SITE DATA

0.245± AC 0.245± AC

B (BUSINESS/COMMERCIAL) - WITHIN DOWNTOWN OVÉRLAY DISTRICT CASTLE ROCK, COLORADO LOCAL JURISDICTION:

LOT 6 & S 1/2 OF LOT 5, BLOCK 22, TOWN OF CASTLE ROCK LOCATED IN THE NORTHWEST QUARTER OF SECTION 11, TOWNSHIP 8, RANGE 67 WEST OF THE 6TH P.M. TOWN OF CASTLE ROCK, COUNTY OF DOUGLAS, STATE OF COLORADO

BASIS OF BEARING

ORIGINAL PLAT IS INTERIOR ANGLES. BEARINGS ARE ASSUMED AND BASED ON THE CONSIDERATION THAT THE EAST LINE OF LOT 6 & THE SOUTH 1/2 OF LOT 5, TOWN OF CASTLE ROCK REC NO. 1874010001, COUNTY OF DOUGLAS, STATE OF COLORADO S 00°31'17" W; NORTHEAST CORNER IS A #5 REBAR WITH A 1-1/2" DIAMTER ORANGE PLASTIC CAP STAMPED PLS 36570: SOUTHEAST CORNER IS AN "X" CHISELED INTO CONCRETE WALL AS SHOWN HERON BETWEEN THOSE IDENTIFIES MONUMENTS.

BASIS OF ELEVATIONS

DOUGLAS COUNTY BENCHMARK: DCBM 3020015 ELEVATION = 6255.DD (NAVD88)

LEGAL DESCRIPTION

LOT 6 & S 1/2 OF LOT 5 BLOCK 22, TOWN OF CASTLE ROCK, STATE OF COLORADO, COUNTY OF DOUGLAS

PROJECT CONTACTS:


<u>CIVIL ENGINEER</u> RIDGETOP ENGINEERING 541 E. GARDEN DRIVE, UNIT N WINDSOR, CO 80550 (970) 663-4552 CONTACT: MIKE BEACH, P.E.

<u>DEVELOPER/APPLICANT</u>
THE LITTLE SCHOOL ON PERRY ST. 203 PERRY ST. CASTLE ROCK, CO 80104 (949) 355-5355 CONTACT: TAYLOR LEWISON

ARCHITECT BODUCH DESIGN GROUP 4969 S. AKIRE ST. MORRISON, CO 80465 (303) 901-0720 CONTACT: SCOTT BODUCH, AIA SURVEYOR
DAVID E. ARCHER & ASSOCIATES, INC. 105 WILCOX ST. CASTLE ROCK, CO 80104 (303) 688-4642 CONTACT: KEVIN E. ARCHER P.E. KARCHER@DAVIDEARCHER.COM

LANDSCAPE ARCHITECT **PLANSCAPES** 980 NORWAY MAPLE DR LOVELAND, CO 80538 (970) 988-5301 CONTACT: ROB MOLLOY, PLA, ASLA

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SITE DEVELOPMENT PLAN GENERAL NOTES

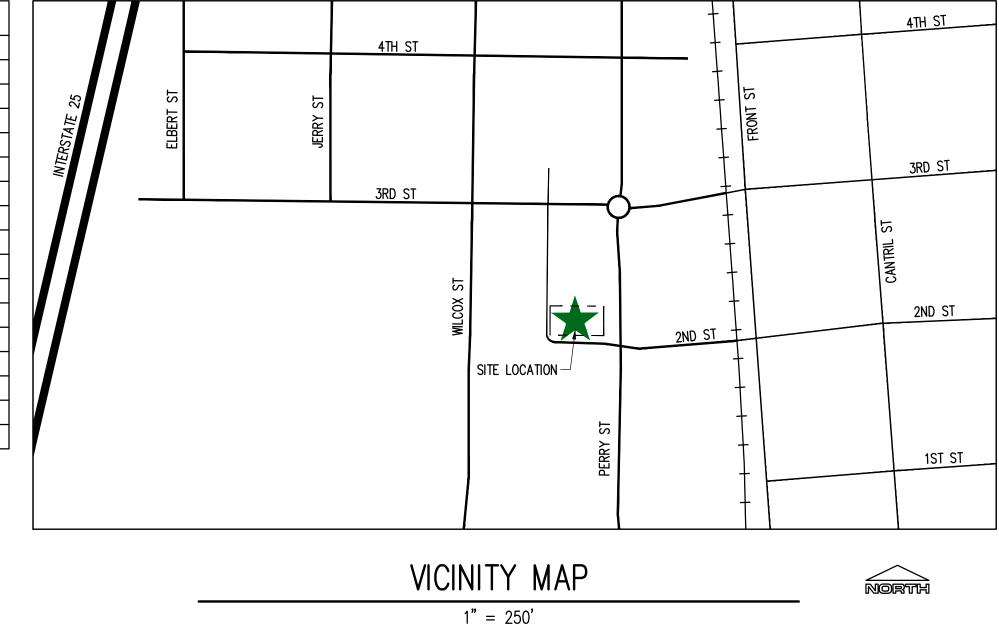- 1. THE TOWN OF CASTLE ROCK REQUIRES THAT MAINTENANCE ACCESS BE PROVIDED TO ALL STORM DRAINAGE FACILITIES TO ASSURE CONTINUOUS OPERATIONAL CAPABILITY OF THE SYSTEM. THE PROPERTY OWNER, SUBSEQUENT OWNERS, HEIRS, SUCCESSORS AND ASSIGNS SHALL BE RESPONSIBLE FOR THE MAINTENANCE OF ALL DRAINAGE FACILITIES INCLUDING, BUT NOT LIMITED TO, INLETS, PIPES, CULVERTS, CHANNELS, DITCHES, HYDRAULIC STRUCTURES, AND DETENTION BASINS LOCATED ON THIS PROPERTY, UNLESS MODIFIED BY THE SUBDIVISION IMPROVEMENTS AGREEMENT. SHOULD THE OWNER FAIL TO ADEQUATELY MAINTAIN SAID FACILITIES, THE TOWN SHALL HAVE THE RIGHT TO ENTER SAID PROPERTY FOR THE PURPOSES OF OPERATION AND MAINTENANCE. ALL SUCH MAINTENANCE COSTS WILL BE ASSESSED TO THE PROPERTY OWNER, SUBSEQUENT OWNERS, HEIRS, SUCCESSORS AND ASSIGNS. THE MAINTENANCE COSTS SHALL INCLUDE ALL ACTUAL COSTS FOR LABOR, EQUIPMENT AND MATERIALS AND A 25% FEE.
- 2. PURSUANT TO THE TOWN OF CASTLE ROCK LANDSCAPE REGULATIONS THE PROPERTY OWNER, SUBSEQUENT OWNERS, HEIRS, SUCCESSORS AND ASSIGNS SHALL BE RESPONSIBLE FOR THE PROPER MAINTENANCE OF THE AREA SUBJECT TO THE APPROVED SITE DEVELOPMENT PLAN. LANDSCAPING WITHIN PUBLIC RIGHTS-OF-WAY IS TO BE MAINTAINED BY THE ADJACENT PRIVATE PROPERTY OWNER OR THE HOMEOWNER/PROPERTY OWNER ASSOCIATION. AS APPLICABLE, LANDSCAPING SHALL BE CONTINUOUSLY MAINTAINED INCLUDING NECESSARY WATERING, WEEDING, PRUNING, MOWING, PEST CONTROL, AND REPLACEMENT OF DEAD OR DISEASED PLANT MATERIAL. UPON WRITTEN NOTICE BY THE TOWN, THE OWNER WILL HAVE 45 DAYS TO CURE OR REPLACE DAMAGED OR DEAD LANDSCAPE MATERIAL. IN THE CASE OF DISEASED LANDSCAPE MATERIAL, A SHORTER COMPLIANCE PERIOD MAY BE SPECIFIED IN SAID NOTICE. THE TOWN OF CASTLE ROCK WATER CONSERVATION ORDINANCE REGULATES TIMES OF SEASONAL IRRIGATION AND PROHIBITS THE WASTING OF POTABLE WATER THROUGH IMPROPER IRRIGATION.
- 3. THE PROVIDED LANDSCAPE COUNTS IN THE SITE DEVELOPMENT PLAN ARE MINIMUM REQUIRED COUNTS. ANY CHANGES TO THE PROVIDED LANDSCAPE COUNTS SHALL REQUIRE AN SDP AMENDMENT. THE LOCATION OF PLANT MATERIAL IS SUBJECT TO CHANGE DUE TO FIELD CONDITIONS WITH REVIEW OF THE CONSTRUCTION DOCUMENTS.
- 4. THIS PROPERTY IS LOCATED WITHIN ZONE "X" AS PER FEMA FIRM PANEL NO. 08035C0301G, DATED MARCH 16TH, 2016. 5. ANY STREET SIGNS, STRIPING, STREET LIGHTS AND CURB RAMPS ARE CONCEPTUAL ONLY AND SUBJECT TO TOWN REVIEW WITH THE CONSTRUCTION DOCUMENTS. THESE ITEMS SHALL COMPLY WITH THE TOWN OF CASTLE ROCK'S REGULATIONS, STANDARDS AND
- 6. THE DEVELOPER SHALL CONFORM TO THE TOWN OF CASTLE ROCK "WATER USE MANAGEMENT PROGRAM IMPLEMENTATION POLICY", AS AMENDED FROM TIME TO TIME, FOR THIS PROJECT. 7. APPROVAL OF THIS SITE DEVELOPMENT PLAN DOES NOT CONSTITUTE APPROVAL OF ANY DEVIATIONS FROM TOWN OF CASTLE ROCK
- REGULATIONS AND STANDARDS. ALL DEVIATIONS FROM TOWN REGULATIONS AND STANDARDS ARE SUBJECT TO THE APPROPRIATE PROCEDURES FOR APPROVAL. 8. NO SOLID OBJECT (EXCLUDING FIRE HYDRANTS, TRAFFIC CONTROL DEVICES AND TRAFFIC SIGNS) EXCEEDING THIRTY (30) INCHES IN HEIGHT ABOVE THE FLOWLINE ELEVATIONS OF THE ADJACENT STREET, INCLUDING BUT NOT LIMITED TO BUILDINGS, UTILITY CABINETS,
- WALLS, FENCES, LANDSCAPE PLANTINGS, CROPS, CUT SLOPES, AND BERMS SHALL BE PLACED WITHIN SIGHT DISTANCE LINES AND
- 9. ALL UTILITY, DRAINAGE, EMERGENCY ACCESS, SIGHT DISTANCE AND PUBLIC ACCESS/TRAIL EASEMENTS AS SHOWN ON THE SITE DEVELOPMENT PLAN SHALL BE GRANTED TO THE TOWN OF CASTLE ROCK WITH THE PLAT.
- 10. THE ZONING RECORDATION INFORMATION, INCLUDING DATE AND RECEPTION NUMBER OR "THIS SITE IS ZONED "B" -BUSINESS/COMMERCIAL I. AND "DOD" — DOWNTOWN OVERLAY."
- 11. ALL EMERGENCY ACCESS ROADS, EMERGENCY ACCESS GATES AND SIGNAGE SHALL COMPLY WITH THE TOWN OF CASTLE ROCK FIRE DEPARTMENT REQUIREMENTS AND SHALL BE MAINTAINED BY METROPOLITAN DISTRICT, HOMEOWNERS ASSOCIATION, OR OTHER PROPERTY
- 12. UNLESS OTHERWISE NOTED, ALL LOTS SHALL HAVE A 10-FOOT UTILITY EASEMENT ALONG THE FRONT AND REAR LOT LINES AND ALONG ALL PUBLIC RIGHTS-OF-WAY AND SHALL HAVE 5-FOOT UTILITY EASEMENTS ALONG EACH SIDE LOT LINE. THESE UTILITY EASEMENTS ARE FOR THE INSTALLATION, MAINTENANCE AND OPERATION OF UTILITIES AND DRAINAGE FACILITIES INCLUDING, BUT NOT LIMITED TO STREET LIGHTS, ELECTRIC LINES, GAS LINES, CABLE TELEVISION LINES, FIBER OPTIC LINES AND TELEPHONE LINES, AS WELL AS PERPETUAL RIGHT FOR INGRESS AND EGRESS FOR INSTALLATION, MAINTENANCE AND REPLACEMENT OF SUCH LINES.
- FOOTING TO THE TOP OF THE WALL, AND RETAINING WALLS, REGARDLESS OF HEIGHT, WHICH RETAIN A SURCHARGE OR TIERED WALLS MUST BE DESIGNED BY A STRUCTURAL ENGINEER LICENSED IN THE STATE OF COLORADO AND MUST RECEIVE A BUILDING PERMIT FROM 14. A SIGN PERMIT FOR EACH SIGN MUST BE OBTAINED FROM THE TOWN OF CASTLE ROCK BUILDING DIVISION PRIOR TO PLACING ANY SIGN ON THE PROPERTY. ALL SIGNS MUST COMPLY WITH THE PROVISIONS OF TITLE 19 (SIGN CODE REGULATIONS) OF THE MUNICIPAL

13. RETAINING WALLS, SECTIONS OF RETAINING WALLS GREATER THAN 4-FEET IN HEIGHT AS MEASURED FROM THE BOTTOM OF THE

- 15. IF THE PROJECT WILL BE LOCATED WITHIN 300 FEET OF THE 100 YR. FLOODPLAIN, APPROVAL FROM THE U.S. FISH AND WILDLIFE SERVICE WILL BE REQUIRED FOR POTENTIAL DISTURBANCE OF THE PREBLE'S MEADOW JUMPING MOUSE HABITAT. PLEASE SEE LINK BELOW FOR INFORMATION RELATED TO THE PREBLE'S MEADOW JUMPING MOUSE. HTTP: //WWW.FWS.GOV/MOUNTAIN-PRAIRIE/SPECIES/MAMMALS/PREBLE/
- 16. THE NUMBER OF PARKING SPACES HAS BEEN SET BASED ON THE PROPOSED USES ON THIS SITE DEVELOPMENT PLAN AND CHAPTER 17.54 OF THE CASTLE ROCK MUNICIPAL CODE. A CHANGE OF USE TO A MORE PARKING INTENSIVE USE AS IDENTIFIED IN CHAPTER 17.54 OF THE CASTLE ROCK MUNICIPAL CODE WILL REQUIRE AN AMENDMENT TO THIS SITE DEVELOPMENT PLAN.

FIRE NOTES

- 1. IF FIRE APPARATUS ACCESS ROADS OR WATER SUPPLY FOR FIRE PROTECTION IS REQUIRED TO BE INSTALLED. SUCH PROTECTION SHALL BE INSTALLED AND MADE SERVICEABLE PRIOR TO VERTICAL CONSTRUCTION.
- 2. FIRE HYDRANT(S) ARE REQUIRED TO BE INSTALLED AND MADE SERVICEABLE PRIOR TO AND DURING THE TIME OF CONSTRUCTION. 3. APPROVED FIRE APPARATUS ACCESS ROADS SHALL BE PROVIDED FOR EVERY FACILITY, BUILDING OR PORTION OF A BUILDING CONSTRUCTED OR MOVED INTO, OR WITHIN THE JURISDICTION. THE FIRE APPARATUS ACCESS ROAD SHALL EXTEND TO WITHIN 150 FEET OF ALL PORTIONS OF THE FACILITY AND ALL PORTIONS OF THE EXTERIOR WALLS OF THE FIRST STORY OF THE BUILDING AS MEASURED BY AN APPROVED ROUTE AROUND THE EXTERIOR OF THE BUILDING OR FACILITY.
- 4. DEAD-END FIRE ACCESS ROADS IN EXCESS OF 150 FEET SHALL PROVIDE AN APPROVED AREA FOR TURNING AROUND FIRE APPARATUS. 5. FIRE APPARATUS ACCESS ROADS SHALL HAVE AN UNOBSTRUCTED WIDTH OF NOT LESS THAN 20 FEET, EXCLUSIVE OF SHOULDERS,
- EXCEPT FOR APPROVED SECURITY GATES AND AN UNOBSTRUCTED VERTICAL CLEARANCE OF NOT LESS THAN 13 FEET, 6 INCHES. 6. FIRE APPARATUS ACCESS ROADS SHALL BE DESIGNED AND MAINTAINED TO SUPPORT THE IMPOSED LOADS OF FIRE APPARATUS WEIGHING AT LEAST 75,000 POUNDS, AND SHALL BE SURFACED SO AS TO PROVIDE ALL-WEATHER DRIVING CAPABILITIES. THE TERM "ALL-WEATHER DRIVING CAPABILITIES" HAS BEEN INTERPRETED TO MEAN EITHER CONCRETE OR ASPHALT, OR OTHER APPROVED DRIVING
- SURFACE DESIGNED BY AN ENGINEER AND APPROVED BY THE FIRE DEPARTMENT. 7. "NO PARKING FIRE LANE" SIGNS ARE REQUIRED IN AREAS THAT MEET THE FOLLOWING CRITERIA AND IN AREAS DESIGNATED BY THE FIRE PREVENTION BUREAU. SIGNS SHALL BE POSTED ON BOTH SIDES OF FIRE ACCESS ROADWAYS, PUBLIC OR PRIVATE ROADWAYS AND DRIVEWAYS LESS THAN 26 FEET WIDE. SIGNS SHALL BE POSTED ON ONE SIDE ONLY OF FIRE ACCESS ROADWAYS, PUBLIC OR PRIVATE ROADWAYS OR DRIVEWAYS BETWEEN 26 FEET WIDE AND 32 FEET WIDE. NO SIGNAGE IS REQUIRED FOR FIRE ACCESS ROADWAYS, PUBLIC
- OR PRIVATE ROADWAYS OR DRIVEWAYS GREATER THAN OR EQUAL TO32 FEET WIDE. 8. IT IS THE RESPONSIBILITY OF THE PROPERTY OWNER TO MAINTAIN DRIVE LANES FOR EMERGENCY VEHICLE INGRESS AND EGRESS, INCLUDING SNOW REMOVAL.
- 9. THE DEVELOPER UNDERSTANDS THAT AS THE PROJECT DEVELOPS THERE MAY BE FIRE AND LIFE SAFETY PROVISIONS OF THE TOWN OF CASTLE ROCK ADOPTED INTERNATIONAL FIRE CODE (IFC) THAT MAY ARISE, AND WERE NOT CLEARLY VISIBLE DURING THE INITIAL REVIEWS, BUT MAY REQUIRE CORRECTIVE ACTION. THESE ITEMS MAY INCLUDE, BUT ARE NOT LIMITED TO: FIRE FLOW REQUIREMENTS, FIRE HYDRANT PLACEMENT, ACCESS, ETC.

WATER RIGHTS DEDICATION AGREEMENT THE TOWN OF CASTLE ROCK HAS ACQUIRED CONTROL OF THE WATER RIGHTS THROUGH THE ADOPTION OF ORDINANCE NO. 97-17 AND PURSUANT TO THE IMPLIED CONSENT PROVISION OF C.R.S. 37-90-137(8)



LITTLE SCHOOL ON PERRY ST

203 PERRY ST. CASTLE ROCK, CO 80104

MISSION CAPITAL **PROPERTIES** BAYSIDE

PREPARED FOR

SUBMITTAL CONSTRUCTION **DOCUMENTS**

DRAWN BY: PROJECT NO .: 23-222-002 REVISIONS

08/31/2023

SHEET TITLE

UTILITY NOTE

CONTRACTOR TO FIELD VERIFY ALL UTILITY INVERTS PRIOR TO ANY CONSTRUCTION OR EARTHWORK MODIFICATIONS.

COVER SHEET

NOTE: CURRENT PLAN SET IS NOT FOR CONSTRUCTION

Know what's below.


Call before you dig.

SHEET INFORMATION

CV-1.0

SITE DEVELOPMENT PLAN LOT 6 & S 1/2 OF LOT 5, BLOCK 22, TOWN OF CASTLE ROCK TOWN OF CASTLE ROCK PROJECT NO: SDP23-0032

LOT 6 & S 1/2 OF LOT 5, BLOCK 22, TOWN OF CASTLE ROCK LOCATED IN THE NORTHWEST QUARTER OF SECTION 11, TOWNSHIP 8, RANGE 67 WEST OF THE 6TH P.M. TOWN OF CASTLE ROCK, COUNTY OF DOUGLAS, STATE OF COLORADO

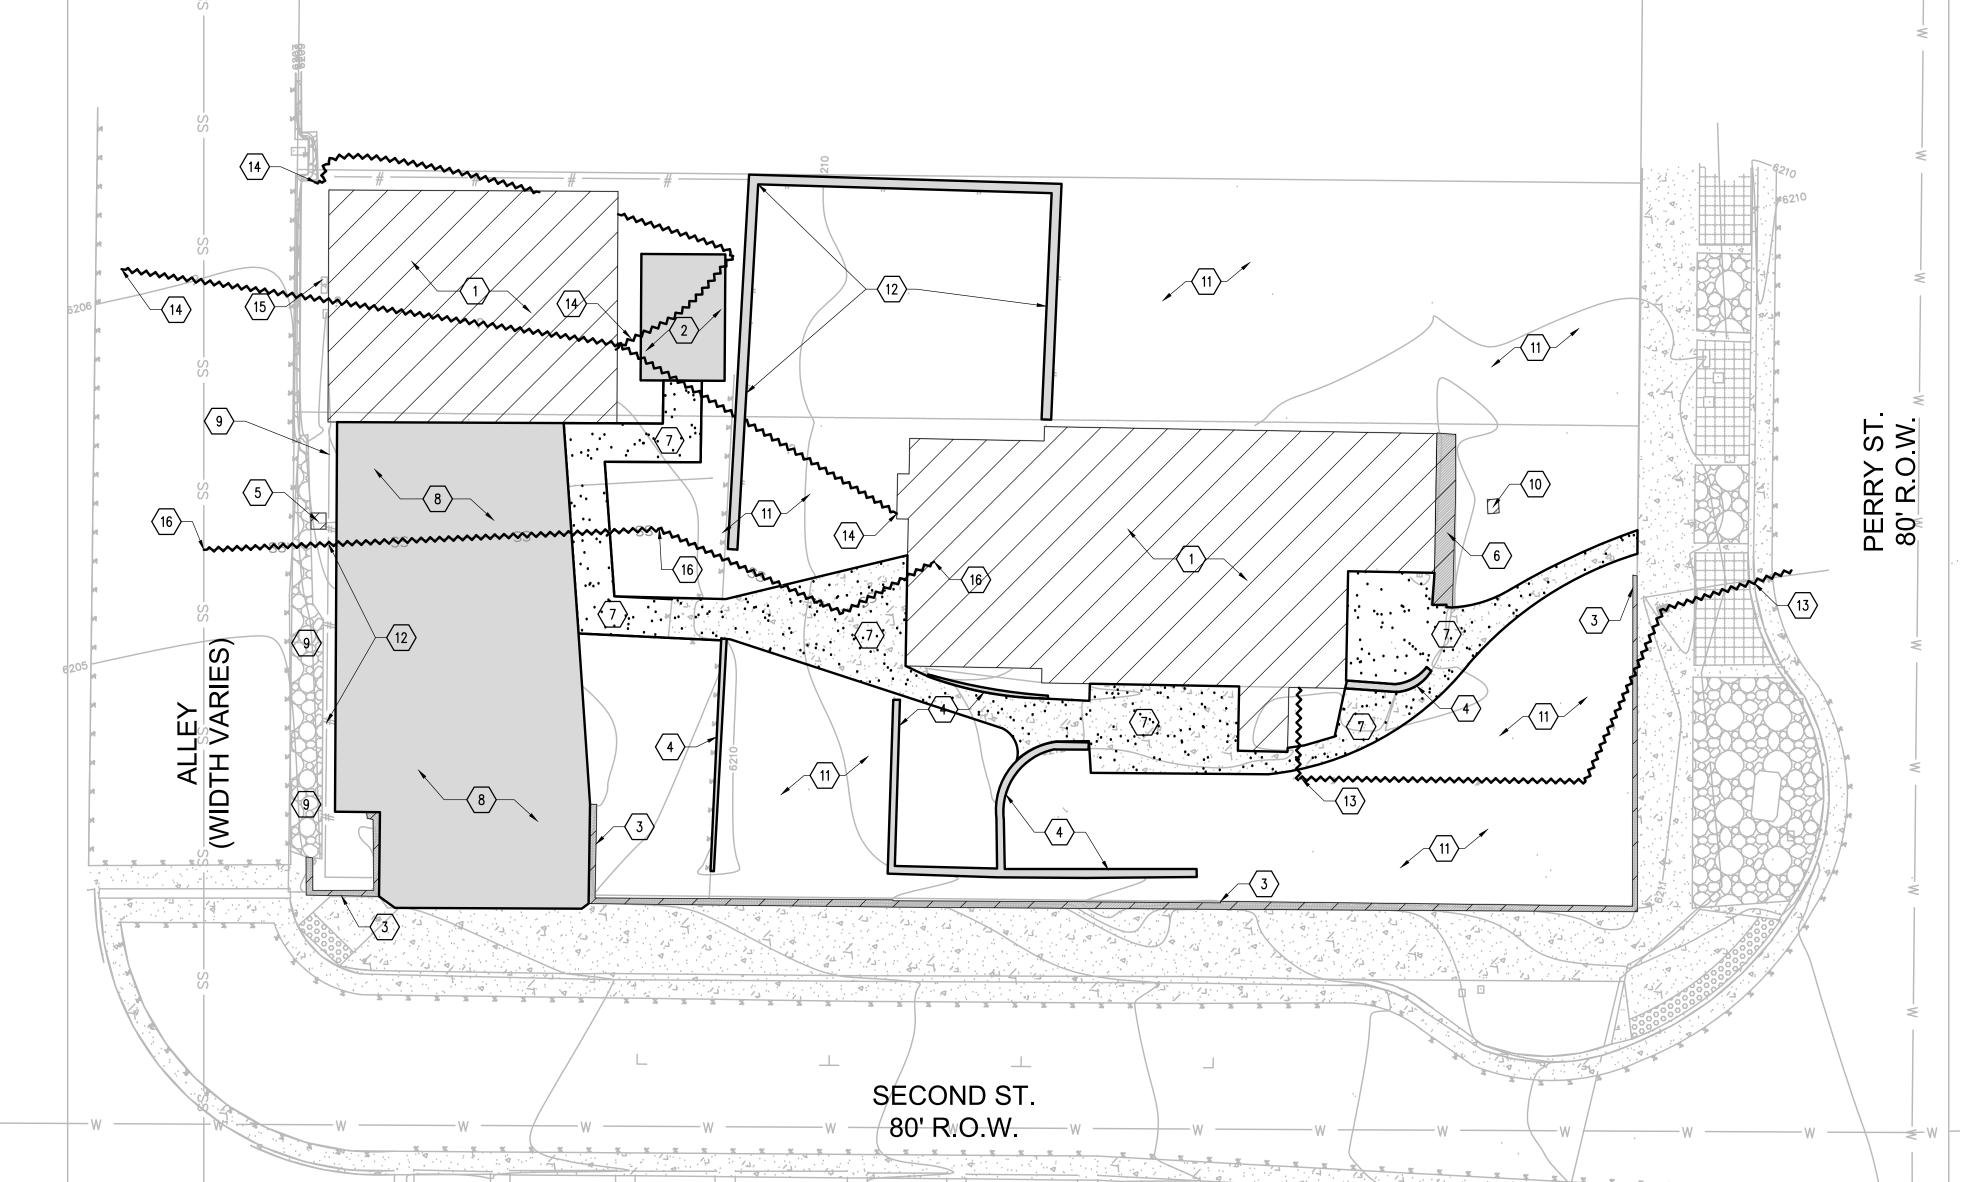

LEGEND

REMOVE/REPLACE EX. PAVEMENT HARDSCAPE PROTECT EXISTING REMOVE/REPLACE

EXISTING CONCRETE/SIDEWALK

CURB REMOVAL

UTILITIES TO BE DEMOED -----


NOTE: FOR ANY REMOVALS BACK TO MAIN OR SIMILAR; ALL HARD SURFACES, BASE MATERIAL, CURB AND GUTTER, ETC MUST BE REPLACED WITH SAME TYPE/COLOR MATERIAL

NOTES

- 1. DEMOLITION NOTES ARE FOR CLARIFICATION ONLY AND ARE SHOWN FOR THE CONTRACTOR'S BENEFIT. THESE NOTES ARE NOT INTENDED TO BE COMPREHENSIVE. THE CONTRACTOR SHALL REMOVE OR RELOCATE ALL EXISTING ON-SITE IMPROVEMENTS NECESSARY TO ACCOMMODATE
- 2. THE DESIGN SHOWN IS BASED UPON THE ENGINEER'S UNDERSTANDING OF THE EXISTING CONDITIONS. THE PLAN DOES NOT REPRESENT A DETAILED FIELD SURVEY. THE EXISTING ARCHER. THE CONTRACTOR IS RESPONSIBLE FOR VERIFYING FIELD CONDITIONS PRIOR TO BIDDING THE PROPOSED SITEWORK IMPROVEMENTS. IF CONFLICTS ARE DISCOVERED, THE CONTRACTOR SHALL NOTIFY THE OWNER PRIOR TO INSTALLATION OF ANY PORTION OF THE SITEWORK WHICH WOULD BE AFFECTED. IF CONTRACTOR DOES NOT ACCEPT EXISTING SURVEY, INCLUDING TOPOGRAPHY AS SHOWN ON THE PLANS, WITHOUT EXCEPTION, HE SHALL HAVE MADE, AT HIS OWN EXPENSE, A TOPOGRAPHIC SURVEY BY A REGISTERED LAND SURVEYOR AND SUBMIT IT TO THE OWNER FOR REVIEW.
- 3. CAUTION NOTICE TO CONTRACTOR THE CONTRACTOR IS SPECIFICALLY CAUTIONED THAT THE LOCATION AND/OR ELEVATION OF EXISTING UTILITIES AS SHOWN ON THESE PLANS IS BASED ON RECORDS OF THE VARIOUS EXACT FIELD LOCATION OF UTILITIES. IT SHALL BE THE RESPONSIBILITY OF THE CONTRACTOR TO RELOCATE ALL EXISTING UTILITIES AND EXISTING IMPROVEMENTS WHICH CONFLICT WITH THE PROPOSED IMPROVEMENTS ON THE PLANS.
- 4. CONTRACTOR IS TO REMOVE ALL EXISTING SURFACE IMPROVEMENTS AND DEBRIS WITHIN THE LIMITS OF WORK UNLESS OTHERWISE NOTED. ALL DEBRIS FOUND ON SITE SHALL BE DISPOSED OF IN ACCORDANCE WITH APPLICABLE STATE CODES.
- 5. CONTRACTOR TO PROTECT EXISTING FEATURES WHICH ARE TO REMAIN.
- 6. REMOVE EXISTING PIPES LOCATED OUTSIDE PROPOSED BUILDING PAD LIMITS. 7. CONTRACTOR SHALL ADJUST ALL EXISTING MANHOLE RIMS, DRAINAGE STRUCTURES, VALVE BOXES, VAULT LIDS AND UTILITY ACCESS STRUCTURES TO FINISH GRADE WITHIN AREAS AFFECTED BY PROPOSED CONSTRUCTION.

DEMOLITION KEY


- 1 PROTECT EXISTING BUILDING. TO REMAIN.
- $\langle 2 \rangle$ DEMOLISH EXISTING SHED
- 3 PROTECT EXISTING RETAINING WALLS
- 4 DEMOLISH AND REMOVE EXISTING RETAINING/ROCKERY WALLS
- 5 REMOVE EXISTING GAS METER. TO BE RELOCATED.
- 6 PROTECT EXISTING PLANTER SEE ARCH. DRAWINGS
- 7 REMOVE EXISTING SIDEWALKS AND PATHWAYS
- DEMOLISH AND REMOVE EXISTING ASPHALT PAVEMENT/CONCRETE TO DEPTH SUFFICIENT TO CONSTRUCT NEW PAVING AND IMPROVEMENTS.
- 9 DEMOLISH EXISTING CONCRETE CURB
- 10 PROTECT HISTORICAL MARKER. TO REMAIN.
- CLEAR AND GRUB AREA OF ANY EXISTING IMPROVEMENTS IN THE WAY OF THE PROPOSED BUILDING AND SITE IMPROVEMENTS.
- (12) REMOVE ALL EXISTING FENCING FROM SITE
- (13) DEMOLISH EXISTING WATER LINE AND METER UP TO METER.
- 14 DEMOLISH EXISTING PRIVATE OVERHEAD POWER LINE. TO BE RELOCATED.
- 15 PROTECT EXISTING METERING POINT TO REMAIN.
- DEMOLISH EXISTING SANITARY LINE TO MAIN. CONTRACTOR TO FIELD VERIFY DEPTH AND LOCATION

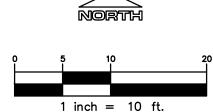



NOTE: CURRENT PLAN SET IS NOT FOR CONSTRUCTION

SITE DEVELOPMENT PLAN LOT 6 & S $\frac{1}{2}$ OF LOT 5, BLOCK 22, TOWN OF CASTLE ROCK TOWN OF CASTLE ROCK PROJECT NO: SDP23-0032

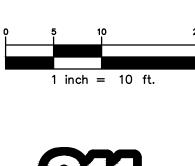

PROJECT TITLE

203 PERRY ST.

PROPERTIES

BAYSIDE

LITTLE SCHOOL

CASTLE ROCK, CO 80104

MISSION CAPITAL

ON PERRY ST

SUBMITTAL CONSTRUCTION DOCUMENTS

> DRAWN BY: PROJECT NO .:


08/31/2023

SHEET TITLE

DEMO PLAN


SHEET INFORMATION DM-1.0

LOT 6 & S 1/2 OF LOT 5, BLOCK 22, TOWN OF CASTLE ROCK LOCATED IN THE NORTHWEST QUARTER OF SECTION 11, TOWNSHIP 8, RANGE 67 WEST OF THE 6TH P.M. TOWN OF CASTLE ROCK, COUNTY OF DOUGLAS, STATE OF COLORADO

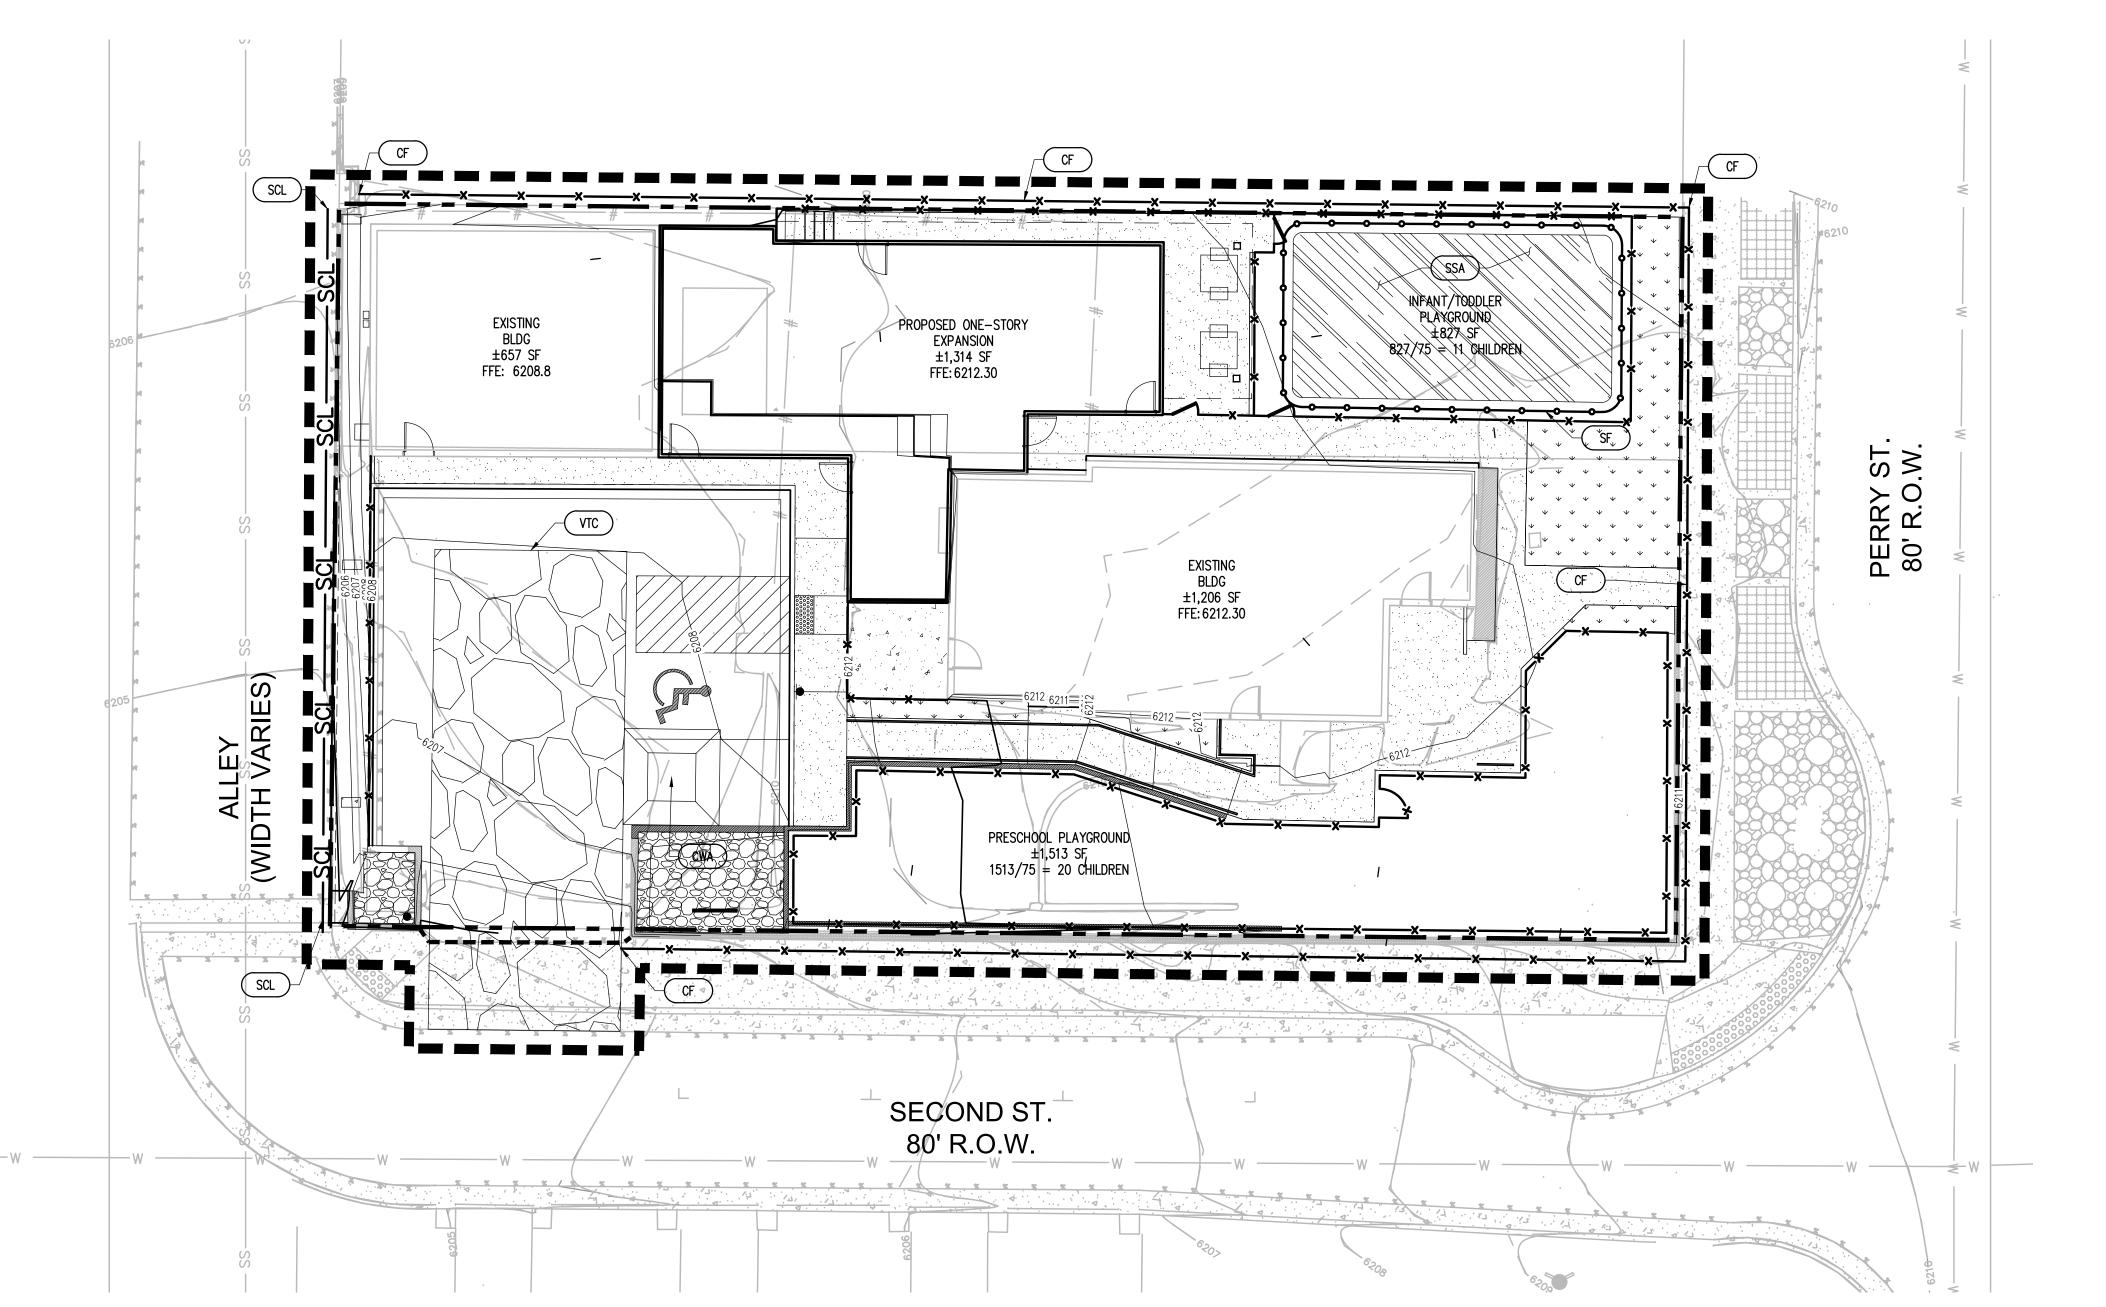

LEGEND

EX. CONTOUR LIMITS OF DISTURBANCI PROPERTY LINE

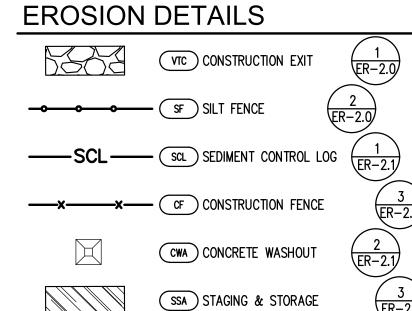

RS ROCK SOCK

ACREAGE SUMMARY (IN ACRES)							
SITE AREA	0.24 AC±						
ON-SITE DISTURBED AREA	0.24 AC±						
OFF-SITE DISTURBED AREA	0.04 AC±						
TOTAL DISTURBED AREA	0.28 AC±						

PROJECT TITLE LITTLE SCHOOL ON PERRY ST

203 PERRY ST. CASTLE ROCK, CO 80104

MISSION CAPITAL **PROPERTIES BAYSIDE**

CONSTRUCTION DOCUMENTS

SUBMITTAL

08/31/2023

SHEET TITLE **EROSION** CONTROL

SHEET INFORMATION

ER-1.0


PLAN


SITE DEVELOPMENT PLAN LOT 6 & S ½ OF LOT 5, BLOCK 22, TOWN OF CASTLE ROCK TOWN OF CASTLE ROCK PROJECT NO: SDP23-0032 Of **16**





NOTE: CURRENT PLAN SET IS NOT FOR CONSTRUCTION

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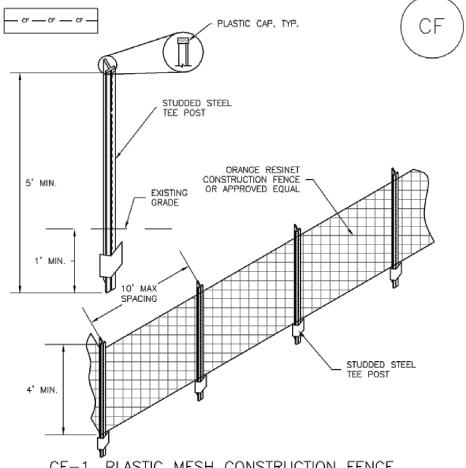


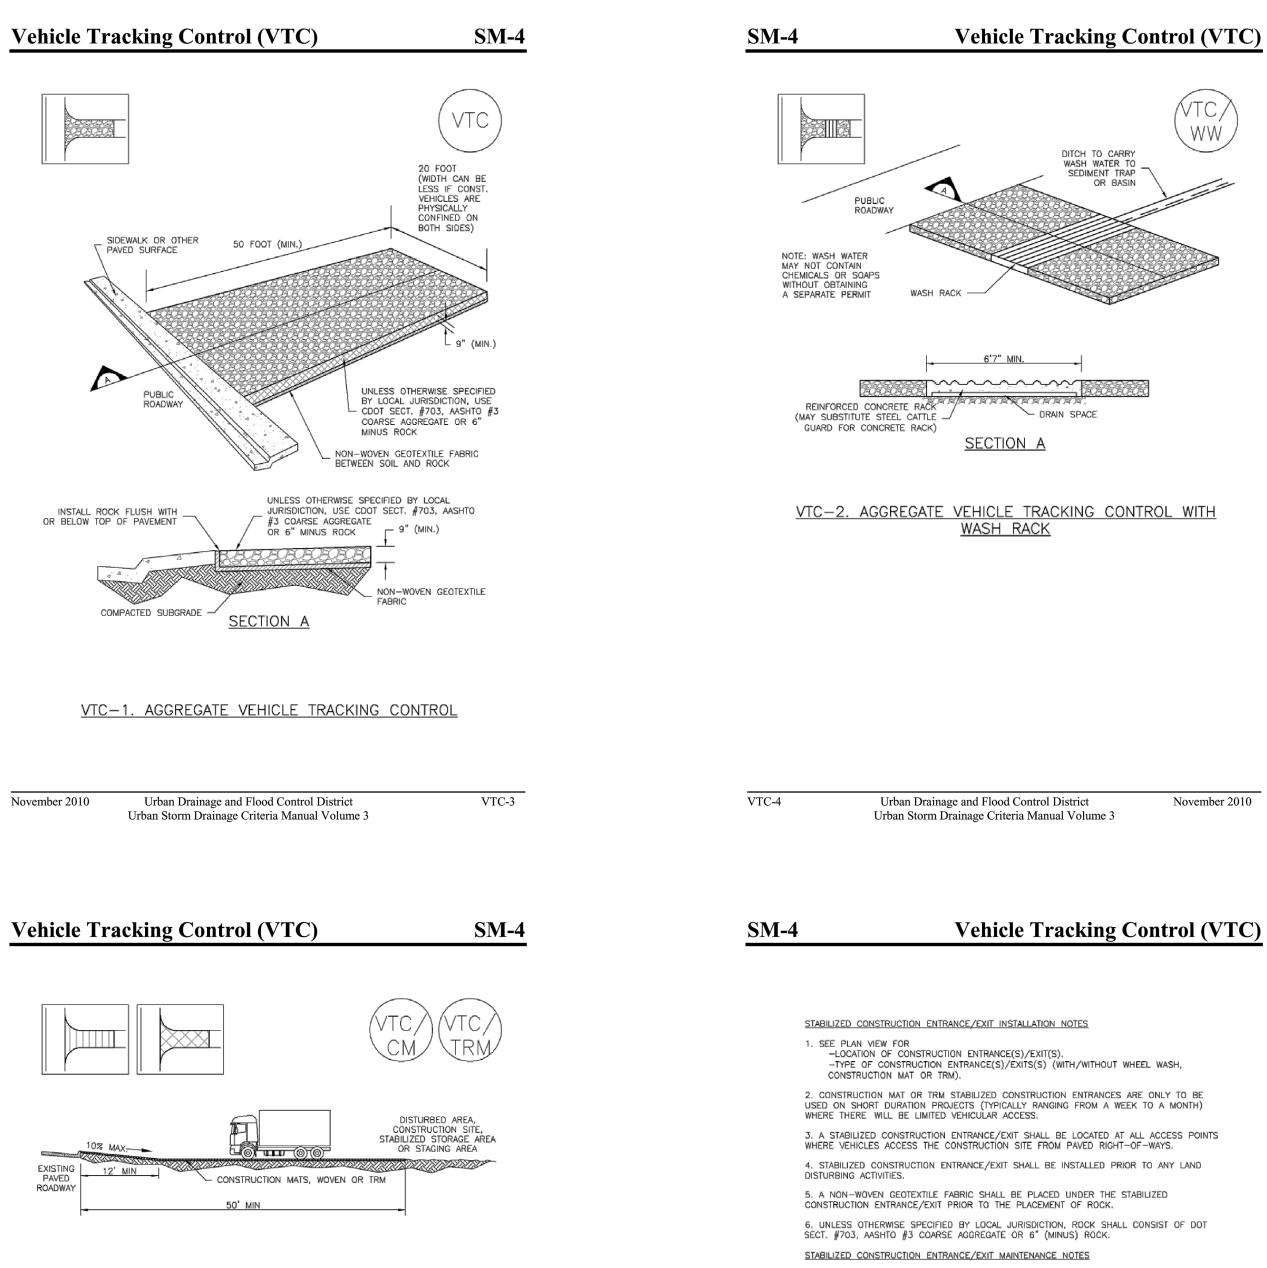

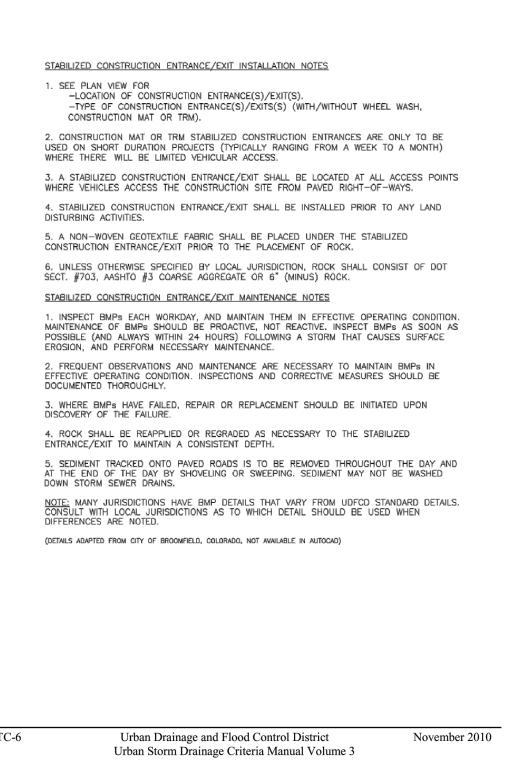SILT FENCE INSTALLATION NOTES 1. SILT FENCE MUST BE PLACED AWAY FROM THE TOE OF THE SLOPE TO ALLOW FOR WATER PONDING. SILT FENCE AT THE TOE OF A SLOPE SHOULD BE INSTALLED IN A FLAT LOCATION AT LEAST SEVERAL FEET (2-5 FT) FROM THE TOE OF THE SLOPE TO ALLOW ROOM FOR 2. A UNIFORM 6" X 4" ANCHOR TRENCH SHALL BE EXCAVATED USING TRENCHER OR SILT FENCE INSTALLATION DEVICE. NO ROAD GRADERS, BACKHOES, OR SIMILAR EQUIPMENT SHALL BE USED. 3. COMPACT ANCHOR TRENCH BY HAND WITH A "JUMPING JACK" OR BY WHEEL ROLLING. COMPACTION SHALL BE SUCH THAT SILT FENCE RESISTS BEING PULLED OUT OF ANCHOR TRENCH BY HAND. 4. SILT FENCE SHALL BE PULLED TIGHT AS IT IS ANCHORED TO THE STAKES. THERE SHOULD BE NO NOTICEABLE SAG BETWEEN STAKES AFTER IT HAS BEEN ANCHORED TO THE STAKES. 5. SILT FENCE FABRIC SHALL BE ANCHORED TO THE STAKES USING 1" HEAVY DUTY STAPLES OR NAILS WITH 1" HEADS. STAPLES AND NAILS SHOULD BE PLACED 3" ALONG THE FABRIC 6. AT THE END OF A RUN OF SILT FENCE ALONG A CONTOUR, THE SILT FENCE SHOULD BE TURNED PERPENDICULAR TO THE CONTOUR TO CREATE A "J-HOOK." THE "J-HOOK" EXTENDING PERPENDICULAR TO THE CONTOUR SHOULD BE OF SUFFICIENT LENGTH TO KEEP RUNOFF FROM FLOWING AROUND THE END OF THE SILT FENCE (TYPICALLY 10' - 20'). 7. SILT FENCE SHALL BE INSTALLED PRIOR TO ANY LAND DISTURBING ACTIVITIES. SILT FENCE MAINTENANCE NOTES 1. INSPECT BMPs EACH WORKDAY, AND MAINTAIN THEM IN EFFECTIVE OPERATING CONDITION. MAINTENANCE OF BMPs SHOULD BE PROACTIVE, NOT REACTIVE. INSPECT BMPs AS SOON AS POSSIBLE (AND ALWAYS WITHIN 24 HOURS) FOLLOWING A STORM THAT CAUSES SURFACE EROSION, AND PERFORM NECESSARY MAINTENANCE 2. FREQUENT OBSERVATIONS AND MAINTENANCE ARE NECESSARY TO MAINTAIN BMPs IN EFFECTIVE OPERATING CONDITION. INSPECTIONS AND CORRECTIVE MEASURES SHOULD BE 3. WHERE BMPs HAVE FAILED, REPAIR OR REPLACEMENT SHOULD BE INITIATED UPON DISCOVERY OF THE FAILURE. 4. SEDIMENT ACCUMULATED UPSTREAM OF THE SILT FENCE SHALL BE REMOVED AS NEEDED TO MAINTAIN THE FUNCTIONALITY OF THE BMP, TYPICALLY WHEN DEPTH OF ACCUMULATED 5. REPAIR OR REPLACE SILT FENCE WHEN THERE ARE SIGNS OF WEAR, SUCH AS SAGGING,

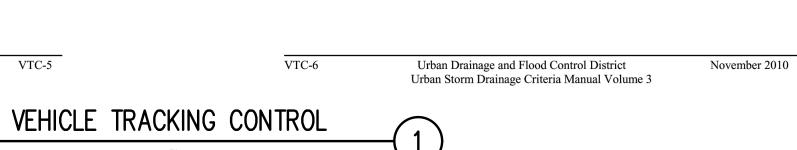6. SILT FENCE IS TO REMAIN IN PLACE UNTIL THE UPSTREAM DISTURBED AREA IS STABILIZED AND APPROVED BY THE LOCAL JURISDICTION, OR IS REPLACED BY AN EQUIVALENT PERIMETER SEDIMENT CONTROL BMP. 7. WHEN SILT FENCE IS REMOVED, ALL DISTURBED AREAS SHALL BE COVERED WITH TOPSOIL, SEEDED AND MULCHED OR OTHERWISE STABILIZED AS APPROVED BY LOCAL JURISDICTION. (DETAIL ADAPTED FROM TOWN OF PARKER, COLORADO AND CITY OF AURORA, NOT AVAILABLE IN AUTOCAD) NOTE: MANY JURISDICTIONS HAVE BMP DETAILS THAT VARY FROM UDFCD STANDARD DETAILS. CONSULT WITH LOCAL JURISDICTIONS AS TO WHICH DETAIL SHOULD BE USED WHEN DIFFERENCES ARE NOTED.

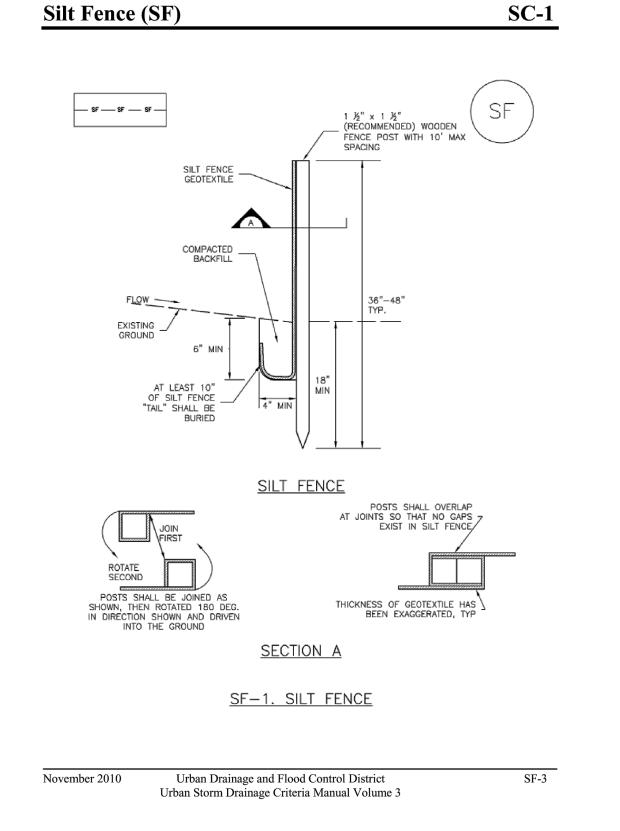SM-3 Construction Fence (CF)



CF-1. PLASTIC MESH CONSTRUCTION FENCE

CONSTRUCTION FENCE INSTALLATION NOTES

2. CONSTRUCTION FENCE SHOWN SHALL BE INSTALLED PRIOR TO ANY LAND DISTURBING

 CONSTRUCTION FENCE SHALL BE COMPOSED OF ORANGE, CONTRACTOR—GRADE MATERIAL THAT IS AT LEAST 4' HIGH. METAL POSTS SHOULD HAVE A PLASTIC CAP FOR SAFETY. 4. STUDDED STEEL TEE POSTS SHALL BE UTILIZED TO SUPPORT THE CONSTRUCTION FENCE. MAXIMUM SPACING FOR STEEL TEE POSTS SHALL BE 10'.

5. CONSTRUCTION FENCE SHALL BE SECURELY FASTENED TO THE TOP, MIDDLE, AND BOTTOM OF EACH POST.

Urban Drainage and Flood Control District Urban Storm Drainage Criteria Manual Volume 3

November 2010

SM-3

Construction Fence (CF)

CONSTRUCTION FENCE MAINTENANCE NOTES 1. INSPECT BMPs EACH WORKDAY, AND MAINTAIN THEM IN EFFECTIVE OPERATING CONDITION. MAINTENANCE OF BMPs SHOULD BE PROACTIVE, NOT REACTIVE. INSPECT BMPs AS SOON AS POSSIBLE (AND ALWAYS WITHIN 24 HOURS) FOLLOWING A STORM THAT CAUSES SURFACE EROSION, AND PERFORM NECESSARY MAINTENANCE.

2. FREQUENT OBSERVATIONS AND MAINTENANCE ARE NECESSARY TO MAINTAIN BMPs IN EFFECTIVE OPERATING CONDITION. INSPECTIONS AND CORRECTIVE MEASURES SHOULD BE DOCUMENTED THOROUGHLY. 3. WHERE BMPs HAVE FAILED, REPAIR OR REPLACEMENT SHOULD BE INITIATED UPON

4. CONSTRUCTION FENCE SHALL BE REPAIRED OR REPLACED WHEN THERE ARE SIGNS OF DAMAGE SUCH AS RIPS OR SAGS, CONSTRUCTION FENCE IS TO REMAIN IN PLACE UNTIL THE UPSTREAM DISTURBED AREA IS STABILIZED AND APPROVED BY THE LOCAL JURISDICTION. 5. WHEN CONSTRUCTION FENCES ARE REMOVED, ALL DISTURBED AREAS ASSOCIATED WITH THE INSTALLATION, MAINTENANCE, AND/OR REMOVAL OF THE FENCE SHALL BE COVERED WITH

TOPSOIL, SEEDED AND MULCHED, OR OTHERWISE STABILIZED AS APPROVED BY LOCAL

Urban Drainage and Flood Control District

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CONSTRUCTION FENCE

NOTE: MANY JURISDICTIONS HAVE BMP DETAILS THAT VARY FROM UDFCD STANDARD DETAILS. CONSULT WITH LOCAL JURISDICTIONS AS TO WHICH DETAIL SHOULD BE USED WHEN DIFFERENCES ARE NOTED. (DETAIL ADAPTED FROM TOWN OF PARKER, COLORADO, NOT AVAILABLE IN AUTOCAD)

SUBMITTAL CONSTRUCTION **DOCUMENTS**

541 E. Garden Drive,

Windsor, CO 80550

PROJECT TITLE

LITTLE SCHOOL

CASTLE ROCK, CO 80104

MISSION CAPITAL

ON PERRY ST

203 PERRY ST.

PREPARED FOR

PROPERTIES

BAYSIDE

W ridgetopeng.con

DRAWN BY: PROJECT NO .: 23-222-002

08/31/2023

EROSION CONTROL **DETAILS**

SHEET INFORMATION

SITE DEVELOPMENT PLAN LOT 6 & S 1/2 OF LOT 5, BLOCK 22, TOWN OF CASTLE ROCK TOWN OF CASTLE ROCK PROJECT NO: SDP23-0032

Of

Know what's below. Call before you dig.

NOTE: CURRENT PLAN SET IS NOT FOR CONSTRUCTION

Urban Drainage and Flood Control District Urban Storm Drainage Criteria Manual Volume 3

November 2010

CONSTRUCTION MATS, WOVEN OR TURF REINFORCEMENT

VTC-3. VEHICLE TRACKING CONTROL W/ CONSTRUCTION

MAT OR TURF REINFORCEMENT MAT (TRM)

CONSTRUCTION MAT END

OVERLAP INTERLOCK WITH STRAP CONNECTORS

TO ACCOMMODATE ANTICIPATED

CAN BE LESS IF CONST. VEHICLES ARE PHYSICALLY

SIDES)


CONFINED ON BOTH

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November 2010

Silt Fence (SF)

LOT 6 & S 1/2 OF LOT 5, BLOCK 22, TOWN OF CASTLE ROCK LOCATED IN THE NORTHWEST QUARTER OF SECTION 11, TOWNSHIP 8, RANGE 67 WEST OF THE 6TH P.M. TOWN OF CASTLE ROCK, COUNTY OF DOUGLAS, STATE OF COLORADO

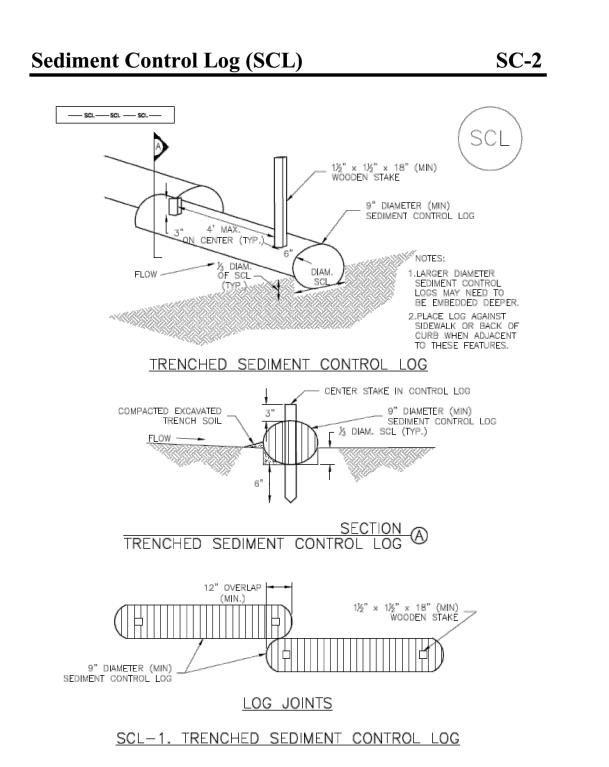

SC-2 **Sediment Control Log (SCL)** 4' MAX FOR TRENCHED SCI-SCL-3. SEDIMENT CONTROL LOGS TO CONTROL

Urban Drainage and Flood Control District

Urban Storm Drainage Criteria Manual Volume 3

SCL-5

November 2015

Sediment Control Log (SCL)

(CWA CONTROL (SEE VTC DETAIL) OF OTHER STABLE SURFACE 2% SLOPE VEHICLE TRACKING SECTION CWA-1. CONCRETE WASHOUT AREA CWA INSTALLATION NOTES SEE PLAN VIEW FOR:
 -CWA INSTALLATION LOCATION. 2. DO NOT LOCATE AN UNLINED CWA WITHIN 400' OF ANY NATURAL DRAINAGE PATHWAY OR WATERBODY. DO NOT LOCATE WITHIN 1,000' OF ANY WELLS OR DRINKING WATER SOURCES. I SITE CONSTRAINTS MAKE THIS INFEASIBLE, OR IF HIGHLY PERMEABLE SOILS EXIST ON SITE THE CWA MUST BE INSTALLED WITH AN IMPERMEABLE LINER (16 MIL MIN. THICKNESS) LINED ABOVE GROUND STORAGE ARE SHOULD BE USED 3. THE CWA SHALL BE INSTALLED PRIOR TO CONCRETE PLACEMENT ON SITE. 4. CWA SHALL INCLUDE A FLAT SUBSURFACE PIT THAT IS AT LEAST 8' BY 8' SLOPES LEADING OUT OF THE SUBSURFACE PIT SHALL BE 3:1 OR FLATTER. THE PIT SHALL BE AT 5. BERM SURROUNDING SIDES AND BACK OF THE CWA SHALL HAVE MINIMUM HEIGHT OF 1' 6. VEHICLE TRACKING PAD SHALL BE SLOPED 2% TOWARDS THE CWA. SIGNS SHALL BE PLACED AT THE CONSTRUCTION ENTRANCE, AT THE CWA, AN ELSEWHERE AS NECESSARY TO CLEARLY INDICATE THE LOCATION OF THE CWA TO OPERATORS OF CONCRETE TRUCKS AND PUMP RIGS. 8. USE EXCAVATED MATERIAL FOR PERIMETER BERM CONSTRUCTION. Urban Drainage and Flood Control District CWA-3 Urban Storm Drainage Criteria Manual Volume 3

Concrete Washout Area (CWA)

CONSTRUCTION
VEHICLE
PARKING (1F NEEDED) CONSTRUCTION SITE ACCESS GRANULAR MATERIAL CONSTRUCTION ENTRANCE (SEE -DETAILS VTC-1 SILT FENCE OR CONSTRUCTION FENCING AS NEEDED — SF/CF — SF/CF → SSA-1. STABILIZED STAGING AREA STABILIZED STAGING AREA INSTALLATION NOTES -LOCATION OF STAGING AREA(S). -CONTRACTOR MAY ADJUST LOCATION AND SIZE OF STAGING AREA WITH APPROVAL FROM THE LOCAL JURISDICTION. 2. STABILIZED STAGING AREA SHOULD BE APPROPRIATE FOR THE NEEDS OF THE SITE. OVERSIZING RESULTS IN A LARGER AREA TO STABILIZE FOLLOWING CONSTRUCTION. 3. STAGING AREA SHALL BE STABILIZED PRIOR TO OTHER OPERATIONS ON THE SITE. 4. THE STABILIZED STAGING AREA SHALL CONSIST OF A MINIMUM 3" THICK GRANULAR 5. UNLESS OTHERWISE SPECIFIED BY LOCAL JURISDICTION, ROCK SHALL CONSIST OF DOT SECT. #703, AASHTO #3 COARSE AGGREGATE OR 6" (MINUS) ROCK. 6. ADDITIONAL PERIMETER BMPs MAY BE REQUIRED INCLUDING BUT NOT LIMITED TO SILT STABILIZED STAGING AREA MAINTENANCE NOTES MAINTENANCE OF BMPs SHOULD BE PROACTIVE, NOT REACTIVE. INSPECT BMPs AS SOON AS POSSIBLE (AND ALWAYS WITHIN 24 HOURS) FOLLOWING A STORM THAT CAUSES SURFACE EROSION, AND PERFORM NECESSARY MAINTENANCE. 2. FREQUENT OBSERVATIONS AND MAINTENANCE ARE NECESSARY TO MAINTAIN BMPs IN EFFECTIVE OPERATING CONDITION. INSPECTIONS AND CORRECTIVE MEASURES SHOULD BE DOCUMENTED THOROUGHLY. 3. WHERE BMPs HAVE FAILED, REPAIR OR REPLACEMENT SHOULD BE INITIATED UPON DISCOVERY OF THE FAILURE. 4. ROCK SHALL BE REAPPLIED OR REGRADED AS NECESSARY IF RUTTING OCCURS OR UNDERLYING SUBGRADE BECOMES EXPOSED. Urban Drainage and Flood Control District Urban Storm Drainage Criteria Manual Volume 3

Stabilized Staging Area (SSA)

— SF/CF — SF/CF –

Sediment Control Log (SCL) SEDIMENT CONTROL LOG NOTES: CONTROL LOGS THAT ARE A MINIMUM OF COMPOST SEDIMENT CONTROL LOG (WEIGHTED) MEDIA OR SOIL 1½" x 1½" x 18" (MIN) WOODEN STAKE 9" DIAMETER (MIN LOG JOINTS

SCL-2. COMPOST SEDIMENT CONTROL LOG (WEIGHTED)

Urban Drainage and Flood Control District

Urban Storm Drainage Criteria Manual Volume 3

Urban Drainage and Flood Control District

Urban Storm Drainage Criteria Manual Volume 3

SEDIMENT CONTROL LOG INSTALLATION NOTES 1. SEE PLAN VIEW FOR LOCATION AND LENGTH OF SEDIMENT CONTROL LOGS. 2. SEDIMENT CONTROL LOGS THAT ACT AS A PERIMETER CONTROL SHALL BE INSTALLED PRIOR 3. SEDIMENT CONTROL LOGS SHALL CONSIST OF STRAW, COMPOST, EXCELSIOR OR COCONUT FIBER, AND SHALL BE FREE OF ANY NOXIOUS WEED SEEDS OR DEFECTS INCLUDING RIPS, 4. SEDIMENT CONTROL LOGS MAY BE USED AS SMALL CHECK DAMS IN DITCHES AND SWALES. HOWEVER, THEY SHOULD NOT BE USED IN PERENNIAL STREAMS. 5. IT IS RECOMMENDED THAT SEDIMENT CONTROL LOGS BE TRENCHED INTO THE GROUND TO A DEPTH OF APPROXIMATELY & OF THE DIAMETER OF THE LOG. IF TRENCHING TO THIS DEPTH IS NOT FEASIBLE AND/OR DESIRABLE (SHORT TERM INSTALLATION WITH DESIRE NOT TO DAMAGE LANDSCAPE) A LESSER TRENCHING DEPTH MAY BE ACCEPTABLE WITH MORE ROBUST STAKING. COMPOST LOGS THAT ARE 8 LB/FT DO NOT NEED TO BE TRENCHED. 6. THE UPHILL SIDE OF THE SEDIMENT CONTROL LOG SHALL BE BACKFILLED WITH SOIL OR FILTER MATERIAL THAT IS FREE OF ROCKS AND DEBRIS. THE SOIL SHALL BE TIGHTLY COMPACTED INTO THE SHAPE OF A RIGHT TRIANGLE USING A SHOVEL OR WEIGHTED LAWN ROLLER OR BLOWN IN PLACE. 7. FOLLOW MANUFACTURERS' GUIDANCE FOR STAKING. IF MANUFACTURERS' INSTRUCTIONS DO NOT SPECIFY SPACING, STAKES SHALL BE PLACED ON 4' CENTERS AND EMBEDDED A MINIMUM OF 6" INTO THE GROUND. 3" OF THE STAKE SHALL PROTRUDE FROM THE TOP OF THE LOG. STAKES THAT ARE BROKEN PRIOR TO INSTALLATION SHALL BE REPLACED. COMPOST LOGS SHOULD BE STAKED 10' ON CENTER. SEDIMENT CONTROL LOG MAINTENANCE NOTES 1. INSPECT BMPs EACH WORKDAY, AND MAINTAIN THEM IN EFFECTIVE OPERATING CONDITION. MAINTENANCE OF BMPs SHOULD BE PROACTIVE, NOT REACTIVE. INSPECT BMPs AS SOON AS POSSIBLE (AND ALWAYS WITHIN 24 HOURS) FOLLOWING A STORM THAT CAUSES SURFACE EROSION, AND PERFORM NECESSARY MAINTENANCE. 2. FREQUENT OBSERVATIONS AND MAINTENANCE ARE NECESSARY TO MAINTAIN BMPs IN EFFECTIVE OPERATING CONDITION. INSPECTIONS AND CORRECTIVE MEASURES SHOULD BE DOCUMENTED THOROUGHLY. 3. WHERE BMPs HAVE FAILED, REPAIR OR REPLACEMENT SHOULD BE INITIATED UPON DISCOVERY OF THE FAILURE. 4. SEDIMENT ACCUMULATED UPSTREAM OF SEDIMENT CONTROL LOG SHALL BE REMOVED AS NEEDED TO MAINTAIN FUNCTIONALITY OF THE BMP, TYPICALLY WHEN DEPTH OF ACCUMULATED SEDIMENTS IS APPROXIMATELY 1/2 OF THE HEIGHT OF THE SEDIMENT CONTROL LOG. 5. SEDIMENT CONTROL LOG SHALL BE REMOVED AT THE END OF CONSTRUCTION.COMPOST FROM COMPOST LOGS MAY BE LEFT IN PLACE AS LONG AS BAGS ARE REMOVED AND THE AREA SEEDED. IF DISTURBED AREAS EXIST AFTER REMOVAL, THEY SHALL BE COVERED WITH OP SOIL, SEEDED AND MULCHED OR OTHERWISE STABILIZED IN A MANNER APPROVED BY (DETAILS ADAPTED FROM TOWN OF PARKER, COLORADO, JEFFERSON COUNTY, COLORADO, DOUGLAS COUNTY, COLORADO, AND CITY OF AURORA, COLORADO, NOT AVAILABLE IN AUTOCAD) NOTE: MANY JURISDICTIONS HAVE BMP DETAILS THAT VARY FROM UDFCD STANDARD DETAILS, CONSULT WITH LOCAL JURISDICTIONS AS TO WHICH DETAIL SHOULD BE USED WHEN

Urban Drainage and Flood Control District

Urban Storm Drainage Criteria Manual Volume 3

CWA MAINTENANCE NOTES 1. INSPECT BMPs EACH WORKDAY, AND MAINTAIN THEM IN EFFECTIVE OPERATING CONDITION. MAINTENANCE OF BMPs SHOULD BE PROACTIVE, NOT REACTIVE. INSPECT BMPs AS SOON AS POSSIBLE (AND ALWAYS WITHIN 24 HOURS) FOLLOWING A STORM THAT CAUSES SURFACE EROSION, AND PERFORM NECESSARY MAINTENANCE. 2. FREQUENT OBSERVATIONS AND MAINTENANCE ARE NECESSARY TO MAINTAIN BMPs IN EFFECTIVE OPERATING CONDITION. INSPECTIONS AND CORRECTIVE MEASURES SHOULD BE DOCUMENTED THOROUGHLY. 3. WHERE BMPs HAVE FAILED, REPAIR OR REPLACEMENT SHOULD BE INITIATED UPON 4. THE CWA SHALL BE REPAIRED, CLEANED, OR ENLARGED AS NECESSARY TO MAINTAIN CAPACITY FOR CONCRETE WASTE. CONCRETE MATERIALS, ACCUMULATED IN PIT, SHALL BE REMOVED ONCE THE MATERIALS HAVE REACHED A DEPTH OF 2'. 5. CONCRETE WASHOUT WATER, WASTED PIECES OF CONCRETE AND ALL OTHER DEBRIS IN THE SUBSURFACE PIT SHALL BE TRANSPORTED FROM THE JOB SITE IN A WATER-TIGHT CONTAINER AND DISPOSED OF PROPERLY. 6. THE CWA SHALL REMAIN IN PLACE UNTIL ALL CONCRETE FOR THE PROJECT IS PLACED. 7. WHEN THE CWA IS REMOVED, COVER THE DISTURBED AREA WITH TOP SOIL, SEED AND MULCH OR OTHERWISE STABILIZED IN A MANNER APPROVED BY THE LOCAL JURISDICTION. (DETAIL ADAPTED FROM DOUGLAS COUNTY, COLORADO AND THE CITY OF PARKER, COLORADO, NOT AVAILABLE IN AUTOCAD). $\underline{\text{NOTE}}$: MANY JURISDICTIONS HAVE BMP DETAILS THAT VARY FROM UDFCD STANDARD DETAILS. CONSULT WITH LOCAL JURISDICTIONS AS TO WHICH DETAIL SHOULD BE USED WHEN DIFFERENCES ARE NOTED.

MM-1

STABILIZED STAGING AREA MAINTENANCE NOTES 5. STABILIZED STAGING AREA SHALL BE ENLARGED IF NECESSARY TO CONTAIN PARKING, STORAGE, AND UNLOADING/LOADING OPERATIONS. 6. THE STABILIZED STAGING AREA SHALL BE REMOVED AT THE END OF CONSTRUCTION. THE GRANULAR MATERIAL SHALL BE REMOVED OR, IF APPROVED BY THE LOCAL JURISDICTION, USED ON SITE, AND THE AREA COVERED WITH TOPSOIL, SEEDED AND MULCHED OR OTHERWISE STABILIZED IN A MANNER APPROVED BY LOCAL JURISDICTION. NOTE: MANY MUNICIPALITIES PROHIBIT THE USE OF RECYCLED CONCRETE AS GRANULAR MATERIAL FOR STABILIZED STAGING AREAS DUE TO DIFFICULTIES WITH RE-ESTABLISHMENT OF VEGETATION IN AREAS WHERE RECYCLED CONCRETE WAS PLACED. NOTE: MANY JURISDICTIONS HAVE BMP DETAILS THAT VARY FROM UDFCD STANDARD DETAILS. CONSULT WITH LOCAL JURISDICTIONS AS TO WHICH DETAIL SHOULD BE USED WHEN DIFFERENCES ARE NOTED. (DETAILS ADAPTED FROM DOUGLAS COUNTY, COLORADO, NOT AVAILABLE IN AUTOCAD)

Stabilized Staging Area (SSA)

SUBMITTAL CONSTRUCTION **DOCUMENTS** DRAWN BY: PROJECT NO .: 23-222-002 REVISIONS 08/31/2023

541 E. Garden Drive,

Windsor, CO 80550

PROJECT TITLE

203 PERRY ST.

PROPERTIES

PREPARED FOR

BAYSIDE

LITTLE SCHOOL

CASTLE ROCK, CO 80104

MISSION CAPITAL

ON PERRY ST

SM-6

SSA

W ridgetopeng.con

SEDIMENT CONTROL LOG

Urban Storm Drainage Criteria Manual Volume 3 CONCRETE WASHOUT AREA

Urban Drainage and Flood Control District

November 2010

NOTE: CURRENT PLAN SET IS NOT FOR CONSTRUCTION

Urban Storm Drainage Criteria Manual Volume 3

STABILIZED STAGING AREA

SITE DEVELOPMENT PLAN LOT 6 & S ½ OF LOT 5, BLOCK 22, TOWN OF CASTLE ROCK TOWN OF CASTLE ROCK PROJECT NO: SDP23-0032

Concrete Washout Area (CWA)

MM-1

Urban Drainage and Flood Control District

Know what's below.

Call before you dig.

November 2010

SHEET INFORMATION

EROSION

CONTROL

DETAILS

LOT 6 & S 1/2 OF LOT 5, BLOCK 22, TOWN OF CASTLE ROCK LOCATED IN THE NORTHWEST QUARTER OF SECTION 11, TOWNSHIP 8, RANGE 67 WEST OF THE 6TH P.M. TOWN OF CASTLE ROCK, COUNTY OF DOUGLAS, STATE OF COLORADO

541 E. Garden Drive, W ridgetopeng.com Windsor, CO 80550

PROJECT TITLE LITTLE SCHOOL ON PERRY ST

203 PERRY ST. CASTLE ROCK, CO 80104

PREPARED FOR MISSION CAPITAL **PROPERTIES BAYSIDE**

SUBMITTAL CONSTRUCTION DOCUMENTS

DRAWN BY:	A
CHECKED BY:	MR
PROJECT NO.:	23-222-00
REVISIONS	

08/31/2023

SHEET TITLE

EROSION CONTROL

DETAILS SHEET INFORMATION

ER-2.2

SITE DEVELOPMENT PLAN LOT 6 & S 1/2 OF LOT 5, BLOCK 22, TOWN OF CASTLE ROCK TOWN OF CASTLE ROCK PROJECT NO: SDP23-0032

NOTE: CURRENT PLAN SET IS NOT FOR CONSTRUCTION

Of



(3535) 1½" (MINUS) CRUSHED ROCK ENCLOSED IN WIRE MESH O" ON BEDROCK OR GROUND SURFACE HARD SURFACE, 2"

Rock Sock (RS)

ROCK SOCK PLAN **ROCK SOCK SECTION**

ANY GAP AT JOINT SHALL BE FILLED WITH AN ADEQUATE ANY GAP AI JOINI SHALL BE FILLED WITH AN ADEQUATE AMOUNT OF 1½" (MINUS) CRUSHED ROCK AND WRAPPED WITH ADDITIONAL WIRE MESH SECURED TO ENDS OF ROCK - REINFORCED SOCK. AS AN ALTERNATIVE TO FILLING JOINTS BETWEEN ADJOINING ROCK SOCKS WITH CRUSHED ROCK AND ADDITIONAL WIRE WRAPPING, ROCK SOCKS CAN BE OVERLAPPED (TYPICALLY 12-INCH OVERLAP) TO AVOID GAPS. ROCK SOCK, _ SIEVE SIZE MASS PERCENT PASSING SQUARE MESH SIEVES **ROCK SOCK JOINTING** ROCK SOCK INSTALLATION NOTES

MATCHES SPECIFICATIONS FOR NO. 4 COARSE AGGREGATE FOR CONCRETE PER AASHTO M43. ALL ROCK SHALL BE FRACTURED FACE, ALL SIDES. SEE PLAN VIEW FOR:
 -LOCATION(S) OF ROCK SOCKS. 2. CRUSHED ROCK SHALL BE 1½" (MINUS) IN SIZE WITH A FRACTURED FACE (ALL SIDES) AND SHALL COMPLY WITH GRADATION SHOWN ON THIS SHEET (11/2" MINUS). 3. WIRE MESH SHALL BE FABRICATED OF 10 GAGE POULTRY MESH, OR EQUIVALENT, WITH A MAXIMUM OPENING OF ½", RECOMMENDED MINIMUM ROLL WIDTH OF 48" 4. WIRE MESH SHALL BE SECURED USING "HOG RINGS" OR WIRE TIES AT 6" CENTERS ALONG ALL JOINTS AND AT 2" CENTERS ON ENDS OF SOCKS. 5. SOME MUNICIPALITIES MAY ALLOW THE USE OF FILTER FABRIC AS AN ALTERNATIVE TO WIRE MESH FOR THE ROCK ENCLOSURE. RS-1. ROCK SOCK PERIMETER CONTROL

Urban Drainage and Flood Control District Urban Storm Drainage Criteria Manual Volume 3

Rock Sock (RS)

ROCK SOCK MAINTENANCE NOTES

1. INSPECT BMPs EACH WORKDAY, AND MAINTAIN THEM IN EFFECTIVE OPERATING CONDITION.
MAINTENANCE OF BMPs SHOULD BE PROACTIVE, NOT REACTIVE. INSPECT BMPs AS SOON AS
POSSIBLE (AND ALWAYS WITHIN 24 HOURS) FOLLOWING A STORM THAT CAUSES SURFACE EROSION, AND PERFORM NECESSARY MAINTENANCE.

2. FREQUENT OBSERVATIONS AND MAINTENANCE ARE NECESSARY TO MAINTAIN BMPs IN EFFECTIVE OPERATING CONDITION. INSPECTIONS AND CORRECTIVE MEASURES SHOULD BE DOCUMENTED THOROUGHLY.

3. WHERE BMPs HAVE FAILED, REPAIR OR REPLACEMENT SHOULD BE INITIATED UPON DISCOVERY OF THE FAILURE.

4. ROCK SOCKS SHALL BE REPLACED IF THEY BECOME HEAVILY SOILED, OR DAMAGED 5. SEDIMENT ACCUMULATED UPSTREAM OF ROCK SOCKS SHALL BE REMOVED AS NEEDED TO MAINTAIN FUNCTIONALITY OF THE BMP, TYPICALLY WHEN DEPTH OF ACCUMULATED SEDIMENTS

6. ROCK SOCKS ARE TO REMAIN IN PLACE UNTIL THE UPSTREAM DISTURBED AREA IS STABILIZED AND APPROVED BY THE LOCAL JURISDICTION.

(DETAIL ADAPTED FROM TOWN OF PARKER, COLORADO AND CITY OF AURORA, COLORADO, NOT AVAILABLE IN AUTOCAD)

NOTE: MANY JURISDICTIONS HAVE BMP DETAILS THAT VARY FROM UDFCD STANDARD DETAILS. CONSULT WITH LOCAL JURISDICTIONS AS TO WHICH DETAIL SHOULD BE USED WHEN DIFFERENCES ARE NOTED.

November 2010

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RS-3


ROCK SOCKS

IS APPROXIMATELY & OF THE HEIGHT OF THE ROCK SOCK.

7. WHEN ROCK SOCKS ARE REMOVED, ALL DISTURBED AREAS SHALL BE COVERED WITH TOPSOIL, SEEDED AND MULCHED OR OTHERWISE STABILIZED AS APPROVED BY LOCAL JURISDICTION.

NOTE: THE DETAILS INCLUDED WITH THIS FACT SHEET SHOW COMMONLY USED, CONVENTIONAL METHODS OF ROCK SOCK INSTALLATION IN THE DENVER METROPOLITAN AREA. THERE ARE MANY OTHER SIMILAR PROPRIETARY PRODUCTS ON THE MARKET. UDFCD NEITHER NDORSES NOR DISCOURAGES USE OF PROPRIETARY PROTECTION PRODUCTS; HOWEVER, IN THE EVENT PROPRIETARY METHODS ARE USED, THE APPROPRIATE DETAIL FROM THE MANUFACTURER MUST BE INCLUDED IN THE SWMP AND THE BMP MUST BE INSTALLED AND MAINTAINED AS SHOWN IN THE MANUFACTURER'S DETAILS.

LOT 6 & S 1/2 OF LOT 5, BLOCK 22, TOWN OF CASTLE ROCK LOCATED IN THE NORTHWEST QUARTER OF SECTION 11, TOWNSHIP 8, RANGE 67 WEST OF THE 6TH P.M. TOWN OF CASTLE ROCK, COUNTY OF DOUGLAS, STATE OF COLORADO

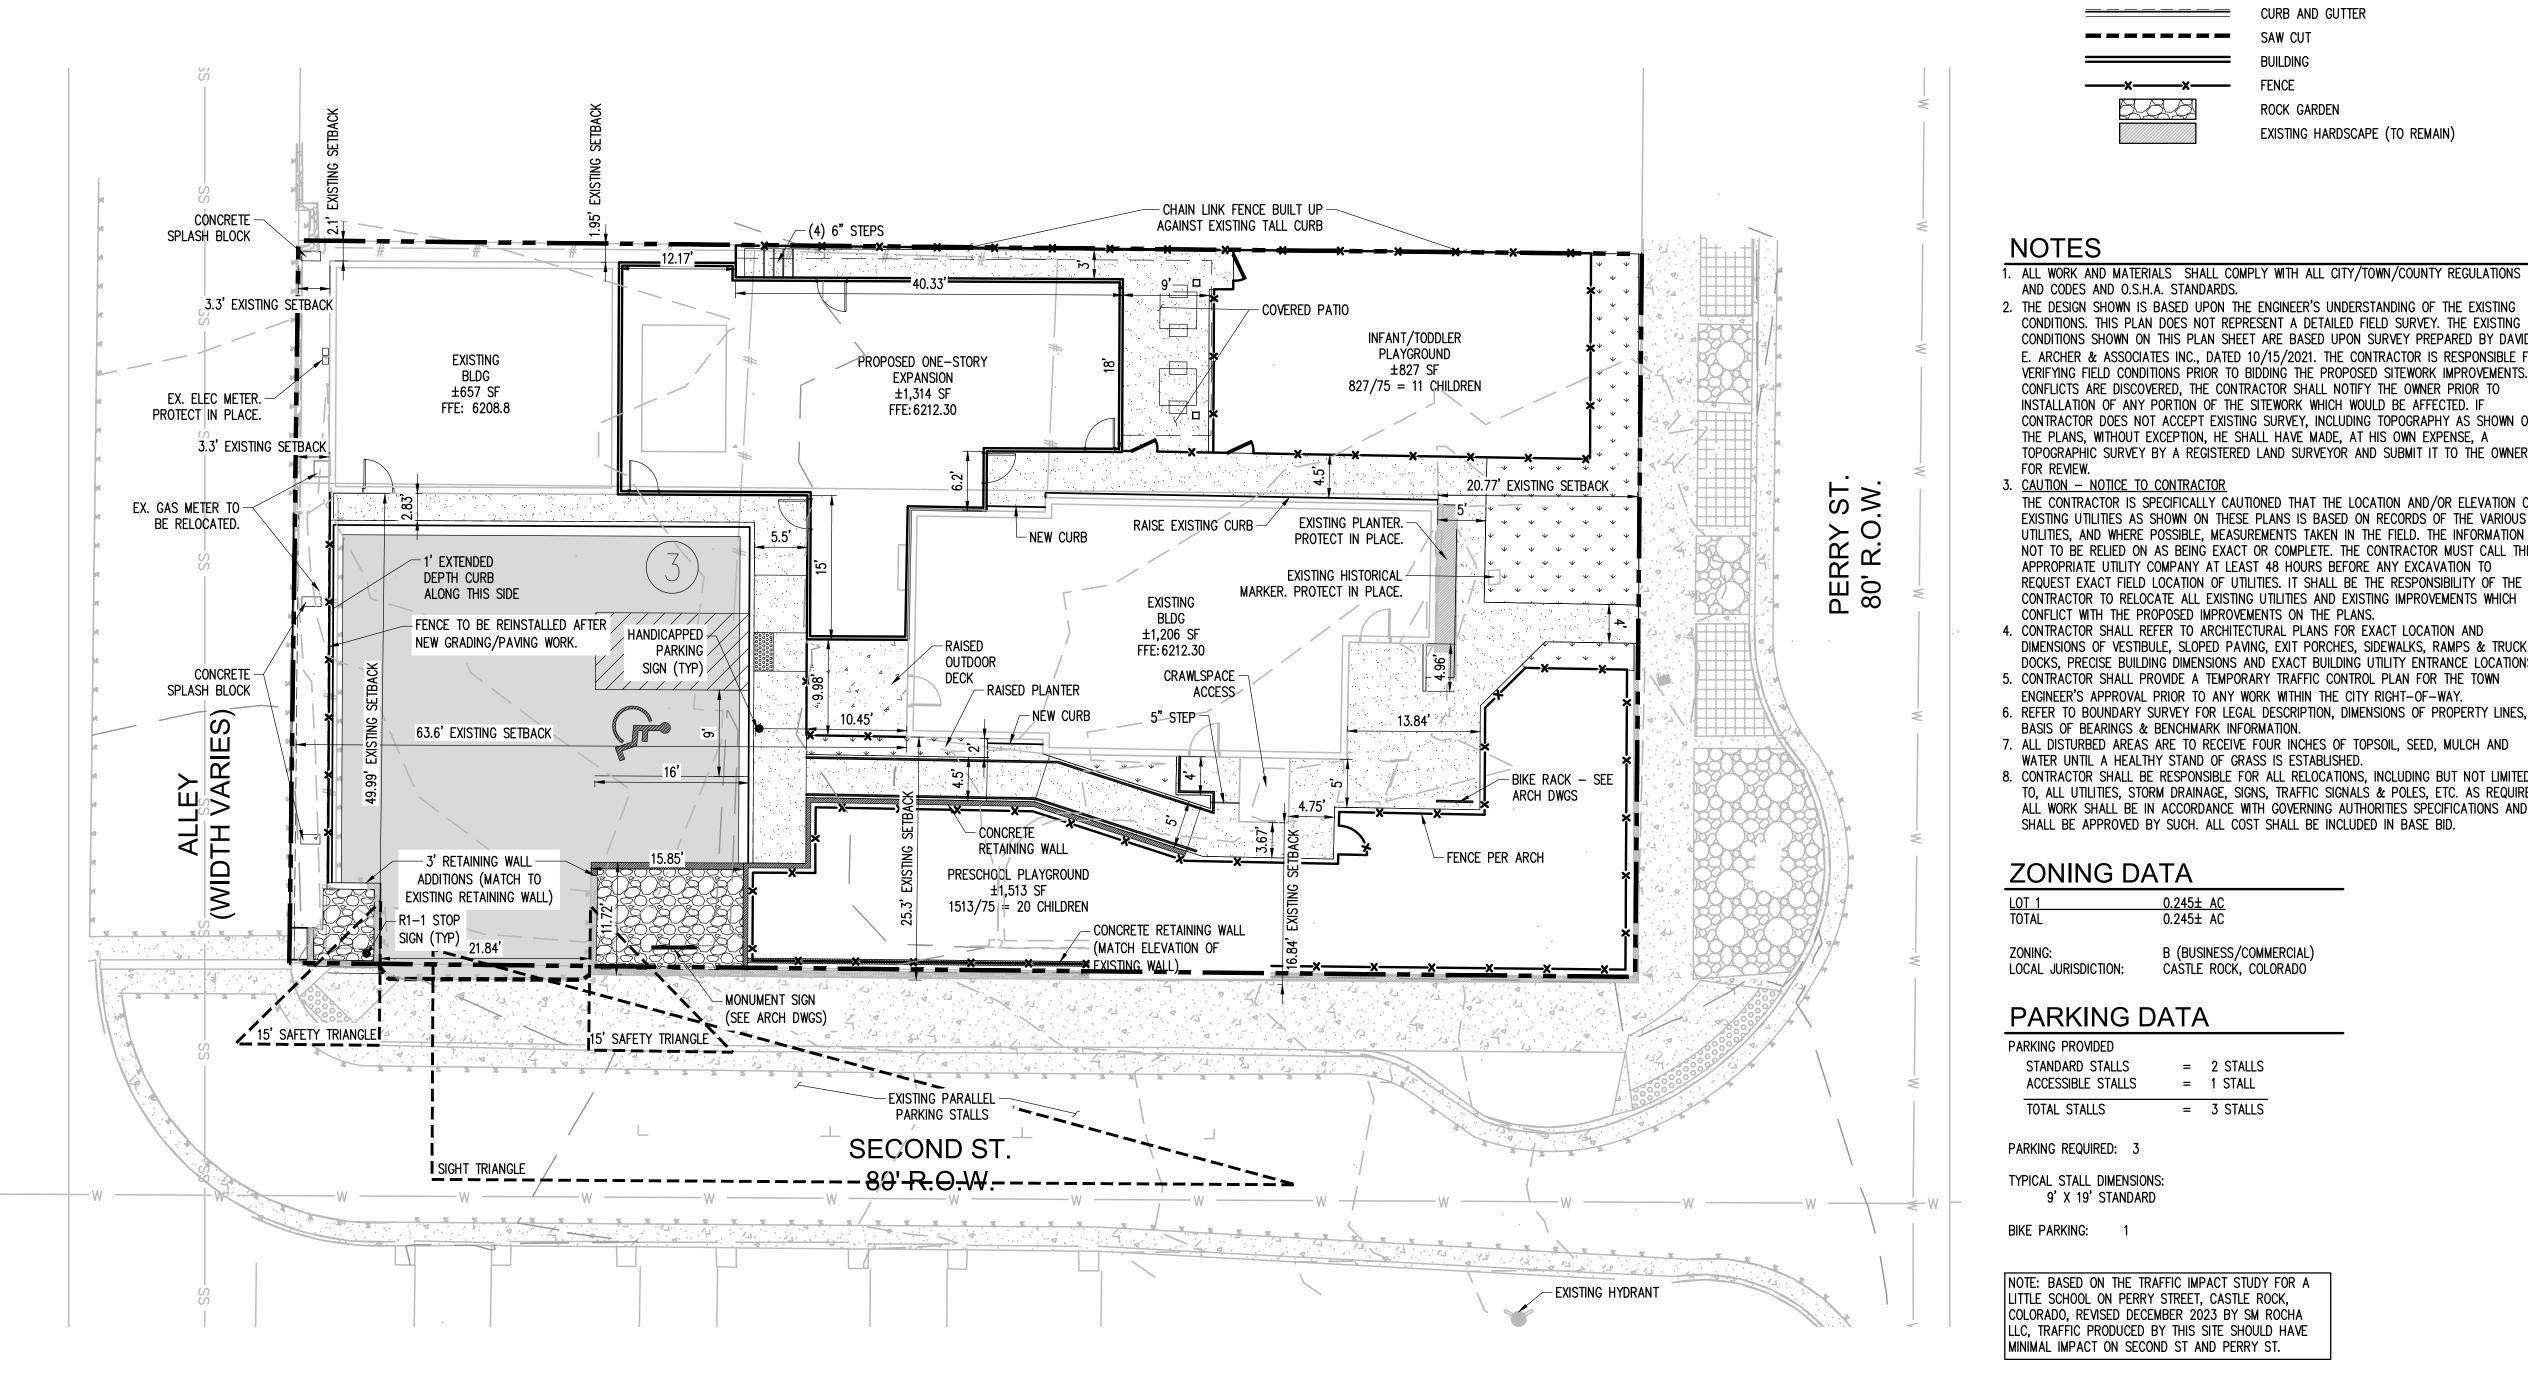

PLANT MIXED BITUMINOUS PAVEMENT AGGREGATE BASE COURSE (CLASS 6) 12" OF MOISTURE CONDITIONED AND COMPACTED SUITABLE NATIVE MATERIAL OR ENGINEERED FILL PER GEOTECHNICAL SIGHT TRIANGLE DIMENSIONS REPORT. UNSUITABLE NATIVE MATERIAL SHALL BE OVEREXCAVATED AND PARKING/LIGHT DUTY PAVEMENT - PORTLAND CEMENT CONCRETE NOTE: NO ITEMS THAT ARE WIDER THAN

SIGHT TRIANGLE (25 MPH)

■ DEVICES AND EQUIPMENT.

18 INCHES MAY BE TALLER THAN 30

■ STREET TREES AND TRAFFIC CONTROL

I INCHES WITHIN THIS TRIANGLE EXCEPT FOR


12" OF MOISTURE CONDITIONED COMPACTED SUITABLE NATIVE MATERIAL OR ENGINEERED FILL PER GEOTECHNICAL REPORT. UNSUITABLE NATIVE MATERIAL SHALL BE OVEREXCAVATED AND REPLACED. SIDEWALK/CONCRETE


PAVEMENT NOTES

- 1. MATERIAL THICKNESS IS COMPACTED DEPTH. APPLIES TO ALL SECTIONS. 2. SUITABLE ONSITE SOILS SHALL BE FREE OF DELETERIOUS MATERIALS AND MAY BE USED FOR SUBGRADE PROVIDED SOILS MEET REQUIREMENTS AS SET FORTH IN THE GEOTECHNICAL REPORT.
- 3. PROOFROLLING OF PAVEMENT SUBGRADES UNDER GEOTECHNICAL SUPERVISION SHOULD BE COMPLETED TO HELP IDENTIFY UNSTABLE AREAS. ANY INSTABILITY OF THE SUBGRADE SOILS OBSERVED AT THE TIME OF PROOFROLLING, SHOULD BE REPAIRED. IF PROOFROLLING CANNOT BE ACHIEVED, THE SUBGRADE SHALL BE STABILIZED.
- 4. THE SUBGRADE SHOULD BE SCARIFIED TO THE REQUIRED DEPTH AND THEN COMPACTED TO 95 PERCENT OF THE MAXIMUM DRY DENSITY AS OBTAINED BY ASTM D698 AND MOISTURE CONTENT BETWEEN -2 TO +2 PERCENTAGE POINTS OF OPTIMUM MOISTURE CONTENT. BASE COURSE MATERIAL SHOULD BE PLACED IMMEDIATELY UPON COMPLETION OF THE SUBGRADE COMPACTION OPERATION TO
- PREVENT DRYING OF THE SOILS DUE TO EXPOSURE ASPHALTIC CONCRETE SHOULD CONSIST OF A BITUMINOUS PLANT MIX COMPOSED OF A MIXTURE OF AGGREGATE, FILLER, BINDERS AND ADDITIVES (IF REQUIRED) MEETING THE DESIGN REQUIREMENTS FOR THE TOWN OF CASTLE ROACK. AGGREGATE USED IN ASPHALT CONCRETE SHOULD MEET TABLE 11 OF THE PAVEMENT MATERIALS AS
- INDICATED IN THE PROJECT GEOTECHNICAL REPORT. 6. AGGREGATE BASE COURSE SHOULD BE CONSISTENT WITH CDOT REQUIREMENTS FOR CLASS 6 AGGREGATE BASE.
- 7. ALL ASPHALT PAVEMENTS MATERIALS SHALL COMPLY WITH TOWN OF CASTLE ROCK AND MGPEC SPECIFICATIONS.
- 8. SEE "GEOTECHNICAL ENGINEERING REPORT THE LITTLE SCHOOL ON PERRY STREET,
- 203 PERRY STREET. CASTLE ROCK, COLORADO 80104" PREPARED BY TRIAX ENGINEERING DATED SEPTEMBER 22, 2023 FOR MORE INFORMATION. . SEE TOWN OF CASTLE ROCK STANDARDS AND SPECIFICATIONS FOR ADDITIONAL INFORMATION REGARDING ASPHALT AND CONCRETE PAVEMENTS.

LEGEND

AND CODES AND O.S.H.A. STANDARDS.

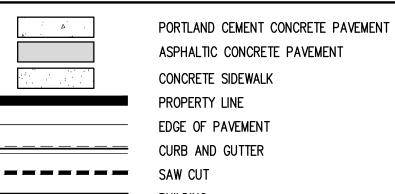

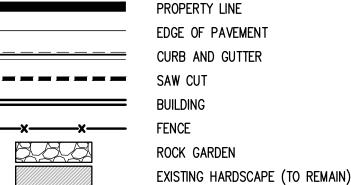

CONDITIONS. THIS PLAN DOES NOT REPRESENT A DETAILED FIELD SURVEY. THE EXISTING

INSTALLATION OF ANY PORTION OF THE SITEWORK WHICH WOULD BE AFFECTED, IF

THE PLANS, WITHOUT EXCEPTION, HE SHALL HAVE MADE, AT HIS OWN EXPENSE, A

CONDITIONS SHOWN ON THIS PLAN SHEET ARE BASED UPON SURVEY PREPARED BY DAVID

E. ARCHER & ASSOCIATES INC., DATED 10/15/2021. THE CONTRACTOR IS RESPONSIBLE FOR VERIFYING FIELD CONDITIONS PRIOR TO BIDDING THE PROPOSED SITEWORK IMPROVEMENTS. IF

CONTRACTOR DOES NOT ACCEPT EXISTING SURVEY, INCLUDING TOPOGRAPHY AS SHOWN ON

TOPOGRAPHIC SURVEY BY A REGISTERED LAND SURVEYOR AND SUBMIT IT TO THE OWNER

THE CONTRACTOR IS SPECIFICALLY CAUTIONED THAT THE LOCATION AND/OR ELEVATION OF

UTILITIES, AND WHERE POSSIBLE, MEASUREMENTS TAKEN IN THE FIELD. THE INFORMATION IS

NOT TO BE RELIED ON AS BEING EXACT OR COMPLETE. THE CONTRACTOR MUST CALL THE

REQUEST EXACT FIELD LOCATION OF UTILITIES. IT SHALL BE THE RESPONSIBILITY OF THE

DIMENSIONS OF VESTIBULE, SLOPED PAVING, EXIT PORCHES, SIDEWALKS, RAMPS & TRUCK

DOCKS, PRECISE BUILDING DIMENSIONS AND EXACT BUILDING UTILITY ENTRANCE LOCATIONS.

8. CONTRACTOR SHALL BE RESPONSIBLE FOR ALL RELOCATIONS, INCLUDING BUT NOT LIMITED

TO, ALL UTILITIES, STORM DRAINAGE, SIGNS, TRAFFIC SIGNALS & POLES, ETC. AS REQUIRED. ALL WORK SHALL BE IN ACCORDANCE WITH GOVERNING AUTHORITIES SPECIFICATIONS AND

CONTRACTOR TO RELOCATE ALL EXISTING UTILITIES AND EXISTING IMPROVEMENTS WHICH

APPROPRIATE UTILITY COMPANY AT LEAST 48 HOURS BEFORE ANY EXCAVATION TO

ENGINEER'S APPROVAL PRIOR TO ANY WORK WITHIN THE CITY RIGHT-OF-WAY.

SHALL BE APPROVED BY SUCH. ALL COST SHALL BE INCLUDED IN BASE BID.

B (BUSINESS/COMMERCIAL) CASTLE ROCK, COLORADO

> = 2 STALLS = 1 STALL

= 3 STALLS

CONFLICT WITH THE PROPOSED IMPROVEMENTS ON THE PLANS.

WATER UNTIL A HEALTHY STAND OF GRASS IS ESTABLISHED.

BASIS OF BEARINGS & BENCHMARK INFORMATION.

LOCAL JURISDICTION:

PARKING PROVIDED STANDARD STALLS

TOTAL STALLS

BIKE PARKING: 1

1 inch = 10 ft.

Know what's below.

Call before you dig.

ACCESSIBLE STALLS

9' X 19' STANDARD

LITTLE SCHOOL ON PERRY STREET, CASTLE ROCK,

MINIMAL IMPACT ON SECOND ST AND PERRY ST.

COLORADO, REVISED DECEMBER 2023 BY SM ROCHA LLC, TRAFFIC PRODUCED BY THIS SITE SHOULD HAVE

EXISTING UTILITIES AS SHOWN ON THESE PLANS IS BASED ON RECORDS OF THE VARIOUS



PROJECT TITLE

LITTLE SCHOOL **ON PERRY ST**

203 PERRY ST. CASTLE ROCK, CO 80104

PREPARED FOR MISSION CAPITAL

PROPERTIES BAYSIDE

DRAWN BY: CHECKED BY: PROJECT NO .: REVISIONS

SUBMITTAL

CONSTRUCTION DOCUMENTS

08/31/2023

SHEET TITLE

SITE PLAN

SHEET INFORMATION

C-1.0

SITE DEVELOPMENT PLAN LOT 6 & S ½ OF LOT 5, BLOCK 22, TOWN OF CASTLE ROCK TOWN OF CASTLE ROCK PROJECT NO: SDP23-0032


NOTE: CURRENT PLAN SET

IS NOT FOR CONSTRUCTION

±4" STEP TO EXISTING GRADE \FG_10.24 \(-(4) 6"\STEPS SITE BLOWUP 1

CONSTRUCTION DOCUMENTS

LOT 6 & S 1/2 OF LOT 5, BLOCK 22, TOWN OF CASTLE ROCK LOCATED IN THE NORTHWEST QUARTER OF SECTION 11, TOWNSHIP 8, RANGE 67 WEST OF THE 6TH P.M. TOWN OF CASTLE ROCK, COUNTY OF DOUGLAS, STATE OF COLORADO

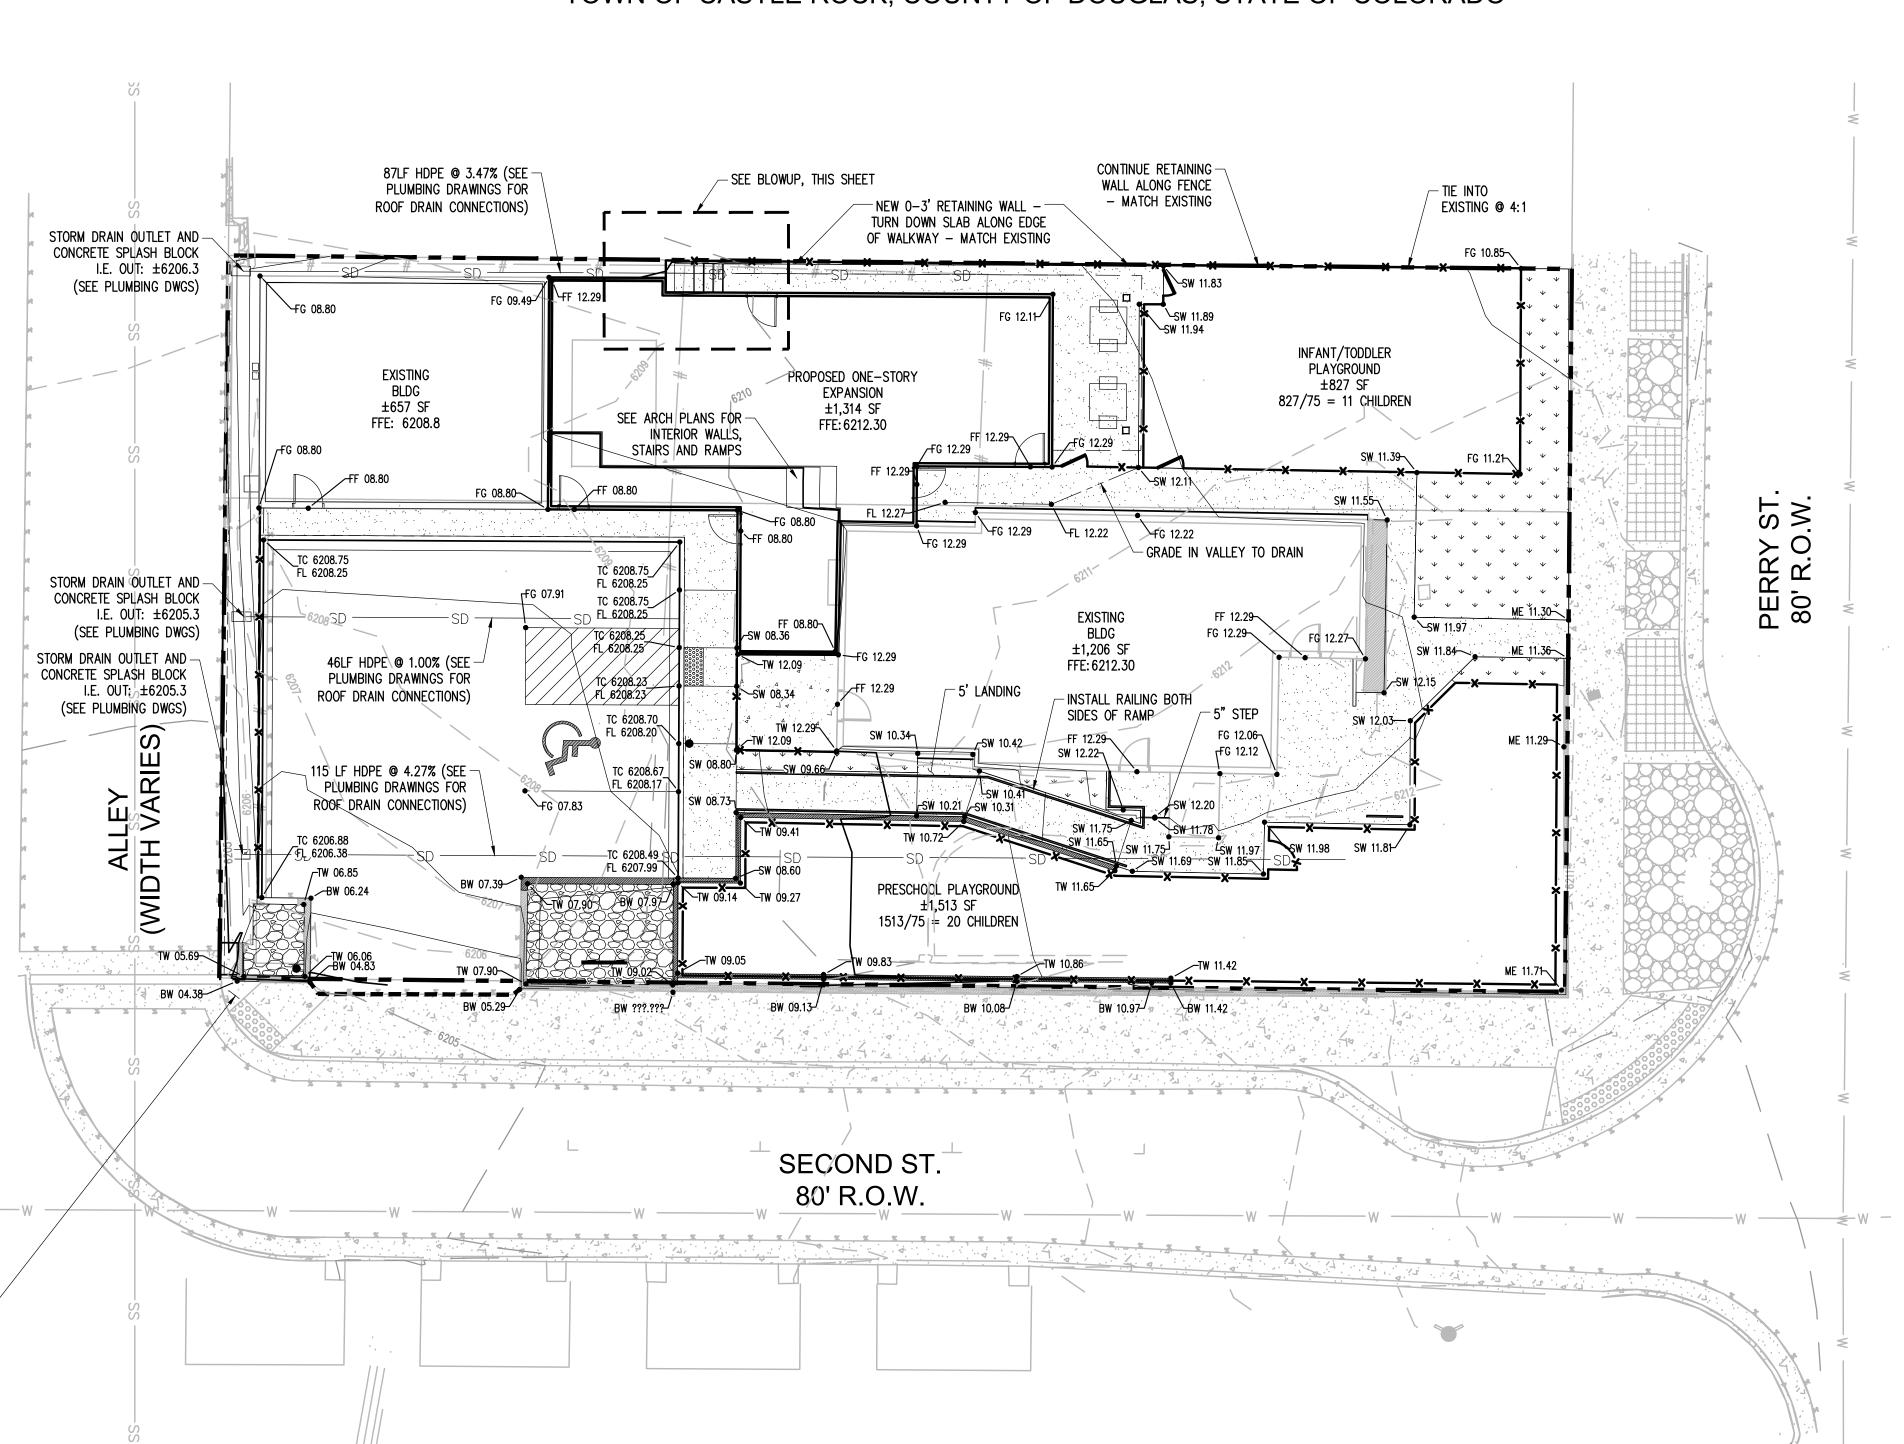

LEGEND

EX. CONTOUR	24
PROPOSED CONTOUR	322
PROPERTY LINE	
SPOT ELEVATION	<u>4653</u> ●
TOP OF CURB	TC
FINISHED GRADE	FG
FINISHED FLOOR	FF
SIDEWALK	SW
MATCH EXISTING	ME
FLOW LINE	FL
HIGH POINT	HP
TOP OF WALL	TW
BOTTOM OF WALL	BW

NOTES

1. ALL WORK AND MATERIALS SHALL COMPLY WITH ALL CITY/TOWN/COUNTY REGULATIONS AND CODES AND O.S.H.A. STANDARDS.

THE DESIGN SHOWN IS BASED UPON THE ENGINEER'S UNDERSTANDING OF THE EXISTING CONDITIONS. THIS PLAN DOES NOT REPRESENT A DETAILED FIELD SURVEY. THE EXISTING CONDITIONS SHOWN ON THIS PLAN SHEET ARE BASED UPON SURVEY PREPARED BY DAVID E. ARCHER & ASSOCIATES INC., DATED 10/15/2021. THE CONTRACTOR IS RESPONSIBLE FOR VERIFYING FIELD CONDITIONS PRIOR TO BIDDING THE PROPOSED SITEWORK IMPROVEMENTS. IF CONFLICTS ARE DISCOVERED, THE CONTRACTOR SHALL NOTIFY THE OWNER PRIOR TO INSTALLATION OF ANY PORTION OF THE SITEWORK WHICH WOULD BE AFFECTED. IF CONTRACTOR DOES NOT ACCEPT EXISTING SURVEY, INCLUDING TOPOGRAPHY AS SHOWN ON

THE PLANS, WITHOUT EXCEPTION, HE SHALL HAVE MADE, AT HIS OWN EXPENSE, A TOPOGRAPHIC SURVEY BY A REGISTERED LAND SURVEYOR AND SUBMIT IT TO THE OWNER FOR REVIEW. 3. CAUTION - NOTICE TO CONTRACTOR

THE CONTRACTOR IS SPECIFICALLY CAUTIONED THAT THE LOCATION AND/OR ELEVATION OF EXISTING UTILITIES AS SHOWN ON THESE PLANS IS BASED ON RECORDS OF THE VARIOUS UTILITIES, AND WHERE POSSIBLE, MEASUREMENTS TAKEN IN THE FIELD. THE INFORMATION IS NOT TO BE RELIED ON AS BEING EXACT OR COMPLETE. THE CONTRACTOR MUST CALL THE APPROPRIATE UTILITY COMPANY AT LEAST 48 HOURS BEFORE ANY EXCAVATION TO REQUEST EXACT FIELD LOCATION OF UTILITIES. IT SHALL BE THE RESPONSIBILITY OF THE CONTRACTOR TO RELOCATE ALL EXISTING UTILITIES AND EXISTING IMPROVEMENTS WHICH CONFLICT WITH THE PROPOSED IMPROVEMENTS ON THE PLANS.

. CONTRACTOR SHALL REFER TO ARCHITECTURAL PLANS FOR EXACT LOCATION AND DIMENSIONS OF VESTIBULE, SLOPED PAVING, EXIT PORCHES, SIDEWALKS, RAMPS & TRUCK DOCKS, PRECISE BUILDING DIMENSIONS AND EXACT BUILDING UTILITY ENTRANCE LOCATIONS.

5. CONTRACTOR SHALL PROVIDE A TEMPORARY TRAFFIC CONTROL PLAN FOR THE CITY ENGINEER'S APPROVAL PRIOR TO ANY WORK WITHIN THE CITY RIGHT-OF-WAY.

6. REFER TO BOUNDARY SURVEY FOR LEGAL DESCRIPTION, DIMENSIONS OF PROPERTY LINES, BASIS OF BEARINGS & BENCHMARK INFORMATION. 7. ALL DISTURBED AREAS ARE TO RECEIVE FOUR INCHES OF TOPSOIL, SEED, MULCH AND


WATER UNTIL A HEALTHY STAND OF GRASS IS ESTABLISHED. 8. CONTRACTOR SHALL BE RESPONSIBLE FOR ALL RELOCATIONS, INCLUDING BUT NOT LIMITED TO, ALL UTILITIES, STORM DRAINAGE, SIGNS, TRAFFIC SIGNALS & POLES, ETC. AS REQUIRED. ALL WORK SHALL BE IN ACCORDANCE WITH GOVERNING AUTHORITIES SPECIFICATIONS AND

GRADING NOTES

1. ALL UNSURFACED AREAS DISTURBED BY GRADING OPERATION SHALL RECEIVE 4 INCHES OF TOPSOIL. CONTRACTOR SHALL APPLY STABILIZATION FABRIC TO ALL SLOPES 3H:1V OR STEEPER. CONTRACTOR SHALL STABILIZE DISTURBED AREAS WITH GRASS IN ACCORDANCE

SHALL BE APPROVED BY SUCH. ALL COST SHALL BE INCLUDED IN BASE BID.

- WITH LOCAL SPECIFICATION UNTIL A HEALTHY STAND OF GRASS IS OBTAINED. 2. ALL CUT AND FILL SLOPES SHALL BE CONSTRUCTED PER THE IBC CODE AND APPLICABLE LOCAL REGULATION. ALL CUT AND FILL SLOPES SHALL BE 3:1 OR FLATTER UNLESS
- 3. CONTRACTOR SHALL ASSURE POSITIVE DRAINAGE AWAY FROM BUILDINGS FOR ALL NATURAL AND PAVED AREAS AND SHALL GRADE ALL AREAS TO PRECLUDE PONDING OF WATER.
- 4. ALL POLLUTANTS OTHER THAN SEDIMENT ON-SITE DURING CONSTRUCTION SHALL BE HANDLED AND DISPOSED OF IN A MANNER THAT DOES NOT CAUSE CONTAMINATION OF STORMWATER. THE CONTRACTOR SHALL ADHERE TO ALL TERMS AND CONDITIONS AS OUTLINED IN THE GENERAL N.P.D.E.S. PERMIT FOR STORMWATER DISCHARGE ASSOCIATED
- WITH CONSTRUCTION ACTIVITIES. 5. PROPERTIES AND WATERWAYS DOWNSTREAM OF THE SITE SHALL BE PROTECTED FROM EROSION DUE TO INCREASES IN THE VOLUME, VELOCITY AND PEAK FLOW RATE OF STORMWATER RUNOFF FROM PROJECT SITE.
- 6. CONSTRUCTION SHALL COMPLY WITH ALL APPLICABLE GOVERNING CODES AND BE CONSTRUCTED TO SAME.
- 7. CONTRACTOR TO REMOVE UNSUITABLE SOILS LOCATED WITHIN THE BUILDINGS SPLAY LINE OF THE FOOTINGS. 8. FOR BOUNDARY AND TOPOGRAPHIC INFORMATION REFER TO PROJECT SURVEY.
- 9. REUSE OF NATIVE MATERIAL PERMITTED IF PLACED IN 8" LIFTS AND COMPACTED TO 95%
- 10. SPOT ELEVATIONS SHOWN ARE TO THE TOP OF PAVEMENT, SWALE FLOWLINE, OR FINISHED
- GRADE, UNLESS OTHERWISE SPECIFIED.
- 11. CONTRACTOR SHALL PERFORM A CUT AND FILL QUANTITY CALCULATION AND INCLUDE IN THE BASE BID. ANY CUT OR FILL REQUIRED IN ADDITION TO THE BASE BID SHALL BE AT THE CONTRACTOR'S EXPENSE.
- 12. CONTRACTOR TO ENSURE POSITIVE DRAINAGE AWAY FROM ALL BUILDINGS AND ARENAS. ADDITIONAL SWALES OR MINOR CHANNELIZATION GRADING EFFORTS MAY BE REQUIRED PRIOR TO SEEDING OR INSTALLING GRAVEL, ETC.

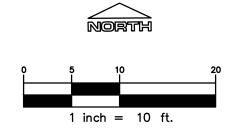



NOTE: CURRENT PLAN SET IS NOT FOR CONSTRUCTION

SITE DEVELOPMENT PLAN LOT 6 & S 1/2 OF LOT 5, BLOCK 22, TOWN OF CASTLE ROCK TOWN OF CASTLE ROCK PROJECT NO: SDP23-0032

Of



PROJECT TITLE LITTLE SCHOOL **ON PERRY ST**

203 PERRY ST. CASTLE ROCK, CO 80104

MISSION CAPITAL **PROPERTIES** BAYSIDE

PREPARED FOR

SUBMITTAL

DRAWN BY:

CHECKED BY:

PROJECT NO.:

08/31/2023

GENERAL

GRADING

SHEET INFORMATION

SHEET TITLE

PLAN


C-2.0

REVISIONS

CONSTRUCTION

DOCUMENTS

LOT 6 & S 1/2 OF LOT 5, BLOCK 22, TOWN OF CASTLE ROCK LOCATED IN THE NORTHWEST QUARTER OF SECTION 11, TOWNSHIP 8, RANGE 67 WEST OF THE 6TH P.M. TOWN OF CASTLE ROCK, COUNTY OF DOUGLAS, STATE OF COLORADO

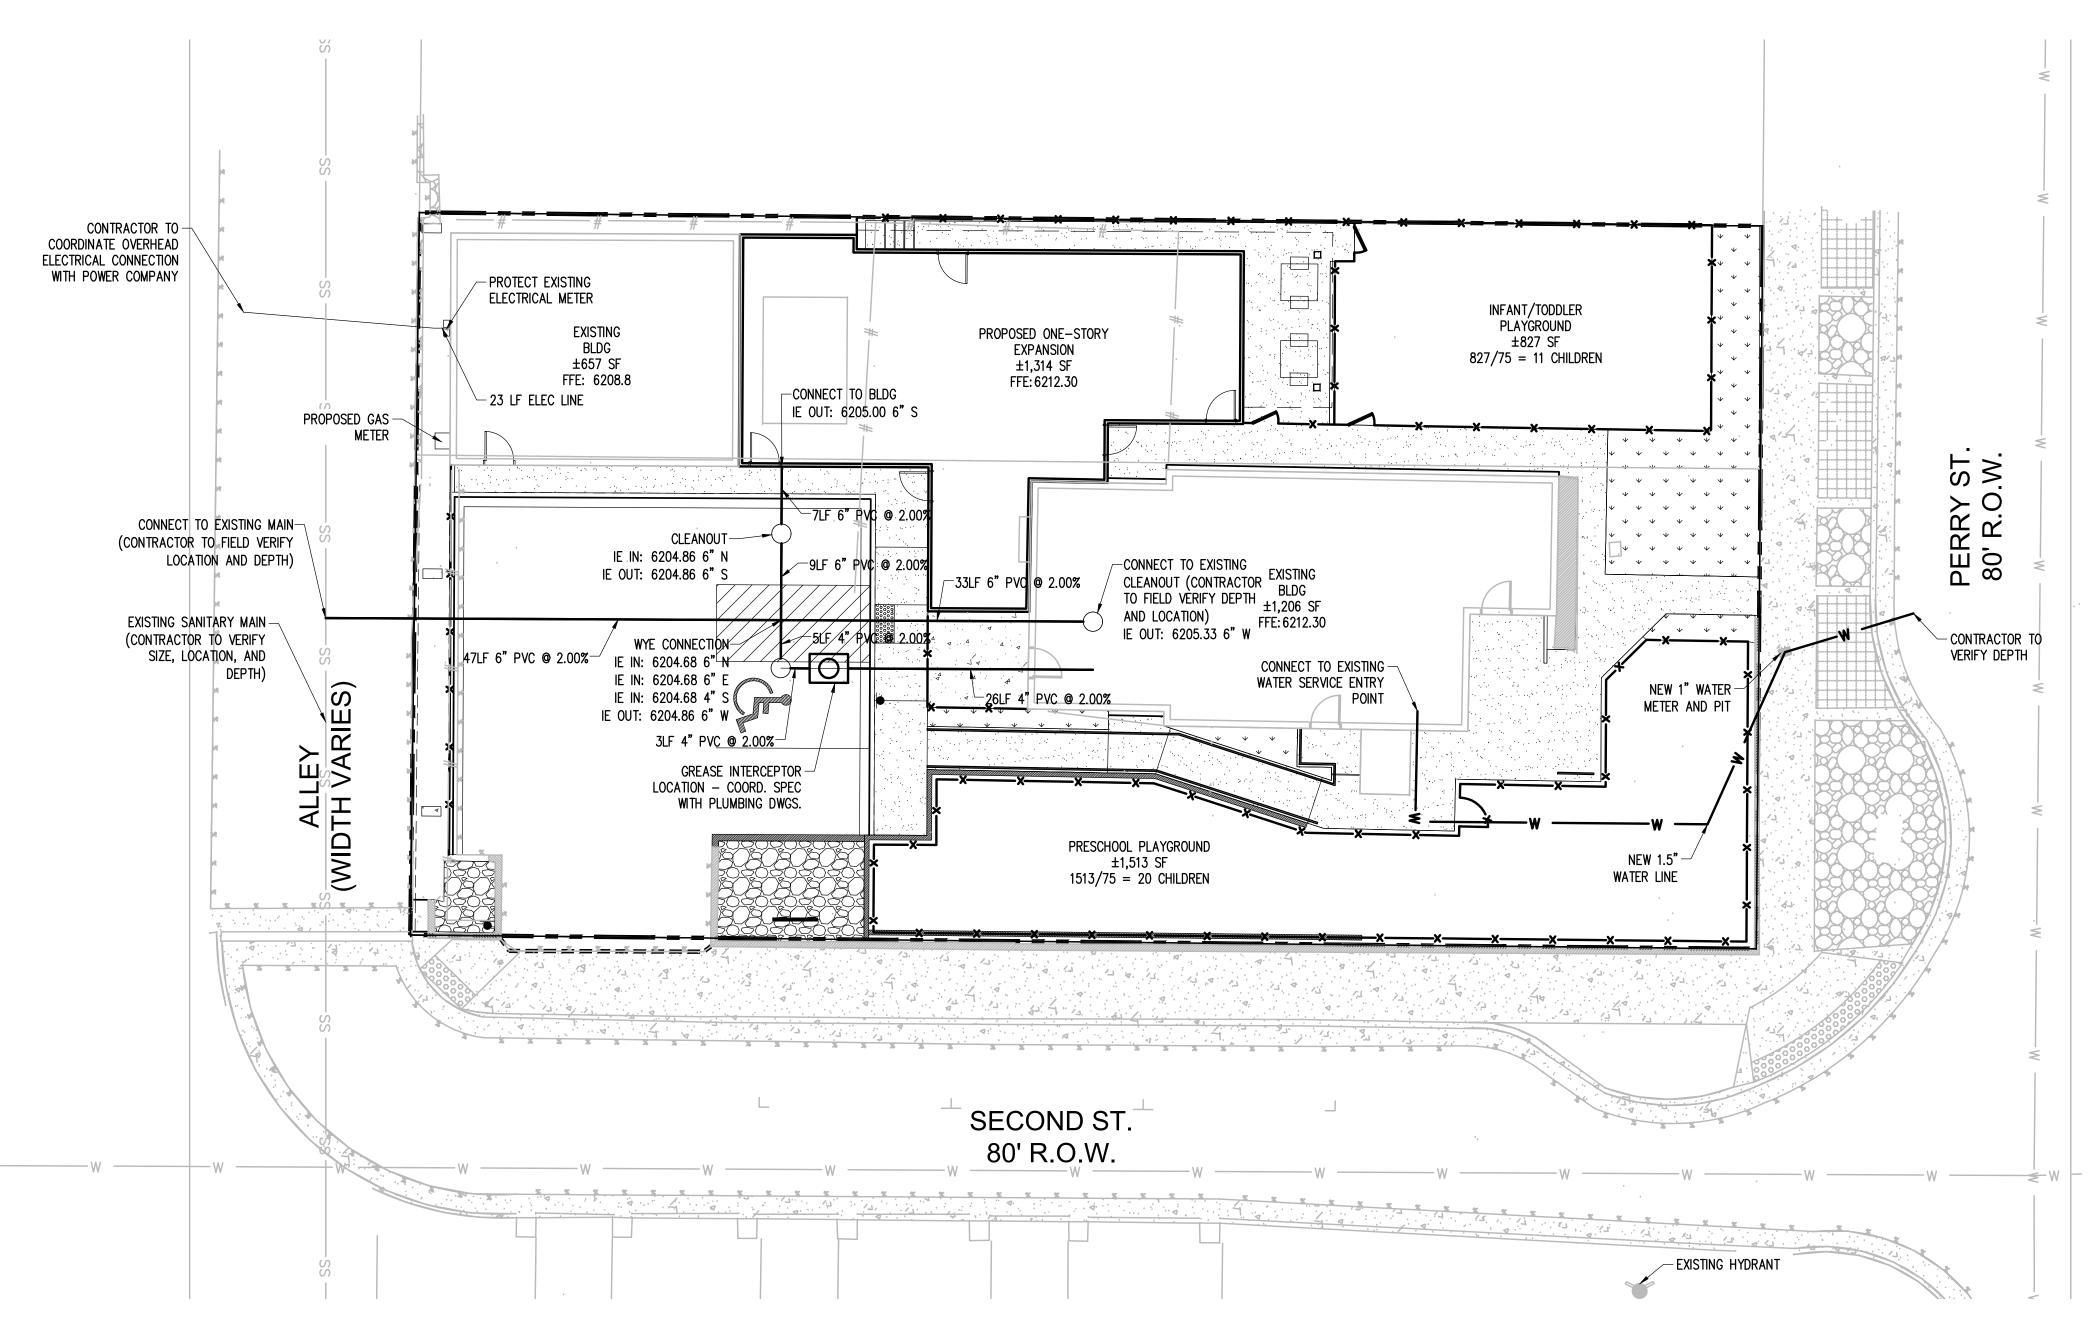

GENERAL UTILITY NOTES

- 1. ALL IMPROVEMENTS SHALL MEET LOCAL, STATE DOT AND A.P.W.A. STANDARD SPECIFICATIONS.
- REFER TO INTERIOR PLUMBING DRAWINGS FOR TIE—IN OF ALL UTILITIES.
 ALL FILL MATERIAL SHALL BE IN PLACE, AND COMPACTED BEFORE INSTALLATION OF PROPOSED UTILITIES.
 CONTRACTOR SHALL NOTIFY THE UTILITY AUTHORITIES INSPECTORS 72 HOURS BEFORE CONNECTING TO ANY
- 5. MINIMUM WATER AND SANITARY SEWER TRENCH WIDTH SHALL BE 2 FEET.
- 6. ALL UTILITIES SHOULD BE KEPT TEN (10') APART (PARALLEL) OR WHEN CROSSING 18" VERTICAL CLEARANCE (OUTSIDE EDGE OF PIPE TO OUTSIDE EDGE OF PIPE).
- 7. IN THE EVENT OF A VERTICAL CONFLICT BETWEEN WATERLINES, SANITARY LINES, STORM LINES AND GAS LINE (EXISTING AND PROPOSED), THE SANITARY LINE SHALL BE DUCTILE IRON PIPE WITH MECHANICAL JOINTS AT LEAST 10 FEET ON BOTH SIDES OF CROSSING, THE WATERLINE SHALL BE MECHANICAL JOINTS WITH

APPROPRIATE THRUST BLOCKING AS REQUIRED TO PROVIDE A MINIMUM OF 18" CLEARANCE, MEETING

- REQUIREMENTS OF ANSI A21.10 AND ANSI A21.11 (AWWA C-151) (CLASS 50).

 8. LINES UNDERGROUND SHALL BE INSTALLED, INSPECTED AND APPROVED BEFORE BACKFILLING.

 9. CONTRACTOR IS RESPONSIBLE FOR COMPLYING WITH THE SPECIFICATIONS OF THE LOCAL AUTHORITIES WITH
- REGARD TO MATERIALS AND INSTALLATION OF THE WATER AND SEWER LINES.


 10. ALL NECESSARY INSPECTIONS AND/OR CERTIFICATIONS REQUIRED BY CODES AND/OR UTILITY SERVICE COMPANIES SHALL BE PERFORMED PRIOR TO ANNOUNCED BUILDING POSSESSION AND THE FINAL CONNECTION
- 11. CONTRACTOR SHALL COORDINATE WITH ALL UTILITY COMPANIES FOR INSTALLATION REQUIREMENTS AND
- 12. CONTRACTOR TO PROVIDE TRENCHING, BACKFILL, 2 4" PVC SCHEDULE 40 CONDUITS, AND PULLING WIRES FOR UNDERGROUND TELEPHONE SERVICE FROM EXISTING FACILITIES AS SHOWN ON PLANS. CONTRACTOR TO COORDINATE INSTALLATION AND POINT OF CONNECTION WITH UTILITY PROVIDER.
- CONTRACTOR IS TO PROVIDE TRENCHING, CONDUIT, AND BACKFILL FOR ALL UNDERGROUND POWER LINE AND VAULTS AS REQUIRED BY UTILITY PROVIDER. POWER LINES AND POLES TO BE INSTALLED BY UTILITY PROVIDER. SEE SITE ELECTRICAL PLAN FOR SITE LIGHTING AND FOR PRIMARY ELECTRIC SERVICE LOCATIONS.
 GAS PIPING SHOWN FOR COORDINATION ONLY. INSTALLATION OF THE GAS MAIN AND METER TO BE ACCOMPLISHED BY UTILITY PROVIDER.
- 15. BACKFLOW PREVENTION DEVICES SHALL BE INSTALLED INSIDE THE BUILDING FOR EACH APPLICABLE USE INCLUDING DOMESTIC, FIRE, AND IRRIGATION SYSTEMS. CONTRACTOR SHALL COORDINATE AND SUPPLY A BACKFLOW TEST REPORT TO THE WATER AND SEWER DEPARTMENT UPON INSTALLATION. OWNER IS REQUIRED TO SUPPLY AN ANNUAL BACKFLOW TEST REPORT TO THE WATER AND SEWER DEPARTMENT.

UTILITY NOTES

1. ALL PROPOSED EASEMENTS MUST BE RECORDED PRIOR TO ISSUANCE OF CONSTRUCTION PERMITS.

4. THIS SITE IS LOCATED WITHIN THE TOWN OF CASTLE ROCK YELLOW WATER PRESSURE ZONE.

- REVISED: 11/5/2019
 THE MINIMUM SEPARATION RETWEEN WATERLINES SANITARY SEWE
- 2. THE MINIMUM SEPARATION BETWEEN WATERLINES, SANITARY SEWER AND STORM SEWER LINES IS 10 FEET.
 3. THE MINIMUM SEPARATION BETWEEN WATER SERVICE LINES IS 5 FEET.

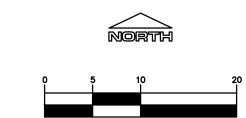

1 inch = 10 ft.

LEGEND

ELECTRIC LINE

COMMUNICATIONS LINE



NOTE: CURRENT PLAN SET
IS NOT FOR CONSTRUCTION

SITE DEVI

SITE DEVELOPMENT PLAN LOT 6 & S ½ OF LOT 5, BLOCK 22, TOWN OF CASTLE ROCK TOWN OF CASTLE ROCK PROJECT NO: SDP23-0032

RIDGEOP
ENGINEERING & SURVEYING
541 E. Garden Drive,
Unit N
Windsor, CO 80550

T (970) 663-455.
W ridgetopeng.cor

LITTLE SCHOOL
ON PERRY ST

203 PERRY ST. CASTLE ROCK, CO 80104

MISSION CAPITAL PROPERTIES BAYSIDE

PREPARED FOR

SUBMITTAL
CONSTRUCTION
DOCUMENTS

DRAWN BY: KNW
CHECKED BY: MRB
PROJECT NO.: 23-222-002
REVISIONS

08/31/2023

SHEET TITLE

GENERAL UTILITY PLAN

SHEET INFORMATION

C-3.0

LOT 6 & S 1/2 OF LOT 5, BLOCK 22, TOWN OF CASTLE ROCK LOCATED IN THE NORTHWEST QUARTER OF SECTION 11, TOWNSHIP 8, RANGE 67 WEST OF THE 6TH P.M. TOWN OF CASTLE ROCK, COUNTY OF DOUGLAS, STATE OF COLORADO



PROJECT TITLE

203 PERRY ST.

PROPERTIES

PREPARED FOR


BAYSIDE


LITTLE SCHOOL


CASTLE ROCK, CO 80104


MISSION CAPITAL

ON PERRY ST

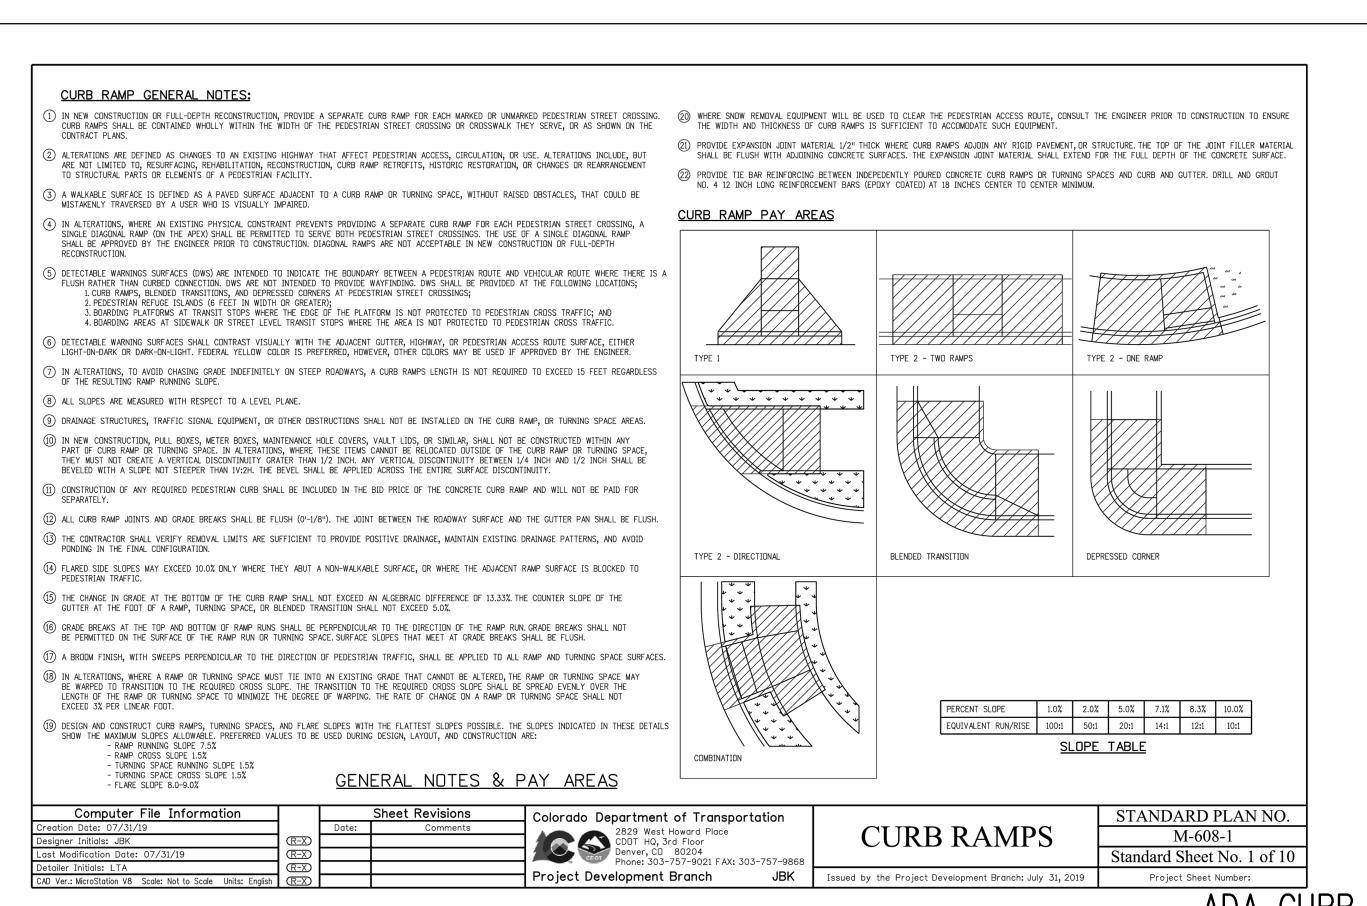

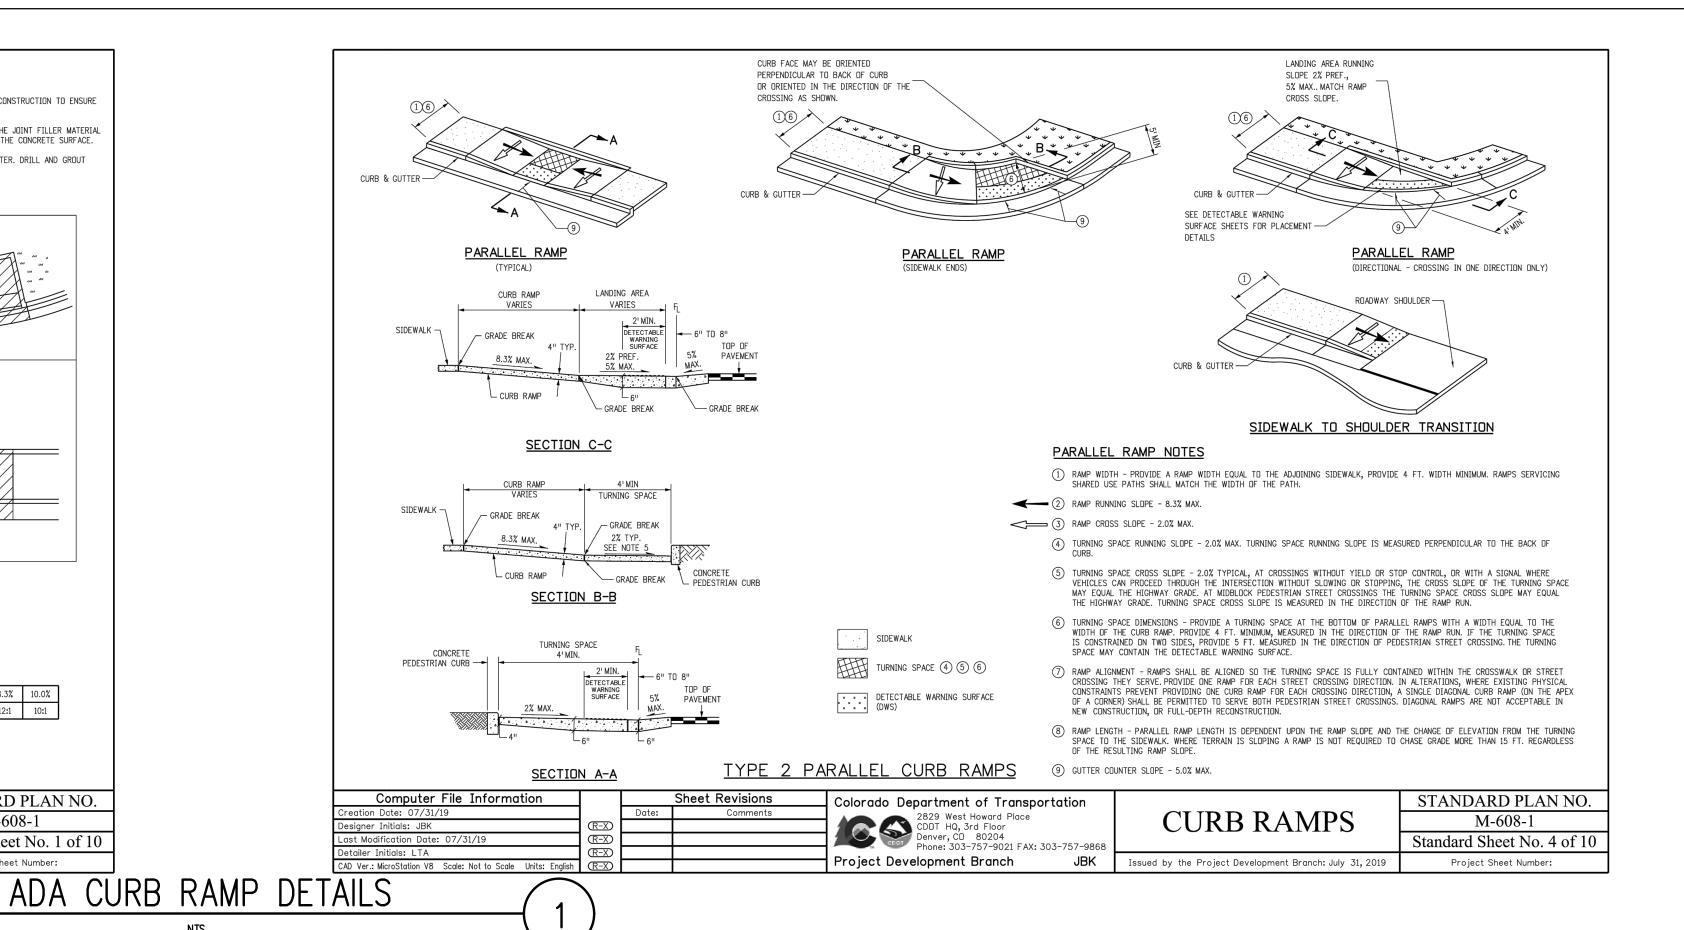

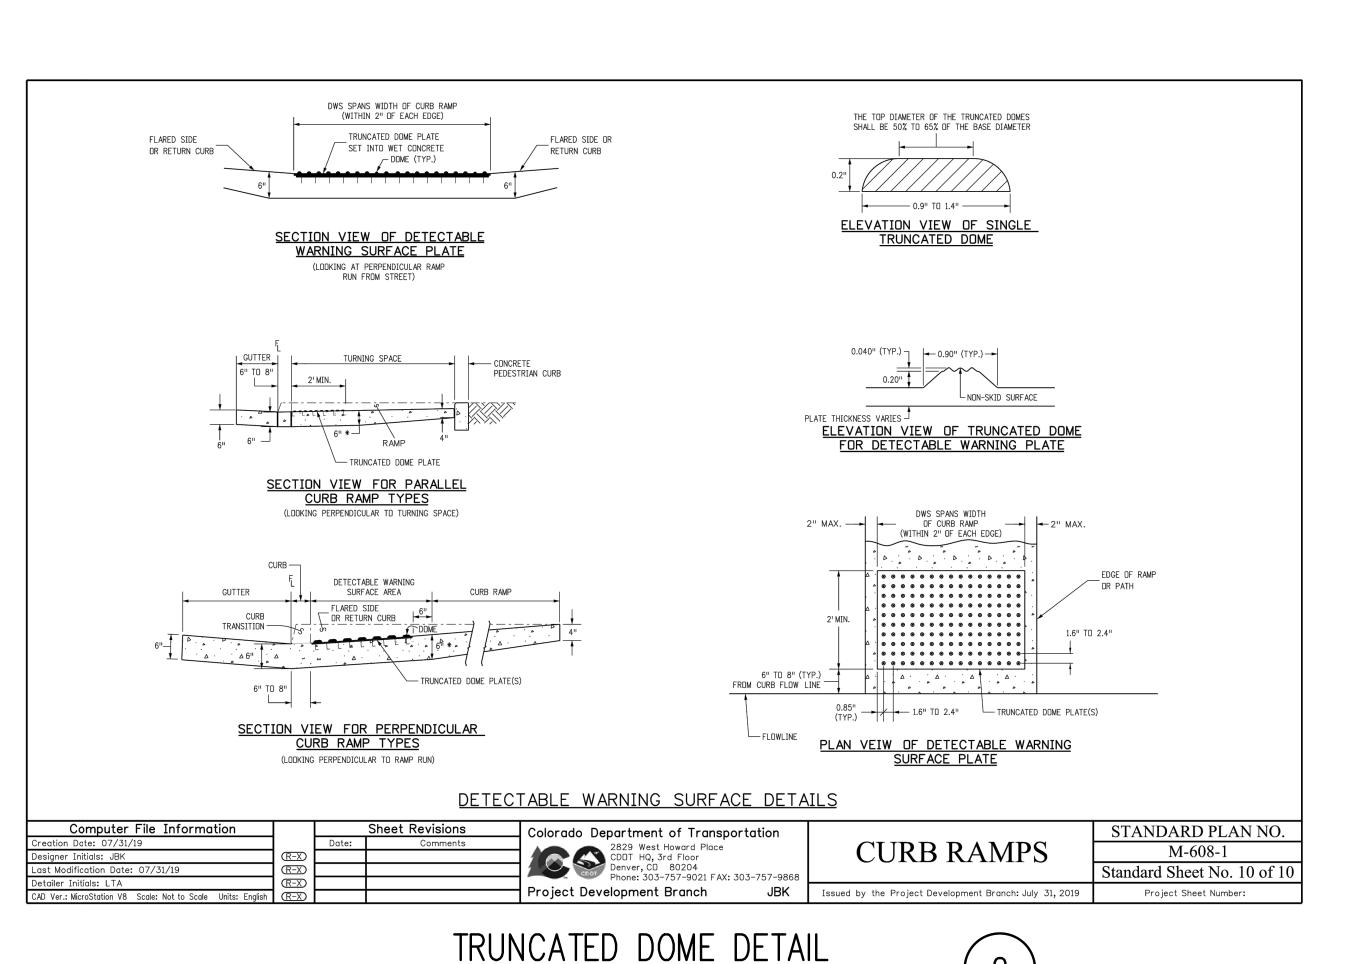

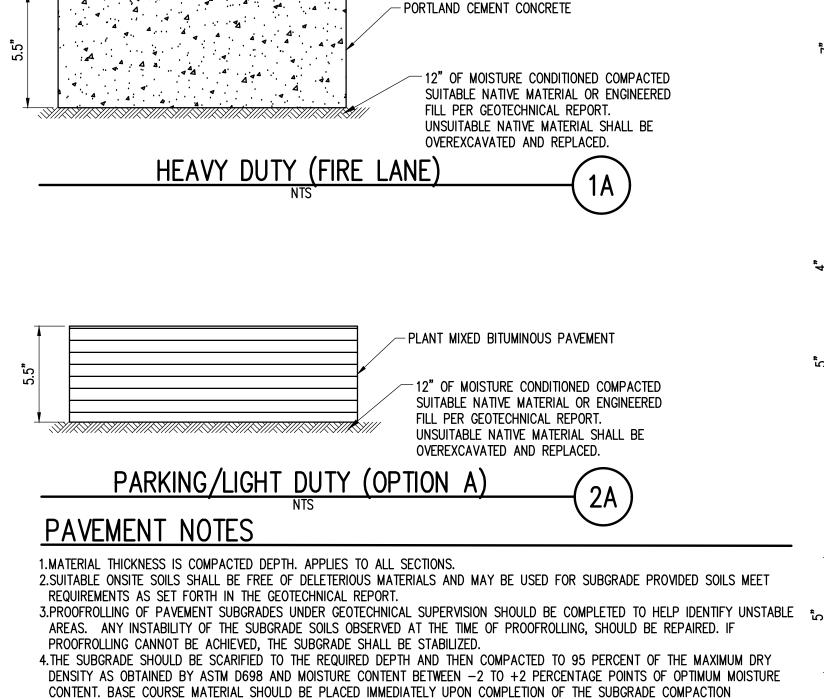

ASPHALT CONCRETE SHOULD MEET SPECIFIC GRADATION REQUIREMENTS SUCH AS COLORADO DEPARTMENT OF TRANSPORTATION

6.ÀGGRÉGATE BASE COURSE SHOULD BE CONSISTÉNT WITH CDOT REQUIREMENTS FOR CLASS 6 AGGREGATE BASE, PLACED IN LOOSE

LIFTS NOT TO EXCEED 8 INCHES THICK AND COMPACTED TO AT LEAST 95% OF THE MATERIALS STANDARD PROCTOR MAXIMUM DRY

7.ALL ASPHALT PAVEMENTS SHALL CONFORM TO SPECIFICATIONS IN CDOT SECTION 401 STANDARD SPECIFICATIONS FOR ROAD AND

9.SEE TOWN OF CASTLE ROCK STANDARDS AND SPECIFICATIONS FOR ADDITIONAL INFORMATION REGARDING ASPHALT AND CONCRETE

8.SEE "GEOTECHNICAL ENGINEERING REPORT - THE LITTLE SCHOOL ON PERRY STREET, 203 PERRY STREET. - CASTLE ROCK,


(CDOT) GRADING S OR SG (BOTTOM LIFTS ONLY) OR SX (TOP LIFT ONLY) SPECIFICATIONS, OR EQUIVALENT.

COLORADO 80104" PREPARED BY TRIAX ENGINEERING DATED SEPTEMBER 22, 2023 FOR MORE INFORMATION.

OPERATION TO PREVENT DRYING OF THE SOILS DUE TO EXPOSURE.

BRIDGE CONSTRUCTION.

PAVEMENTS.

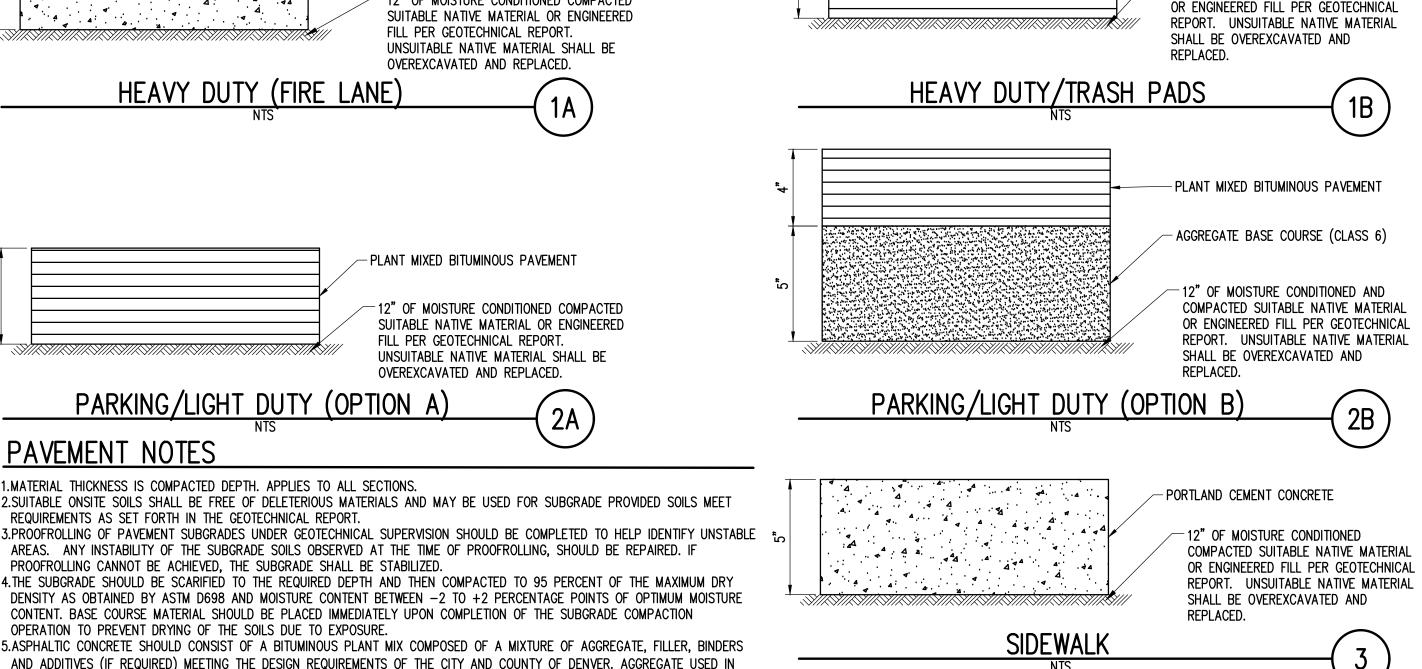

SUBMITTAL CONSTRUCTION **DOCUMENTS** DRAWN BY: PROJECT NO .: REVISIONS 08/31/2023 SHEET TITLE **DETAILS** SHEET INFORMATION

Know what's below. Call before you dig.

SITE DEVELOPMENT PLAN LOT 6 & S 1/2 OF LOT 5, BLOCK 22, TOWN OF CASTLE ROCK TOWN OF CASTLE ROCK PROJECT NO: SDP23-0032

NOTE: CURRENT PLAN SET

IS NOT FOR CONSTRUCTION

PLANT MIXED BITUMINOUS PAVEMENT

COMPACTED SUITABLE NATIVE MATERIAL

12" OF MOISTURE CONDITIONED

Of

C-9.0

23-222-002

LOT 6 & S 1/2 OF LOT 5, BLOCK 22, TOWN OF CASTLE ROCK LOCATED IN THE NORTHWEST QUARTER OF SECTION 11, TOWNSHIP 8, RANGE 67 WEST OF THE 6TH P.M. TOWN OF CASTLE ROCK, COUNTY OF DOUGLAS, STATE OF COLORADO



PROJECT TITLE LITTLE SCHOOL ON PERRY ST

203 PERRY ST. CASTLE ROCK, CO 80104

MISSION CAPITAL **PROPERTIES** BAYSIDE

SUBMITTAL	
CONSTRUCTION	
DOCUMENTS	

DRAWN BY:

08/31/2023

SHEET TITLE

DETAILS

SHEET INFORMATION

C-9.1

LOT 6 & S 1/2 OF LOT 5, BLOCK 22, TOWN OF CASTLE ROCK

NOTE: CURRENT PLAN SET


IS NOT FOR CONSTRUCTION

Know what's below.

Call before you dig.

TOWN OF CASTLE ROCK PROJECT NO: SDP23-0032

SITE DEVELOPMENT PLAN Of **16**

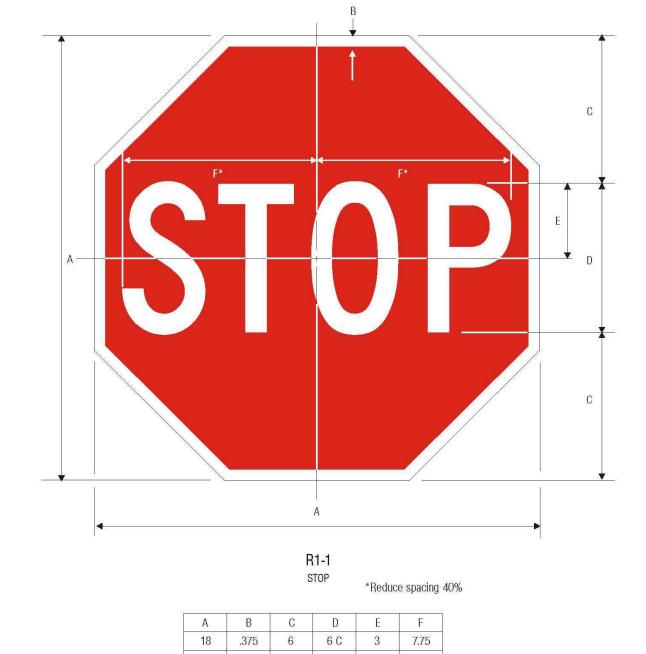


COLORS: LEGEND — WHITE (RETROREFLECTIVE)

BACKGROUND — RED (RETROREFLECTIVE)

R1-1 STOP SIGN DETAIL



R7-8 HANDICAPPED PARKING SIGN DETAIL

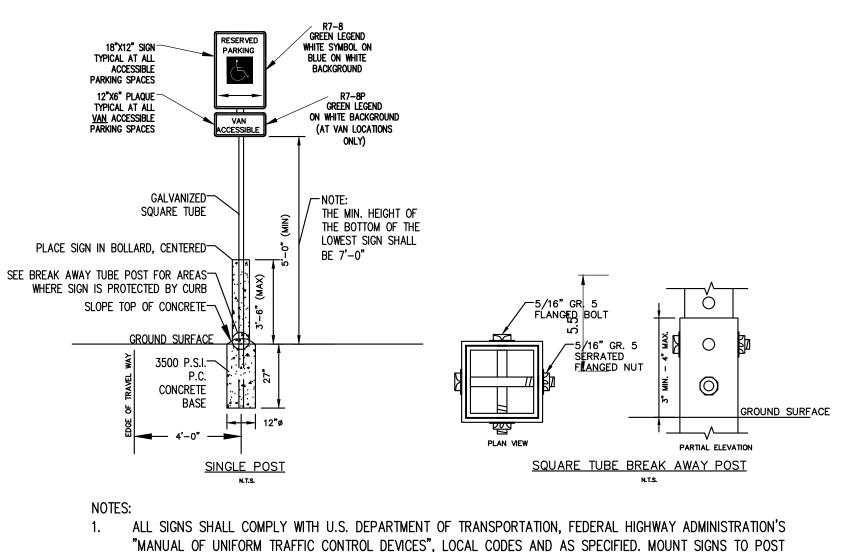

"MANUAL OF UNIFORM TRAFFIC CONTROL DEVICES", LOCAL CODES AND AS SPECIFIED. MOUNT SIGNS TO POST IN ACCORDANCE WITH MANUFACTURER'S INSTRUCTIONS.

2. GALVANIZED SQUARE TUBE


POST TUBES — 2"x2"x3/16" 12ga POST TUBE SHALL MEET ASTM A1011 GRADE 50. POST TUBE GALVANIZED AS PER ASTM A653 GRADE 90.

ANCHOR TUBE -2-1/4"x2-1/4"x3/16" 12ga HEAVY DUTY ANCHOR TUBE SHALL MEET ASTM A500 GRADE B. STRUCTURAL TUBE AND STEEL SHALL BE HOT DIP GALVANIZED PER ASTM A123.

THE UPPER SIGN POST SHALL TELESCOPE INSIDE THE ANCHOR TUBE A MINIMUM OF 12". THE ANCHOR TUBE SHALL BE A MINIMUM 27" DEEP WITH 3" MIN. 4" MAX. EXPOSED ABOVE FINISH GRADE.

SIGN DETAILS

LOT 6 & S 1/2 OF LOT 5, BLOCK 22, TOWN OF CASTLE ROCK LOCATED IN THE NORTHWEST QUARTER OF SECTION 11, TOWNSHIP 8, RANGE 67 WEST OF THE 6TH P.M. TOWN OF CASTLE ROCK, COUNTY OF DOUGLAS, STATE OF COLORADO

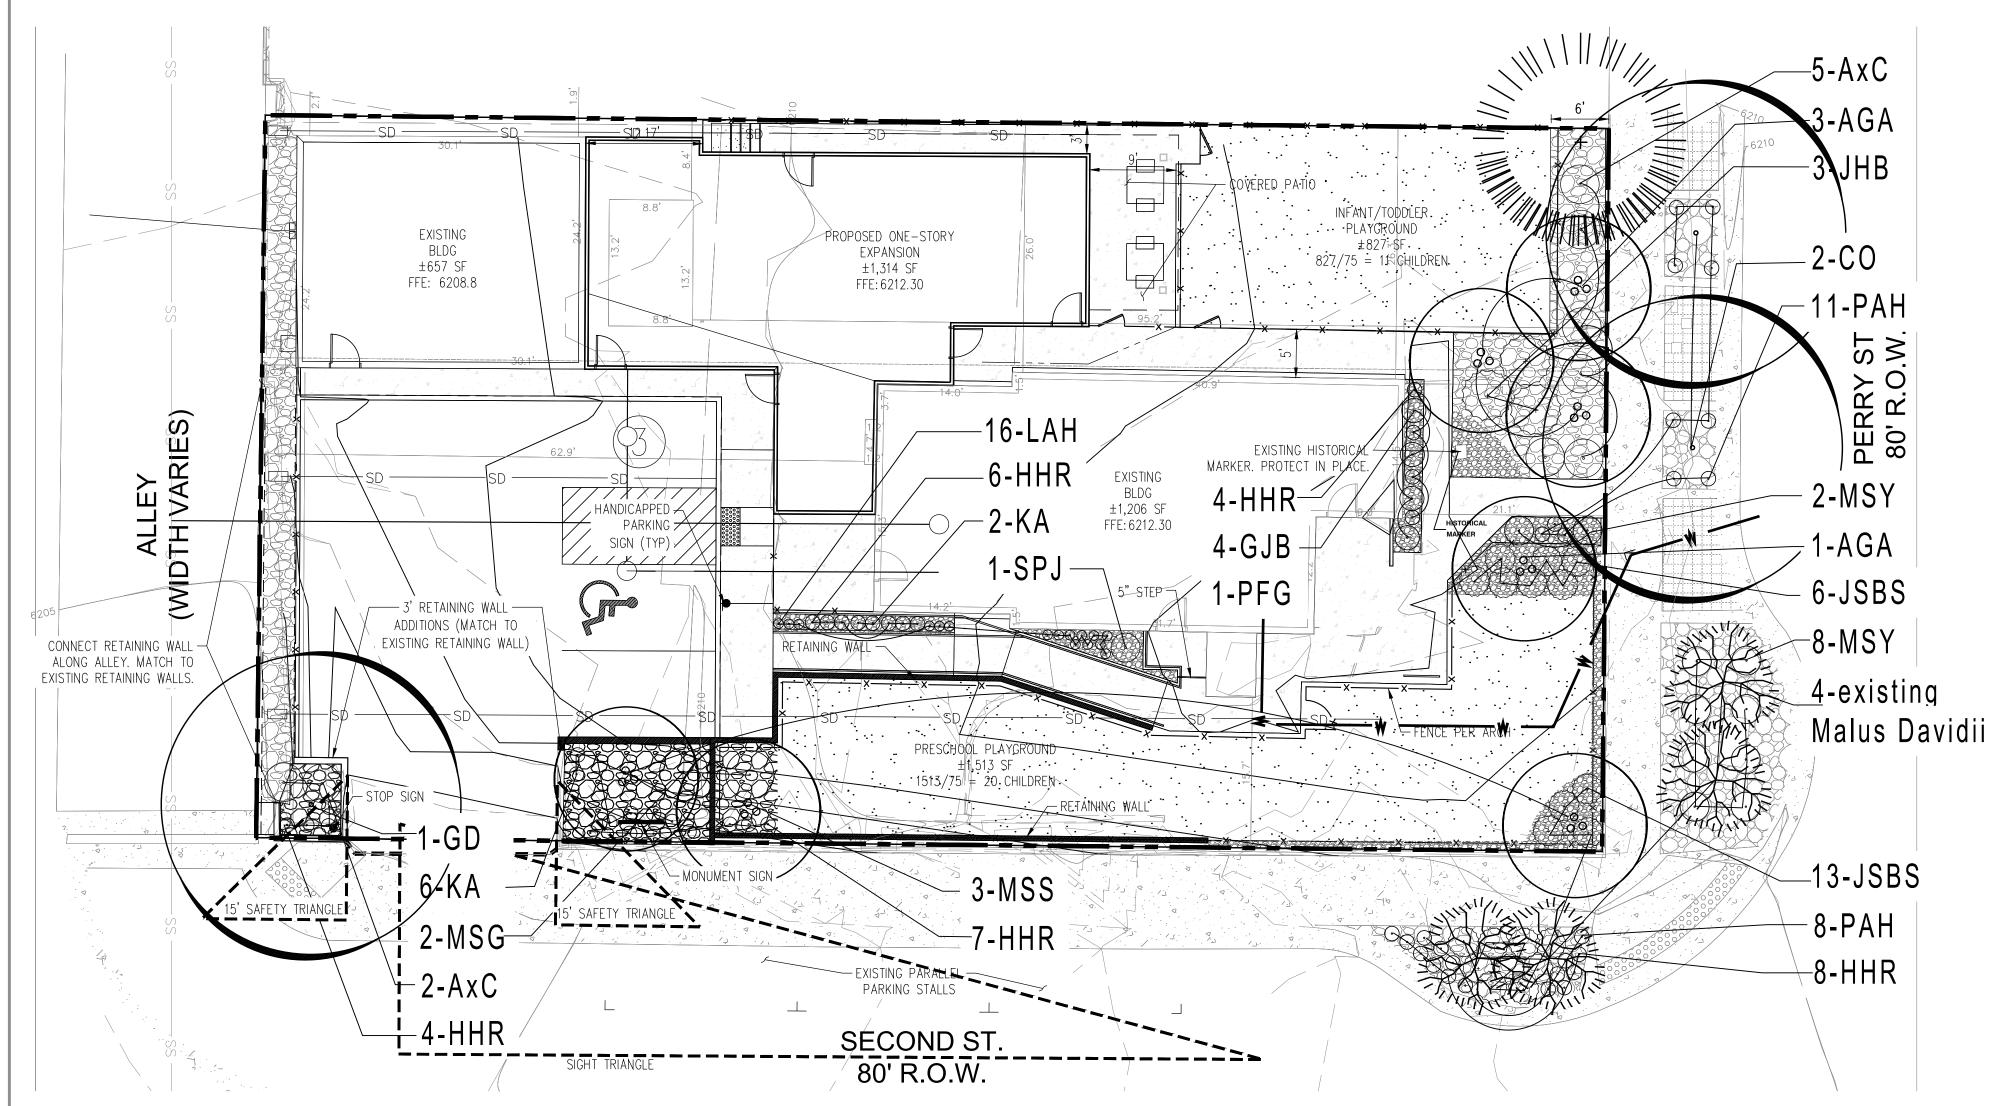

			PLANTIN(G SCHEDULE				
TYPE KEY QTY BOTANICAL NAME Trees CO 2 Celtis occidentallis GD 1 Gynocladus dioicus AGA 4 Amelanchier Grandiflora 'Autumn Brilli' MSS 3 Malus 'Spring Snow' Shrubs Evergreen Shrub JHB 3 Juniperus horizontalis 'Bar Harbor' JHBC 19 Juniperus horizontalus 'Blue Chip' AxC 7 Arctostaphylos X Coloradoensis SJN 1 Spiraea Japonica 'Neon Flash' Perennials & Ornamen				COMMON NAME	SIZE AT MATURITY	NOTES	WA ⁻ US	
			Trees					
Shade Tree	СО	2	Celtis occidentallis	Western Hackberry	2.0" Cal.	30'-50'	B & B	L
TYPE KEY QTY BOTANICAL NAME Trees Shade Tree CO 2 Celtis occidentallis GD 1 Gynocladus dioicus AGA 4 Amelanchier Grandiflore 'Autumn Brilli' MSS 3 Malus 'Spring Snow' Shrubs Evergreen Shrub 19 Juniperus horizontalis 'Bar Harbor' Deciduous 19 Juniperus horizontalius 'Blue Chip' AxC 7 Arctostaphylos X Coloradoensis SJN 1 Spiraea Japonica 'Neon Flash' Perennials & Orname Perennial KA 8 Calamagrostis X Acutiflora 'Karl Foreste GJB 4 Geranium 'Johnson's Blue' PAH 19 Pennisetum alopecuroides 'Hameln MSY 10 Miscanthus sinensi 'Yak Jima'		Kentucky Coffeetree	2.0 cal.	30'-50'	B & B	L		
0	AGA	4		Autumn Brilliant Serviceberry	1.5" Cal	15'-20'	B & B	L-
Urnamental	MSS	3	Malus 'Spring Snow'	Spring Snow Crabapple	1.5" Cal	15'-20'	B & B	N,
	•		Shrubs					
	JHB	3	•	Bar Harbor Juniper	5 gal.	3'-4'	5' OC	L
	JHBC	19		Blue Chip Juniper	5 gal.	2'-3'	5' OC	L
David	A×C	7		Panchito Manzanita	5 Gal	3'	5' OC	L
Deciduous	SJN	1	l '	Neon Splash Spirea	5 Gal	3'	3' OC	L
	<u> </u>	Ре	rennials & Ornamen	tal Grasses				
Perennial	KA	8	Calamagrostis X Acutiflora 'Karl Forester'	Karl Forester Grass	1 Gal		4' OC	L
	GJB	4		Blue Cranesbill	1 gal		30" OC	L
	PAH	19	Pennisetum alopecuroides 'Hameln'	Dwarf Fountain Grass	1 gal		18" OC	L
	MSY			Yaku Jima Maiden Grass	2 gal		30" OC	L
			Lavendula angustifolia 'Hidcote'	Deep Blue Lavender	1 gal.		12" OC	L
	MSG	2		Maiden Grass	5 gal		5' OC.	L

ANNUAL WATER NEEDS

LOW WATER ZONE 1,144sf x 7gal. = 8,000 gallons annually



DECIDUOUS CANOPY TREES



ORNAMENTAL TREES

EVERGREEN TREES



EXISTING TREE




EVERGREEN SHRUBS



3/4" RIVER ROCK


EXISTING ROCK MULCH



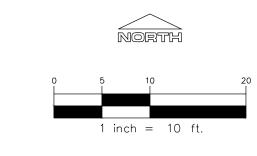

Know what's below.

Call before you dig.

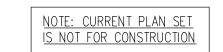

SITE DEVELOPMENT PLAN LOT 6 & S ½ OF LOT 5, BLOCK 22, TOWN OF CASTLE ROCK TOWN OF CASTLE ROCK PROJECT NO: SDP23-0032

12 of 16

LS1

PROJECT TITLE LITTLE SCHOOL ON PERRY ST

203 PERRY ST. CASTLE ROCK, CO 80104

MISSION CAPITAL PROPERTIES **BAYSIDE**

SUBMITTAL
CONSTRUCTION
DOCUMENTS

DRAWN BY: CHECKED BY: PROJECT NO.:

08/31/2023

LANDSCAPE

SHEET INFORMATION

SHEET TITLE


PLAN

SYNTHETIC TURF


1" DECORATIVE ROCK

LOT 6 & S 1/2 OF LOT 5, BLOCK 22, TOWN OF CASTLE ROCK LOCATED IN THE NORTHWEST QUARTER OF SECTION 11, TOWNSHIP 8, RANGE 67 WEST OF THE 6TH P.M.


TOWN OF CASTLE ROCK, COUNTY OF DOUGLAS, STATE OF COLORADO

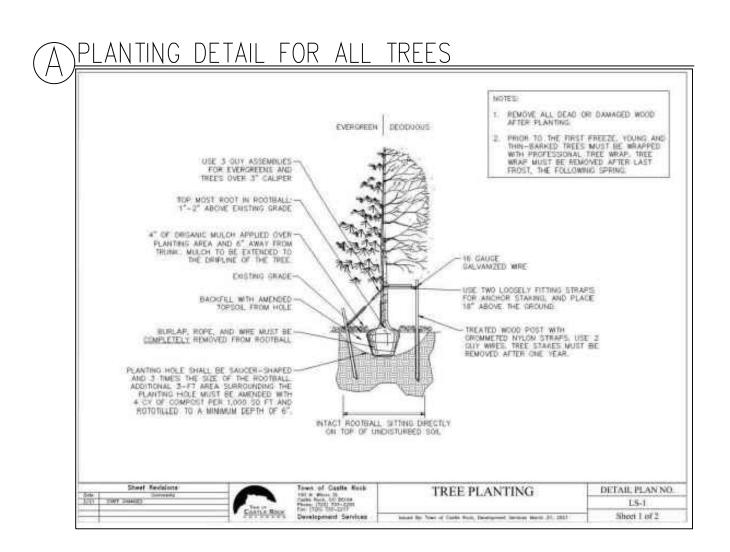


YPLANTING DETAIL FOR SRHUBS

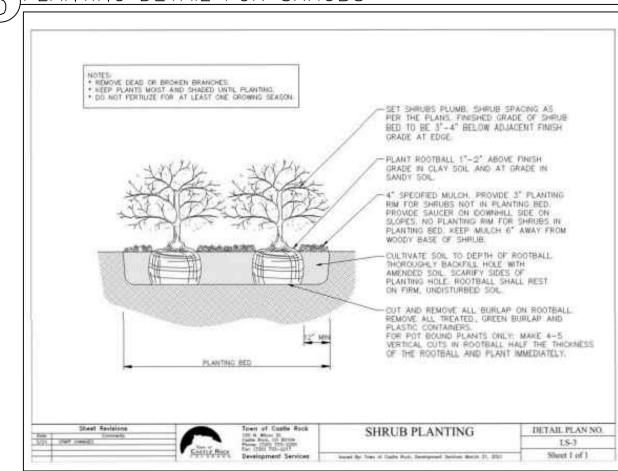

PLANTING DETAIL FOR PRENNIALS

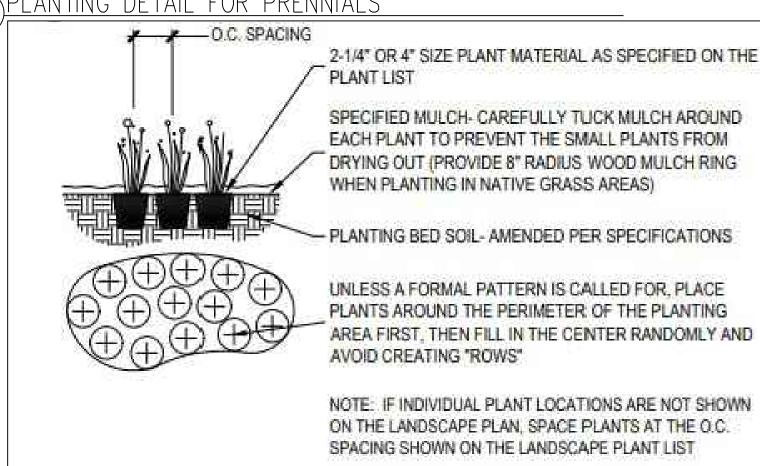

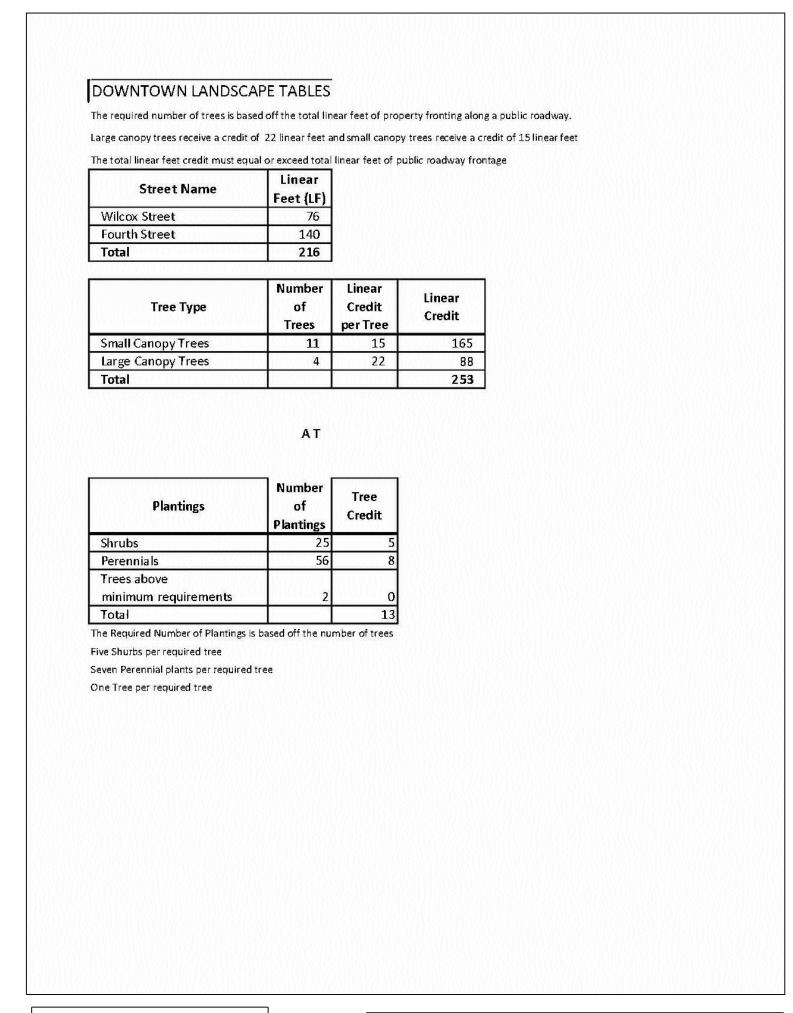


WATER L	COMPOSITE LANDSCAPE WATER USE RATING CHART								
LANDSCAPE ZONE	LWU RATING RANGE								
Very low	0.0 to 1.5								
Low Water Use	+1.5 to 3.0								
Moderate Water Use	+3.0 to 4.5								
High Water Use	+4.5								


SITE UTILIZATION TABLE									
BUILDING FOOTPRINT	3,290 SF	0.07 AC	31%						
OPEN SPACE	3,153 SF	0.07 AC	30%						
PARKING, DRIVES & SIDEWALKS	4,102 SF	0.09	39%						
TOTAL	10,545 SF	0.24 AC	100%						

LANDSCAPE NOTES

- Final landscape area, coverage and plant quantities, shall meet or exceed quantities represented in this drawing and shall conform to subsequent submittal requirements.
- Location of plant materials are approximated and may change slightly due to unforeseen field constraints.
- All plants are to be properly hydrozoned per Town of Castle Rock Plant list.
- Distance of trees to wet utility lines should be a minimum of 10 feet.
- Permanent irrigation is required for all landscaped areas greater than 500 square feet, per Section 4.2.3 of the Landscape and Irrigation Manual.
- Design must accommodate the watering restrictions as outlined in the Town of Castle Rock Water Use Management Plan (WUMP).
- Irrigation systems are to be designed to operate within the Town of Castle Rock Water Use Management Plan.
- Irrigation systems are to be designed per the Town of Castle Rock Landscape and Irrigation regulations Section 4.2.3 and to correlate with the use type on the property.
- If any transformers, ground-mounted HVAC units, utility pedestals, or similar features existing on site, but not shown on the Site Development Plan, additional landscaping and screening may be required based upon field conditions determined during the site inspection. Installation will be required prior to the final inspection and the issuance of the certificate of occupancy, as applicable.
- 10. No solid object exceeding 30" in height above the flowline elevation of the adjacent street, including, but not limited to building, utility cabinets, walls, fences, trees, landscape plantings, cut slopes and berms shall be placed in sight distance triangles or easements as shown on the plan.
- 11. No trees, large shrubs, or permanent structures are allowed in wet utility and drainage easements.
- 12. An irrigation plan is required with the first submittal of the Construction Documents. Please see Sections 3.1.2B and 4.2.3 of the Town of Castle Rock Landscape and Irrigation Performance Standards and Criteria Manual for irrigation submittal and design requirements. Changes to the landscape plan may be necessary due to Construction Documents Irrigation Plan review comments.
- 13. Landscape and irrigation shall be installed by a Town of Castle Rock registered landscape contract professional.
- 14. Dead plant materials shall be removed and replaced with healthy planting materials of comparable size and species that meet the original intent of the approved landscape design within forty-five(45) days or sooner in the event of a contagious disease or invasive insect species. Town of Castle Rock is not responsible for plant replacements.
- 15. Slopes steeper than 3:1 are not permitted on landscape plans in the Town of Castle Rock.

CLWUR CHART (LWUR X IA) /TA											
IRRIGATION ZONE	PLANT NAME	APP RATE (INCHES/MONTH)	ZONE (VL, L M,	% OF TOTAL AREA	IA (Irrigated area in SF for each zone)	LWUR (Landscape Water Use Rating)	TA (Total area of all irrigated landscape zones)	CLWUR (LWUR X IA/TA)			
Drip	Deciduous Shrub and Perennial beds	2	Low	100%	1,144 SF	2	1,144 SF	2			
TOTALS					1,144 SF			2			

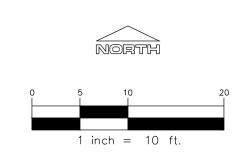

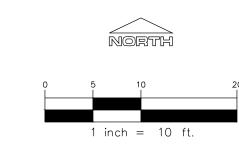



NOTE: CURRENT PLAN SET IS NOT FOR CONSTRUCTION

SITE DEVELOPMENT PLAN LOT 6 & S ½ OF LOT 5, BLOCK 22, TOWN OF CASTLE ROCK TOWN OF CASTLE ROCK PROJECT NO: SDP23-0032

13 of 16

PROJECT TITLE

LITTLE SCHOOL ON PERRY ST

203 PERRY ST CASTLE ROCK, CO 80104 PREPARED FOR

MISSION CAPITAL **PROPERTIES** BAYSIDE

SUBMITTAL

DRAWN BY:

CHECKED BY:

PROJECT NO.: REVISIONS

08/31/2023

LANDSCAPE

SHEET TITLE

NOTES


LS2

SHEET INFORMATION

CONSTRUCTION

DOCUMENTS

LOT 6 & S 1/2 OF LOT 5, BLOCK 22, TOWN OF CASTLE ROCK LOCATED IN THE NORTHWEST QUARTER OF SECTION 11, TOWNSHIP 8, RANGE 67 WEST OF THE 6TH P.M. TOWN OF CASTLE ROCK, COUNTY OF DOUGLAS, STATE OF COLORADO

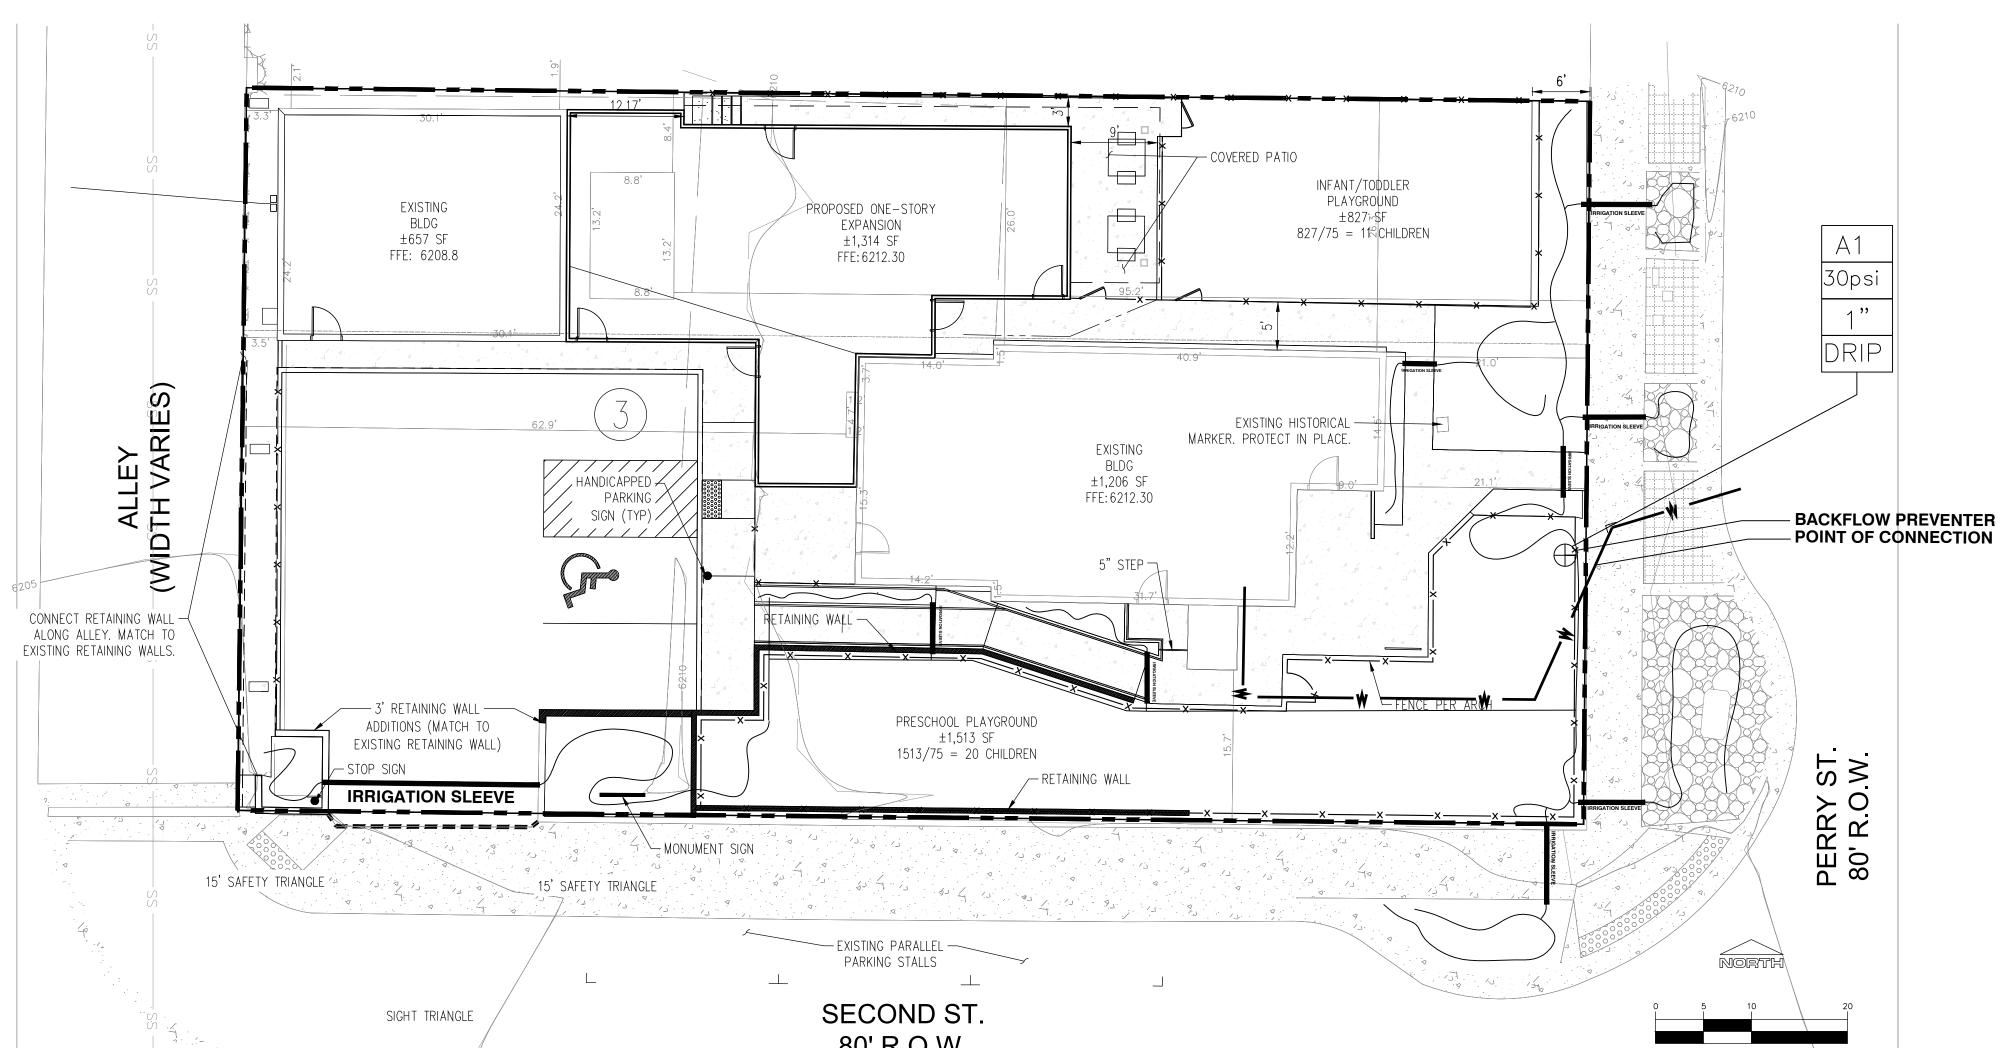

THE SYSTEM DESIGN ASSUMES A MINIMUM DYNAMIC PRESSURE FOR THE IRRIGATION SYSTEM OF 40 PSI. AT A MAXIMUM DISCHARGE OF 55 GPM AT THE IRRIGATION POINT OF CONNECTION 1 (POC1) VERIFY PRESSURE AND GLOW ON SITE PRIOR TO

SPECIFICATIONS AND INSTALLATION DETAILS FOR THIS AND

COORDINATE UTILITY LOCATES (CALL BEFORE YOU DIG)

- DO NOT PROCEED WITH THE INSTALLATION OF THE IRRIGATION SYSTEM WHEN IT IS OBVIOUS IN THE FIELD THAT OBSTRUCTION OR GRADE DIFFERENCES EXIST THAT MIGHT NOT HAVE BEEN CONSIDERED IN THE ENGINEERING. IF DISCREPANCIES IN CONSTRUCTION DETAILS, LEGEND, NOTES, OR DISCREPANCIES TO
- THE ATTENTION OF THE OWNERS REPRESENTATIVE. 5. THE DRAWING ARE DIAGRAMMATIC. THEREFORE THE FOLLOWING
- A. ALTHOUGH IRRIGATION COMPONENTS MAY BE SHOWN OUTSIDE PLANTING AREAS FOR CLARITY' INSTALL IRRIGATION PIPE AND WIRING IN THE LANDSCAPED AREAS WHENEVER POSSIBLE. B. TREE AND SHRUB LOCATIONS AS SHOWN ON LANDSCAPE PLANS
- TAKE PRECEDENCE OVER IRRIGATION EQUIPMENT LOCATIONS. AVOID CONFLICTS BETWEEN THE IRRIGATION SYSTEM, PLANTING MATERIALS, AND ARCHITECTURAL FEATURES. C. USE ONLY STANDARD TEE AND ELBOW FITTINGS. USE OF TEE
- FITTINGS IN THE BULL-NOSE CONFIGURATION, OR USE OF CROSS TYPE FITTINGS IS NOT ALLOWED. 6. PROVIDE THE FOLLOWING COMPONENTS TO THE OWNER PRIOR TO
- THE COMPLETION OF THE PROJECT: A. TWO OPERATING KEYS FOR EACH TYPE OF MANUALLY OPERATED
- B. TWO OF EACH SERVICING WRENCH OR TOOL NEEDED FOR COMPLETE ACCESS' ADJUSTMENT, AND REPAIR OF ALL ROTARY
- C. "AS BUILT" IRRIGATION DRAWINGS WATER BUDGET CHART
- SMART IRRIGATION CONTROLLER DATA INPUT CHART SELECTED NOZZLES FOR SPRAY AND ROTARY SPRINKLERS WITH ARC WHICH PROVIDE COMPLETE AND ADEQUATE COVERAGE WITH MINIMUM OVER-SPRAY FOR THE CONDITION. CAREFULLY ADJUST THE RADIUS OF THROW AND ARC OF COVERAGE OF EACH ROTARY SPRINKLER TO PROVIDE THE BEST PERFORMANCES.
 - INSTALLATION OF IRRIGATION SLEEVING, SLEEVES ARE REQUIRED FOR BOTH PIPING AND ELECTRICAL WIRING AT EACH HARD-SCAPE CROSSING COORDINATE INSTALLATION OF SLEEVING WITH OTHER TRADES. ANY PIPE OR WIRE WHICH PASSES BENEATH EXISTING HARD-SCAPE WHERE SLEEVING WAS NOT INSTALLED WILL REQUIRE HORIZONTAL BORING BY THE IRRIGATION CONTRACTOR.
- O SEPARATE SLEEVING USED FOR IRRIGATION LINES AND WIRING BUNDLES FOR ALL SLEEVING LOCATED UNDER CONCRETE, THE
- PAVEMENT OR OTHER HARD SURFACING SHALL BE NOTCHED ON BOTH SIDES TO MARK THE SLEEVE LOCATION. AND TRACER WIRES SHALL BE INSTALLED ON THE UPPER SIDE AND BOTH ENDS OF THE SLEEVING THE DIAMETER OF SLEEVE SHALL BE A MINIMUM OF TWICE
- THAT OF THE PIPE AND WIRING BUNDLE BUT NO SMALLER THAN A TWO (2) INCH DIAMETER PIPE. THE ENDS OF THE SLEEVES SHALL EXTEND PAST THE EDGE OF THE CURB, GUTTER, SIDEWALK, OR OTHER HARDSCAPE A MINIMUM OF EIGHTEEN (18) INCHES.
- THE SLEEVE MATERIAL BENEATH SIDEWALKS, DRIVES AND STREETS SHALL BE PVC CLASS 200 PIPE WITH SOLVENT WELDED JOINTS
- O CONTAINS NO JOINTS WHEN LENGTH IS LESS THAN TWENTY (20) FEET.
- 7. INSTALL ALL ELECTRICAL POWER TO THE IRRIGATION CONTROL SYSTEM IN ACCORDANCE WITH THE NATIONAL ELECTRIC CODE AND ALL APPLICABLE LOCAL ELECTRIC UTILITY CODES. THE IRRIGATION CONTROLLER MUST BE WALL MOUNTED IN THE PARTS STAGING AREA ADJACENT TO ELECTRICAL OUTLET LOCATED IN THE JANITORS ROOM WITH BACKFLOW PREVENTER
- 8. THE FOLLOWING SHOULD BE NOTED REGARDING PIPE SIZING. IF A SECTION OF UNSIZED PIPE IS LOCATED BETWEEN THE IDENTICALLY SIZED SECTIONS, THE UNSIZED PIPE IS THE SAME

- NOMINAL SIZE AS THE TWO SIZED SECTIONS. THE UNSIZED PIPE SHOULD NOT BE CONFUSED WITH THE DEFAULT PIPE SIZE NOTED IN THE LEGEND.
- 9. INSTALL TWO #14 AWG CONTROL WIRES FROM CONTROLLER LOCATION TO EACH DEAD END OF MAINLINE FOR USE AS SPARES INCASE OF CONTROL WIRE FAILURE. COIL 3 FEET OF WIRE IN VALVE BOX. END OF WIRES SHALL BE CAPPED WITH WATERPROOF
- WIRE CONNECTORS 10. AUTOMATIC IRRIGATION SYSTEM SHALL BE EQUIPPED WITH AN AUTOMATIC RAIN DETECTION DEVICE.
- 11. THE WATER AND SEWER DEPARTMENT RESERVES THE RIGHT TO ENHANCE THE REQUIREMENTS OF THE BACKFLOW PREVENTER INSTALLATION BASED ON CITY REQUIREMENTS.
- 12. NATIVE GRASS AREA WILL BE WATERED UNTIL ESTABLISHED FOR UP TO THREE YEARS. TOUCH UP WATERING WILL BE DONE AS NEEDED AFTER ESTABLISHMENT
- 13. POST AT EACH SMART IRRIGATION CONTROLLER A DATA INPUT CHART INCLUDING THE PRECIPITATION RATE FROM THE AUDIT WATER BUDGET, AND ZONE DESCRIPTIONS. SEE WITHIN THIRTY (30) DAYS OF THE INSTALLATION OF NEW LANDSCAPING, THE IRRIGATION SYSTEM CONTROLLER(S) SHALL BE RESET TO THE NORMAL SEASONAL WATERING SCHEDULE.


EMITTER SCHEDULE

- 4. IN CLAY OR LOAM SOILS, CONSIDER TWO 0.5 GPH EMITTERS AT THE BASE OF A PERENNIAL FLOWER TO ENSURE WATERING IF ONE FAILS. A 1 TO 5 FOOT SHRUB AND SMALL TREE LESS THAN 15 FEET AT MATURITY WILL INITIALLY REQUIRE TWO, 1 GPH EMITTERS 12 INCHES FROM THE BASE OF THE PLANT. CHANGE TO 2 AND THEN 4 GPH HIGHER FLOW EMITTERS IF PLANTING A LARGER SIZED TREE AND AS THE SMALL TREE GROWS. A 5 FOOT OR LARGER SHRUB MAY REQUIRE THREE 1GPH EMITTERS.
- 15. A MEDIUM TREE 15 TO 25 FEET MAY ULTIMATELY REQUIRE FOUR EMITTERS TWO FEET FROM THE TRUNK. IF PLANTING A "WHIP", IT'S POSSIBLE TO START WITH TWO 0.5 GPH EMITTERS AND CHANGE TO HIGHER FLOW AND MORE EMITTERS AS THE TREE GROWS. BEGIN WITH THREE, 2 GPH EMITTERS ON A 1 INCH CALIPER TREE PLANTING AND THREE, 4 GPH EMITTERS ON A 2 INCH CALIPER TREE
- 16. TREES LARGER THAN 25 FEET AT MATURITY MAY BE IMPRACTICAL TO IRRIGATE WITH DRIP BECAUSE OF THE EXTENSIVE NATURE OF TREE ROOT SYSTEMS AND MASS OF THE TREES. INCREASE THE NUMBER OF EMITTERS AND CHANGE THEM TO 2 OR 4 GPH OR LARGER FLOWS AS TREES AND SHRUBS GROW.

7. NON-POTABLE SYSTEMS MUST USE THE COLOR PURPLE TO IDENTIFY COMPONENTS SUCH AS VALVES, VALVE BOXES,

- 18. A MASTER SHUT-OFF VALVE SHALL BE INSTALLED DOWNSTREAM OF THE BACKFLOW DEVICE.
- 19. FLOW SENSORS INTEGRATED WITH SMART IRRIGATION CONTROLLER ARE REQUIRED FOR SINGLE OR COMBINED POINT OF CONNECTION FOR FLOWS OF 15 GALLONS PER MINUTE OR
- GREATER AND 1 INCH OR GREATER WATER TAPS. 20. ALL VALVES SHALL HAVE A MANUAL BALL VALVE INSTALLED PRIOR TO THE LATERAL VALVE
- 21. ENSURE SLEEVING MEETS ALL REQUIREMENTS UNDER 6.11.B.6 INCLUDING BUT NOT LIMITED TO SLEEVING SIZE BEING TWICE THAT OF THE PIPE, NOTCHING OF HARD SURFACE FOR SLEEVES RUNNING UNDER HARDSCAPE.

IRRIGATION LEGEND

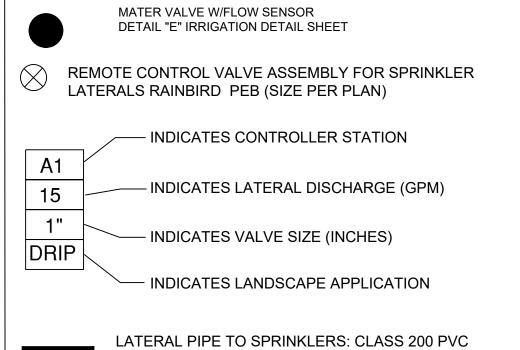

1 INCH UNLESS OTHERWISE INDICATED LATERAL PIPE TO EMITTERS: UV RADIATION RESISTANT POLYETHYLENE (3/4-INCH SIZE, ROUTING DIAGRAM)

1" FEBCO BACK FLOW PREVENTER DETAIL "F" IRRIGATION DETAILS SHEET



FEBCO MODEL 765

Pressure Vacuum Breaker

Outside Installation

NOTE: CURRENT PLAN SET IS NOT FOR CONSTRUCTION

LOT 6 & S ½ OF LOT 5, BLOCK 22, TOWN OF CASTLE ROCK TOWN OF CASTLE ROCK PROJECT NO: SDP23-0032

SITE DEVELOPMENT PLAN

08/31/2023 SHEET TITLE

SUBMITTAL

DRAWN BY:

CHECKED BY

PROJECT NO.:

REVISIONS

CONSTRUCTION

23-222-002

DOCUMENTS

PROJECT TITLE

203 PERRY ST

PROPERTIES

BAYSIDE

MISSION CAPITAL

LITTLE SCHOOL

CASTLE ROCK, CO 80104


ON PERRY ST

IRRIGATION PLAN

SHEET INFORMATION

LS3

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NOTE: USE ONE IRRIGATION

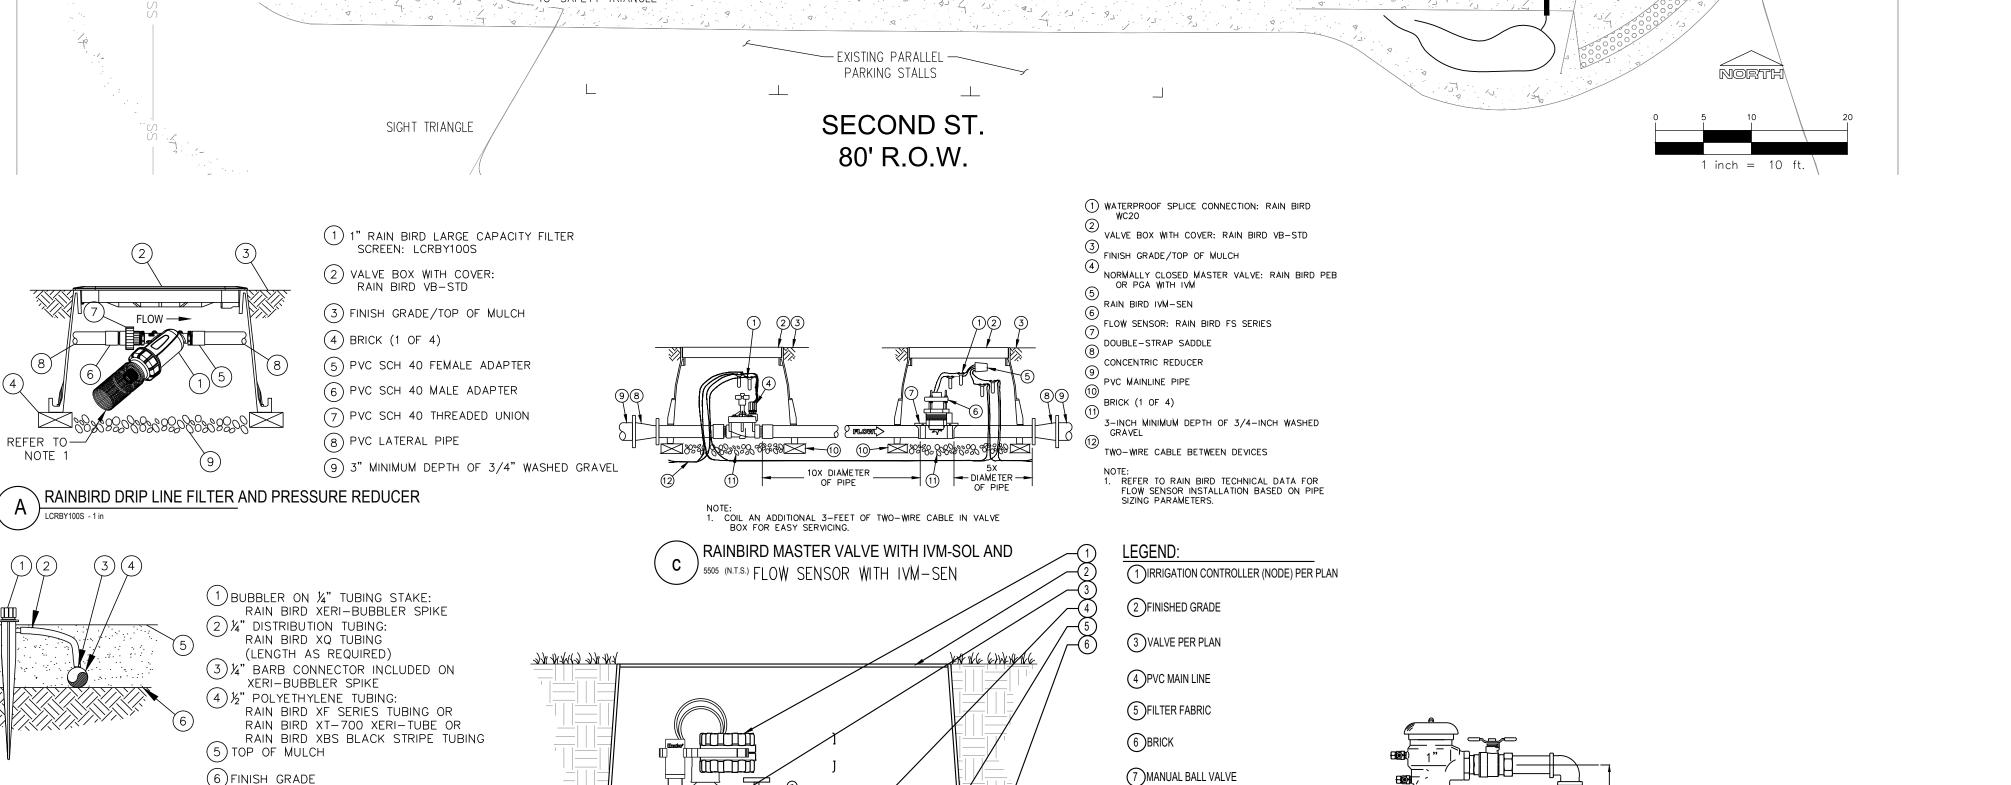BOX FOR ELECTRIC VALVE

AND PRESSURE REDUCER


VALVE AS TYPICALLY

INSTALLED

NOT TO SCALE

RAINBIRD DRIP EMITTER

LOT 6 & S 1/2 OF LOT 5, BLOCK 22, TOWN OF CASTLE ROCK LOCATED IN THE NORTHWEST QUARTER OF SECTION 11, TOWNSHIP 8, RANGE 67 WEST OF THE 6TH P.M. TOWN OF CASTLE ROCK, COUNTY OF DOUGLAS, STATE OF COLORADO

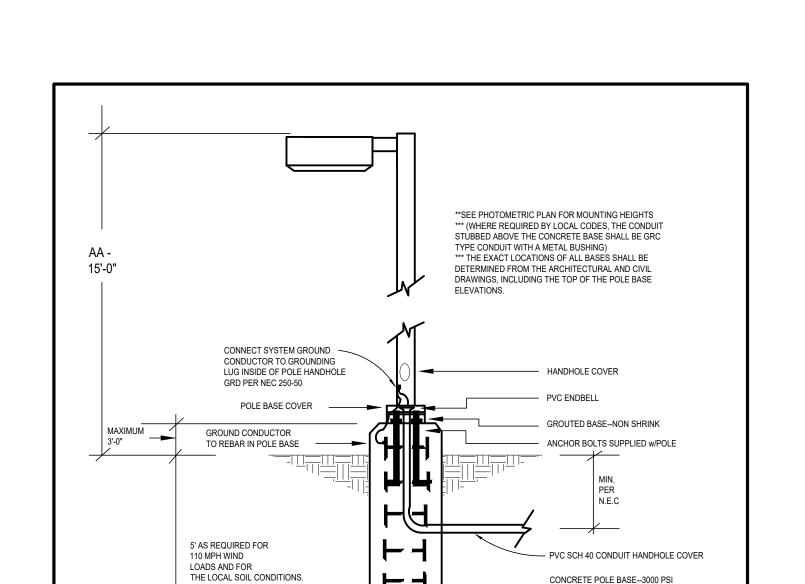


WITH 4#4 VERTICAL REBARS

12" MORE IN DIAMETER THAN THE BOLT CIRCLE DIAMETER OF THE POLE AS THE

MINIMUM DIAMETER OF THE POLE BASE.

& #2 REBAR TIES @ 12"

TYPICAL POLE BASE DETAIL scale: N.T.S.

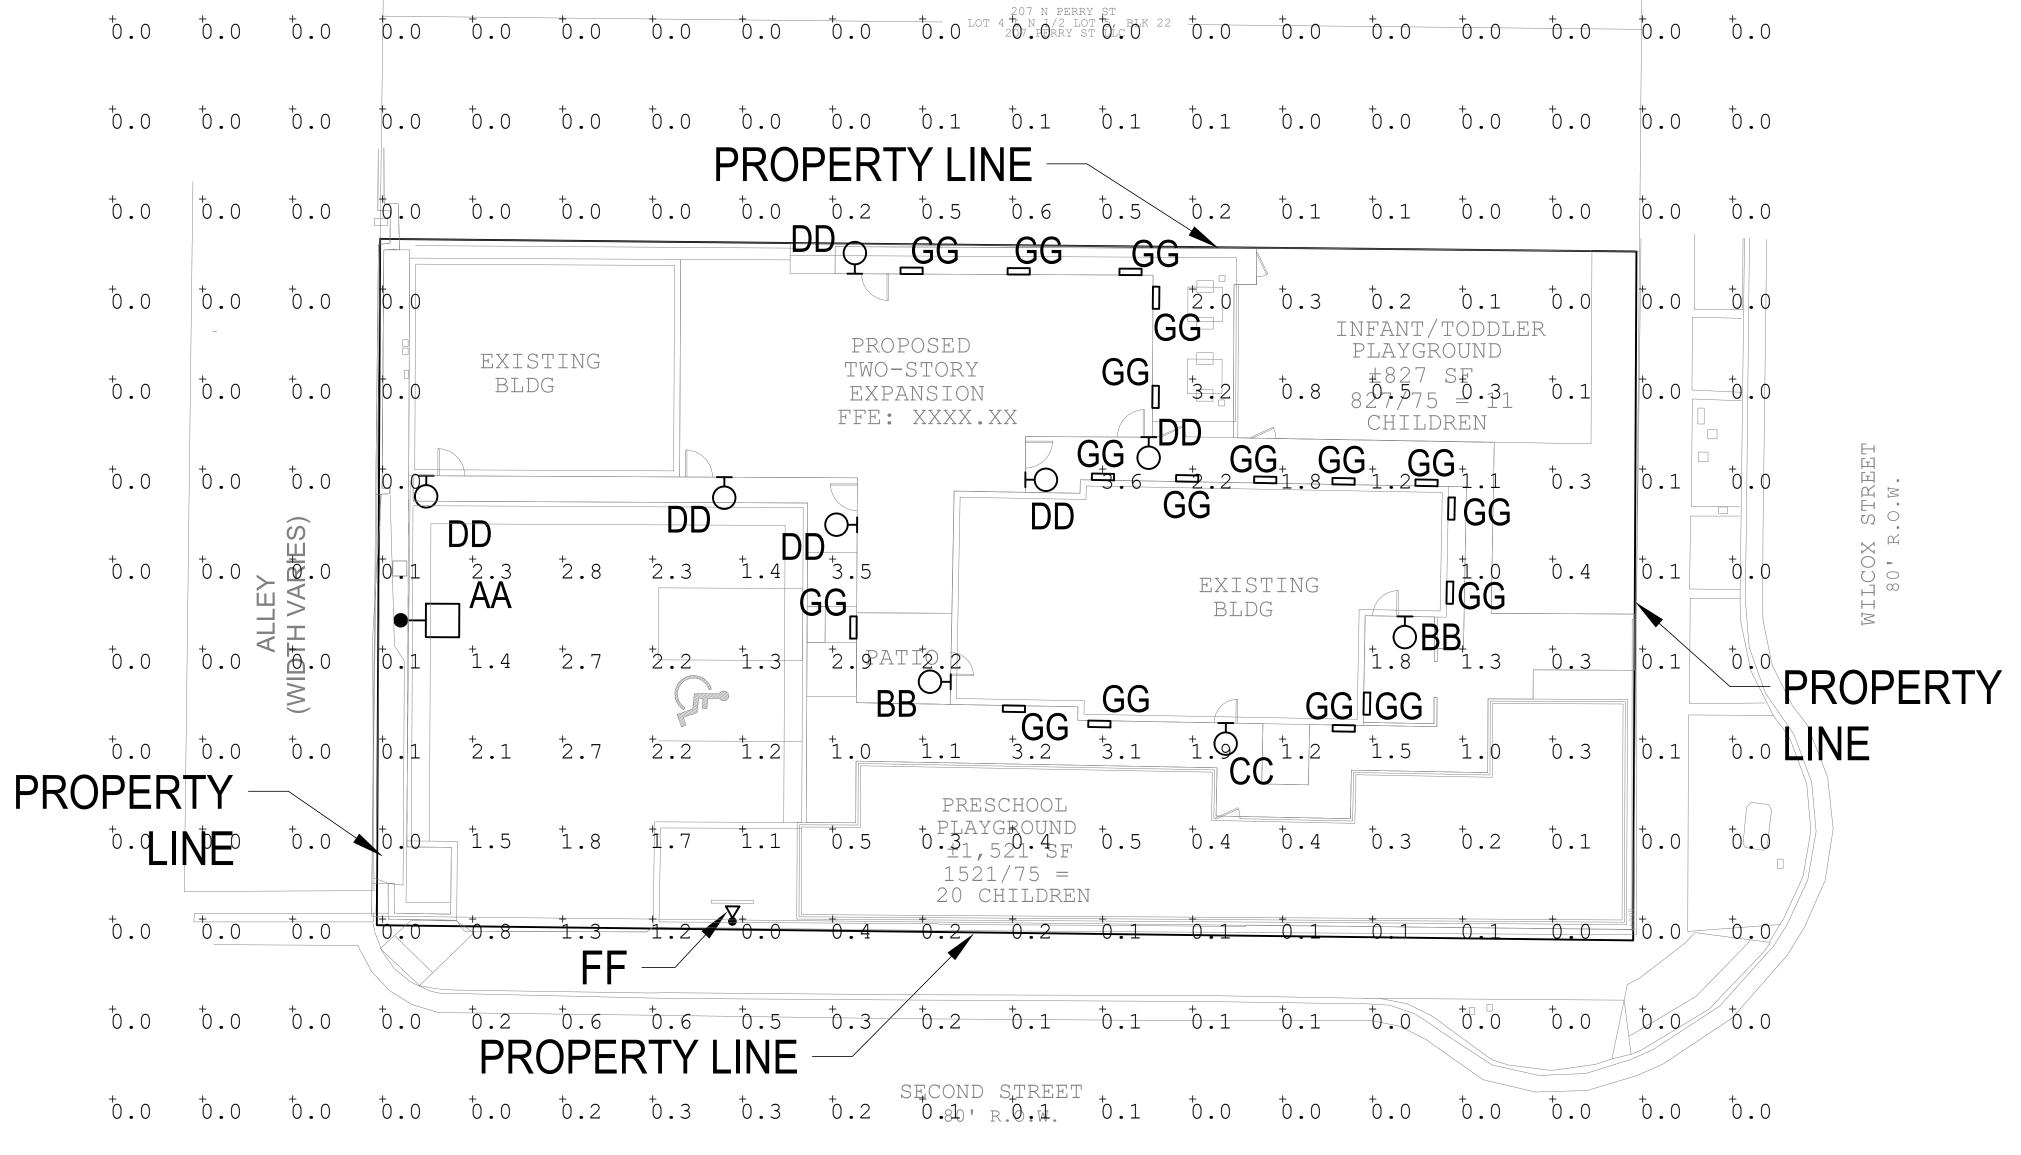

Calculation Summary							
Label	CalcType	Units	Avg	Max	Min	Avg/Min	Max/Min
OVERALL SITE	Illuminance	FC	0.43	3.6	0.0	N.A.	N.A.
PARKING	Illuminance	Fc	1.97	2.8	1.2	1.64	2.33

	LUMINAIRE SCHEDULE											
FIXT.	MANUFACTURER FINISH			LAMP DATA / INITIAL LUMEN	LAMP WATTS	LIGHT LOSS	MOUNTING METHOD	QUANTITY	MTG HEIGHT	DESCRIPTION WITH DISTRIBUTION TYPE	VOLTS	CUTTOFF
TYPE	NAME	CATALOG NUMBER	Tilviori	RATING	LY WINT VVY (110	FACTOR (LLF)	MOONTING METHOD	Q0/111111	WIGHEIGH	BESSAII HON WITT BIOTALBOTTON THE	VOLIO	0011011
AA	LSI INDUSTRIES	MRS-LED-9L-SIL-3-UNV-30-70CRI-BLK-IL	BLACK	LED / 6016	63	1.0	POLE	1	15'-0"	SITE LIGHTING SINGLE HEAD TYPE III WITH HOUSE SIDE SHIELD, 3000K 70CRI	UNV	FULL CUTOFF
BB	TRANSGLOBE	40455-BK	BLACK	LED / 806	9	1.0	SURFACE	2	6'-0"	8" WALL LANTERN, 1 E26 60W LED EQUIVALENT BULB, 3000K, VERIFY MOUNTING HEIGHT PRIOR TO INSTALLATION	120	NON-FULI CUTOFF
СС	TRANSGLOBE	51390-BK	BLACK	LED / 806	9	1.0	SURFACE	1	-	1LT WALL LANTERN, 1 E26 60W LED EQUIVALENT BULB, 3000K, VERIFY MOUNTING HEIGHT PRIOR TO INSTALLATION	120	NON-FULI CUTOFF
DD	WAC LIGHTING	DS-WS0517-N-30-S-BK	BLACK	LED / 2300	17	1.0	SURFACE	6	8'-0"	LED DOWNLIGHT, 3000K, VERIFY MOUNTING HEIGHT PRIOR TO INSTALLATION	120	FULL CUTOFF
FF	KIM	EL218-F-3-8L-3K-UV-BK, LED LAMP	BLACK	LED / 889	16	1.0	GROUND	1	-	WATERPROOF SPOT LIGHTIN FOR MONUMENT SIGN. PROVIDE WITH LOUVERS (NARROW FLOOD), 3000K	UNV	NON-FULI CUTOFF
GG	REBELLE	1645-15L-30-120-LV-EM-BT	BLACK	LED / 1580	11.2	1.0	SURFACE	17	3'-0"	WALKWAY AREA LIGHT WITH INTEGRATED BATTERY BACKUP AND INTEGRATED LOUVER, 3000K	120	FULL CUTOFF
GENERAL L	IGHTING PLAN STANDAR	RD NOTES:	-	1	1	1	TOTAL NON-FULL CUT	ΓOFF LUMENS: 3,30	7 LUMENS TOT	AL FULL CUTOFF LUMENS: 46,676 LUMENS TOTAL SITE LUM	IENS: 49,9	83 LUMENS





EP-100

08/31/2023

SHEET TITLE

NOTE: CURRENT PLAN SET IS NOT FOR CONSTRUCTION. SHEET INFORMATION **PHOTOMETRIC PLAN**

SUBMITTAL

DRAWN BY:

CHECKED BY:

CONSTRUCTION **DOCUMENTS**

PROJECT TITLE

LITTLE SCHOOL ON

CASTLE ROCK, CO 80104

MISSION CAPITAL

PERRY STREET

203 PERRY ST.

PROPERTIES

BAYSIDE


SITE DEVELOPMENT PLAN LOT 6 & S 1/2 OF LOT 5, BLOCK 22, TOWN OF CASTLE ROCK TOWN OF CASTLE ROCK PROJECT NO: SDP23-0032

15 of 16

AT A BUILDING'S FACADE, AND UNSHIELDED WALL PACKS.

Know what's below. Call before you dig.

LOT 6 & S 1/2 OF LOT 5, BLOCK 22, TOWN OF CASTLE ROCK LOCATED IN THE NORTHWEST QUARTER OF SECTION 11, TOWNSHIP 8, RANGE 67 WEST OF THE 6TH P.M. TOWN OF CASTLE ROCK, COUNTY OF DOUGLAS, STATE OF COLORADO

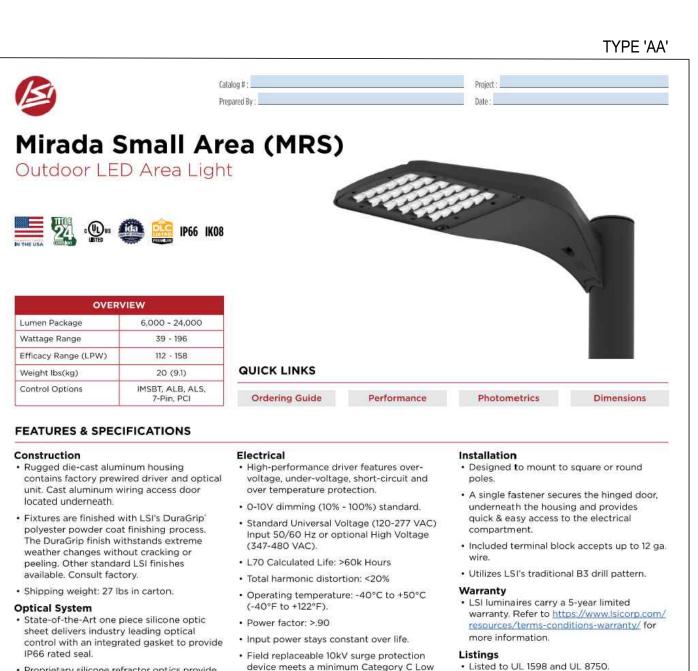

device meets a minimum Category C Low operation (per ANSI/IEEE C62,41.2).

High-efficacy LEDs mounted to metal-core

circuit board to maximize heat dissipation

for moisture resistance and complies with

FCC standards. Driver and key electronic

Bluetooth™ motion and photocell sensor.

Fixtures operate independently and can

be commissioned via iOS or Android

LSI's AirLink™ wireless control system

options reduce energy and maintenance

configuration app.

Driver is fully encased in potting material

· Meets Buy American Act requirements.

. Title 24 Compliant: see local ordinance for

IP66 rated Luminaire per IEC 60598-1.

• 3G rated for ANSI C136.31 high vibration

· IK08 rated luminiare per IEC 66262 me

· DesignLights Consortium® (DLC) qualified

product. Not all versions of this product

may be DLC qualified. Please check the D

IDA compliant: with 3000K color

temperature selection.

qualification information.

applications are qualified.

chanical impact code

Suitable for wet locations.

· Proprietary silicone refractor optics provide

· Silicone optical material does not yellow or

Available in 5000K, 4000K, and 3000K

louver (IH) options available for enhanced

color temperatures per ANSI C78.377

· Integral louver (IL) and integral half

crack with age and provides a typical light


distribution types 2, 3, 4, 5W, FT, and LC/RC.


exceptional coverage and uniformity in

transmittance of 93-95%.

Minimum CRI of 70.

backlight control.

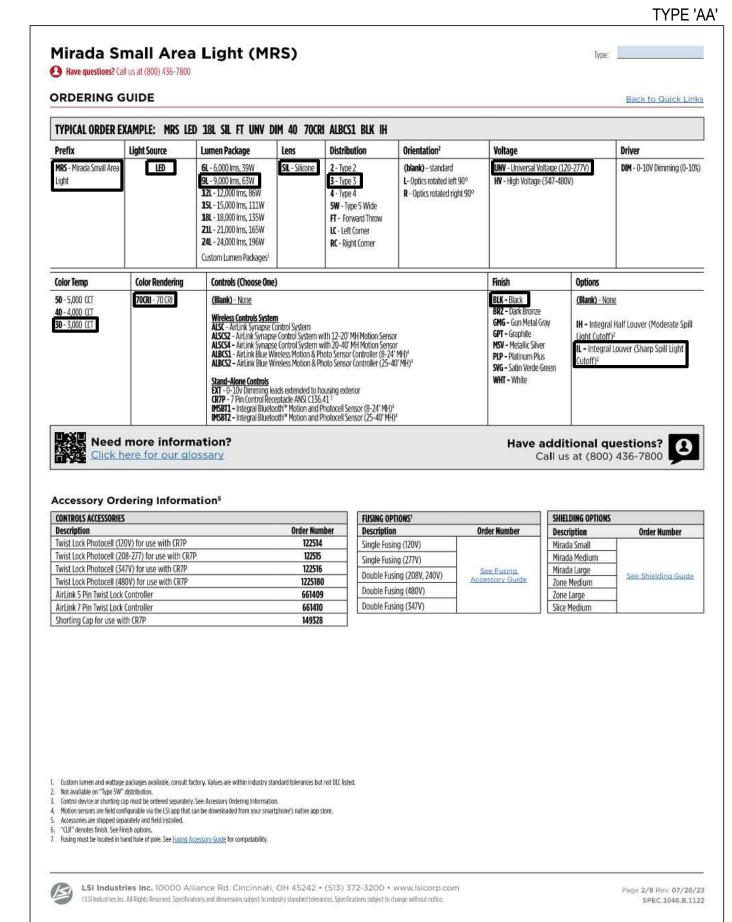


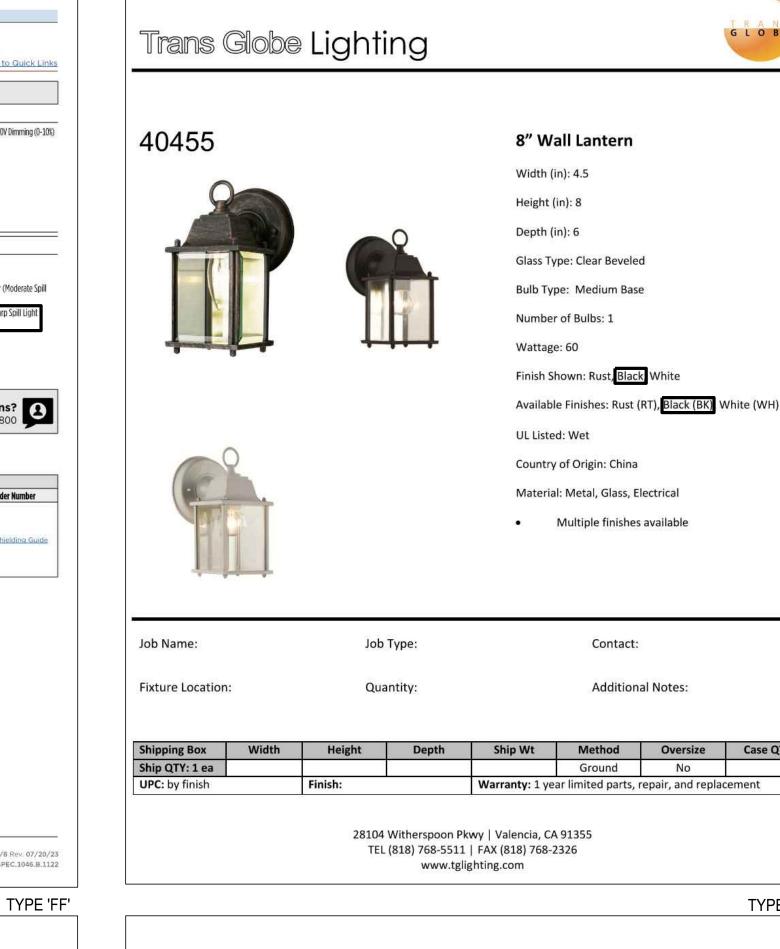




TYPE 'BB'

TYPE 'GG'

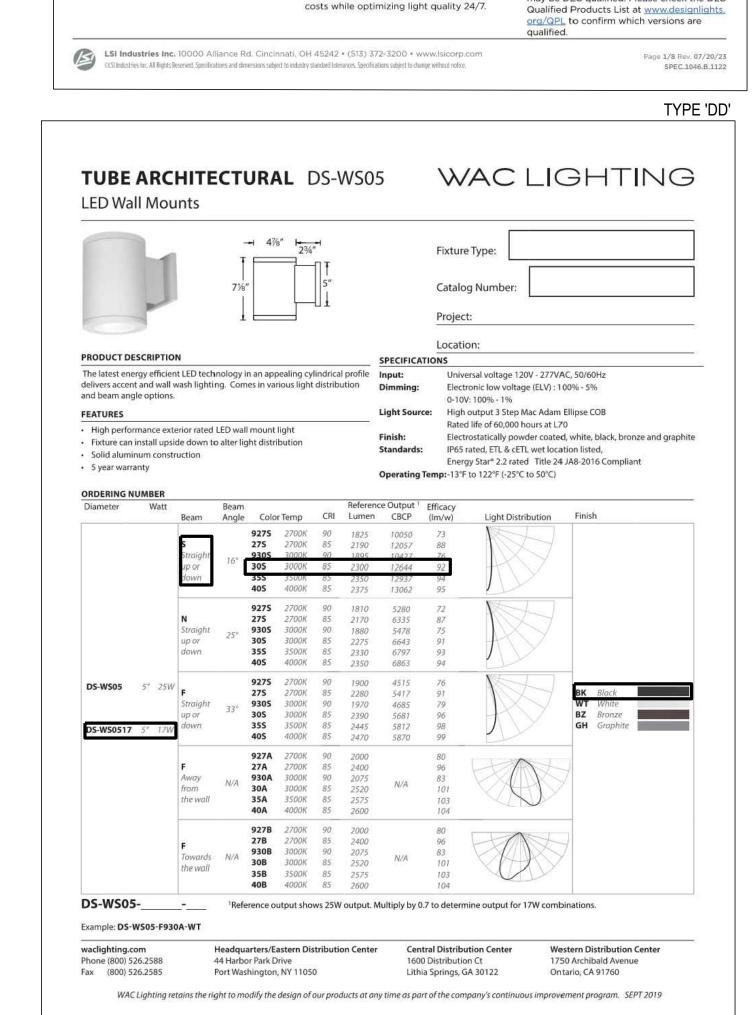

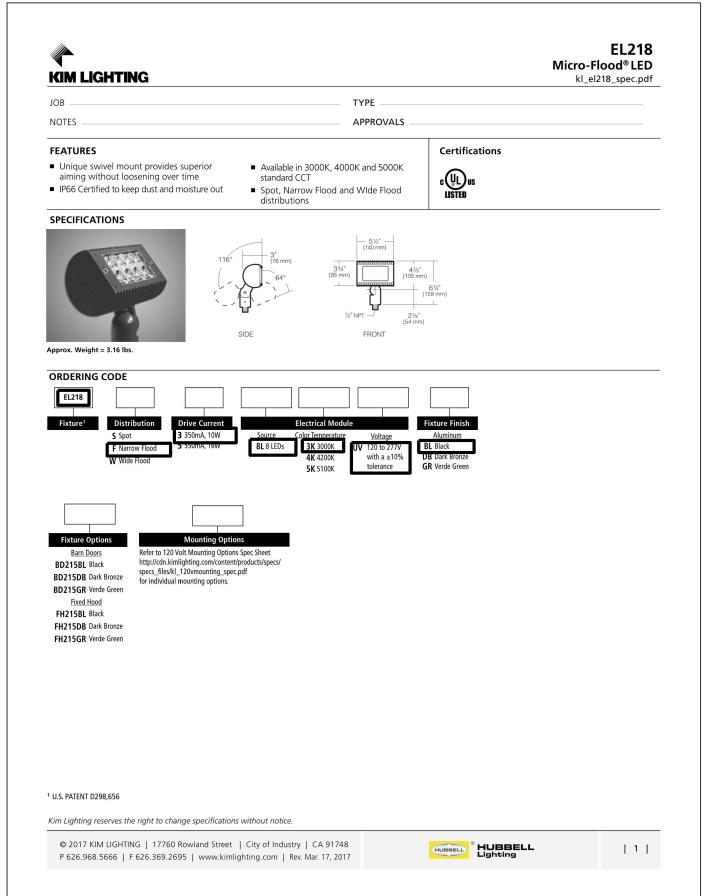





4100 Wadsworth Blvd. Wheat Ridge, CO 80033 p 303.985.3260

08/31/2023

SHEET TITLE

541 E. Garden Drive,

Windsor, CO 80550

LITTLE SCHOOL ON

CASTLE ROCK, CO 80104

MISSION CAPITAL

PERRY STREET

203 PERRY ST.

PROPERTIES

PREPARED FOR

BAYSIDE

SUBMITTAL

DRAWN BY:

CONSTRUCTION

23-222-002

DOCUMENTS

TYPE 'CC'

W ridgetopeng.con

NOTE: CURRENT PLAN SET IS NOT FOR CONSTRUCTION.

Know what's below.

Call before you dig.

PHOTOMETRIC CUTSHEETS

SHEET INFORMATION

SITE DEVELOPMENT PLAN LOT 6 & S 1/2 OF LOT 5, BLOCK 22, TOWN OF CASTLE ROCK TOWN OF CASTLE ROCK PROJECT NO: SDP23-0032

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