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MARKET: CAFÉ NAME: GRAMERCY

ID RELEASE SHELL PACKAGE 90% AOR REVIEW ENGINEERING COORD. PERMIT SET PROJECT REVISIONS:

PROJECT SEAL: new york design

ISSUED FOR CONSTRUCTION 08/15/25

DESCRIPTION

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EXPIRATION DATE: 12/31/2025 ROFESSIONAL CERTIFICATION: I HEREBY CERTIFY THAT HESE DOCUMENTS WERE PREPARED UNDER MY DIRECT PERVISION, AND THAT I AM A DULY LICENSED ROFESSIONAL ARCHITECT UNDER THE LAWS OF THE STATI

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PROJECT INFORMATION: DRAWN BY:

PROJECT MANAGER: PARTNER IN CHARGE: SHEET TITLE:

ARCHITECTURAL POWER PLAN

SHEET NUMBER: PAGE #:

A010.00 09 OF 33

DOB APPROVAL(S):

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## HUNG ACOUSTICAL CEILING TILE NOTES

- 1. NEW CEILING SUSPENSION SYSTEM TO BE 2'X2' GRID AND CEILING TILES AS SELECTED BY OWNER. CEILING AND ALL COMPONENTS OF SHALL BE ONE HOUR FIRE RATED
- 2. ALL FIXTURES IN LAY IN CEILING GRID SHALL BE TENTED IF REQUIRED BY N.Y.C. AND U.L. DESIGNS & SHALL BE OF EQUAL RATING OF CEILING LAYED IN. 3. ALL CEILING AND HANGING COMPONENTS TO BE M.E.A. OR B.S.A. APPROVED AS LISTED HEREWITH OR EQUAL:
- HANG CLIPS: B.S.A. 548-58 SM GAT CLIP: 481.5L B.S.A. 16-59 SM 4. HANGING RODS TO BE 1/4" DIA. GALVANIZED STEEL RODS NOT TO EXCEED 4'-0" O.C.
- EACHWAY PROVIDE ADDITIONAL SEISMIC BRACING AS PER CONST. STANDARDS. 5. HANGING CHANNELS TO BE 1 1/2" @ 4'-6" O.C. 16 GAUGE (COLD ROLLED) 475#
- . THE TOTAL WEIGHT OF A LIGHT FIXTURE AND OTHER EQUIPMENT INCLUDING OTHER CEILING MATERIAL SUPPORTED BY THE MAIN BEAM MUST NOT EXCEED THE ALLOWABLE DEFLECTION OF 1/360 OF ITS SPAN. DEFLECTION DATA MUST BE FURNISHED AND
- CERTIFIED BY THE MANUFACTURER. 8. SURFACE OR PENDANT FIXTURES MUST BE INDEPENDENTLY SUPPORTED FROM 1 1/2" BLACK IRON OR FROM FLOOR OR ROOF CONSTRUCTION. 9. ALL CEILINGS OR PORTION OF CEILINGS TO COMPLY WITH N.Y.C. REFERENCE

STANDARDS RS 5-15 THRU RS 5-16.

2. "\*" WITHIN THE CEILING ELEVATION TAG DENOTES INSTALLATION OF R-13 SOUND BATT

- FAN "M" FIXTURE LOCATIONS TO BE VERIFIED WITH OWNER IN FIELD. OWNER TO VERIFY MOUNTING METHOD / DROP DOWN FROM CEILING HEIGHT PER FIXTURE BASED ON EXISTING CEILING. COORDINATE WITH MECHANICAL. TYPICAL 10'-0" AFF. CONTRACTOR MUST COORDINATE AN ONSITE MEETING WITH OWNER TO APPROVE FINAL "B" FIXTURE LAYOUT AND HEIGHTS PRIOR TO INSTALL. TYPICAL 6'-8" AFF.
- 3 GC TO INSTALL "D" FIXTURES ON STEM MOUNTS. COORDINATE FINAL HEIGHTS WITH FAN HEIGHTS WITH OWNER ALL SCONCES TO BE INSTALLED @ 6'-8" AFF U.N.O. VERIFY FINAL SCONCE SELECTION FOR ADA CLEARANCE. REFER TO
- ELEVATIONS FOR HEIGHTS. PROVIDED BY OWNER. INSTALLED BY GC, LOWEST POINT OF FIXTURE PROTRUDING MORE THAN 4" TO BE MOUNTED NO LOWER THAN 6'-8" AFF FOR ADA COMPATIBILITY. ELECTRICAL CONTRACTOR TO INSTALL MALE CHORD CAP ON OWNER FURNISHED TYPE "Q" LAMP FIXTURE CUSTOM "H" BARISTA FIXTURE TO BE CENTERED ON BARISTA MILLWORK BELOW. SEE LIGHT FIXTURE SCHEDULE AND SHEET
- GC TO PROVIDE UNISTRUT FOR FLEXIBILITY OF COMMUNAL TABLE "C" FIXTURES. UNISTRUT TO BE TIGHT TO DECK AND PAINTED SPEAKERS BY OTHERS. COORDINATE SOUND ISOLATION WITH SOUND TECHNICIAN. GC TO COORDINATE WITH CLIENT FOR EXACT
- LOCATION AND QUANTITIES. SPEAKERS TO BE HUNG AS TIGHT TO THE CEILING AS POSSIBLE COORDINATE WITH OWNER. ALL DOWNLIGHTING TO BE PLACED ON A SEPARATE SWITCH, COORDINATE SWITCHING LOCATION WITH OWNER IN FIELD. ALL EXPOSED CONDUIT TO BE RUN TIGHT AND NEAT TO CEILING WHERE EXPOSED. GC TO PAINT PT2.
- 1 MAIN COUNTER AND BARISTA SOFFITS TO ALIGN WITH THE COUNTERS BELOW. DROPPED GWB CEILING ACCESS PANELS FOR MECHANICAL UNITS WITHIN LOWERED CEILING. COORDINATE WITH ENGINEERING DRAWINGS FOR ACCESS REQUIREMENTS.ACCESS PANELS SHALL BE "STEALTH" BY WINDLOCK AS STANDARD OR APPROVED

10 GC TO FINALIZE FINAL SOFFIT HEIGHT WITH BASE BUILDING'S MEPS. COORDINATE FINAL HEIGHT WITH ARCHITECT

- EQUAL. SIZE AND QUANTITIES AS REQUIRED. GC TO CARRY ALLOWANCE TO FURNISH AND INSTALL TECTUM SHEETS AT THE UNDERSIDE OF DECK ABOVE THROUGHOUT THE DINING ROOM CEILING. PAINT THEM PT2. GC TO REVIEW WITH OWNER QUANTITY & LOCATION BASED ON FINAL RCP AND
- ALL GWB CEILINGS/SOFFITS, AND ALL OTHER ITEMS ASSOCIATED WITH THE CEILING, INCLUDING PIPES, DUCTS, ETC. TO BE FIELD
- WS1 WINDOW SHADES LOCATED AT DESIGNATED WINDOWS. ALL SIZING AND MOUNTING REQUIREMENTS TO BE VERIFIED IN FIELD. LL APPROVAL REQUIRED PRIOR TO INSTALL. SEE MISC. SCHEDULE FMI.
- ACT CEILING TO ABUT WALK-IN COOLER. COORDINATE COOLER HEIGHT WITH CEILING. LIGHTING BY COOLER MANUFACTURER. COORDINATE CEILING TRIM PIECE WITH FINAL COOLER SHOP DRAWINGS.

ENGINEERS TO COORDINATE "K" FIXTURE FOR EMERGENCY LIGHT CIRCUITING. SEE MEP DRAWINGS FMI.

- GC TO COORDINATE ALL HOOD VENTS FOR EQUIPMENT WITH ENGINEERING DRAWINGS. GC TO COORDINATE CEILING GRID WITH HOOD LOCATIONS. 20 HOOD AND HOOD LIGHTING BY KITCHEN VENDOR. GC TO COORDINATE WITH KITCHEN VENDOR.
- GC / ENGINEER TO PROVIDE CIRCUIT / ELECTRICAL CONNECTION FOR EXTERIOR SIGNAGE ILLUMINATION. SIGNAGE TO BE ON PHOTOCELL G.C. TO COORDINATE INSTALLATION OF WALK-IN BOX CEILING LAYOUT WITH FOOD SERVICE CONSULTANT. PROVIDE HEADERS OR
- PANELS AS REQUIRED.NO GAPS PERMITTED LOCATION OF FOOD SERVICE PROVIDED EXHAUST/HOOD. COORDINATE CEILING WITH PARTITION FRAMERS. MAKE-UP AIR GRILL 23 TO HAVE 1/4" MAX. REVEAL BENEATH FINISHED FACE OF DRYWALL CEILING. G.C. TO ENSURE ANCILLARY PANEL OPENS
- 24 LINE DENOTES 2-HOUR WALL SEPARATION INSTALLER MUST CONFIRM HOOD IS INSTALLED AS SUCH THAT THE SPECIFIED WALL, ACTING AS AN END PANEL, IS MATED TIGHT TO THE CORRECT END OF HOOD TO ACHIEVE REDUCED MINIMUM EXHAUST CFM LISTING, NON-COMPLIANCE WILL NULLIFY THE ETL LISTING, VOID THE MANUFACTURER'S WARRANTY AND HOLD THE GC LIABLE FOR ANY AND ALL LOSSES, COSTS, AND EXPENSES RELATED TO THE NON-CONFORMANCE OF THE MANUFACTURER'S SPECIFIED INSTRUCTIONS. THE WALL ACTING AS AN END PANEL MUST EXTEND NO LESS THAN 20" UNDER BOTTOM OF HOOD TO BE ELIGIBLE FOR REDUCED MINIMUM OF "M" LISTING.
- 26 EXISTING BEAM HEIGHTS TO BE VERIFIED AND CONFIRMED BY GC IN FIELD NEW 2'x2' ACOUSTICAL CEILING TILE IN BACK OF HOUSE AREA. REFER TO FINISH SCHEDULE.
- NEW GREENBOARD GYPSUM BOARD CEILING IN TOILET ROOM. GREENBOARD CERTIFIED. 29 NEW GYP. BD. SOFFIT TO BE 8'-0" A.F.F. (TYP.) FOR ADA RESTROOM
- 30 NEW GYP. BD. SOFFIT TO BE 8'-0" A.F.F. (TYP.) FOR RESTROOM CORRIDOR. 31 GENERAL CONTRACTOR RESPONSIBLE FOR HOOD LIGHTING HOOK UP.
- GC TO PROVIDE ALLOWANCE FOR FIVE (5) ADDITIONAL ACCESS PANELS AS REQUIRED TO ACCESS ANY BASE BUILDING VALVES 32 AND/OR OTHER REQUIRED ACCESS. COORDINATE AS REQUIRED WITH BASE BUILDING ENGINEERS. ACCESS PANELS SHALL BE
- "STEALTH" BY WINDLOCK 33 GC SHALL PROVIDE UNIT PRICE FOR ADDITIONAL WINDLOCK STEALTH ACCESS PANELS AS REQUIRED
- 34 SIGNAGE. REFER TO SIGNAGE DRAWINGS BY OTHERS.
- PROVIDE OCCUPANCY SENSOR AS PER NYCECC 505.2.2.1. EXCEPTION IS MADE FOR AREAS CONTROLLED BY OCCUPANCY GC/EC SHALL LOCATE SWITCH BANKS AND ALL LIGHTING WITHIN PREMISES AT A LOCATION DETERMINED BY CLIENT OR BY NEW
- ALL LIGHT FIXTURES WITHIN 15'-0" OF EXTERIOR WALLS SHALL BE CONTROLLED AS PER NYCECC 505.2.2.3 (DAYLIGHT CONTROL
- LIGHTING BY WALK-IN-BOX MANUFACTURER 39 ELECTRIC AIR CURTAIN - REFER TO MECHANICAL DRAWINGS
- SCONCES AT CONCRETE COLUMNS TO HAVE REMOTE JUNCTION BOX AT CEILING ABOVE. ALL ELECTRICAL CONDUIT TO BE RUN TIGHT AND NEAT EXPOSED ON COLUMN
- ALL EXPOSED DUCTWORK AT THE FRONT OF HOUSE OPEN CEILING TO BE ROUND DUCT AND FIELD PAINTED PT2. DESIGN TEAM TO DECIDE ONSITE THE COLOR OF PIPES AND CONDUIT
- EXISTING CONCRETE CEILING AND BEAMS TO REMAIN EXPOSED. GC TO WASH AND STRIP ALL CONCRETE BEAMS AND CEILING OI 124 EXISTING FINISHES. GC TO REMOVE ALL UNUSED HANGERS, DEVICES, ETC. FROM OPEN CEILING. FIRE PROTECTION AND FIRE
- 125 BULKHEAD AT 8'-0" GC/ENGINEER TO PROVIDE CIRCUIT/ELECTRICAL CONNECTION FOR EXTERIOR BLADE SIGNAGE ILLUMINATION. SIGNAGE TO BE

## GENERAL NOTES

- 1. FINAL HEIGHTS TO BE DETERMINED IN FIELD WITH OWNER. 2. CENTER LIGHTS, EXIT LIGHTS, SPRINKLER HEADS, ETC. ON CEILING TILE UNLESS
- OTHERWISE NOTED. 3. ALL ACOUSTICAL CEILING TILES ARE NOT TO BE CUT LESS THAN 3" (TYP.). 4. ALL REQUIRED GWB ACCESS PANEL FOR BASE BUILDING MEP TO BE COORDINATED.
- 5. ALL ACCESS PANELS, SPEAKERS, REGISTERS, AND DIFFUSERS IN CEILINGS TO BE PAINTED SAME COLOR AS CEILING, U.N.O.
- 6. ALL ACCESS PANELS IN GWB CEILINGS TO BE TAPE-IN. 7. ALL SPRINKLER HEADS IN FRONT OF HOUSE CEILINGS TO BE CONCEALED, AND SEMI-RECESSED IN ALL OTHER AREAS. COORDINATE WITH ENGINEERING.
- 8. ALL WOOD MEMBERS AND SURFACES TO BE FIRE-TREATED/FIRE-RATED. 9. GC TO REVIEW FINAL LIGHT FIXTURE LOCATIONS WITH TENANT AND ARCHITECT PRIOR TO INSTALLATION 10. ALL DIMENSIONS TO CENTERLINE OF FIXTURE U.N.O.
- 11. CONFIRM MOUNTING HEIGHTS OF PENDANT FIXTURES WITH OWNER / ARCHITECT PRIOR TO INSTALLATION. 12. ALL A/V EQUIPMENT & ASSOCIATED DEVICES BY OTHERS. GC TO CARRY AN ALTERNATE FOR PULLING ALL THE WIRE CONNECTIVITY. COORDINATE WITH EXISTING. 13. ALL SPRINKLER HEADS COLOR TO MATCH CEILING COLOR. GC TO COORDINATE COLORS
- WITH ARCHITECT PRIOR TO PURCHASE AND INSTALL 14. CHECK WITH MECHANICAL FOR ANY INTERFERENCE. GC TO CARRY ALLOWANCE FOR ANY SPRINKLER LINES THAT REQUIRE RELOCATION. GC TO COORDINATE WITH ENGINEER DRAWINGS 15. ALL LIGHTING SYMBOLS ARE SHOWN FOR REFERENCE ONLY. REFER TO SPECIFICATIONS
- FOR MORE INFORMATION. 16. COORDINATE SPEAKER LOCATIONS WITH CLIENT, LOW VOLTAGE CONSULTANT, AND A CONNECTION TO HEAD UNIT. SPEAKERS SHALL BE TIED INTO THE FIRE ALARM SYSTEM. REFER TO ENGINEER DRAWINGS F.M.I.
- 17. IN EXPOSED CEILINGS, ALL FIRE-PROOFING THAT IS MISSING / DAMAGED TO BE REPLACED WITH THE SAME RATING / PRODUCT AS THE EXISTING FIRE PROOFING 18. GC TO VERIFY REUSE / RELOCATION / NEW REQUIRED EGRESS SIGNS AND ACCESSORIES. 19. GC TO VERIFY IN FIELD CEILING MOUNTED DATA FOR WIFI LOCATIONS. 20. ALL GWB CEILINGS / SOFFITS, AND ALL OTHER ITEMS ASSOCIATED WITH THE CEILING, INCLUDING PIPES, DUCTS, ETC. TO BE FIELD PAINTED PT2.
- 21. GC TO IDENTIFY AREAS WITHIN CEILING WITH REQUIRED ACCESS POINTS. GC TO COORDINATE WITH ARCHITECT FOR ACCESS PANELS WITHIN NEW GWB CEILINGS. 22. SEE LIFE SAFETY SHEET FOR FIRE RATING OF BUILDING COMPONENTS. GC RESPONSIBLE FOR PATCHING / REPAIRING OF THE FIRE-PROOFING SYSTEMS WHERE NEW CONNECTIONS,
- PENETRATIONS, ETC. ARE MADE. 23. WHERE CEILINGS ARE INDICATED TO BE GYP. BD., PROVIDE 5/8" GYPSUM BOARD ON METAL STUD FRAMING OR SUSPENDED CEILING SYSTEM, PROVIDE CEILING GYP. BD. CONTROL JOINTS PER MANUFACTURER'S RECOMMENDATIONS U.N.O.
- 24. VERTICALLY STACK LIGHT SWITCHES, THERMOSTATS, AND LIFE SAFETY DEVICES TO THE GREATEST EXTENT POSSIBLE. 25. CEILING HEIGHTS NOTED ARE FROM TOP OF FINISHED FLOOR (A.F.F.) TO UNDERSIDE OF FINISHED CEILING, U.N.O. 26. THE DIMENSIONS AND WORK NOTED ON THESE DRAWINGS ARE INDICATED FOR DESIGN
- INTENT. IF THE INSTALLATION OF ELECTRICAL, MECHANICAL, PLUMBING, OR FIRE PROTECTION WORK INTERFERES WITH THIS INTENT, THE ARCHITECT SHALL BE NOTIFIED PRIOR TO PROCEEDING WITH CONSTRUCTION. 27. SEE PARTITION TYPE DETAIL SHEET FOR TYPICAL DEVICE MOUNTING HEIGHT IN INFORMATION.
- 28. REFER TO ENGINEERING DRAWINGS FOR ALL CIRCUITING AND SWITCHING INFORMATION. ARCHITECTURAL DRAWINGS TO DICTATE QUANTITIES ONLY. IF DISCREPANCY OCCURS, NOTIFY ARCHITECT PRIOR TO PROCEEDING WITH CONSTRUCTION. 29. REFER TO FINISH SCHEDULE FOR FURTHER SPECIFICATION OF CEILING MATERIALS AND FINISHES 30. G.C. TO VERIFY AND COORDINATE ALL CONDITIONS IN FIELD PRIOR TO START OF WORK, INCLUDING ELECTRICAL PANEL CAPACITY, LOCATIONS, AND CLEARANCES AT MECHANICAL DUCTS, ELECTRICAL ITEMS, SPRINKLERS, AND ASSOCIATED PIPING, ANY CONFLICTS ARE TO
- BE BROUGHT TO THE ATTENTION OF THE ARCHITECT AND ENGINEER AT THE EARLIEST OPPORTUNITY 31. REFER TO ELECTRICAL AND MECHANICAL DRAWINGS FOR LOCATION OF SUPPLY AND RETURN AIR DIFFUSERS, THERMOSTATS, EXIT SIGNS, AND LIFE SAFETY EQUIPMENT. 32. ACT AND GRID TO BE CENTERED IN ROOMS U.N.O.
- 33. SPRINKLER HEADS, LIGHT FIXTURES, DIFFUSERS, AND ETC. TO BE CENTERED WITHIN ACT, U.N.O. G.C. TO VERIFY SECURITY CAMERA LOCATIONS WITH OWNER'S VENDOR AND COORDINATE WITH ARCHITECT. 34. HVAC DIFFUSERS, EQUIPMENT ACCESS PANELS & HATCHES, SPRINKLER HEAD ESCUTCHEON PLATES, EMERGENCY LIGHT FIXTURES, SMOKE DETECTORS, SECURITY
- FEATURES, AUDIO DEVICES, ETC TO MATCH ADJACENT CEILING FINISH U.N.O. SUBMIT LOCATIONS, FINISHES & STYLES OF ALL CEILING FIXTURES TO ARCHITECT FOR APPROVAL PRIOR TO PURCHASING OR CONSTRUCTION 35. ALL SPRINKLER HEADS LOCATED IN CLOSED CEILING IN VIEW OF PUBLICS AREAS SHALL BE

RECESSED AND CONCEALED WITH AN ESCUTCHEON PLATE.

- 36. G.C. TO COORDINATE LOCATION OF ALL EQUIPMENT ACCESS PANELS & HATCHES WITH NECESSARY EQUIPMENT, CEILING OR PARTITION FEATURES, LIGHTING, AND OTHER EQUIPMENT. SUBMIT TO ARCHITECT FOR APPROVAL PRIOR TO COMMENCING WITH WORK.
  - DESIGN INTENT PRIOR TO INSTALLATION OF EQUIPMENT OR SERVICES. 37. ALL ELECTRICAL CONDUIT, WIRING, PLUMBING LINES, AND OTHER SERVICES TO BE

NOTIFY ARCHITECT OF ANY DISCREPANCIES OR CONFLICTS THAT INTERFERE WITH THE

- ROUTED THROUGH CLOSED CEILING, FRAMED WALLS, FAUX BEAMS, ETC. AS NECESSARY TO CONCEAL FROM VIEW.
- 38. G.C. TO COORDINATE THE CEILING FRAMING AROUND SUCH ITEMS AS THE HOOD AND WALK-IN COOLER BOX. THE HOOD SUPPLY PLENUM SHOULD HAVE A 1/4" REVEAL BELOW
- 39. SECURITY CAMERA SCOPE AND LOCATION BY SECURITY TEAM. GENERAL CONTRACTOR TO COORDINATE AS REQUIRED. 40. SPEAKER SCOPE AND LOCATION BY AUDIO VENDER.
- 41. THE G.C. SHALL CUT, REMOVE, PATCH, AND/OR REPLACE THE EXISTING GYPSUM BOARD CEILING(S) TO ALLOW FOR ADJACENT DEMOLITION AND CONSTRUCTION AS REQUIRED. 42. AT MECHANICAL ROOM #110, THE G.C. SHALL SCRAPE EXISTING PLASTER CEILING SMOOTH,
- PATCH, FIRESTOP, AND REPAINT (WHITE). 43. ALL NEW GYPSUM BOARD CEILINGS SHALL BE FLUSH AND SMOOTH WITH EXISTING ADJACENT CEILING (U.O.N.)
- 44. ENTIRE EXPOSED CEILING SLAB SHALL BE PATCHED AND PREPARED AS REQUIRED IN ORDER TO RECEIVE NEW FINISHES. 45. THE G.C. SHALL FIRE PROOF ANY EXPOSED STRUCTURAL STEEL BEAMS WITH A
- CEMENTITIOUS NON-ASBESTOS SPRAY-ON OR TROWELED FIRE PROOFING AS REQUIRED. MONOKOTE OR APPROVED EQUAL 2 HOUR RATING MINIMUM.
- 46. ALL NEW SUSPENDED ACOUSTICAL CEILING TILE SHALL BE AT 9'-0" A.F.F. (U.O.N.) 47. REFER TO MECHANICAL ENGINEERING DRAWINGS FOR C.F.M., DIFFUSER, GRILLE, REGISTER AND LOUVER SPECIFICATIONS.
- 48. THE G.C. SHALL REMOVE & RELOCATE ANY EXISTING DUCTWORK, SPRINKLER PIPES, OR ANY OTHER UTILITIES AS REQUIRED, TO ACCOMMODATE NEW CONSTRUCTION. 49. REFER TO MECHANICAL ENGINEERING DRAWINGS FOR ALL MECHANICAL SPECIFICATIONS.

50. THE G.C. SHALL INSTALL ALL SPRINKLER HEADS AS REQUIRED SO THAT THEY ARE

- RECESSED AND FLUSH WITH NEW CEILINGS. 51. REFER TO ENGINEERING DRAWINGS FOR NEW CLASS 'E' SYSTEM 52. THE EXISTING CLASS "E" SYSTEM SHALL REMAIN OR BE RELOCATED TO THE GREATEST EXTENT POSSIBLE. ANY SPEAKERS, STROBES, ETC., REMOVED DURING THE COURSE OF CONSTRUCTION SHALL BE REMOUNTED AS REQUIRED. REPLACE ALL FIRE ALARM DEVICES WITH NEW. (U.O.N.) REFER TO FIRE ALARM DRAWINGS.
- 53. THE G.C. SHALL PROVIDE NEW CLASS "E" SPEAKER AND STROBE SYSTEM CONFORMING TO LOCAL LAW. (REFER TO FIRE ALARM DRAWINGS) 54. ALL EXISTING EXIT SIGNS SHALL BE NEW.
- 55. ALL EXISTING LIGHT SWITCHES SHALL BE REMOVED. 56. ALL NEW LIGHT SWITCHES SHALL BE RECESSED MOUNTED AT 3'-2" A.F.F. 57. ALL NEW LIGHT SWITCHES AND COVER PLATES SHALL BE 'LEVITON' DECORA SERIES.
- COLOR TO BE DETERMINED. 58. ALL NEW LIGHT DIMMER SWITCHES AND COVER PLATES SHALL BE 'LEVITON' DECORA SERIES. COLOR TO BE DETERMINED.
- 59. ALL NEW LIGHT SWITCHES SHOWN ON EXISTING MASONRY WALLS SHALL BE RECESSED MOUNTED. THE EXISTING MASONRY WALL OR COLUMN SHALL BE CHOPPED AND REPAIRED
- AS REQUIRED 60. ALL LED LAMPS SHALL BE 2700K. (U.O.N.) REFER TO LIGHT FIXTURE SCHEDULE ON SHEET
- 61. UNLESS OTHERWISE NOTED, ALL NEW LIGHT FIXTURES SHALL BE INSTALLED AT SAME HEIGHT AS EXISTING ADJACENT LIGHT FIXTURE. 62. THE G.C. SHALL MAINTAIN A MINIMUM OF 1" CLEARANCE BETWEEN THE LIGHT FIXTURE AND ANY COLUMN, SOFFIT, EXPOSED DUCT AND/OR PARTITION.
- 63. ALL RECESSED LIGHT FIXTURES SHALL BE SET FLUSH WITH CEILING GRID/GYPSUM BOARD 64. WHERE BEAMS, PIPES, DUCTS OR OTHER CONSTRUCTION DETAILS PREVENT THE USE OF STANDARD RECESSED LIGHTING FIXTURES, MATCHING SHALLOW RECESSED FIXTURES
- SHALL BE PROVIDED BY THE CONTRACTOR. 65. THE G.C. SHALL SUBMIT A COMPLETE SET OF SHEET METAL SHOP DRAWINGS. SHOW DRAWING SHALL CHECK ALL CEILING HEIGHTS AND PLENUM CONDITIONS FOR CLEARANCE OF DUCTWORK, LIGHTING AND OTHER OBSTRUCTIONS TO ASSURE FINISHED CEILING HEIGHTS SHOWN ON DRAWINGS ARE ACHIEVED. ANY DEVIATIONS SHALL BE BROUGHT TO
- NEW YORK DESIGN'S ATTENTION FOR REVIEW, APPROVED, AND FURTHER DIRECTION AS REQUIRED TO ACHIEVE DESIGN INTENT. 66. THE G.C. SHALL SUBMIT ALL REQUIRED SHOP DRAWINGS AND SUBMITTALS FOR
- ARCHITECTS REVIEW AND APPROVAL. 67. ANY EXISTING FIRE ALARM DEVICES TO REMAIN SHALL BE INSPECTED BY THE GENERAL CONTRACTOR, ELECTRICAL CONTRACTOR, AND FIRE ALARM VENDOR. REPLACE ALL
- DEVICES THAT ARE NON-OPERABLE AS REQUIRED.
- MATCH CEILING WHERE INSTALLED. 69. ANY STEMS OR CONDUIT REQUIRED FOR INSTALLATION OF LIGHT FIXTURES, EXIT SIGNS EMERGENCY LIGHT, FIRE ALARM DEVICES, ETC. SHALL BE PAINTED AS REQUIRED TO
- 70. THE GENERAL CONTRACTOR SHALL SUBMIT A BALANCING REPORT ALONG WITH ANY SUBMITTALS AS REQUIRED FOR SPECIAL INSPECTION SIGN-OFF

Location of speaker system audio controls

Location of speaker system

head end

new york design

ISSUED FOR CONSTRUCTION 08/15/2

PROJECT APPROVALS:

PROJECT ADDRESS:

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PROPERTY OWNER

**TATTE BAKERY & CAFÉ** 

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MEP ENGINEER

175 WEST BROADWAY

CAFÉ NAME: GRAMERCY

DESIGN MILESTONES

SHELL PACKAGE

90% AOR REVIEW

PERMIT SET

ENGINEERING COORD

PROJECT REVISIONS:

3 IFC SET - BULLETIN 01

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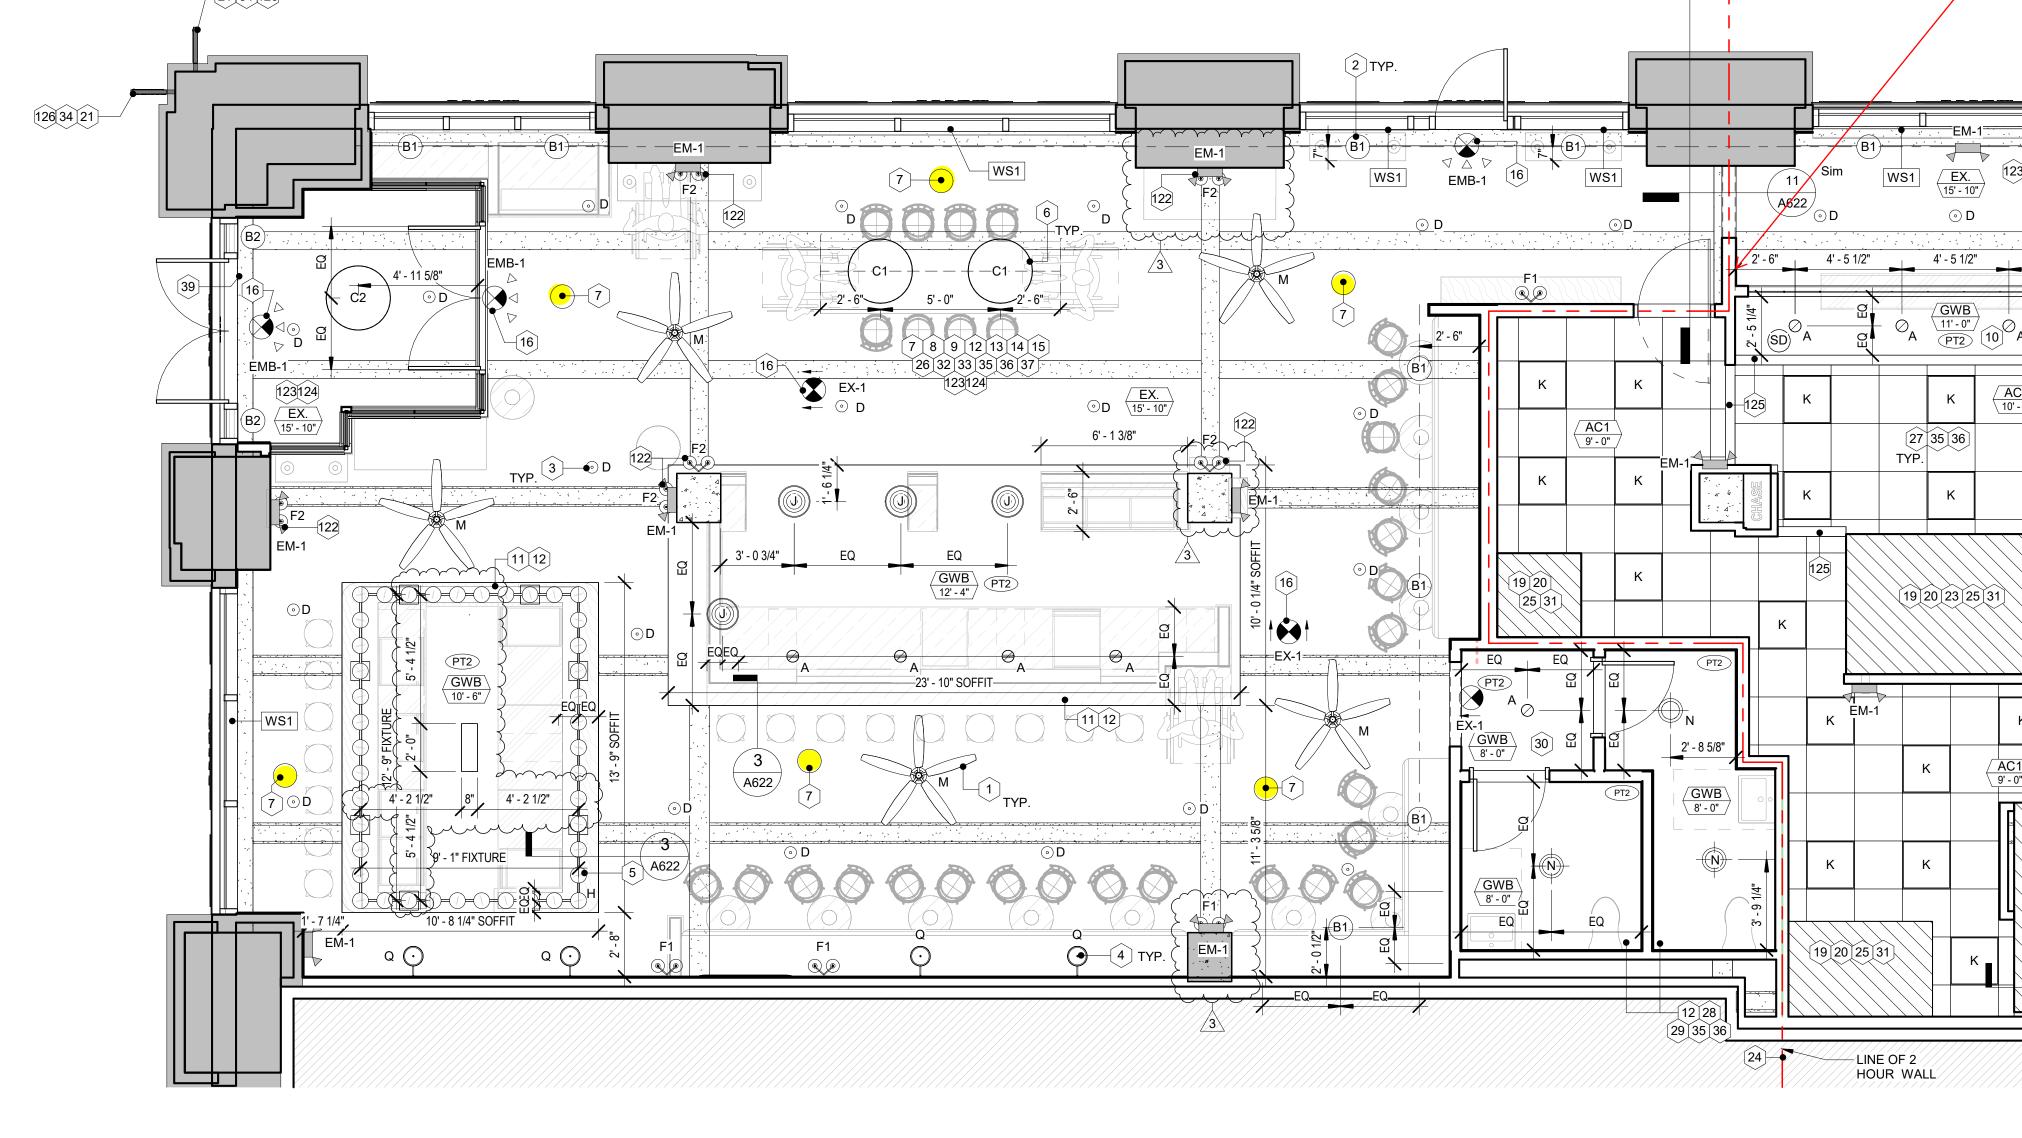
PROJECT INFORMATION

SHEET TITLE: REFLECTED CEILING PLAN

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AUDIO SYSTEM COMPONENTS BOSE DESIGNMAX DM5P WHITE - 5.25" PENDANT

**SPEAKER** 

LEA PROFESSIONAL 4 CHANNEL DANTE AMPLIFIER WITH EQ

LEA PROFESSIONAL CONNECT WALL MOUNT CONTROLLER-POE-WHITE


ARAKNIS 320 SERIES 8-PORT SWITCH WITH FULL POE+ AND REAR PORTS

LOWELL RACK WALL 18.375"H X 19.05"D X 23.06"W

LOWELL RACK PANEL VENTED 1RU 35% OPEN AREA, **BLACK** 

LOWELL RACK SHELF VENTED 1RU 10D

**FURMAN 20 AMP PWR CONDITIONER** 

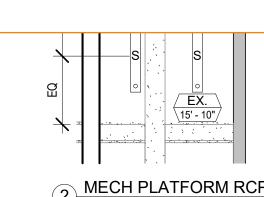

1) REFLECTED CEILING PLAN 1/4" = 1'-0"