SUNY SCCC ELSTON HALL LOBBY & MOHAWK ROOM RENOVATIONS | RFB-2024-20

78 WASHINGTON AVE SCHENECTADY, NY 12305 APRIL 19TH 2024



PROJECT DESCRIPTION

SCOPE OF WORK:

- THE PROJECT IS BROKEN INTO (2) TWO SEPARATE AREAS OF WORK. PLEASE REFERENCE ALL CONTRACT DOCUMENTS. THE PROJECT INVOLVES THE INTERIOR RENOVATION TO:
- A. ELSTON HALL LOBBY AND SECURITY: RENOVATION OF EXISTING ROOM'S FLOORS, WALLS, FINISHES, CEILINGS, AND LIGHTING. THE WORK ALSO INCLUDES A NEW SECURITY ROOM, INTERIOR ENTRANCE VESTIBULE FACADE AND OFFICE SPACE. MULTI PRIME BID INCLUDES GENERAL CONSTRUCTION, MECHANICAL AND ELECTRICAL WORK. SEE ALL CONTRACT DOCUMENTS FOR DETAILED SCOPE OF
- B. MOHAWK ROOM: ALTERNATE #1 RENOVATION OF EXISTING ROOM'S FLOORS, WALLS, FINISHES, DOORS, CEILINGS, AND LIGHTING. THE MULTI PRIME ALTERNATE BID INCLUDES GENERAL CONSTRUCTION, AND ELECTRICAL WORK. SEE ALL CONTRACT DOCUMENTS FOR DETAILED SCOPE OF WORK.
- THIS IS A LEVEL II ALTERATION (<50%) OF BUILDING AREA WITH NO CHANGES IN USE OR HAZARD LEVEL. ALL EXISTING EGRESS POINTS WILL BE MAINTAINED. NEW LIGHTING SHALL BE PROVIDED AS OUTLINED IN THE SCOPES OF WORK. NEW MECHANICAL SHALL BE PROVIDED AS OUTLINED IN THE SCOPE OF WORK.
- REFERENCE ABATEMENT DRAWINGS FOR WORK ASSOCIATED WITH
- ELSTON HALL EXISTING AREA 144,696 NET S.F. EXISTING MASONRY EXTERIOR
- AREA OF WORK FOR PROJECT RENOVATION +/- 8,040 S.F. (5.6% ALTERATIONS)
- OCCUPANCY GROUP OF EXISTING AREA: A. A-2 - ASSEMBLY B. B-BUSINESS

EXISTING OCCUPANCY DOES NOT CHANGE

7. NON-SPRINKLERED - WORK AREA DOES NOT EXCEED 50% OF FLOOR AREA

RESPONSIBILITY MATRIX

	000	INIY	SCCC		CONTRACTOR			
SCOPE OF WORK	FURNISH	INSTALL	FURNIS H	INSTALL	FURNISH	INSTALL	NOTES	
INTERIOR SIGNAGE AND VINYL GRAPHICS					GC	GC		
AV SYSTEMS AND COMPONENTS INCLUDING CAT6 AND BOXES	X	X					AUDIO VIDEO CORP, GC SHALL COORDINATE CUTS AND DISTRIBUTION	
DATA					EC	EC	EC TO COORDINATE WITH COUNTY	
SECURITY SYSTEMS (INCLUDING SECURITY CAMERAS)	X	X					GC TO COORDINATE WITH COUNTY VENDOR	
CAT6 TO IT RACK IN SECUIRTY					EC	EC	EC TO COORDINATE LOCATION(S) WITH COUNTY	

NOTE: DOES NOT INCLUDE FULL SCOPE OF WORK FOR CONTRACTS. SEE RFB-2024-20 DRAWINGS AND SPECIFICATIONS

ABBREVIATIONS:

GC: GENERAL CONTRACTOR PC: PLUMBING CONTRACTOR

PROJECT TEAM

M/E ENGINEERING

T: 518.533.2171

433 STATE STREET, 4TH FLOO


SCHENECTADY, NY 12305

SC OFFICE OF FACILITIES	OWNER
SCHENECTADY COUNTY	SUNY SCCC
620 STATE STREET	78 WASHINGTON AVE.
SCHENECTADY, NY 12305	SCHENECTADY, NY 12305

ARCHITECT: C2 ARCHITECTURE, PC 24 AIRPORT ROAD SCHENECTADY, NY 12302 T: 518.320.8250

ABATEMENT: ECS MID ATLANTIC 421 NEW KARNER ROAD ALBANY, NY 12205 T: 838.900.2851

PROJECT LOCATION

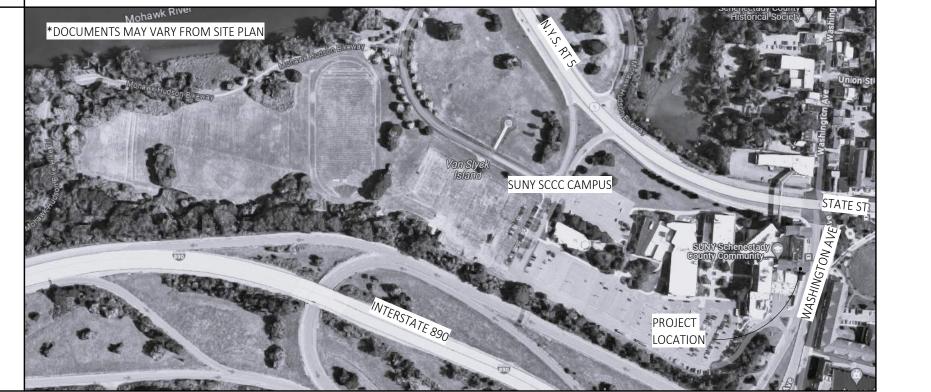



www.C2-DesignGroup.com 24 AIRPORT ROAD SCHENECTADY, NY 12302 518.320.8250

SUNY SCCC 78 Washington Ave. Schenectady, NY 12305

SC Office of Facilities: Schenectady County 620 State Street Schenectady, NY 12305 518.388.4200

C2 Architecture, PC 24 Airport Road Schenectady, NY 12302 T: 518.320.8250

M/E/P Engineer: M/E Engineering 433 State Street, 4th Floor Schenectady, NY 12305 T: 518.533.2171

Abatement: **ECS Mid Atlantic** 421 New Karner Road Albany, NY 12205 T: 838.900.2851

SUNY SCCC ELSTON HALL LOBBY & MOHAWK ROOM RENOVATIONS

78 Washington Ave Schenectady, NY 12305

	BID RFB-20	124-20
No.	REVISION#	DATE:

Drawn By:	C2 Architecture
Scale:	As Noted
Date:	04/19/2024
Job No:	2349
Sheet Title:	

COVER SHEET

Sheet Number:

PLOT DATE: 4/26/2024 9:33:44 AM

ABBREVIATIONS

	<u>ABBREVIATIONS</u>			
KEY NAME	FULL NAME	KEY NAME	FULL NAME	
A.B.	ANCHOR BOLT	O.A.	OVERALL	
ABR.	ABRASIVE FINISH	O.C.	ON CENTER	
ACT ADH.	ACOUSTICAL CEILING TILE ADHESIVE	O.D. OH	OUTSIDE DIAMETER OVERHEAD	
ADII. ADJ.	ADJUSTABLE	O.H.	OPPOSITE HAND	
AFF	ABOVE FINISH FLOOR	OPG.	OPENING	
ALUM. ALT.	ALUMINUM ALTERNATE	PC PCF	PIECE POUNDS PER CUBIC FT	
ALT. APPROX.	APPROXIMATE	PCF PL	PLASTIC LAMINATE	
ARCH.	ARCHITECT	PLAM	PLASTIC LAMINATE	
B/	BOTTOM OF	PLT	PLATE	
B/B BD.	BACK TO BACK BOARD	PLF PLUMB.	POUNDS PER LINEAR FT PLUMBING	
BLDG.	BUILDING	PLYWD	PLYWOOD	
BLK	BLOCK	POLY	POLYETHYLENE	
BM B.O.	BEAM BOTTOM OF	PR. PSF	PAIR POUNDS PER SQUARE FT	
BOT.	BOTTOM	PSI	POUNDS PER SQUARE IN	
B.A.	BEARING PLATE	PFT	PORCELAIN TILE	
BR. BRG.	BRICK BEARING	PT PTD.	PAINT PAINTED	
CAB.	CABINET	Q.T.	QUARRY TILE	
СВ	CATCH BASIN	R.	RISER	
CDX. CF	C-D GRADE EXT. PLYWOOD	RAD. RB	RADIUS	
C.H.	CUBIC FEET CABINET HEATER	R.D.	RUBBER BASE ROOF DRAIN	
CIR.	CIRCUIT	REF.	REFERENCE	
C.J.	CONTROL JOINT	REINF.	REINFORCING	
CL CLG.	CENTER LINE CEILING	REQ'D. REV.	REQUIRED REVISION	
CLG.	CLEAR	RFL	RUBBER FLOOR	
CMU	CONCRETE MASONRY UNIT	R.L.	ROOF LEADER	
COL.	CONCRETE	RM.	ROOM	
CONC. CONST.	CONCRETE CONSTRUCTION	RT. R.V.	RESILIENT TILE ROOF VENT	
CONT.	CONTINUOUS	SCHED.	SCHEDULE	
CONTR.	CONTRACTOR	SECT.	SECTION	
COORD. CORR.	COORDINATE CORRUGATED	SF SHT.	SQUARE FOOT SHEET	
CORR. CPT	CARPET	SHT. SIM.	SIMILAR	
CRS.	COURSES	SPEC.	SPECIFICATIONS	
CSK. CT	COUNTER SINK	SQ. S.S.	SQUARE STAINLESS STEEL	
C.W.	CERAMIC TILE COLD WATER	S.S. ST	STAINLESS STEEL STAIN	
DET	DETAIL	STD.	STANDARD	
DIA .	DIAMETER	STL.	STEEL	
DIAG. DIM.	DIAGONAL DIMENSION	STRUCT. SUSP.	STRUCTURAL SUSPENDED	
DR	DOOR	T.	TREAD	
DWG	DRAWING(S)	T/	TOP OF	
EA. E.F.	EACH EACH FACE	T&B T/C.	TOP AND BOTTOM TOP CHOR	
E.J.	EXPANSION JOINT	T/F	TOP FLANGE	
ELEC.	ELECTRICAL	T/FTG	TOP OF FOOTING	
ELEV. EQ	ELEVATION EQUAL	T.O. THK.	TOP OF THICK	
EQUIP.	EQUIPMENT	THRU.	THROUGH	
ETR	EXISTING TO REMAIN	TP.	TOPPING	
EXIST. EXP.	EXISTING	TRANS. TS.	TRANSVERSE	
EXP. EXT.	EXPOSED EXTERIOR	T/S	TUBE STEE TOP OF SLAB	
F.D.	FLOOR DRAIN	T/STL.	TOP OF STEEL	
F.C.	FAN COIL	TYP.	TYPICAL	
FDN. F.F.	FOUNDATION FINISH FLOOR	UNEX. UNO	UNEXCAVATED UNLESS NOTED OTHERWIS	
FIN.	FINISH	VAR.	VARIES	
FLG.	FLANGE	VB	VINYL BASE	
FLR. FT.	FLOOR FEET	V.B. VCT	VAPOR BARRIER VINYL COMPOSITE TILE	
GRP.	GROUP	VERT.	VERTICAL	
GWB	GYPSUM WALL BOARD	V.I.F.	VERIFY IN FIELD	
GYP. H.B.	GYPSUM HOSE BIB	VTR W	VENT THRU ROOF WATER	
H.B.	HANDICAP HOSE BIR	W/	WATER	
HDW.	HARDWARE	WB	WOOD BASE	
HDWD H M	HARDWOOD	W.J.	WATER CLOSET	
H.M. HORIZ.	HOLLOW METAL HORIZONTAL	WD W.I.	WOOD WROUGHT IRON	
H.P.	HIGH POINT	W.W.F.	WELDED WIRE FABRIC	
H.S.	HIGH STRENGTH			
HT. HVAC	HEIGHT HEAT, VENT AND AC			
H.W.	HOT WATER			
H.W.T.	HOT WATER TANK			
I.D. I.E.	INSIDE DIAMETER INVERT ELEVATION			
I.E. IN.	INCH(ES)			
INSUL.	INSULATION			
INT.	INTERIOR			
INV. JAN.	INVERT JANITOR			
JT.	JOINT			
LAM.	LAMINATED			
LAV. LLH.	LAVATORY LONGER LEG HORIZONTAL			
LLT. LLV.	LONGER LEG VERTICAL			
LOC.	LOCATION			
LONG. L.P.	LONGITUDINAL			
L.P. M.	LOW POINT METER			
MANUF.	MANUFACTURER			
MAS.	MASONRY			
MAT. MAX.	MATERIAL MAXIMUM			
MAX. M.B.	MAXIMUM MACHINE BOLTS			
MC	METAL CHANNEL			
M.C.	MECHANICAL CONTRACTOR			
MECH. MED.	MECHANICAL MEDIUM			
MISC.	MISCELLANEOUS			
M.O.	MASONRY OPENING			
M.T. MTL	METAL THICKNESS METAL			
N.I.C.	NOT IN CONTRACT			
NO.	NUMBER			

NO.

NOM.

NUMBER

NOMINAL

N.T.S. NOT TO SCALE

SYMBOLS



WINDOW TAG: REFERENCE WINDOW SCHEDULE ON A900 FOR SIZE AND DETAIL



ELEVATION TAG: DRAWING NUMBER (TOP NUMBER) Ref SHEET NUMBER (BOTTOM NUMBER)



INTERIOR ELEVATION TAG:
DRAWING NUMBER (TOP NUMBER) REFERENCE SPECIFIED SHEET FOR DRAWING NUMBER



<u>DOOR TAG:</u> REFERENCE DOOR SCHEDULE ON A900 FOR SIZE AND DETAIL



WALL TYPE TAG: RATING REFERENCE WALL TYPES FOR WALL CONSTRUCTION




T.O. SLAB
0' - 0"

ELEVATION MARKER:
SPECIFIES THE VERTICAL
HEIGHT AT A GIVEN LOCATION



PLAN DETAIL TAG: DRAWING NUMBER (TOP NUMBER) REFERENCE SPECIFIED SHEET A101 SIM FOR DRAWING (BOTTOM NUMBER)

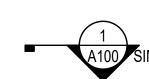

SECTION DETAIL TAG: DRAWING NUMBER (TOP NUMBER) REFERENCE SPECIFIED SHEET FOR DRAWING (BOTTOM NUMBER)



<u>DEMOLITION TAG:</u> REFERENCE PLANS AND GENERAL DEMOLITION NOTES



EQUIPMENT TAG: REFERENCE PLANS AND EQUIPMENT SCHEDULES



NOTE TAG:
SEE ASSOCIATED LEGEND



FLOOR DRAIN (FD)



ROOF DRAIN (RD)






EXISTING WALL TO REMAIN, TYP.





NEW STUD WALL CONSTRUCTION

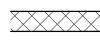

NEW MASONRY WALL CONSTRUCTION




EXISTING DOOR TO REMAIN, TYP.



EXISTING DOOR TO BE REMOVED, TYP.



Sheet Number	Sheet Name	Appear In View Sheet	Current Revision	Current Revision Date	Base Bid	Alternate #
1						
G100	Cover Sheet					
G101	Sheet List, Abbreviations and Symbols					
G102	General Notes					
G200	Elston Hall 1st Level Life Safety Plan					
G203	Accessibility Details					
G300	Area of Work Plan					
Elston Ha	ll Lobby					
D100A	Elston Hall Lobby Demolition Plan				Χ	
D600A	Elston Hall Lobby Demolition Details				Х	
D800A	Elston Hall Lobby Ceiling Demolition Plan				Χ	
4100A	Elston Hall Lobby Floor Plan				Х	
A600A	Details - Elston Hall Lobby				Х	
A601A	Details - Security Desk				Х	
4700A	Interior Elevations - Elston Hall Lobby				Х	
4701A	Interior Elevations - Elston Hall Lobby				Х	
4702A	Interior Elevations and Details - Elston Hall Lobby				Х	
A800A	Elston Hall Lobby Reflected Ceiling PLan				Х	
A900A	, ,				Х	
A901A	Schedules-Elston Hall Lobby X					
Mohawk F	Room (Alternate #1)	<u> </u>				
D100B	Mohawk Room Demolition Plan					Х
D800B	Mohawk Room Ceiling Demolition Plan					Х
A100B	Mohawk Room Floor Plan					Х
4700B	Interior Elevations - Mohawk Room					Х
A800B	Mohawk Room Reflected Ceiling Plan					Х
A900B	Mohawk Room Finish Plan					Х
A901B	Door Schedule - Mohawk Room X				Х	
Mechanic	al Drawings					-
M001	HVAC Symbols, Lists, Details, and Schedules					
M101A	Mechanical Removal and Renovation Plan				Χ	
M101B	Mohawk Room HVAC Plans - Alternative #1					Х
Electrical	Drawings					-
E001	Electrical Legend and Abbreviations					
ER101A	Elston Hall Lobby Power and System Removals Plan				Χ	
ER101B	Mohwak Room Electrical Removals Plan					X
ER201A	Elston Hall Lobby Lighting Floor Plan				Χ	
ER201B	Mohawk Room Lighting Removals Plan					X
E101A	Elston Hall Lobby Power and System Plan				Χ	
E101B	Mohwak Room Power and Systems Plan					X
E201A	Elston Hall Lobby Lighting Floor Plan New				Χ	
E201B	Mohawk Room Lighting Plan					Х
E701	Electrical Schedules					

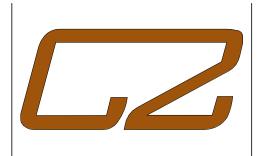

DESIGN GROUP www.C2-DesignGroup.com 24 AIRPORT ROAD SCHENECTADY, NY 12302 518.320.8250

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Stamp:		
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SUNY SCCC ELSTON HALL LOBBY & MOHAWK ROOM RENOVATIONS

78 Washington Ave Schenectady, NY 12305

	BID RFB-20	24-20	
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Drawn By:	C2 Architecture	
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Date:	04/19/2024	
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SHEET LIST,		
ABBREVIATIONS AND		
SYMBOLS		

Sheet Number:

PLOT DATE: 4/26/2024 9:33:44 AM

2. THE INTENT OF THE CONTRACT DOCUMENTS IS TO PROVIDE ADEQUATE INFORMATION FOR BIDDING. "THE WORK" SHALL INCLUDE ALL LABOR, MATERIALS, TRANSPORTATION, EXPEDITING INSTALLATION, INSPECTIONS, CLEANUP AND DISPOSAL FEES REQUIRED TO EXECUTE "THE WORK" IN A TOTAL FINISHED MANNER, UNLESS NOTED OTHERWISE.

3. UNAUTHORIZED ALTERATIONS OR ADDITIONS TO THE CONTRACT DOCUMENTS IS A VIOLATION OF FEDERAL AND STATE LAWS.

4. NOTES APPEAR ON VARIOUS DRAWINGS FOR DIFFERENT SYSTEMS & MATERIALS. REVIEW ALL SHEETS AND APPLY NOTES TO RELATED BUILDING COMPONENTS. REFER TO COMPLETE SET OF ISSUED CONTRACT DOCUMENTS FOR OTHER APPLICABLE NOTES, ABBREVIATIONS AND SYMBOLS.

5. WORDS AND ABBREVIATIONS THAT ARE USED WITHIN THE CONTRACT DOCUMENTS HAVE WELL KNOWN TECHNICAL MEANINGS WITHIN THE ENGLISH LANGUAGE, THE CONSTRUCTION TRADE INDUSTRY, AND ARE USED WITH SUCH RECOGNIZED MEANINGS.

6. "PROVIDE" SHALL MEAN FURNISH AND INSTALL, UNLESS NOTED OTHERWISE.

7. DO NOT SCALE DRAWINGS. USE FIGURED DIMENSIONS. ALL DIMENSIONS ARE IN FEET AND INCHES. CENTER PARTITIONS ON COLUMNS OR MULLIONS UNLESS NOTED OTHERWISE, OR USE EQUAL/EQUAL AND ALIGN SURFACES TO LOCATE PARTITIONS. THE CONTRACTOR SHALL VERIFY AND BE RESPONSIBLE FOR ALL DIMENSIONS AND CONDITIONS ON THE JOB. NOTIFY THE ARCHITECT OF MISSING DIMENSIONS AND DISCREPANCIES FOR RESOLUTION BEFORE PROCEEDING WITH "THE WORK".

8. UNLESS NOTED OTHERWISE, ALL DIMENSIONS ARE TO/FROM FACE OF STUD, CMU, COLUMN CENTER LINE, OR FACE OF EXTERIOR FINISHED SURFACE.

9. DIMENSIONS NOTED "CLEAR/CLR." ARE NOT TO BE ADJUSTED WITHOUT APPROVAL OF ARCHITECT/ENGINEER.

10. THE CONTRACTOR IS SOLELY RESPONSIBLE FOR ALL CONSTRUCTION MEANS, METHODS, TECHNIQUES, SEQUENCES, PROCEDURES, AND FOR COORDINATING "THE WORK".

11. ALL MATERIALS AND EQUIPMENT SPECIFIED SHALL BE SUPPLIED, INSTALLED, CONNECTED, ERECTED, CLEANED, AND CONDITIONED AS DIRECTED BY THE SUPPLIER/MANUFACTURER, IN ACCORDANCE WITH ACCEPTED INDUSTRY STANDARD PRACTICE AND IN COMPLIANCE WITH

12. THE ARCHITECT WILL CONSIDER MATERIAL CHANGE REQUESTS ON AN INDIVIDUAL BASIS. THE CONTRACTOR SHALL SUBMIT SAMPLES AND CUTS FOR WRITTEN APPROVAL PRIOR TO THE START

13. ALL WORK, WHETHER SHOWN OR IMPLIED, UNLESS SPECIFICALLY QUESTIONED, SHALL BE CONSIDERED FULLY UNDERSTOOD IN ALL RESPECTS BY THE CONTRACTOR, AND THEY WILL BE RESPONSIBLE FOR ANY MISINTERPRETATIONS OR CONSEQUENCES THEREOF FOR ALL WORK ON

14. CONTRACTOR SHALL EXAMINE THE SITE AND INCLUDE IN THEIR WORK THE EFFECT OF ALL EXISTING CONDITIONS ON THE WORK.

15. THE CONTRACTOR IS RESPONSIBLE FOR FAMILIARIZING THEMSELVES WITH THE BUILDING RULES AND REGULATIONS BEFORE AND DURING THE COURSE OF THIS PROJECT. SHOULD A CONFLICT ARISE BEWEEN THE CONTRACT DOCUMENTS AND THE BUILDING RULES, THE CONTRACTOR SHALL NOTIFY THE ARCHITECT IMMEDIATELY. BUILDING RULES AND REGULATIONS SHALL GOVERN EXCEPT WHERE THEY ARE IN CONFLICT WITH APPLICABLE CODES AND ORDINANCES.

16. THE CONTRACTOR IS TO PROVIDE A CLEAN, SAFE AND SECURE WORK SITE UNTIL THE FINAL CERTIFICATE OF OCCUPANCY OR PUNCH LIST IS COMPLETED, WHICHEVER IS LATER.

17. A COPY OF THE LATEST SET OF CONTRACT DRAWINGS, SKETCHES, ANSWERED RFI'S, AND APPROVED SUBMITTALS SHALL BE KEPT AT THE JOB SITE FOR REVIEW BY THE ARCHITECT AND AUTHORITIES HAVING JURISDICTION OVER THE PROJECT.

18. THE CONTRACTOR IS TO PROVIDE A FULL-TIME COMPETENT SUPERINTENDENT ON THE PROJECT TO COORDINATE ALL SUBCONTRACTORS' WORK AND SUPERVISE THE DAILY ACTIVITY OF THE PROJECT AS WELL AS MAINTAIN THE SITE IN A SAFE, CLEAN MANNER.

19. THE CONTRACTOR SHALL PROVIDE PROPER FIRE PROTECTION, SIGNAGE, POWER AND LIGHTING PER CODE THROUGHOUT DEMOLITION & CONSTRUCTION.

20. UNLESS NOTED OTHERWISE, THE CONTRACTOR SHALL PROVIDE ALL OF "THE WORK" INDICATED AND REFERENCED IN THE CONTRACT DOCUMENTS. IF THERE IS A CONTRADICTION BETWEEN THE SPECIFICATIONS AND THE DRAWINGS, THE GREATER SPECIFICATION SHALL PREVAIL.

21. THE CONTRACTOR SHALL BE RESPONSIBLE FOR THE DISTRIBUTION OF THE CONTRACT DOCUMENTS TO ALL TRADES AND ALERT THE ARCHITECT OF DISCREPANCES THAT IMPACT THE PROJECT OR THE SUB CONTRACTORS.

22. THE CONTRACTOR SHALL FULLY COORDINATE "THE WORK" WITH COUNTY, STATE AND FEDERAL REQUIREMENTS AS WELL AS THE OWNER, ARCHITECT, ENGINEERS, INSPECTORS AND SUB-CONTRACTORS. ALL WORK IS TO BE PERFORMED IN ACCORDANCE WITH THE RULES AND REGULATIONS OF AGENCIES HAVING JURISDICTION AND SHALL CONFORM TO ALL CITY, STATE AND FEDERAL CONSTRUCTION SAFETY AND SANITARY LAWS, CODES, STATUTES, AND ORDINANCES.

23. THE CONTRACTOR SHALL SCHEDULE ALL WORK TO CONFORM TO THE GENERAL CONSTRUCTION SCHEDULE AND SHALL COOPERATE WITH OTHER CONTRACTORS IN THE REQUIRED SEQUENTIAL INSTALLATION SCHEDULE AS APPROVED BY THE ARCHITECT.

24. THE CONTRACTOR SHALL FURNISH A CONSTRUCTION SCHEDULE TO THE OWNER AND ARCHITECT INDICATING PROJECTED COMMENCEMENT AND COMPLETION DATES FOR ALL MAJOR PHASES OF "THE WORK" AND UPDATE PROGRESS TO ALL PARTIES WEEKLY THROUGHOUT CONSTRUCTION.

25. DURING DEMOLITION AND CONSTRUCTION, THE G.C. IS RESPONSIBLE FOR MAINTAINING THE EXISTING FIRE-RATED ASSEMBLIES THAT ARE INVOLVED. THIS MEANS RESTORING THE VARIOUS ELEMENTS (I.E. SPRAYED-ON FIREPROOFING, INSULATION, SEALANT, ETC.) THAT MAY GET DISTURBED BY CONSTRUCTION ACTIVITY, BACK TO FULLY COMPLIANT STATUS.

GENERAL NOTES CONT.

26. BEFORE COMMENCING WITH ANY PORTION OF "THE WORK", THE CONTRACTOR SHALL SUBMIT TO THE OWNER OR ARCHITECT (AS AGREED UPON DURING THE CONTRACT SIGNING) SUBMITTALS, SAMPLES AND SHOP DRAWINGS FOR APPROVAL PRIOR TO THE ORDERING OF ANY MATERIALS OR PERFORMANCE OF "THE WORK". ALL ITEMS WHICH HAVE NOT BEEN APPROVED BY THE ARCHITECT, OWNER OR OWNERS REPRESENTATIVE ARE SUBJECT TO CHANGE AT NO ADDITIONAL COST TO THE OWNER.

27. VERIFY ALL EXISTING CONDITIONS AND DIMENSIONS PRIOR TO THE COMMENCEMENT OF "THE WORK". DISCOVERED CONDITIONS THAT ARE INCONSISTENT WITH THE CONTRACT DOCUMENTS SHALL BE BROUGHT TO THE ARCHITECT'S ATTENTION BY A WRITTEN RFI WITHIN TWENTY-FOUR (24) HOURS OF ITS DISCOVERY. DO NOT PROCEED WITH "THE WORK" UNTIL THE ARCHITECT RESPONDS TO THE RFI IN WRITING.

28. THE CONTRACTOR SHALL NOT PROCEED WITH ANY ADDITIONAL WORK OR CHANGES FOR WHICH THEY EXPECT ADDITIONAL COMPENSATION BEYOND THE CONTRACT AMOUNT WITHOUT WRITTEN AUTHORIZATION BY COUNTY.

29. THE ARCHITECT SHALL HAVE THE RIGHT AT ALL TIMES TO EXAMINE "THE WORK" AND DETERMINE CONFORMANCE WITH THE REQUIREMENTS AND INTENT OF THE CONTRACT DOCUMENTS AS INTERPRETED BY THE ARCHITECT.

30. REFER TO THE DRAWINGS FOR ITEMS TO BE PROVIDED BY THE OWNER, WORK BY OTHERS, AND MISCELLANEOUS OR SPECIAL REQUIREMENTS. CONTRACTOR SHALL COORDINATE AND PLAN THEIR WORK WITH OTHER TRADES TO ENSURE THAT IN PLACE WORK ACCOMMODATES ALL TRADES AND THE FINAL DESIGN.

31. CONSTRUCTION PERSONNEL MUST CARRY PROPER IDENTIFICATION AT ALL TIMES.

32. THE CONTRACTOR SHALL BE RESPONSIBLE FOR ARRANGING WITH BUILDING OWNER THE USE OF ELEVATOR OR OTHER HOISTING FACILITIES FOR HANDLING THE DELIVERY OF MATERIALS. THE CONTRACTOR SHALL BE RESPONSIBLE FOR NOTIFYING ALL SUB-TRADES OF CONDITIONS REGARDING ELEVATOR CAB SIZE, DOOR OPENING WIDTHS AND LOADING WEIGHT CAPACITIES.

33. ALL PUBLIC AREAS SUCH AS ELEVATOR LOBBIES, CORRIDORS, TOILETS, AND SERVICE HALLS SHALL BE PROTECTED TO THE SATISFACTION OF THE BUILDING OWNER. EQUIPMENT AND OTHER PROPERTY BELONGING TO THE BUILDING SHALL ALSO RECEIVE PROTECTION AND REFURBISHING IF DAMAGED IN THE COURSE OF CONSTRUCTION, TO THE SATISFACTION OF BUILDING OWNER.

34. ALL ELECTRIC HAND TOOLS MUST BE GROUNDED PROPERLY.

35. PROTECTIVE EYE GOGGLES, CONSTRUCTION HARD HATS AND PROPER CLOTHING MATERIALS MUST BE WORN DURING ANY CUTTING, WHETHER BY HAND OR BY MECHANICAL MEANS, OF FLOORS AND WALLS.

36. ALL WINDOWS SHALL BE KEPT CLOSED IN THE WORK AREAS.

37. ALL FIRE EXITS SHALL BE KEPT CLEAR AND ACCESSIBLE AT ALL TIMES.

38. FIRE EXTINGUISHERS MUST BE KEPT ON THE JOB SITE DURING CONSTRUCTION. PLUS, CONTRACTOR TO HAVE PROPER MEDICAL EMERGENCY KIT AVAILABLE AT JOB SITE PER ALL APPLICABLE CODES AND REGULATIONS.

39. DO NOT OBSTRUCT ACCESS TO EXISTING EXITS OR REDUCE WIDTH OF PUBLIC CORRIDORS.

40. PROTECT FROM DAMAGE "THE WORK" AND ALL EXISTING ADJACENT AREAS AND PROPERTIES AT THEIR EXPENSE, INCLUDING BUT NOT LIMITED TO LANDSCAPING AND EXTERIOR & INTERIOR BUILDING SURFACES

41. A MANDATORY WALK-THRU AND INSPECTION BY THE OWNER AND/OR OWNER REPRESENTATIVE SHALL OCCUR PRIOR TO CONCEALING THE FRAMING AND/OR AS DESIGNATED IN THE CONTRACT DOCUMENTS.

42. COORDINATE ALL OWNER SUPPLIED AND CONTRACTOR INSTALLED ITEMS AS WELL AS ALL OWNER PROVIDED ITEMS PRIOR TO CONCEALING THE FRAMING. THE CONTRACTOR SHALL PROVIDE ALL BLOCKING REQUIRED FOR THESE ITEMS.

43. INSTALL FIRE RETARDANT WOOD BLOCKING IN ALL NEW AND EXISTING PARTITIONS TO RECEIVE TV DISPLAYS, MILLWORK, SHELVING, WHITE BOARDS, SLAT WALL, WALL HUNG FURNITURE, ARTWORK, EQUIPMENT, SIGNAGE, AND LIGHT FIXTURE AS REQUIRED.

44. THE CONTRACTOR WILL BE RESPONSIBLE FOR ALL COSTS INCURRED FOR DAMAGES CAUSED BY THEIR SUBCONTRACTORS. INCLUDING SITE DAMAGES.

GENERAL METAL STUD FRAMING NOTES

ITEMS/SYSTEMS.

1. FORM RADIUS/CURVED WORK TO TRUE RADIUS WITHOUT SEGMENTATION, FACETING, BUCKLING, WARPING OR OTHERWISE ALTERING MEMBER DIMENSION OR APPEARANCE.

2. IN CASE OF CONFLICT OR DISCREPANCY, THE MORE RESTRICTIVE OR HIGHER QUALITY PARTITION GOVERNS.

3. AT ALL NON-FLOOR TO STRUCTURAL DECK PARTITIONS, PROVIDE DIAGONAL BRACING AT 4'-0" O.C. EXTENDING FROM 12" ABOVE CEILING TO STRUCTURAL DECK ABOVE AT 12/12 SLOPE, CONFIGURED TO CLEAR STRUCTURAL, MECHANICAL AND ELECTRICAL SYSTEMS.

4. PROVIDE FIRE-TREATED BLOCKING IN PARTITIONS FOR ALL SUPPORTED/ATTACHED

5. PROVIDE FIRE-TREATED WOOD BLOCKING IN WALLS FROM 2'-0" ABOVE FLOOR TO 4'-0" ABOVE FLOOR IN ALL ANSI A117.1 COMPLIANT TOILET STALLS.

6. CONTRACTOR TO CLEAN INSIDE OF ALL STUD CAVITIES BEFORE ENCLOSING WALL.

GENERAL DEMOLITION NOTES

1. SEE ALL DRAWINGS FOR ADDITIONAL NOTES AND SPECIFICATIONS.

2. OBJECTS SHOWN ON DEMOLITION PLANS WITH A "DASHED" LINE ARE TO BE REMOVED, AS A "SYSTEM" IN THEIR ENTIRETY BACK TO SOUND STRUCTURE. COORDINATE WITH ALL GENERAL DEMOLITION NOTES, KEYED DEMOLITION NOTES AND ALL ENGINEERING DRAWINGS.

3. THE CONTRACTOR SHALL COORDINATE ALL PHASES OF DEMOLITION FOR PROJECT AND NOTIFY THE ARCHITECT OF ANY DISCREPANCIES OR CONFLICTING CONDITIONS WHICH WOULD INTERFERE WITH THE SATISFACTORY COMPLETION OF "THE WORK", PRIOR TO THE START OF DEMOLITION.

4. THE CONTRACTOR SHALL MAINTAIN AND PROTECT EXISTING UTILITIES TO REMAIN IN SERVICE BEFORE PROCEEDING WITH DEMOLITION, PROVIDE BYPASS CONNECTIONS TO OTHER PARTS OF THE BUILDING AS REQUIRED.

5. THE CONTRACTOR SHALL MAINTAIN LIFE SAFETY SERVICES AND FIRE EXTINGUISHERS THROUGHOUT DEMOLITION PHASE AS REQUIRED.

6. THE CONTRACTOR SHALL NOTIFY ARCHITECT IMMEDIATELY IN WRITING OF ANY DISCREPANCIES IN THE DRAWINGS REGARDING THE REMOVAL OF LOAD BEARING STRUCTURAL ELEMENTS NOT DOCUMENTED OR DETAILED.

7. OWNER RESERVES THE RIGHT TO KEEP ANY ITEMS IDENTIFIED TO BE REMOVED OR SALVAGED. CONTRACTOR IS TO COORDINATE IDENTIFIED ITEMS WITH THE OWNER AT THE START OF EACH DEMOLITION PHASE. CAREFULLY SALVAGE ITEMS IDENTIFIED BY THE OWNER AND DELIVER THEM TO LOCATION INDICATED BY OWNER.

8. THE CONTRACTOR SHALL CONDUCT ALL WORK IN CONFORMANCE WITH COUNTY'S REQUIREMENTS FOR DEMOLITION AND CONSTRUCTION.

9. THE CONTRACTOR IS RESPONSIBLE TO REPAIR AND/OR REPLACE ANY DAMAGE IN THE SURROUNDING AREAS CAUSED BY DEMOLITION AND CONSTRUCTION IN" AREA OF WORK".

10. ALL EXISTING WALLS, COLUMNS, AND PERIMETER PIERS TO REMAIN IN "AREA OF WORK" ARE TO BE PATCHED AND REPAIRED TO RECEIVE NEW FINISHES.

11. ALL CONTRACTORS ARE TO COORDINATE WITH BUILDING OWNER THE USE OF ELEVATORS AND SERVICES, AND TO CONFORM TO ALL BUILDING REGULATIONS WITH REGARD TO DEMOLITION.

12. SEE ENGINEERING DRAWINGS AND NOTES FOR ADDITIONAL DEMOLITION REQUIREMENTS WHEN REFERRING TO HVAC, SPRINKLER, PLUMBING, ELECTRICAL, FIRE ALARM AND COMMUNICATION. "SYSTEM" SHALL MEAN EVERYTHING NEEDED TO SUPPORT OR TO BE PART OF "THE SYSTEM" INCLUDING BUT NOT LIMITED TO FASTENERS, POWER SUPPLY SYSTEMS, HVAC SYSTEMS, PLUMBING SYSTEMS AND ADHESIVES TO THE FULLEST EXTENT POSSIBLE.

13. DEMOLITION CONTRACTOR TO CONSULT WITH BUILDING OWNER WHEN REMOVING CONDUITS AND CABLES THAT MAY BE ACTIVE. IF SERVICE IS DISRUPTED CONTRACTOR TO PROVIDE ALL REPAIRS AS REQUIRED TO ANY CABLES AND CONDUITS.

14. ANY AND ALL ELECTRICAL/DATA AND TELEPHONE DEVICES, WIRING, CABLES, CONDUITS, ETC. TO BE REMOVED SHALL BE REVIEWED BY BUILDING OWNER, CLIENT CONSULTING ENGINEER AND ANY OTHER CONSULTANT DEEMED NECESSARY PRIOR TO ANY WORK.

15. REMOVAL OF SUCH ELECTRICAL EQUIPMENT SHALL BE DONE IN SUCH A WAY AS TO ALLOW THE OPERATIONS OF ADJACENT FLOORS TO CONTINUE WITHOUT INTERRUPTION OF ANY SERVICE DURING DEMOLITION AND CONSTRUCTION. THE CONTRACTOR SHALL TAKE ALL PRECAUTIONS NEEDED IN ORDER TO COMPLY WITH THIS REQUIREMENT.

16. ALL CONTRACTORS SHALL COORDINATE ALL REMOVALS WITH ALL OTHER TRADES.

17. CONTRACTOR SHALL PROTECT THE BUILDING INTERIOR FROM WEATHER AND WATER LEAKAGE AND DAMAGE.

18. CONTRACTOR TO PROVIDE ADEQUATE BRACING AND SUPPORTS AS REQUIRED TO ENSURE THE STRUCTURAL INTEGRITY OF THE EXISTING BUILDING TO REMAIN AS REQUIRED.

19. CAP ALL ABANDONED PIPING AND CONDUIT TO PREVENT POSSIBLE PASSAGEWAYS FOR RODENTS, FIRE, OR GASES. COORDINATE WORK WITH ALL TRADES.

20. ALL ABANDONED POKE THROUGHS IN THE SLAB SHALL BE PATCHED AND FILLED PER STANDARDS AS STATED IN THE BUILDING RULES AND REGULATIONS, AND PER ALL LOCAL CODES.

21. FILL ALL UNUSED SLAB PENETRATIONS WITH PROPER STRUCTURAL AND FIRE RATED

REQUIREMENTS.

22. ALL LAYERS OF FLOOR FINISHES SCHEDULED FOR REMOVAL SHALL BE REMOVED DOWN TO BASE SUB-FLOOR. ALL SUB-FLOORING SCHEDULED TO RECEIVE FLOORING SHALL BE STRIPPED OF ALL SEALANTS, MASTICS, GREASE, AND PAINT. NOTIFY ARCHITECT PRIOR TO REMOVAL TO ADDRESS BEST PRACTICE TO MOVE FORWARD.

23. REPAIR AND PATCH ALL SURFACES DAMAGED BY "THE WORK" TO MATCH AND TO BLEND INTO THE EXISTING ADJACENT SURFACE MATERIALS AND FINISHES, FLUSH AND SMOOTH. FOLLOWING THE PROCEDURES OF THE PROJECT MANUAL.

THE PROCEDURES OF THE PROJECT MANUAL.

24. PROVIDE BLOCKING OR SHORING AS REQUIRED TO SUPPORT BUILDING SYSTEMS PRIOR TO

DEMOLITION OF MASONRY OR NON - MASONRY BEARING WALLS OR SUPPORT STRUCTURES AS REQUIRED.

25. THE CONTRACTOR TO REMOVE ANY AND ALL DOORS, FRAMES AND HARDWARE IN THE EFFECTED AREAS. CONTRACTOR SHALL CONSULT WITH BUILDING OWNER FOR ANY DOORS/FRAMES OR HARDWARE THAT THE OWNER MIGHT WANT TO REUSE.

26. THE CONTRACTOR SHALL MAINTAIN A SAFE, SECURE AND CLEAN SITE IN ACCORDANCE WITH LOCAL, STATE AND FEDERAL REGULATIONS THROUGHOUT THE ENTIRETY OF "THE WORK", AT NO ADDITIONAL COST TO THE OWNER. AT A MINIMUM THE SITE IS TO BE SECURELY LOCKED WHEN UNOCCUPIED AND BROOM SWEPT ON A DAILY BASIS AND SAFE OF LOOSE DEBRIS.

27. THE CONTRACTOR IS RESPONSIBLE FOR DEMOLITION AND REMOVAL OF ALL DEBRIS AND DISCARDED MATERIALS AND/OR EQUIPMENT AS INDICATED WITHIN THE SPACE. THE CONTRACTOR MUST KEEP ALL DEBRIS REMOVED FROM SITE SEPARATE FROM THE BUILDING TRASH AND PROVIDE DUMPSTERS THROUGH OUT CONSTRUCTION UNTIL PROJECT CLOSEOUT. LOCATE DUMPSTERS IN THE LOCATION DESIGNATED BY THE OWNER. PROMPTLY REPLACE DUMPSTERS WHEN THEY ARE FULL AND WHEN "THE WORK" HAS BEEN COMPLETED.

28. THE CONTRACTOR TO COORDINATE WITH THE BUILDING OWNER AS TO THE PROTECTION AND/OR STORAGE OF ANY ITEMS TO BE SAVED FROM DEMOLITION.

29. THE CONTRACTOR IS RESPONSIBLE TO PROTECT ALL EXISTING ITEMS TO REMAIN (I.E. PLUMBING FIXTURES, WINDOWS. CONVECTOR COVERS' WALLS, CEILINGS, FLOORS, WINDOW TREATMENTS, AND EXPOSED FINISHES, ETC.) THROUGHOUT THE COURSE OF THE JOB AND REPAIR DAMAGE AS REQUIRED.

30. ASBESTOS NOTE: ANY ITEMS ENCOUNTERED IN THE DEMOLITION SUSPECTED OF CONTAINING HAZARDOUS MATERIALS SHALL BE BROUGHT TO THE OWNERS ATTENTION, FOR PROPER IDENTIFICATION AND DISPOSAL OF BY THE OWNERS DESIGNATED FORCES.

31. LEAD PAINT NOTE: DURING DEMOLITION, THE CONTRACTOR MUST BRING ANY MATERIALS SUSPECTED OF OCNTAINING LEAD PAINT TO THE COUNTY'S ATTENTION IMMEDIATELY FOR PROPER IDENTIFICATION AND DIRECTION OF FURTHER WORK. THE CONTRACTOR SHALL FOLLOW LOCAL, STATE AND FEDERAL CODES ON RECOMMENDATIONS FOR REMOVAL.

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SUNY SCCC ELSTON HALL
LOBBY & MOHAWK ROOM
RENOVATIONS

78 Washington Ave Schenectady, NY 12305

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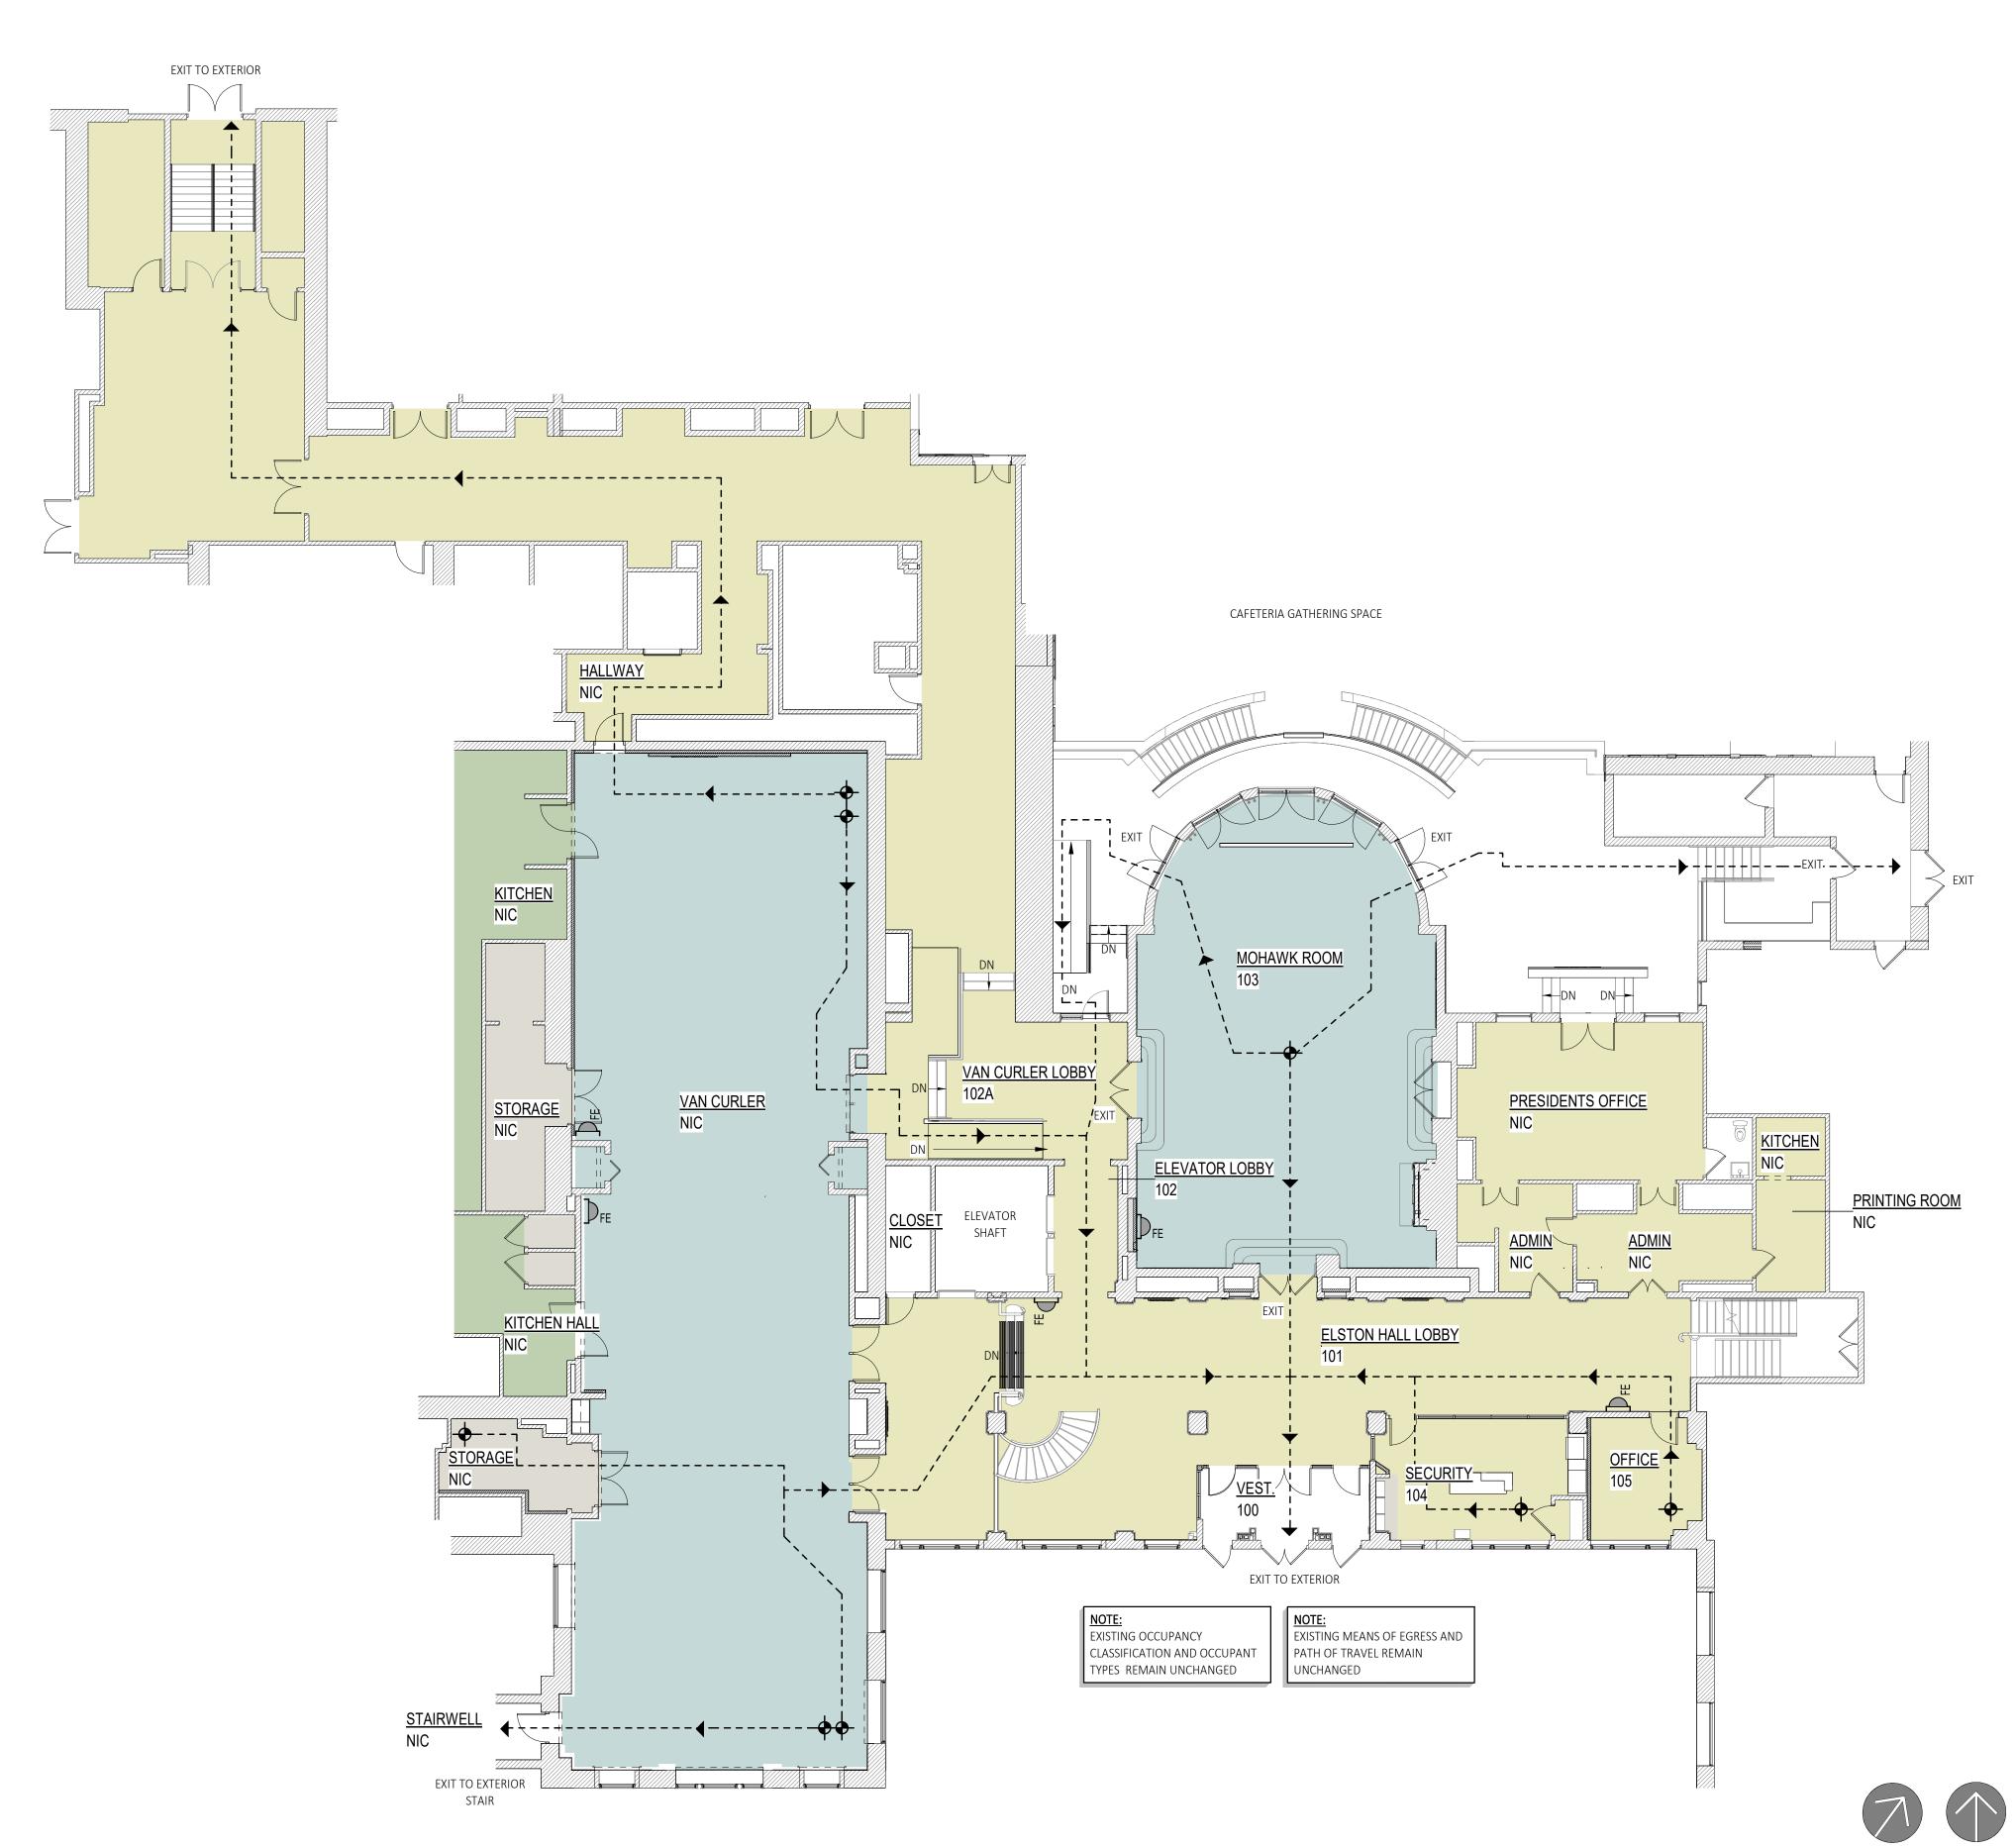
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GENERAL NOTES

Sheet Number:

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Additional Code Provisions

- 1. THROUGH-PENETRATION FIRESTOP SYSTEM REQUIREMENTS: THROUGH-PENETRATIONS OF
- 1. FIRE-RESISTANCE RATED WALL ASSEMBLIES SHALL BE PROTECTED BY AN APPROVED
- THROUGH-PENETRATION FIRESTOP SYSTEM, WITH AN F RATING OF NOT LESS THAN 1-HOUR,
 INSTALLED AND TESTED IN ACCORDANCE WITH ASTM E 814-2006 or UL 1476-2003, WITH A
- 4. MINIMUM POSITIVE PRESSURE DIFFERENTIAL OF 0.01 INCH OF WATER.
- 2. THERMAL AND SOUND INSULATING MATERIALS: ALL INSULATING MATERIALS SHALL HAVE A FLAME SPREAD INDEX OF NOT MORE THAN 25 AND A SMOKE-DEVELOPED INDEX OF NOT MORE THAN 450 WHEN TESTED IN ACCORDANCE WITH ASTM E 84-2007 or UL 723-2003.
- 3. FIRE EXTINGUISHERS SHALL BE MOUNTED 42" MAXIMUM A.F.F. SEE LIFE SAFETY PLAN FOR EXTINGUISHER LOCATIONS, EXISTING FIRE EXTINGUISHER LOCATIONS ARE TO BE MAINTAINED. PRESERVE AND PROTECT FIRE EXTINGUISHERS DURING THE WORK
- 4. COMBUSTIBLE MATERIAL SHALL BE PERMITTED IN BUILDINGS OF TYPE I OR TYPE II CONSTRUCTION PER 2020 NYSBC 603.1:
- 1. MILLWORK SUCH AS DOOR,S DOOR FRAMES, WINDOW SASHES AND FRAMES
- 2. INTERIOR WALL AND CEILING FINISHES INSTALLED PER IBC SECTIONS 801 & 803
- 3. TRIM INSTALLED IN ACCORDANCE WITH IBC 802
- 4. BLOCKING SUCH AS HANDRAILS, MILLWORK AND CABINETS

5. PLYWOOD AND MDF SUBSTRATES SHALL BE FIRE TREATED

5. SPRAYED FIRE RESISTIVE MATERIALS

ASSEMBLY AREA (15 NEW TABLES AND CHAIRS) BUSINESS AREA TRAVEL DISTANCE START POINT STORAGE / MECHANICAL AREAS (300 SF) KITCHEN AREA



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SUNY SCCC ELSTON HALL LOBBY & MOHAWK ROOM RENOVATIONS

78 Washington Ave Schenectady, NY 12305

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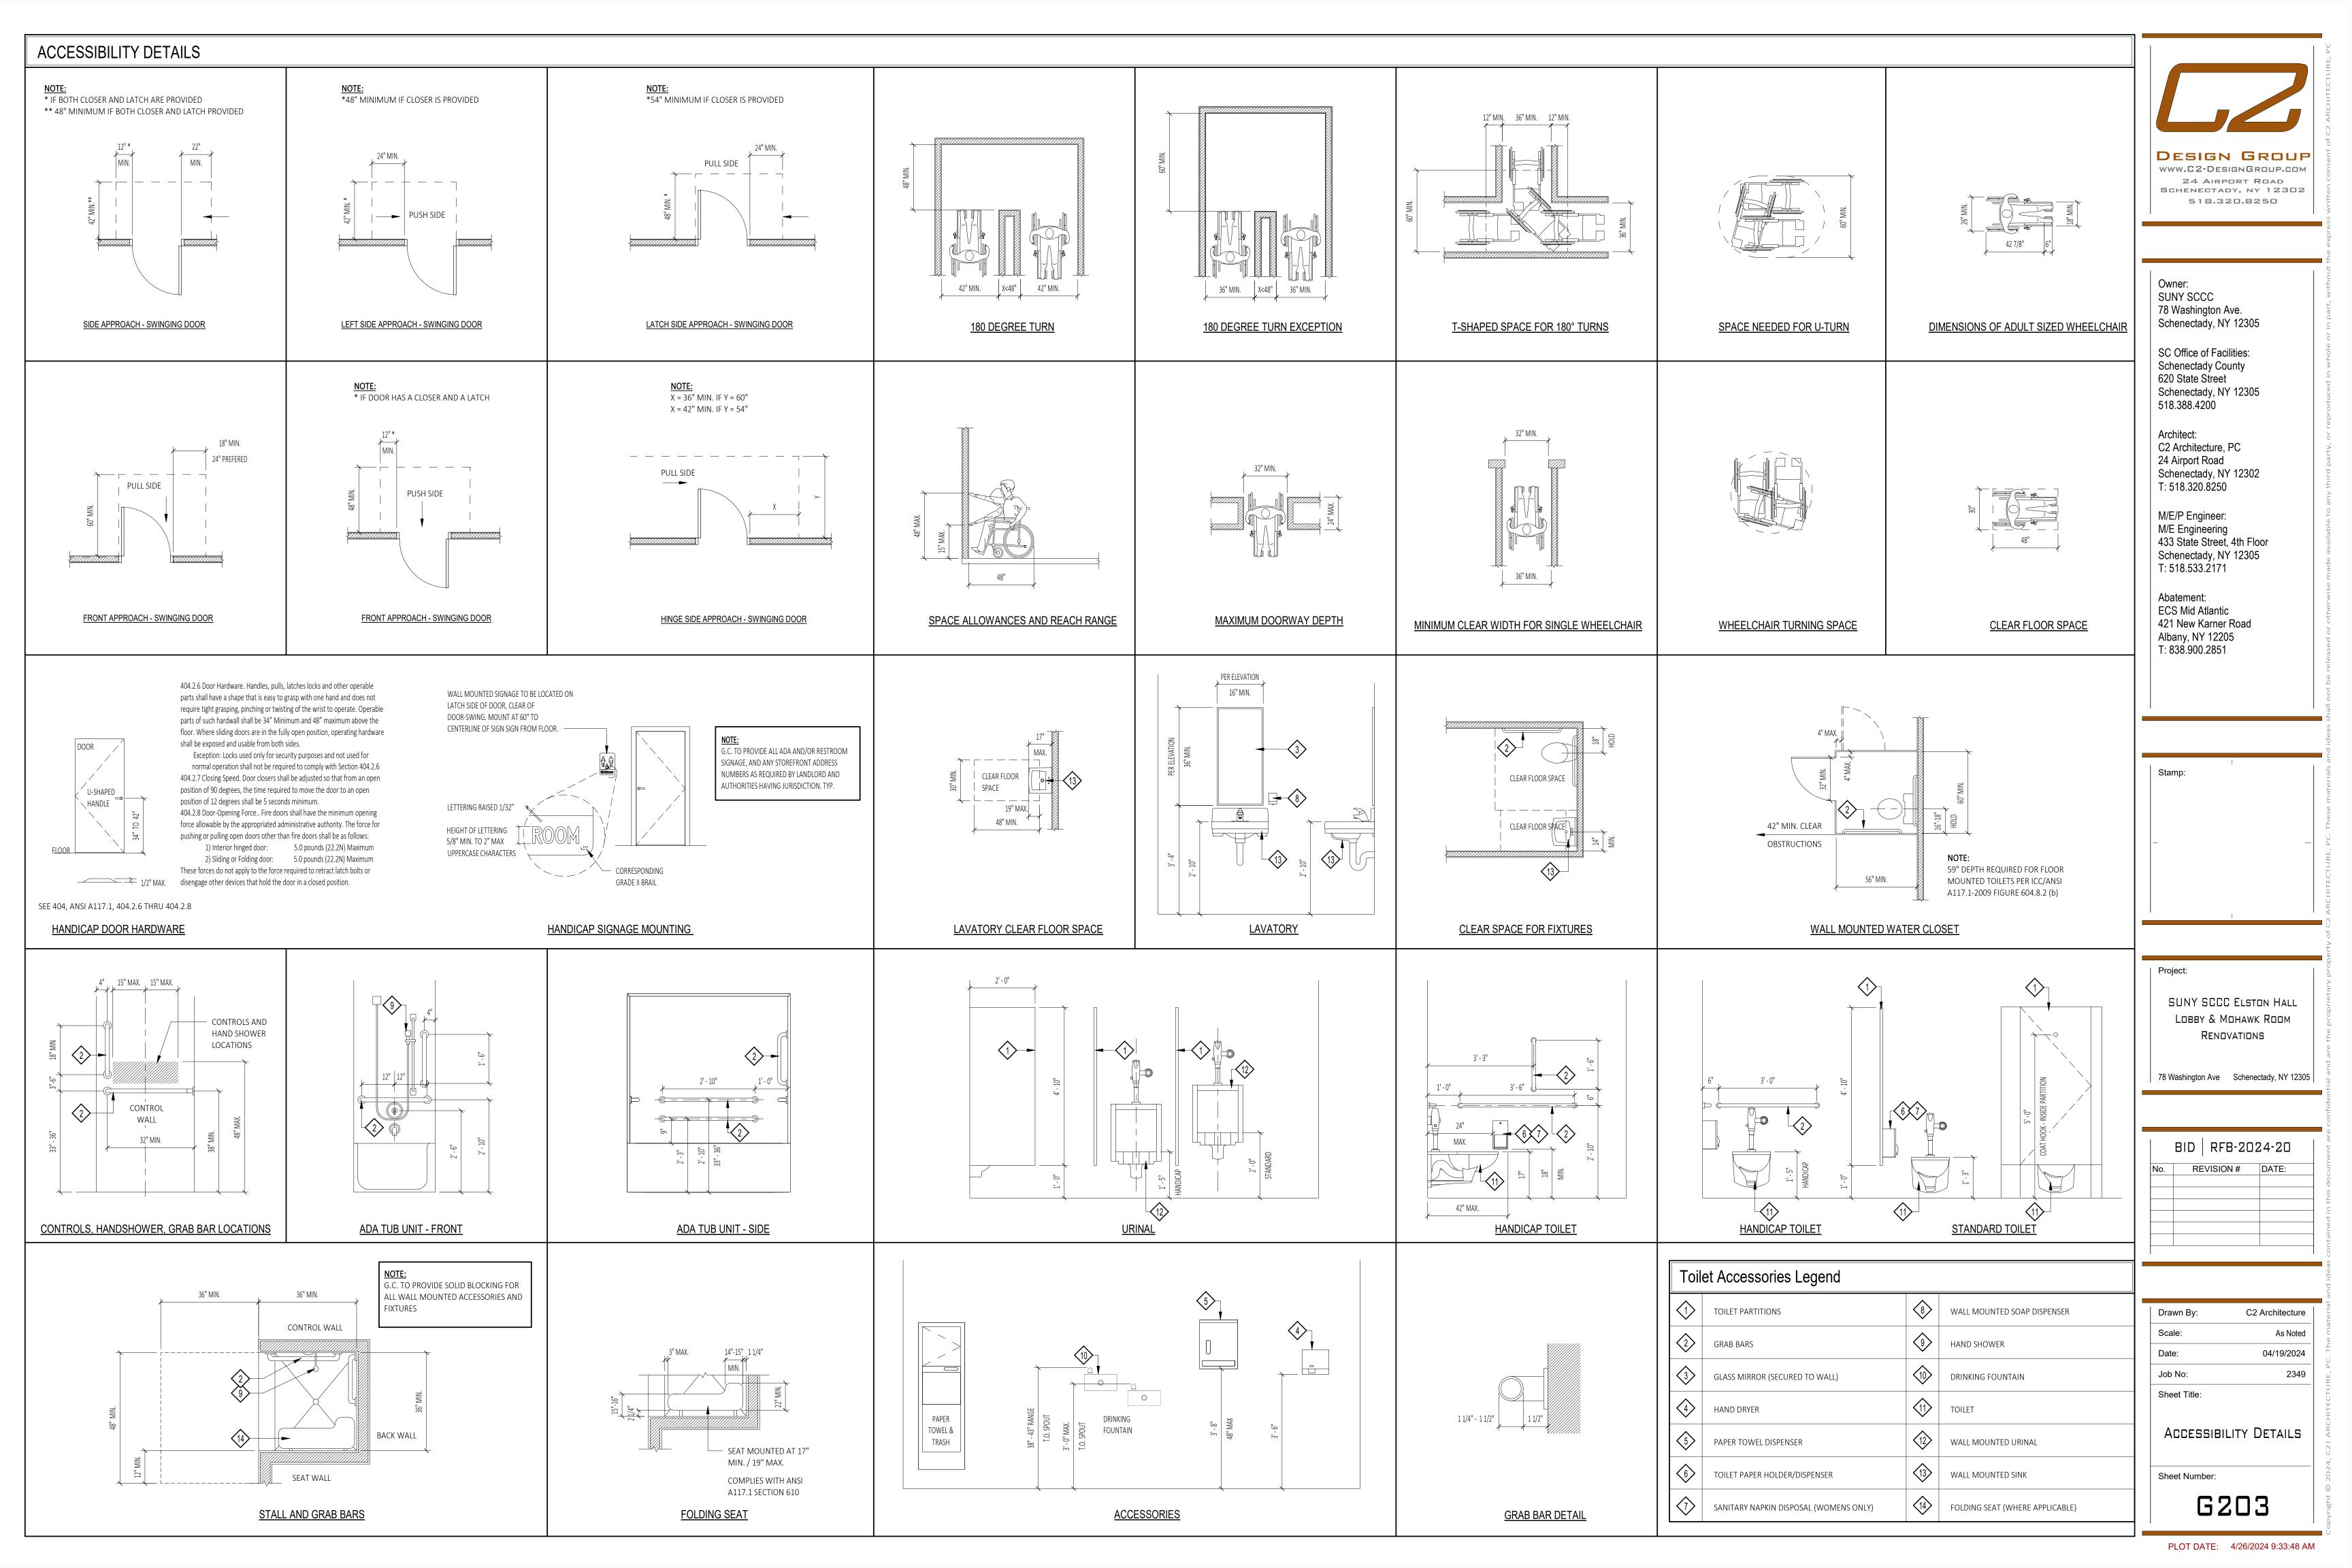
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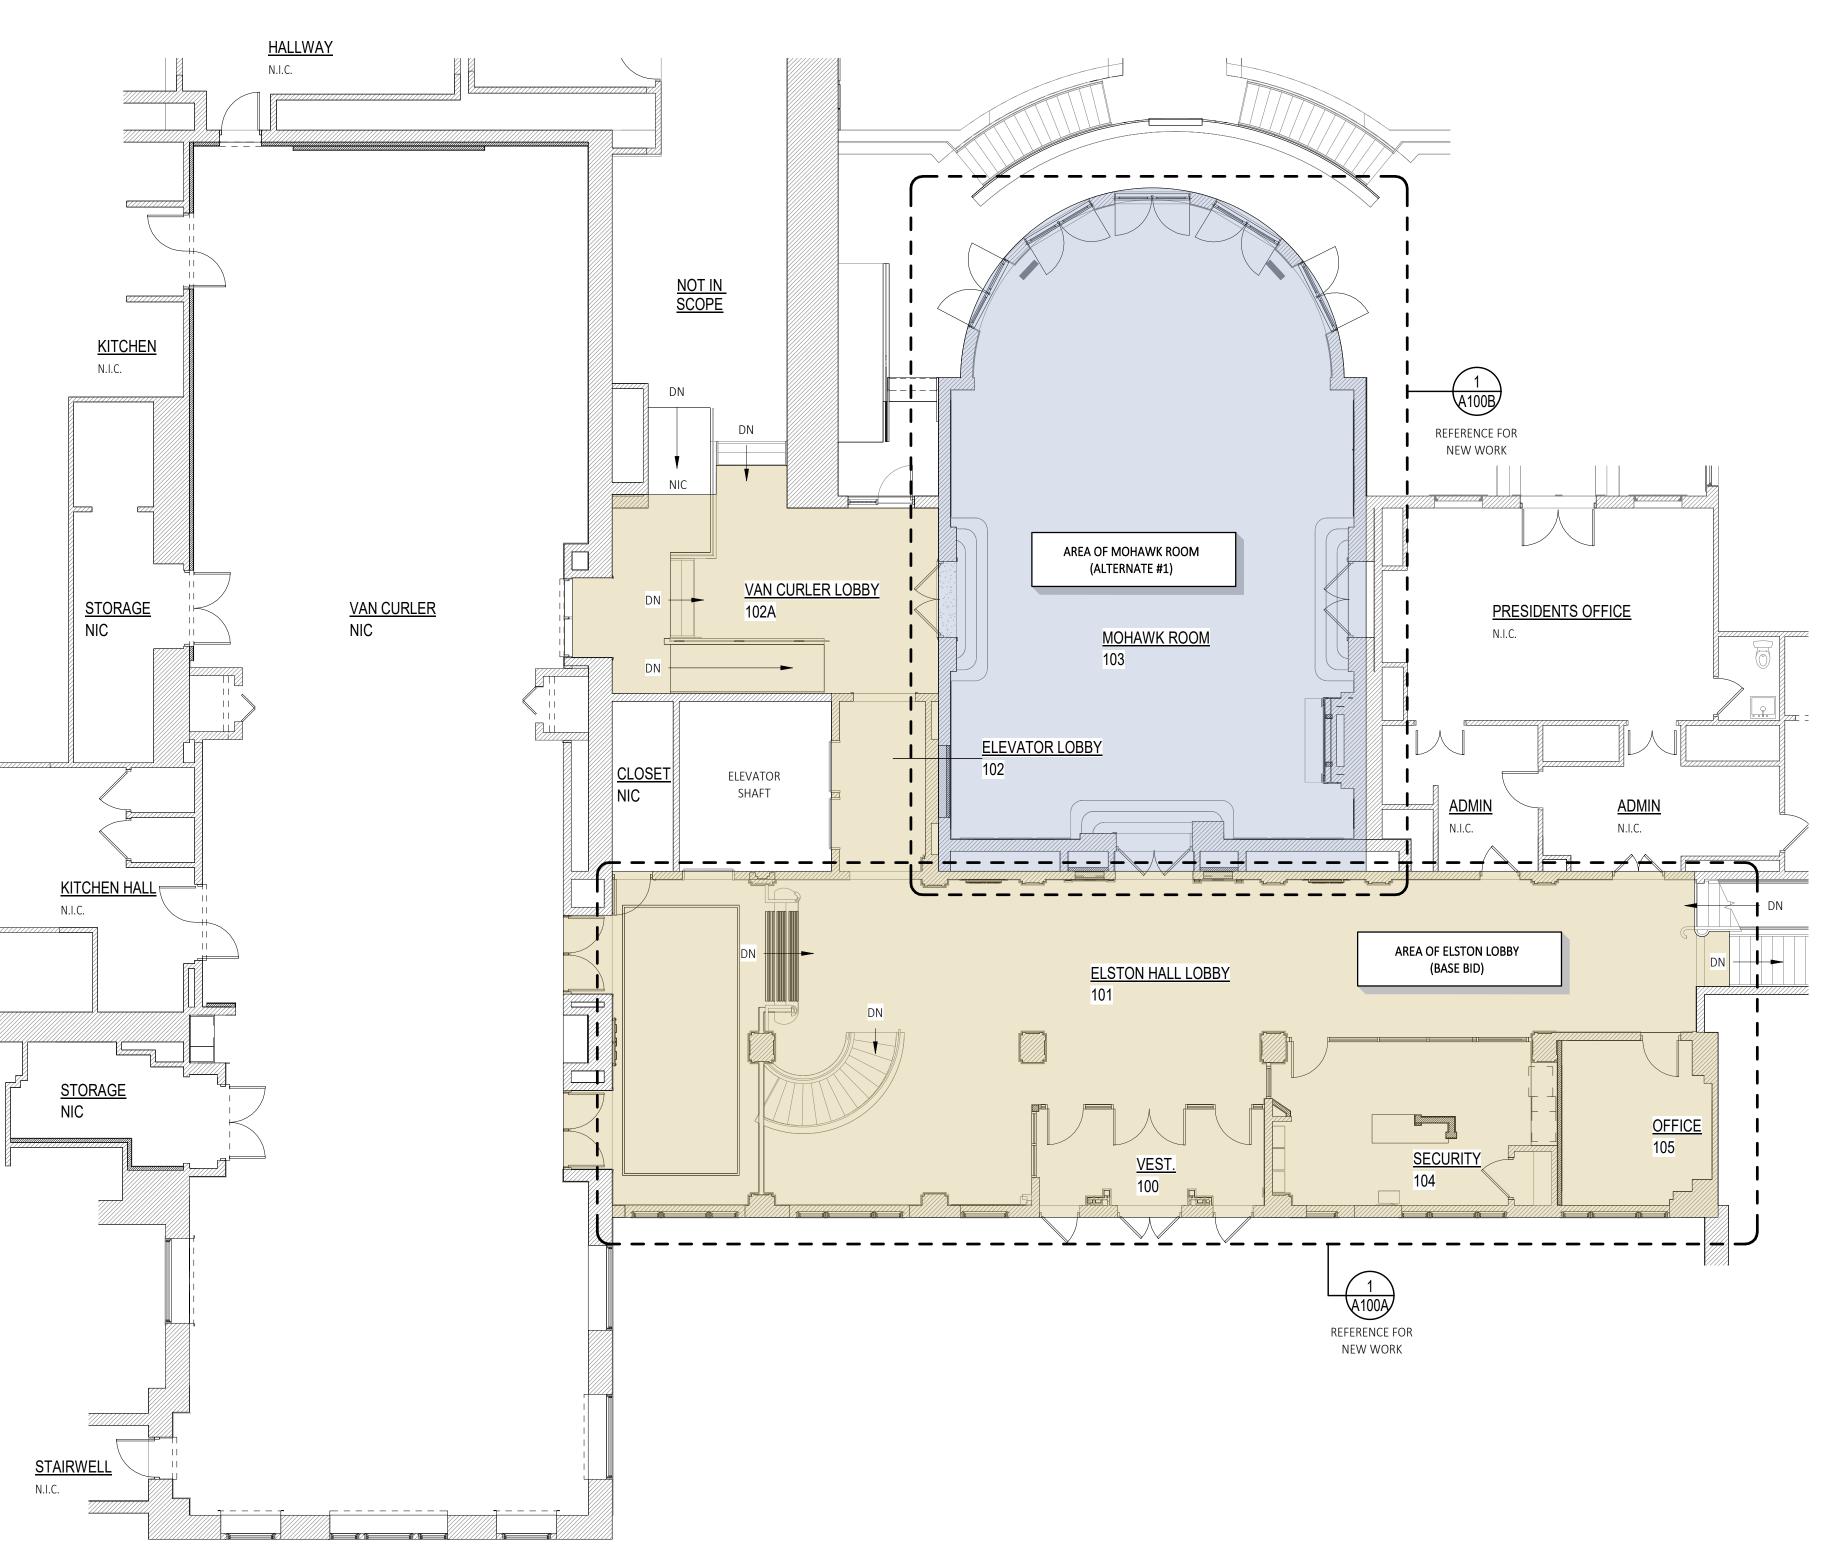
ELSTON HALL 1st LEVEL
LIFE SAFETY PLAN

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G200

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Floor Plan - Room Key





TRUE NORTH



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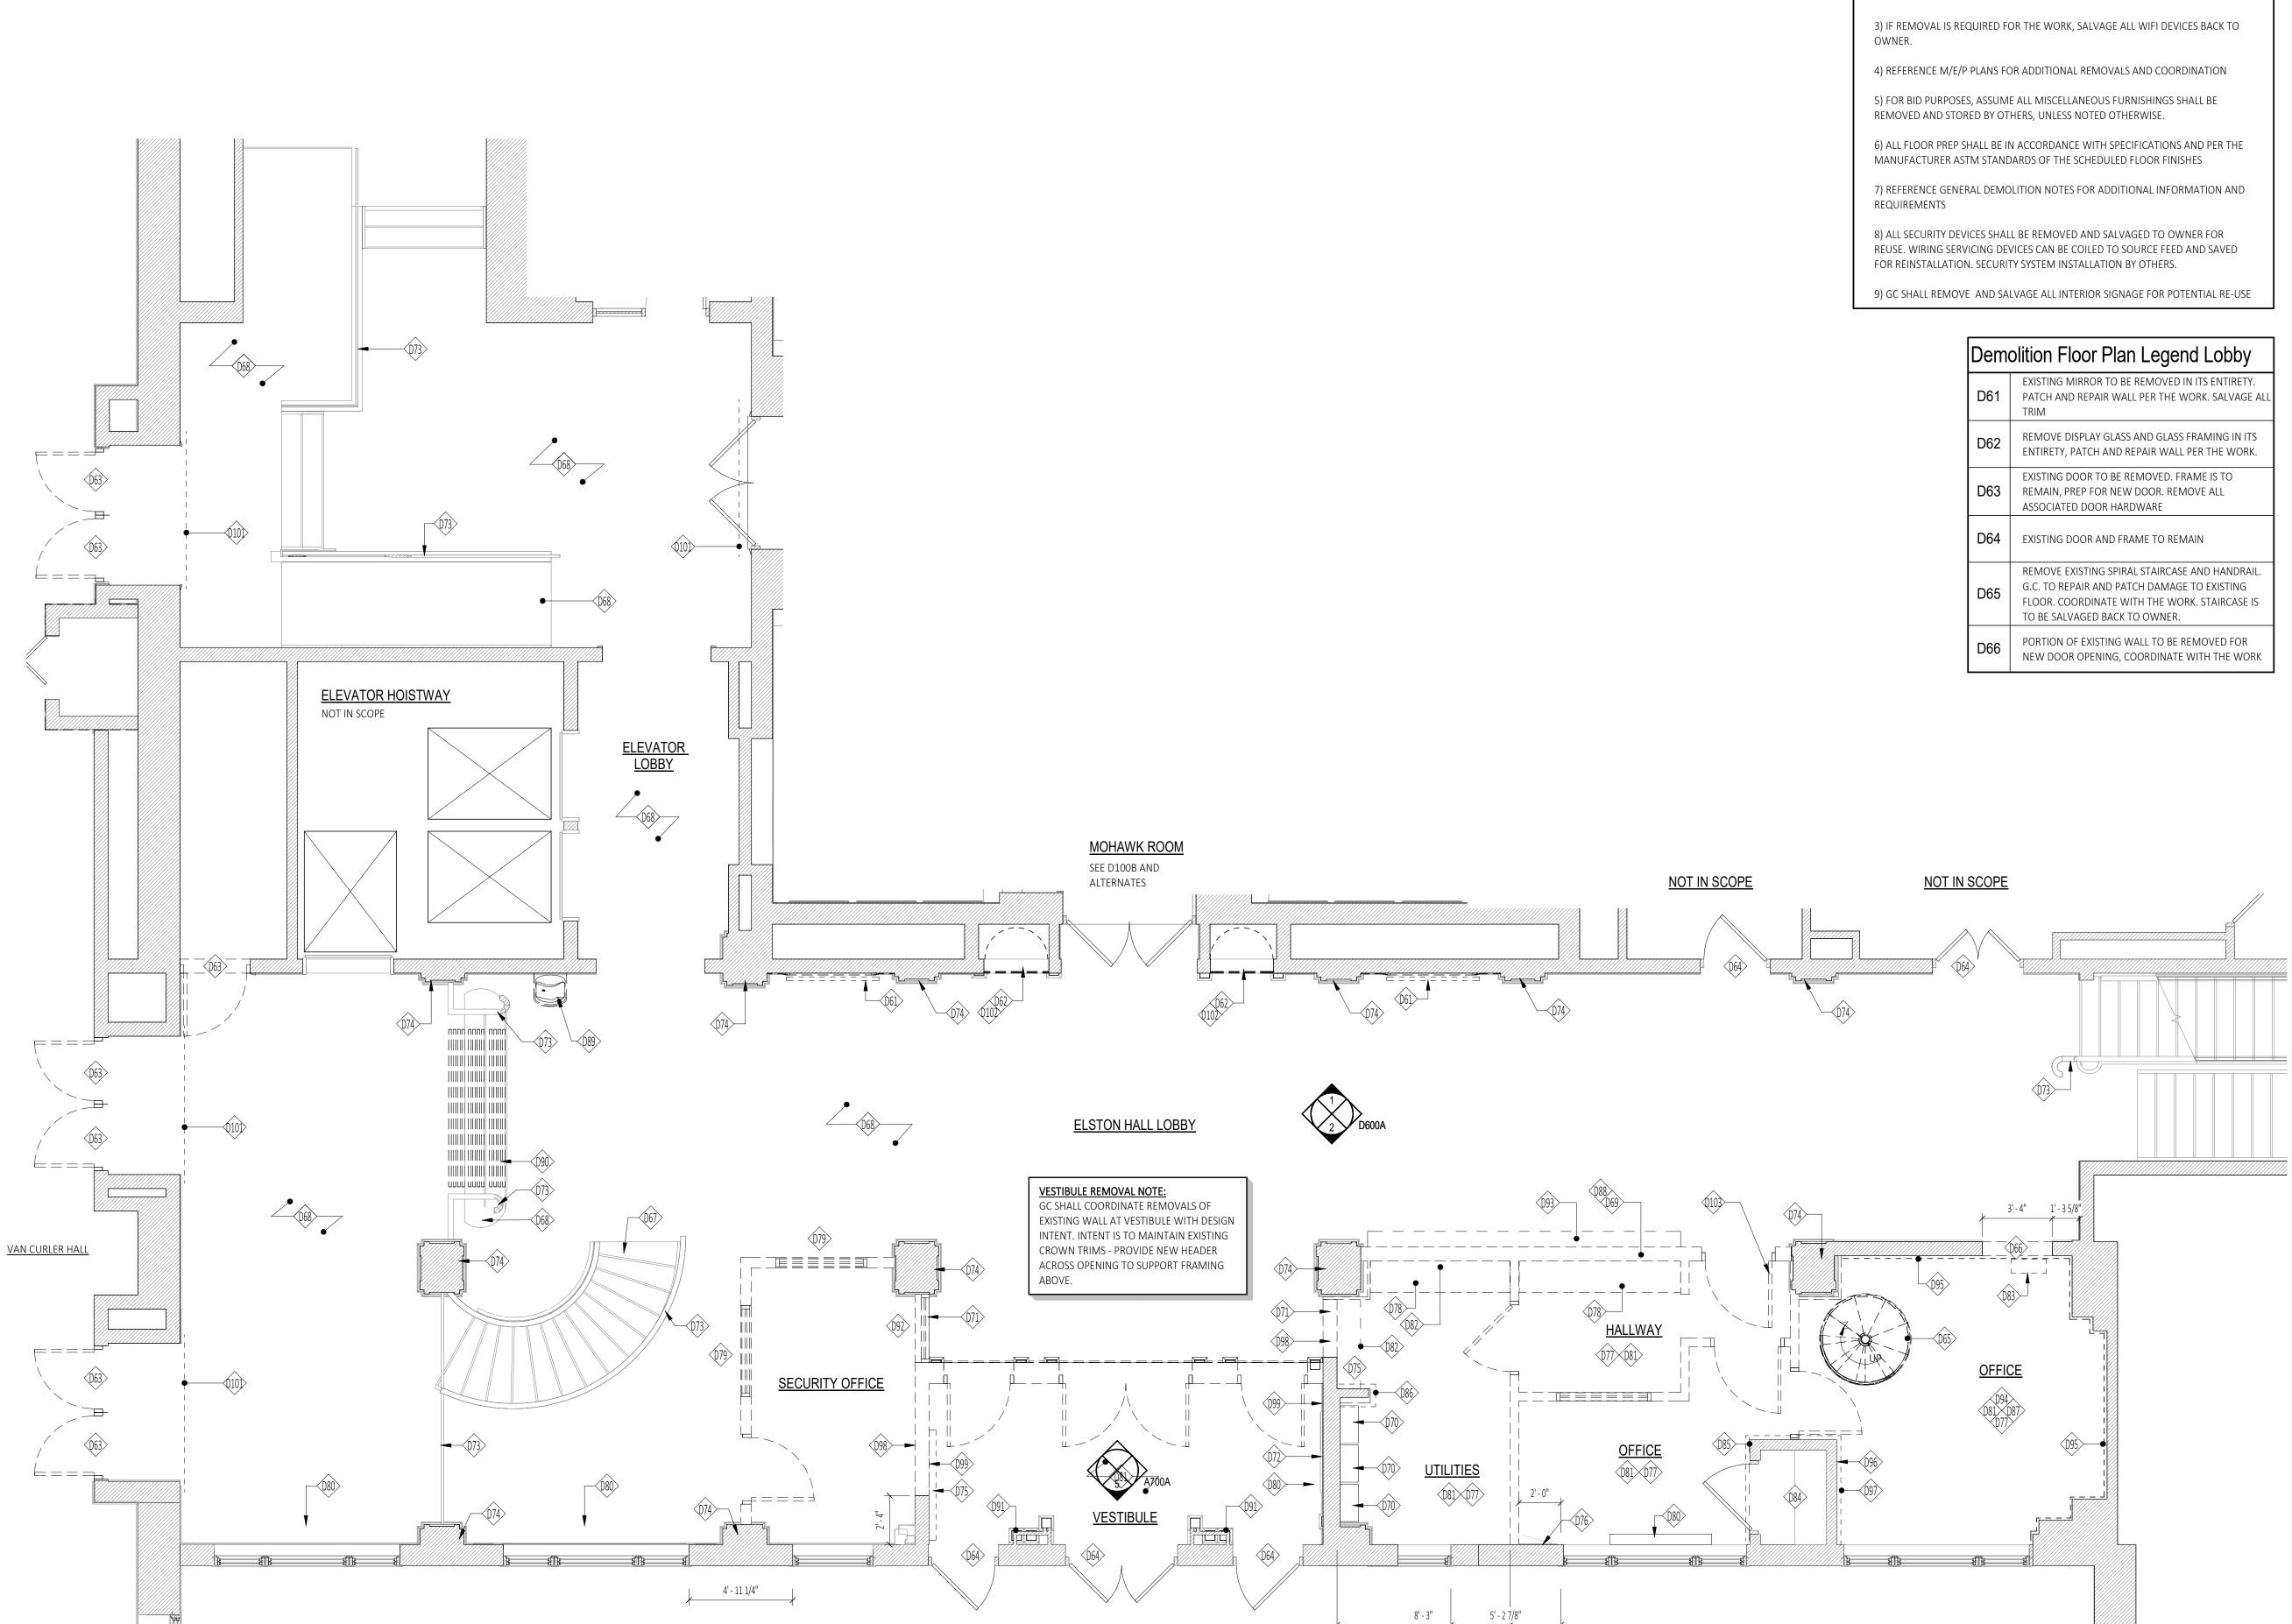
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1) ALL REMOVALS SHALL BE COORDINATED WITH THE OVERALL SCOPE OF WORK. ANY REMOVAL REQUIRED TO ALLOW THE DESIGN INTENT AND SCOPE OF WORK TO BE COMPLETED SHALL BE PART OF THE BID, WITH NO ADDITIONAL COST TO THE

2) REMOVE ALL EXISTING DRAPERIES, CURTAINS AND CURTAIN RODS. SALVAGE TO

COORDINATE ELECTRICAL REMOVALS WITH ELECTRICAL D85 | SCOPE OF WORK. INTENT IS TO REMOVE SURFACE

MAINTAIN PIPING AT WALL. COORDINATE WITH THE

Demolition Floor Plan Legend Lobby

EXISTING FLOORING TO REMAIN, SEE FINISH NOTES

REMOVE PORTION OF EXISTING WALL AS SHOWN BY

THE DASHED LINES. COORDINATE WITH THE WORK. SEE

EXISTING FIRE ALARM, ELECTRICAL PANEL AND OTHER

PARTIAL WALL REMOVAL COORD. THE WORK. SEE

MAINTAIN EXISTING PLAQUE - PROTECT THROUGHOUT

EXISTING HANDRAIL TO REMAIN. G.C. TO PROTECT

EXISTING COLUMN ENLCOSURE TO REMAIN, G.C TO

REMOVE ALL EXISTING VINYL FLOOR BASE. MAINTAIN

REMOVE EXISTING COUNTER AND/OR BASE CABINETS

REMOVE EXISTING SECUIRTY OFFICE ENCLOSURE IN ITS

EXISTING WALL HEATER TO BE REPLACED -

COORDINATE WITH MEP SCOPE OF WORK

REMOVE EXISTING WALL MOUNTED SHELVES.

REMOVE EXISTING FLOORING FINISH TO EXISTING SUBBASE (ASSUMED TERRAZZO)IN THIS ROOM. PREP

SURFACE AS REQUIRED TO RECEIVE SCHEDULED FINISH.

REMOVE EXISTING KEY BOX AND SALVAGE TO OWNER

D70 UTILITY EQUIPMENT TO REMAIN. G.C. TO PROTECT

D71 DEMOLITION ELEVATIONS. MANTAIN BASE ALONG

D67 EXISTING STAIR TO BASEMENT TO REMAIN

FOR TERRAZZO WORK

DEMOLITION ELEVATIONS

WHILE CONSTRUCTION.

COLUMN ENCLOSURE

DURING CONSTRUCTION.

PROTECT DURING DEMOLITION

D75 REMOVE WALL HEATER IN ITS ENTIRETY

D76 EXISTING ELECTRICAL PANEL TO REMAIN

ALL EXISTING WOOD BASE

IN THEIR ENTIRETY

FOR POTENTIAL REUSE.

D84 EXISTING SAFE TO REMAIN

MOUNTED CONDUIT

CONSTURCTION

D87 REMOVE ALL ABANDONED EQUIPMENT ON MEZZANINE

IN THIER ENTIRETY

WALL.REFERENCE PLUMBING/MECHANICAL DRAWINGS

EXISTING STEEL BULKHEAD FRAMING IN THIS WALL TO BE REMOVED AS PART OF WALL REMOVAL REMOVE EXISTING DRINKING FOUNTAIN. G.C. TO PATCH AND REPAIR DAMAGE TO EXISTING

FOR MORE INFORMATION REMOVE EXISTING TREAD METAL STRIPS. CLEAN AND

PREP SURFACE TO RECEIVE SCHEDULED GRIT STRIPS EXISTING DECORATIVE COLUMN AND TRIM TO

REMAIN, G.C. TO PROTECT DURING CONSTRUCTION REMOVE EXISTING VISION PANEL AND FRAME IN ITS

ENTIRETY. COORDINATE WITH THE WORK. REMOVE EXISTING GRANITE COUNTER. COORDINATE

WITH THE WORK. REMOVE EXISTING MEZZANINE STRUCTURE ABOVE IN ITS ENTIRETY. G.C. TO REPAIR AND PATCH DAMAGE TO EXISTING PERIMETER WALLS. COORDINATE WITH THE WORK.

REMOVE EXISTING WALL PANELING SYSTEM BACK TO EXISTING PLASTER WALL. CLEAN AND PREP PLASTER WALL TO RECEIVE SCHEDULED FINISH.

COORDINATE "CAT" SYSTEM REMOVAL WITH OVERALL MECHANICAL SCOPE

REMOVE ALL EXISTING MOULDING AND BASE TRIM FROM EXISTING SAFE ENCLOSURE REMOVE BASE, SALVAGE AND PROTECT FOR RE-USE

D99 REMOVE WAINSCOT TRIM

(EACH SIDE OF WALL)

D101 | REMOVE EXISTING SIGNAGE - SALVAGE TO OWNER EXSTING DISPLAY ALCOVE TO BE REMOVE COORDINATE LIGHTING AND ELECTRICAL REMOVAL WITH

ELECTRICAL CONTRACTOR SALVAGE EXISTING DOOR HARDWARE AND FRAME TO







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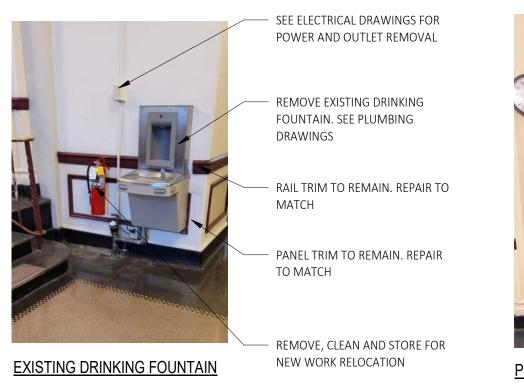
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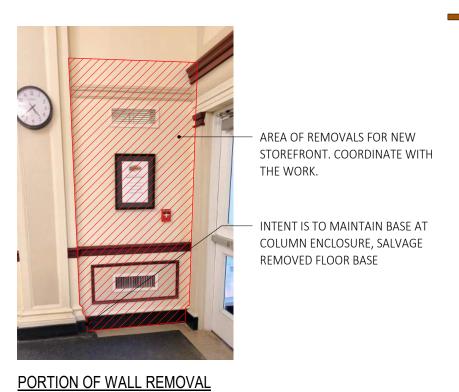
DEMOLITION PLAN


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Demolition Plan - Elston Hall Lobby









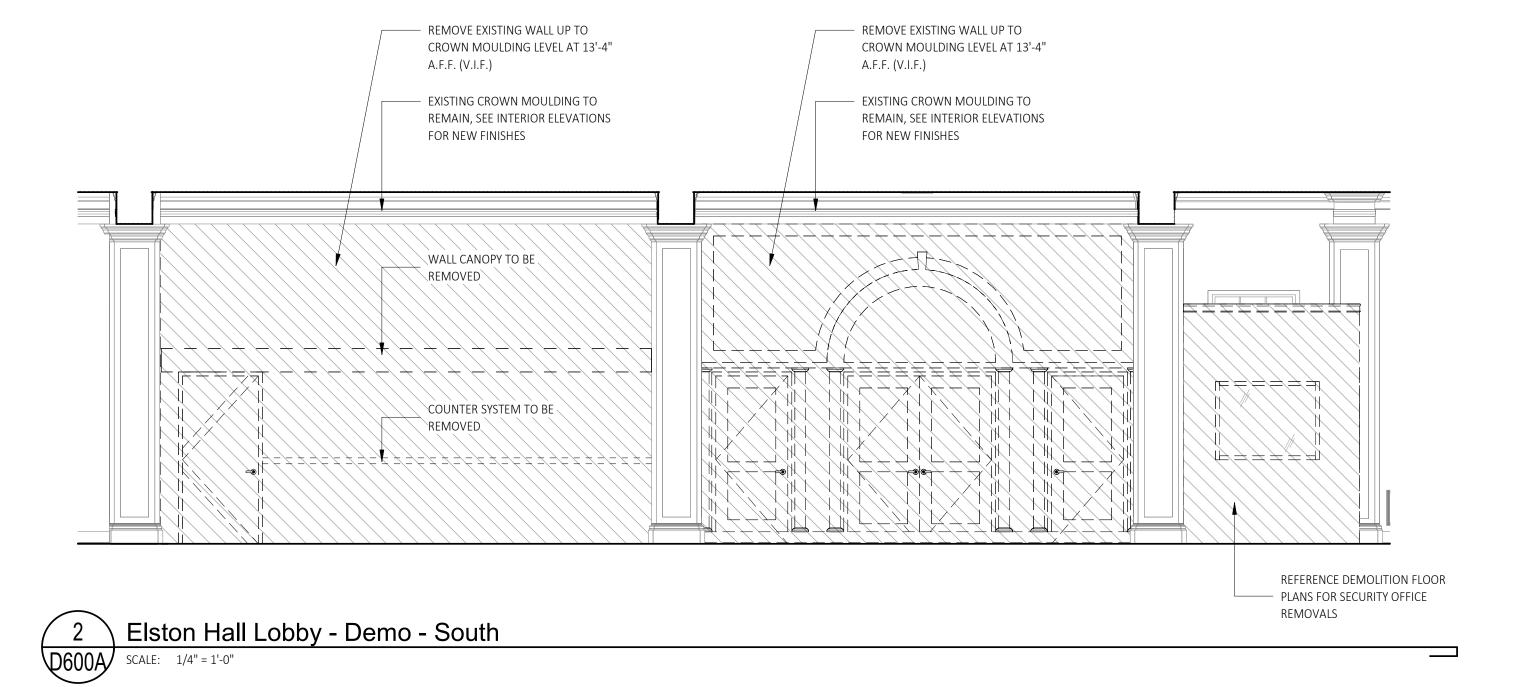



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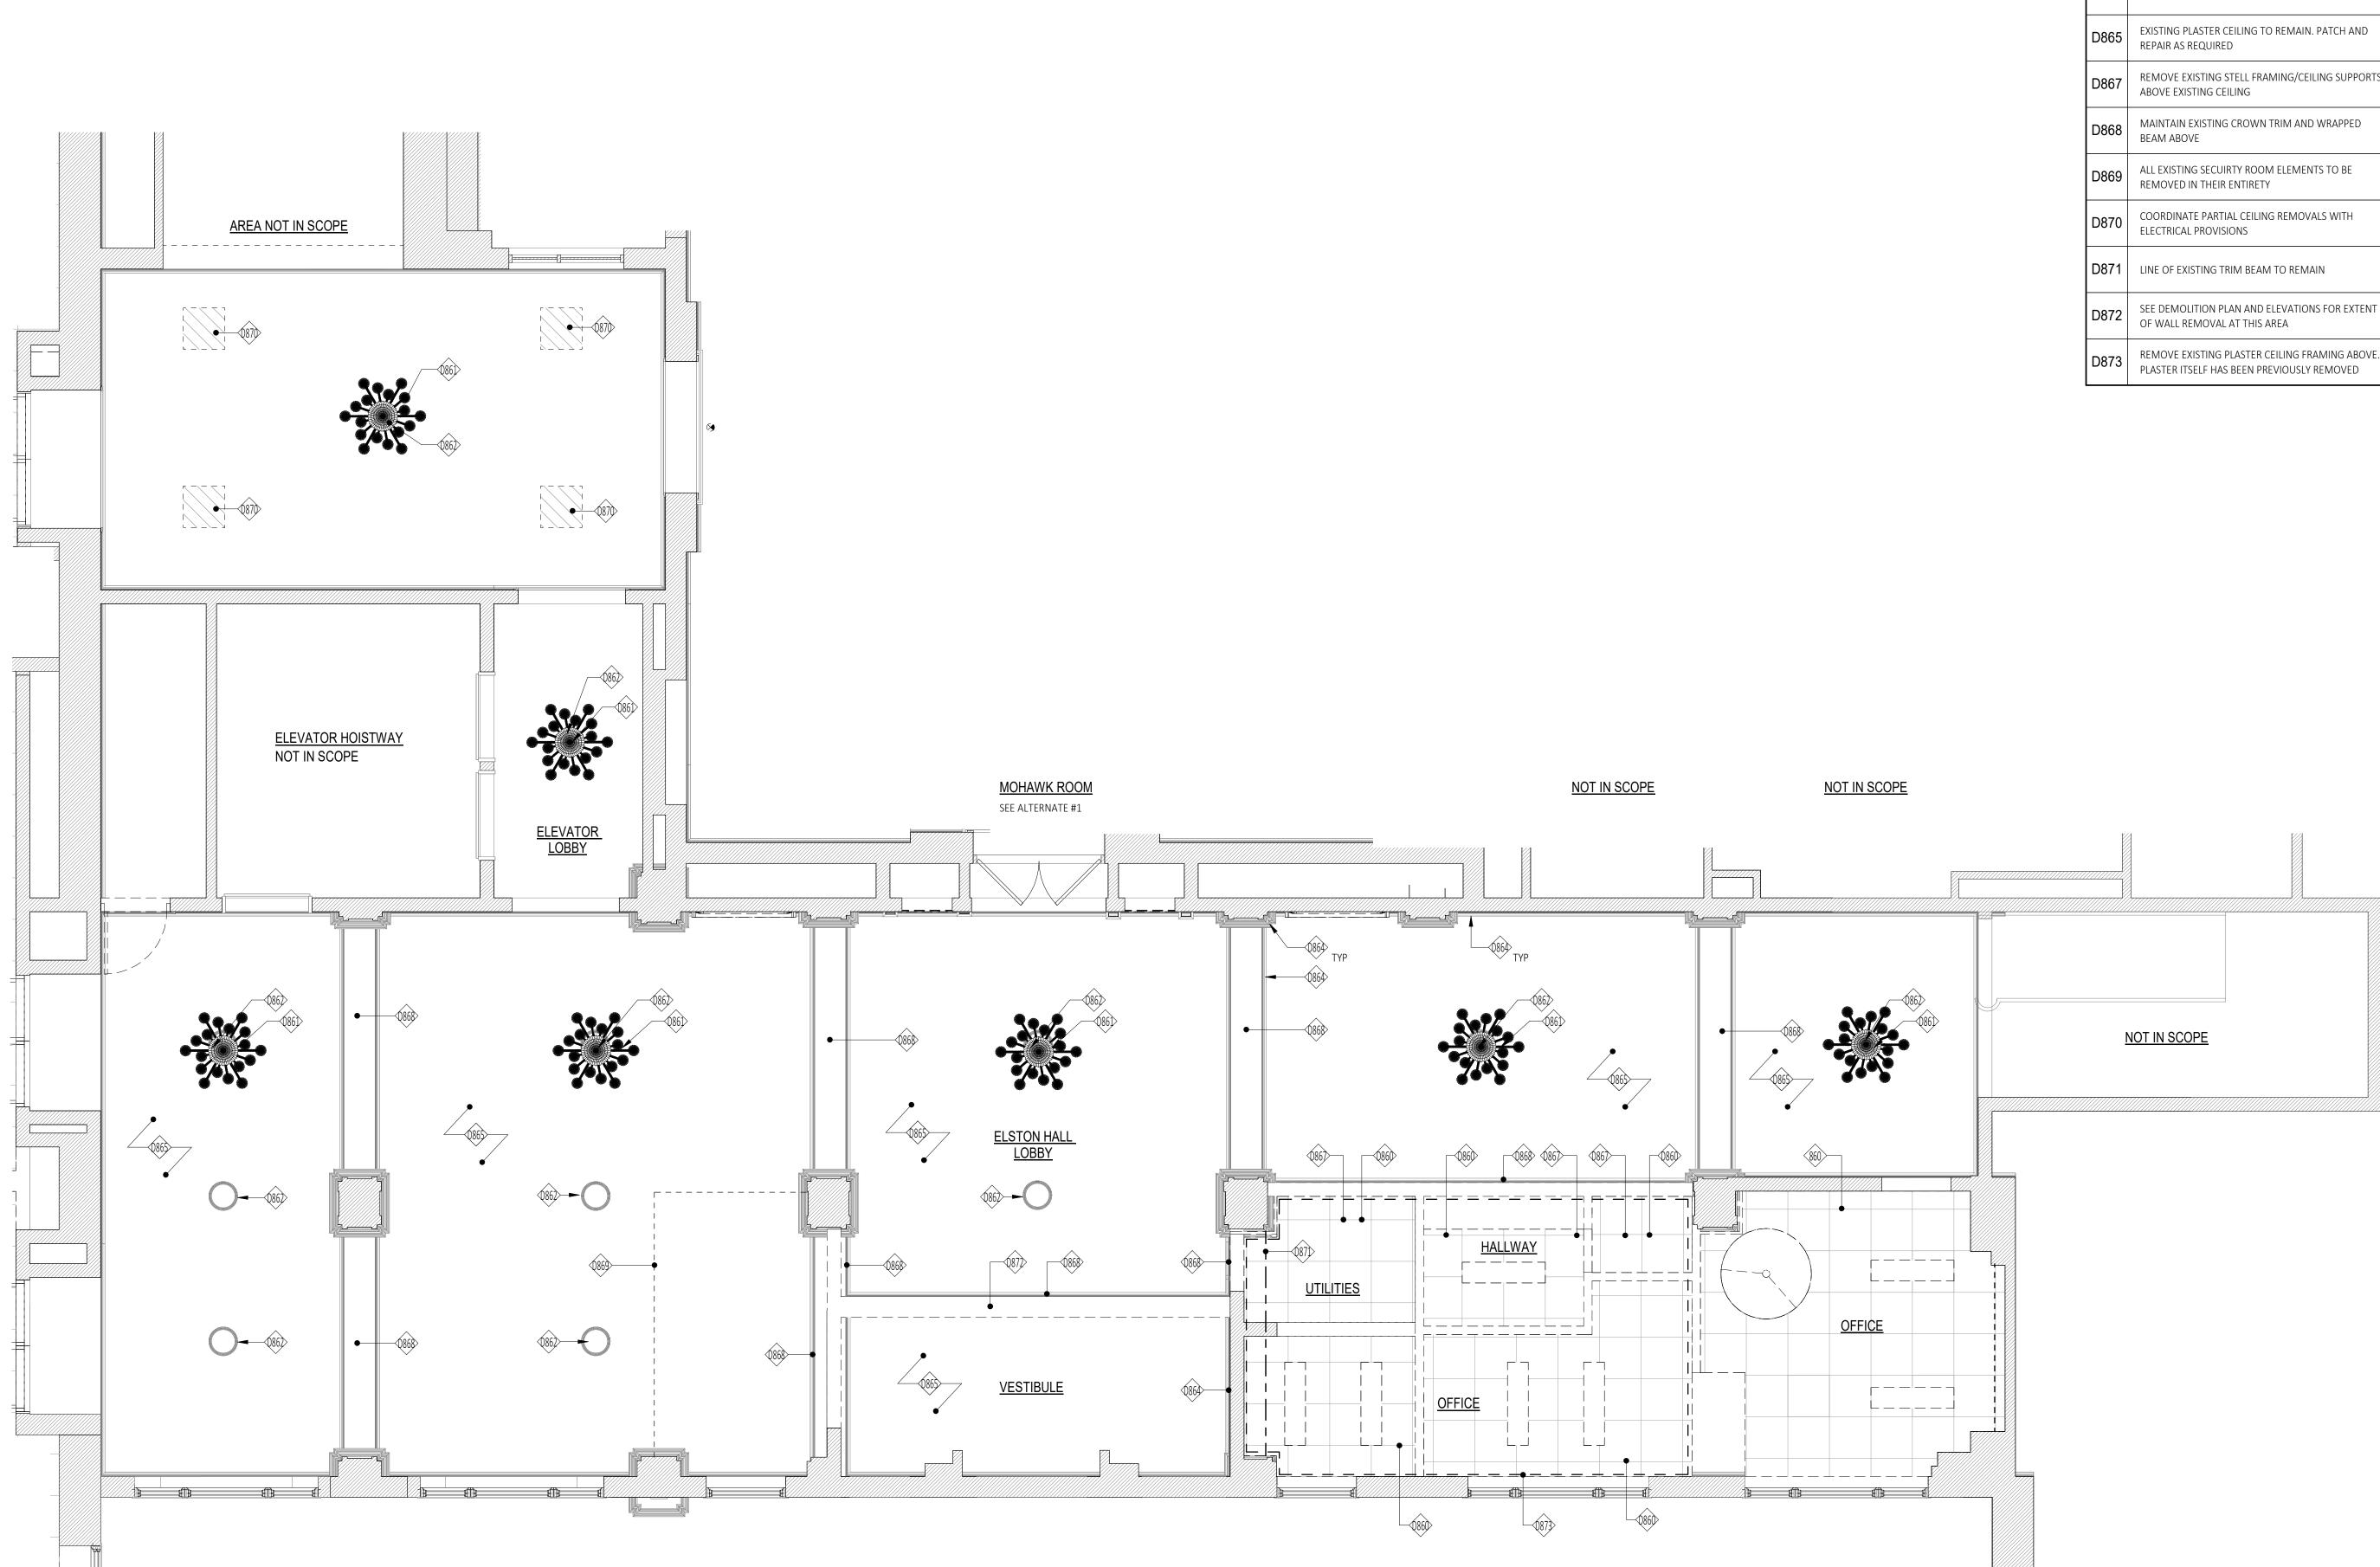
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	all Lobby n Details

D600A

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Elston Hall Lobby Ceiling Demolition Plan

Van Curler RCP Demolition Legend REMOVE EXISTING CEILING SYSTEM AND LIGHT D860 FIXTURES IN THEIR ENTIRETY. COORDINATE ELECTRICAL REMOVALS WITH THE WORK REMOVE EXISTING CHANDELIER. COORDINATE ELECTRICAL WITH THE WORK EXISTING CEILING MEDALLION TO REMAIN, PRESERVE DURING CHANDELIER REMOVALS D864 EXISTING CROWN MOULDING TO REMAIN, TYP REMOVE EXISTING STELL FRAMING/CEILING SUPPORTS

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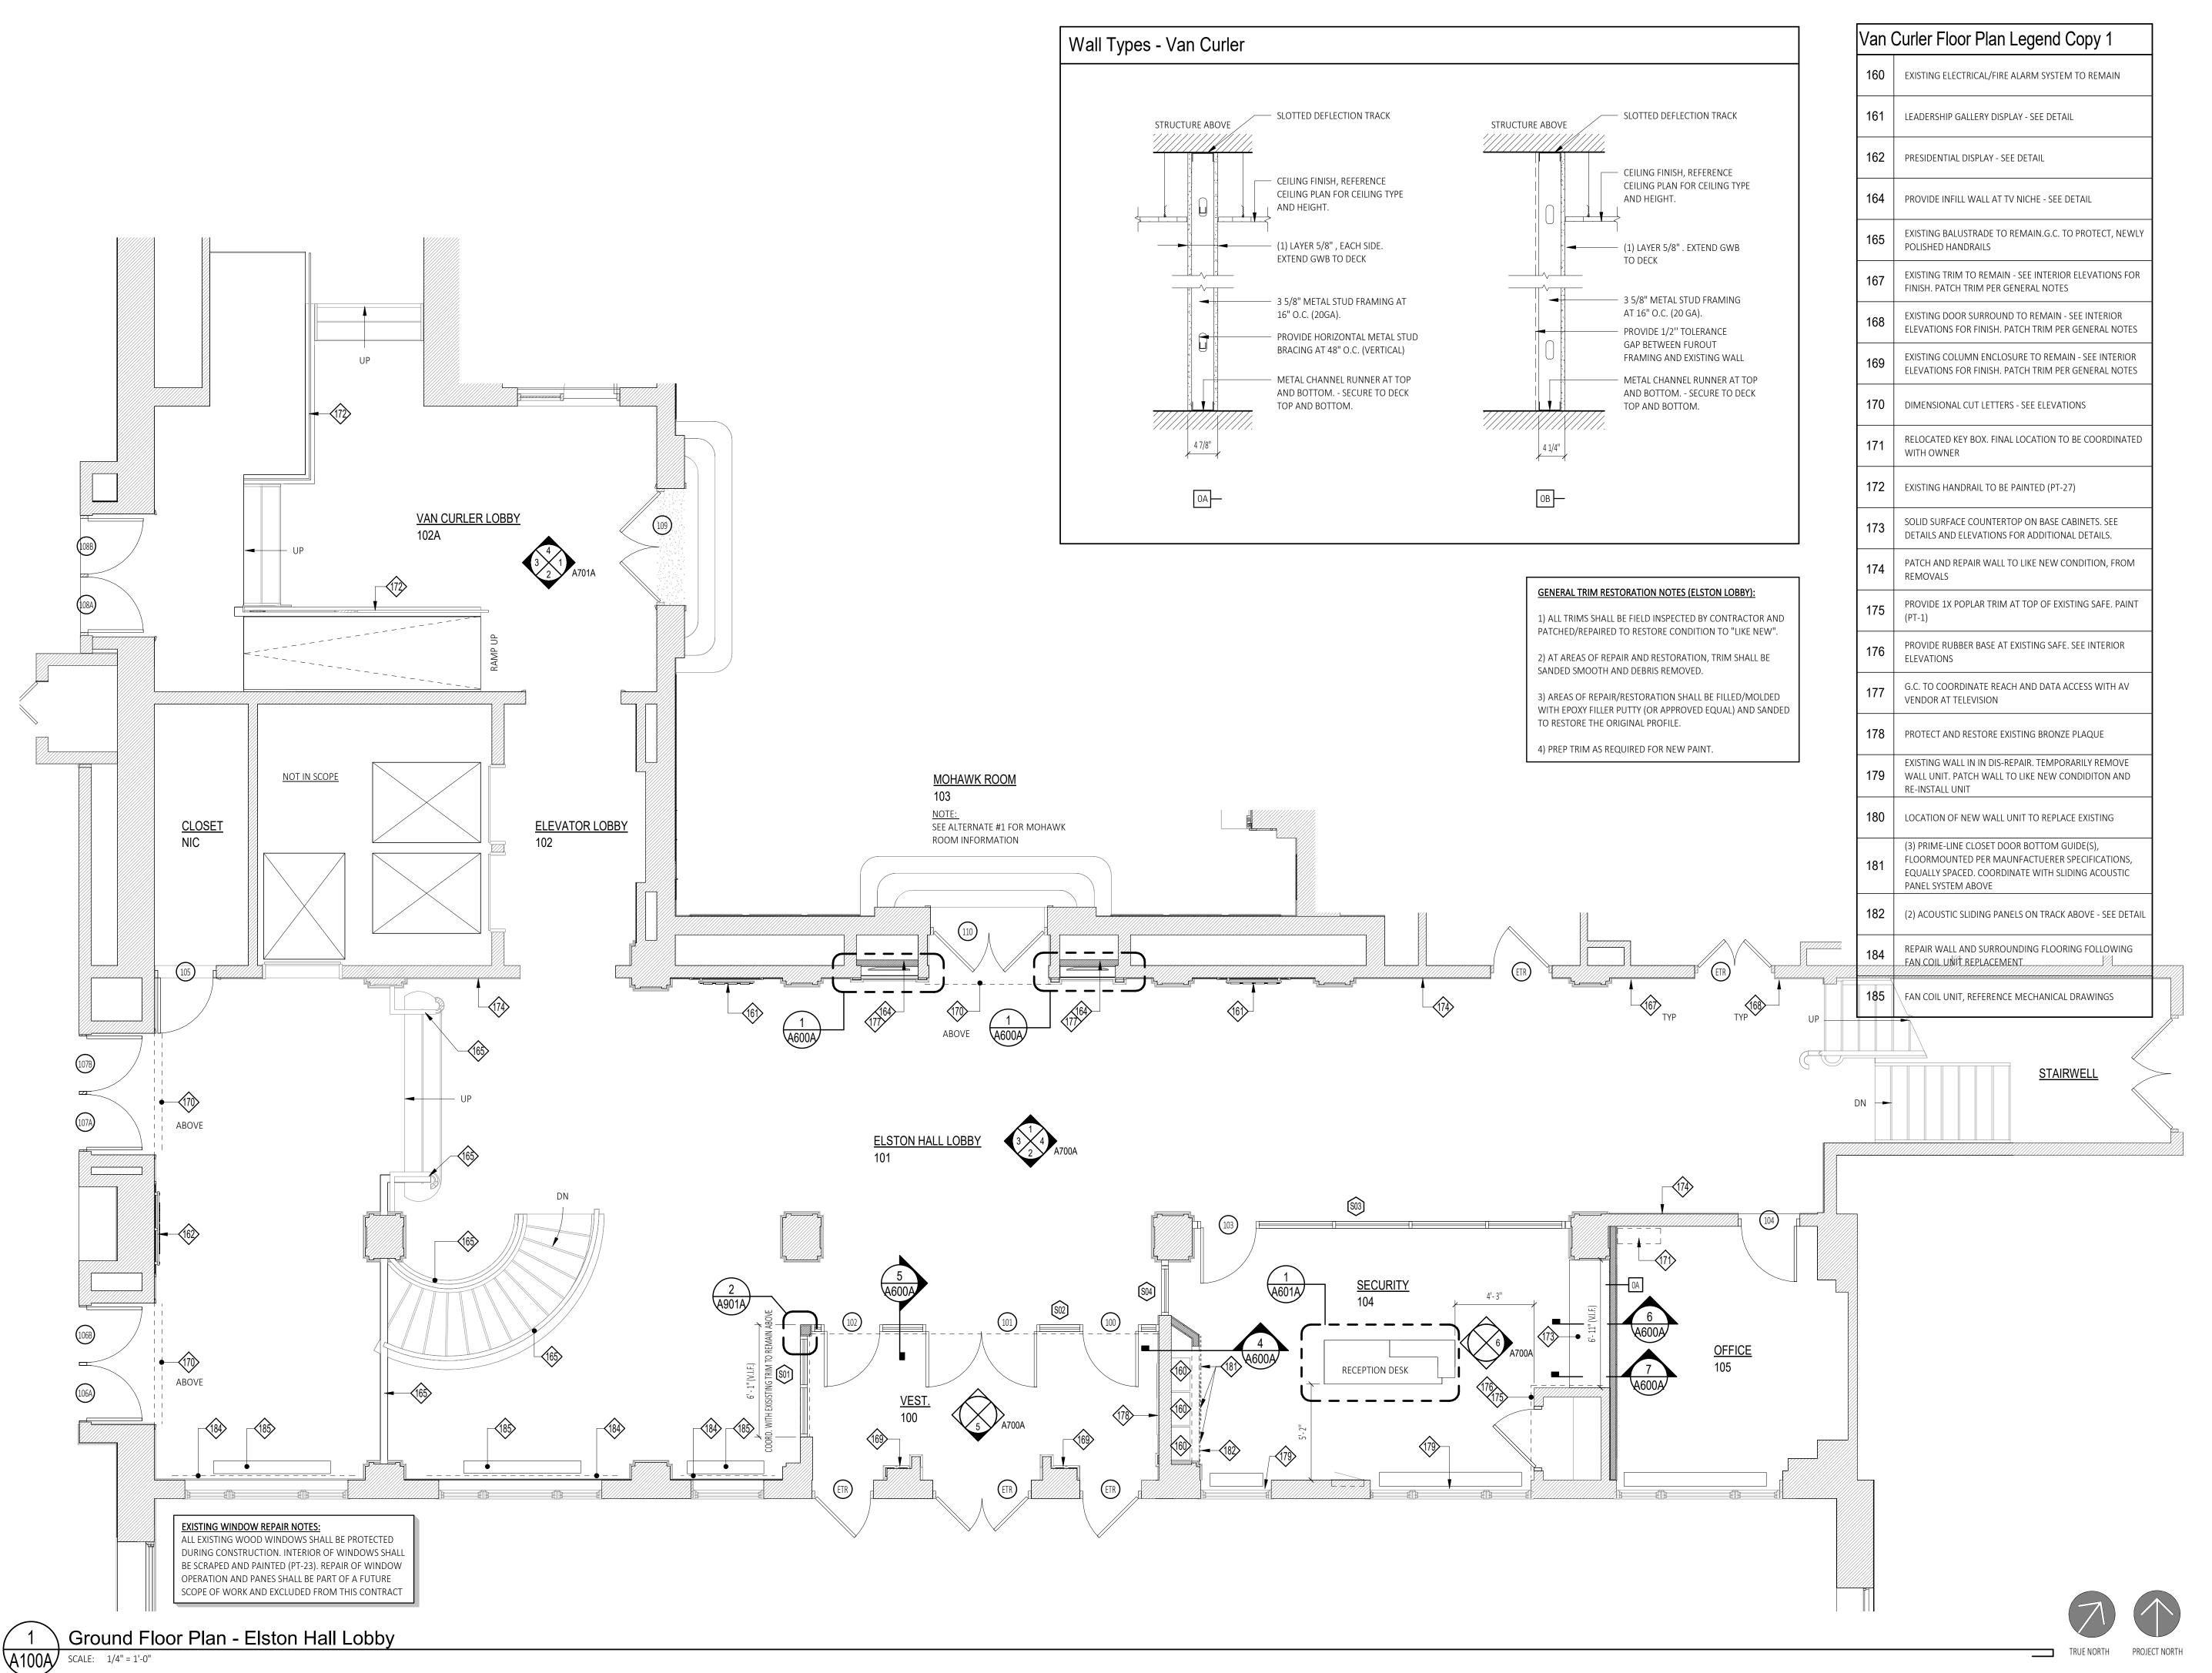
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CEILING DEMOLITION PLAN			

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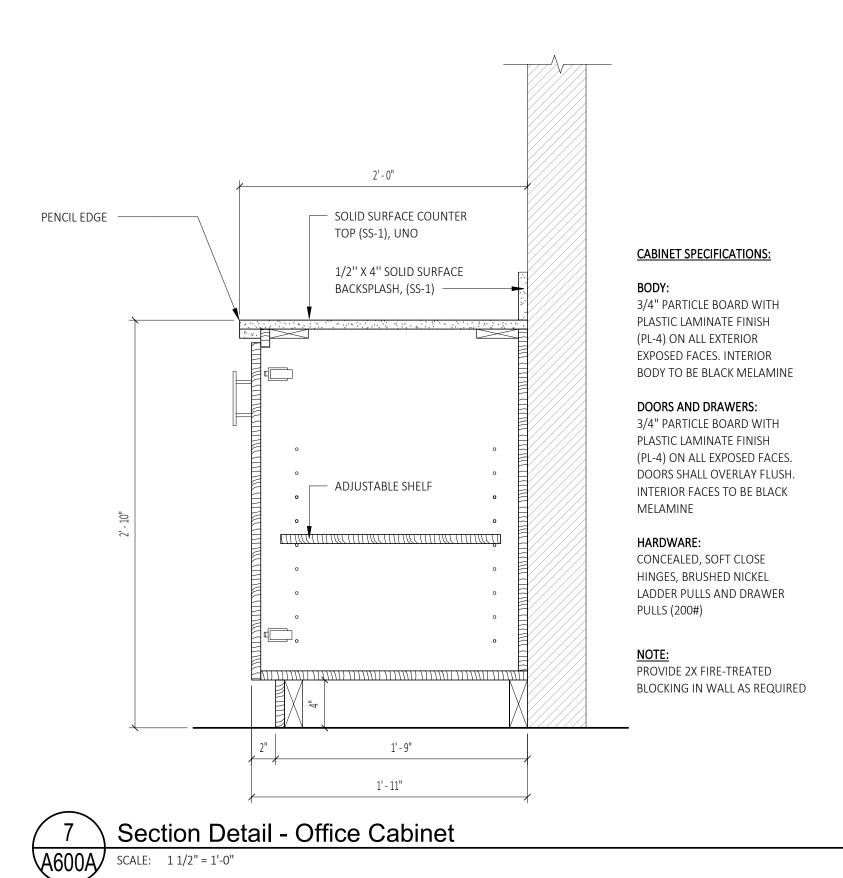
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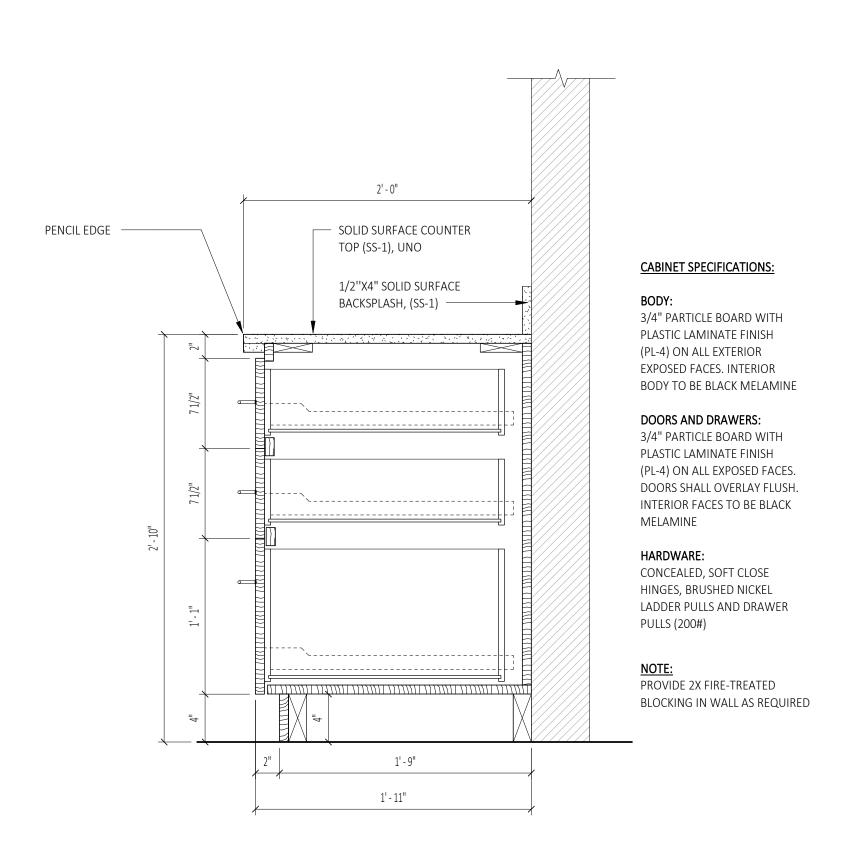
ELSTON HALL LOBBY

FLOOR PLAN

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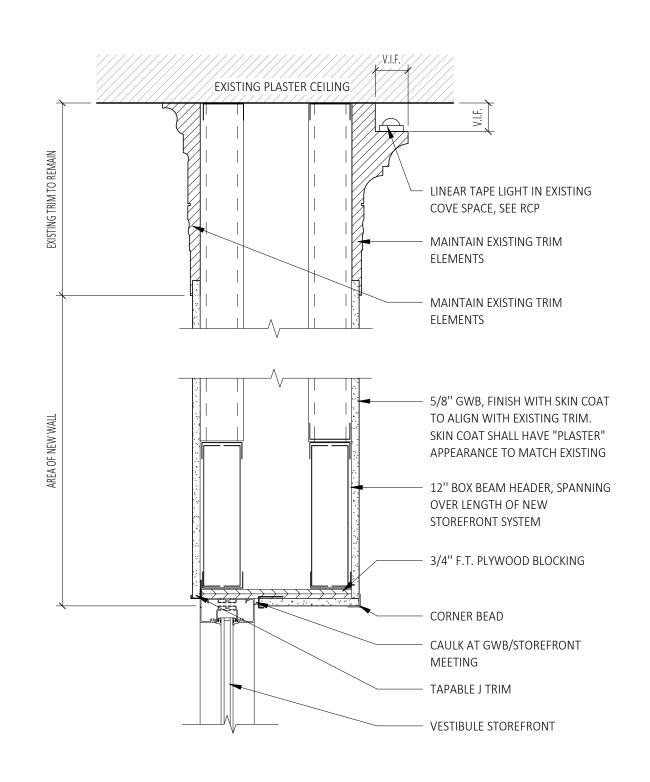
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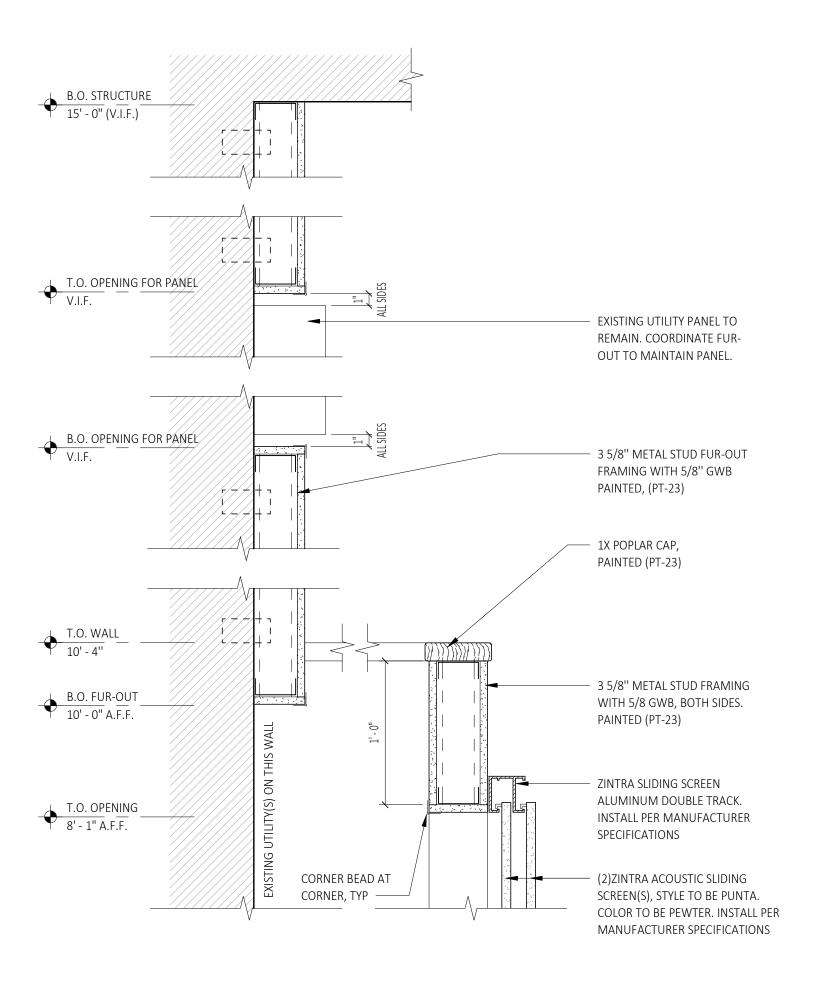



Section Detail - Office Drawers


A600A SCALE: 1 1/2" = 1'-0"




Section Detail - Storefront Vesituble Bulkhea




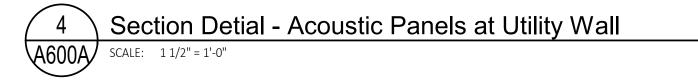

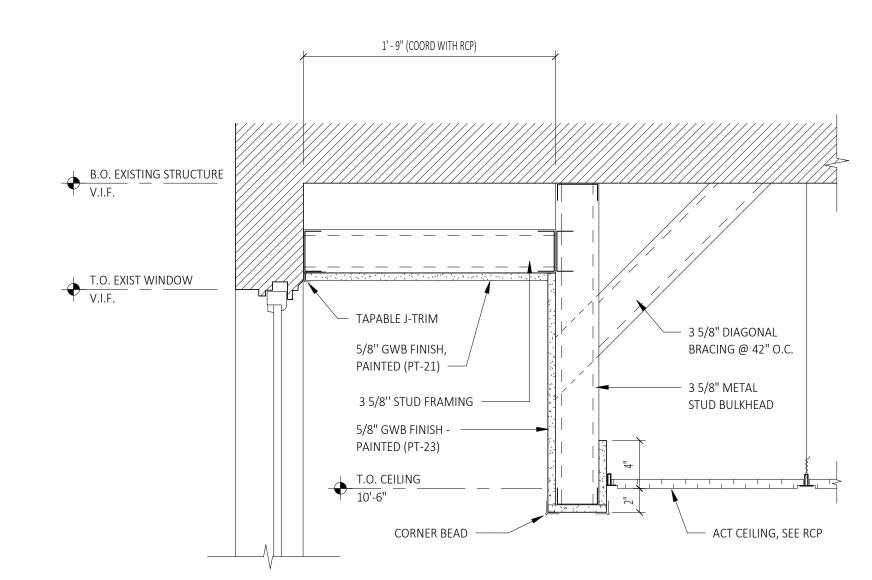



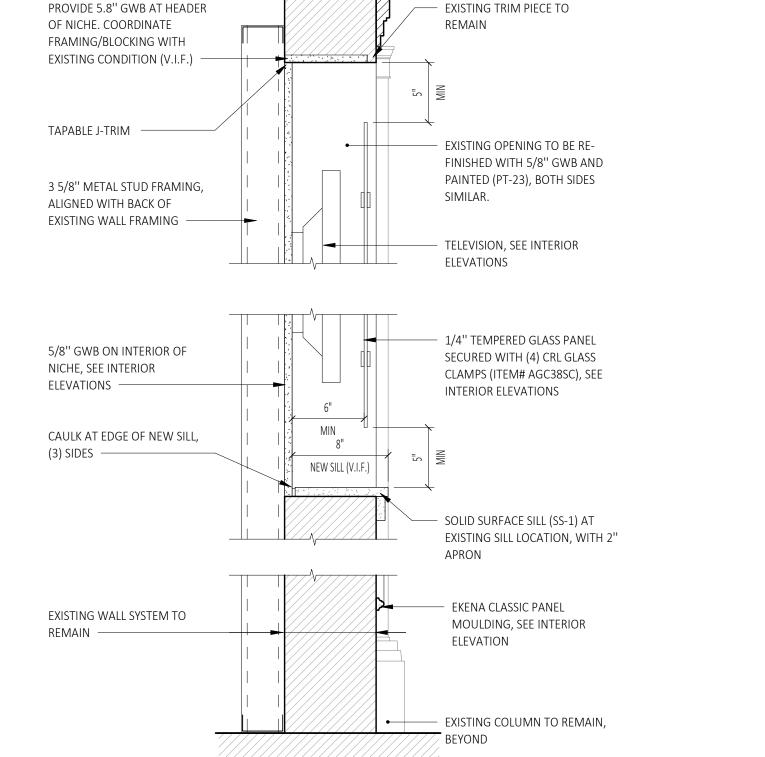

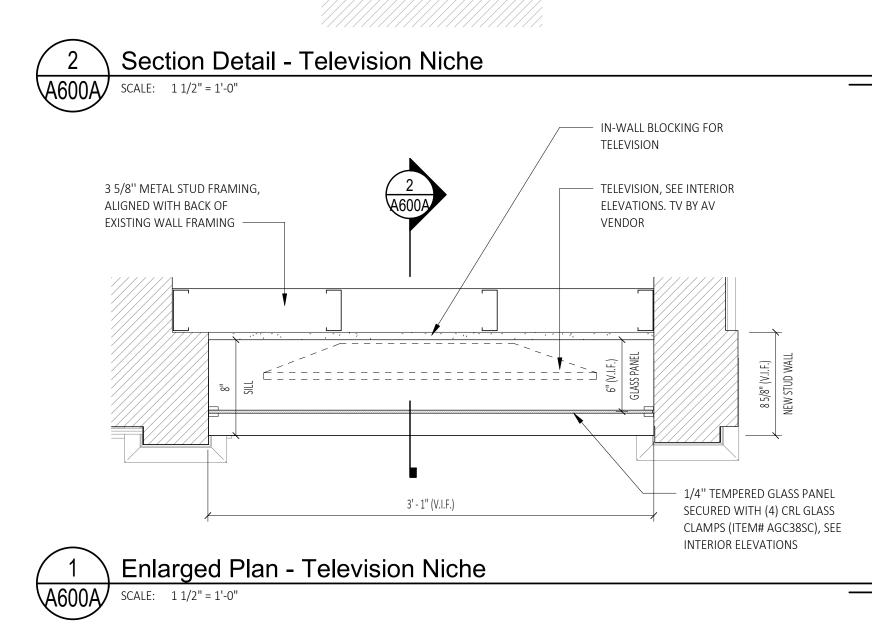



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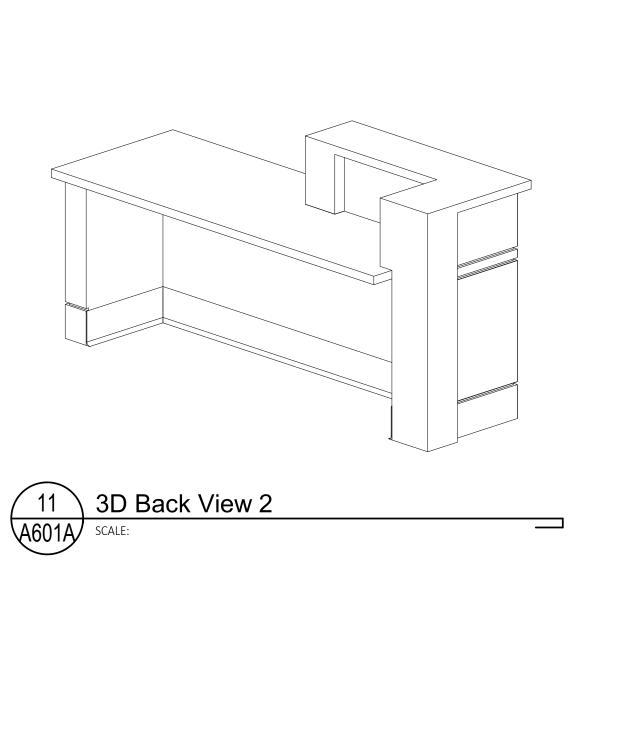
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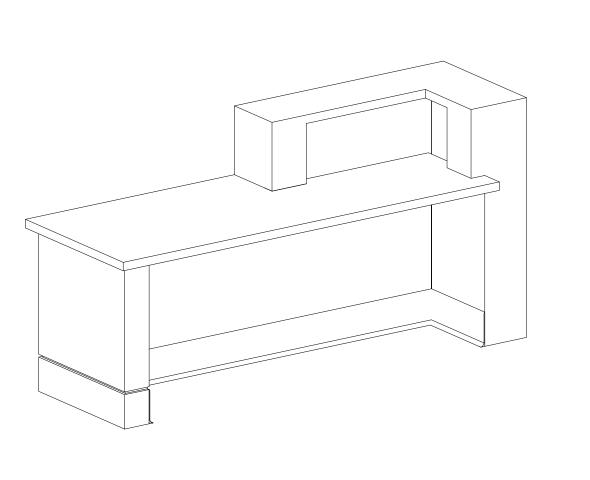
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LOBBY

Sheet Number:


PLOT DATE: 4/26/2024 9:34:09 AM

A600A








3D Back View 1

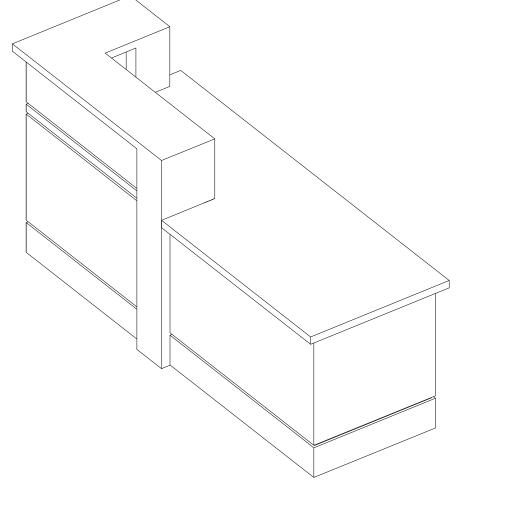



3D Front View 2

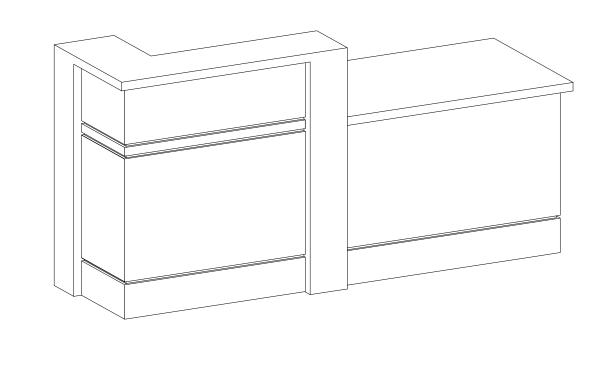


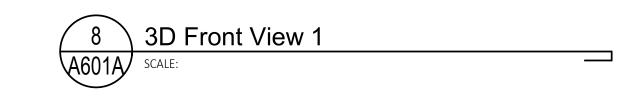


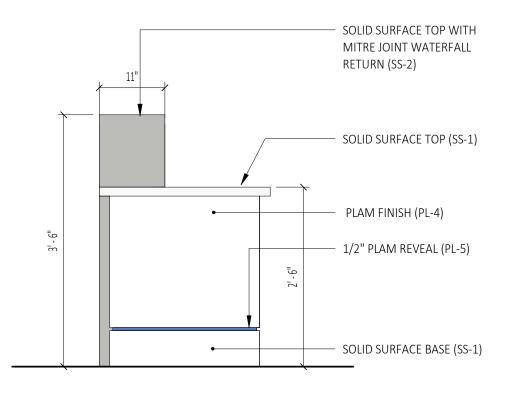


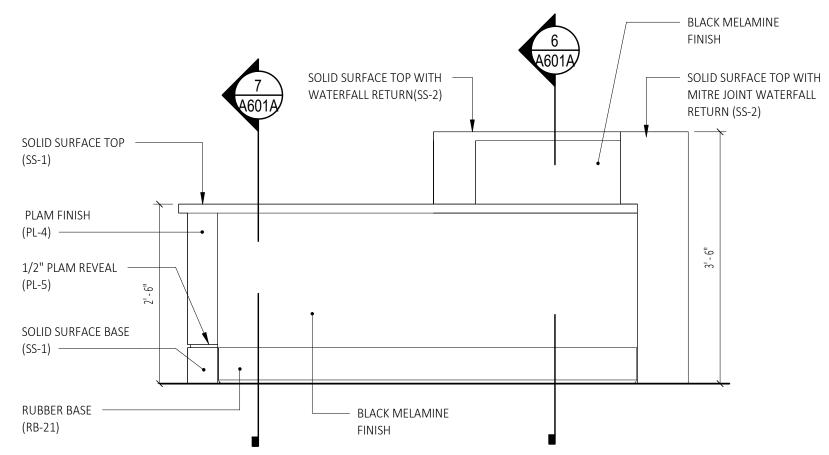


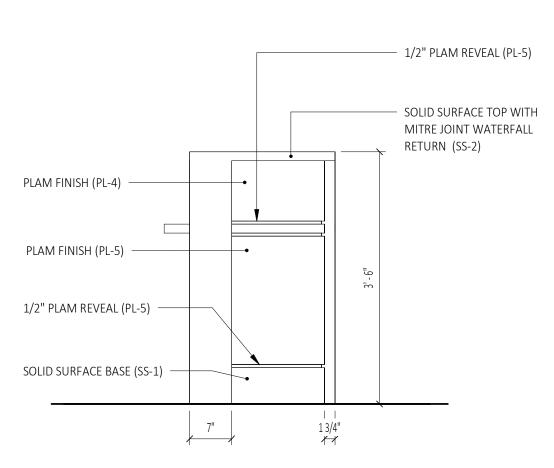


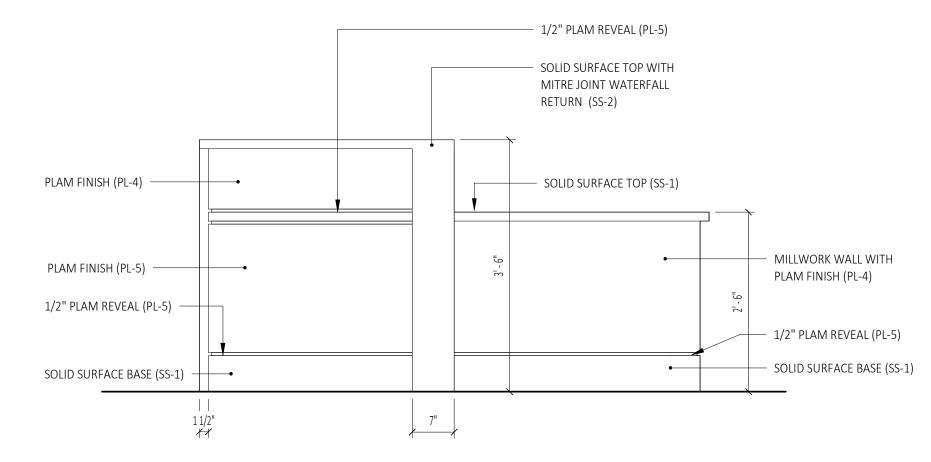

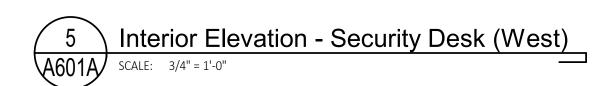


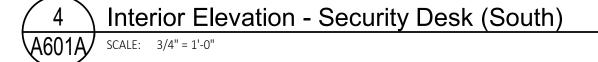


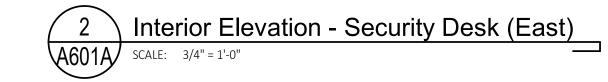


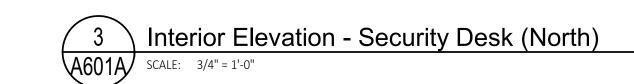

3' - 6 1/2"

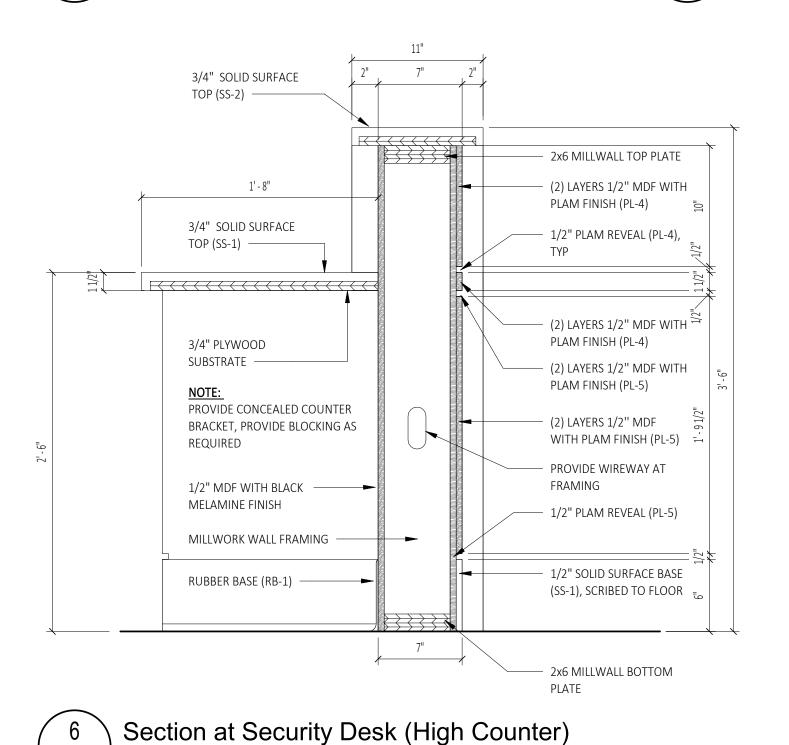

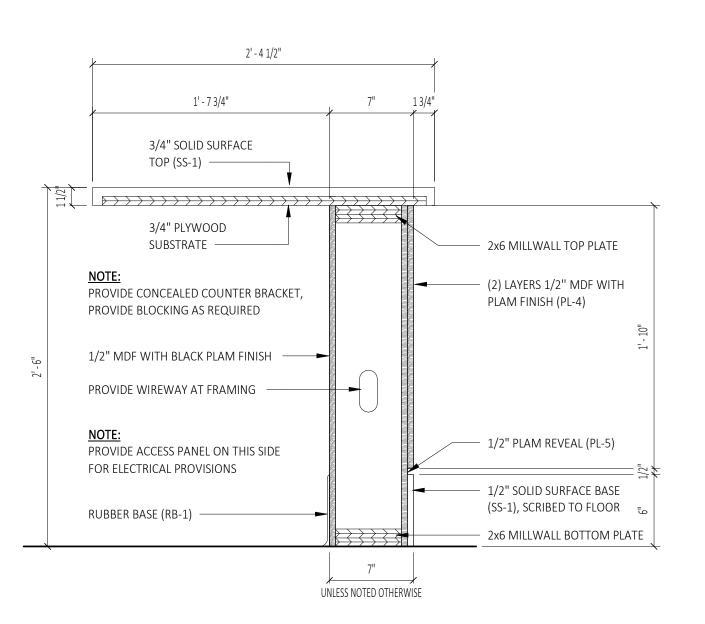

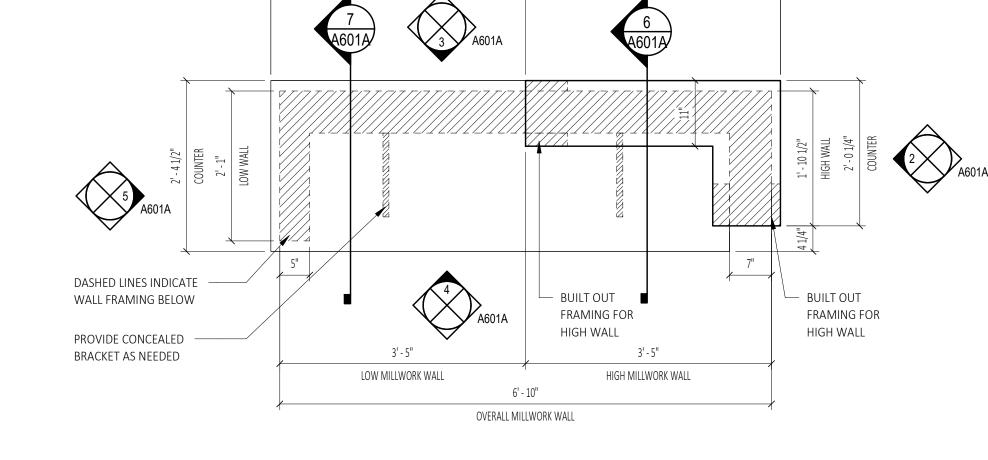

7' - 1"

COUNTER OVERALL

3' - 6 1/2" HIGH COUNTER

$\overline{7}$	Sec	ction at Security Desk (Low Counter)	
\A601A	SCALE:	1 1/2" = 1'-0"	

1 Enlarged Plan at Security Desk

SCALE: 3/4" = 1'-0"



Owner: SUNY SCCC 78 Washington Ave. Schenectady, NY 12305

SC Office of Facilities: Schenectady County 620 State Street Schenectady, NY 12305 518.388.4200


Architect: C2 Architecture, PC 24 Airport Road Schenectady, NY 12302 T: 518.320.8250

M/E/P Engineer: M/E Engineering
433 State Street, 4th Floor Schenectady, NY 12305 T: 518.533.2171

Abatement: ECS Mid Atlantic 421 New Karner Road Albany, NY 12205 T: 838.900.2851

SUNY SCCC ELSTON HALL LOBBY & MOHAWK ROOM RENOVATIONS


78 Washington Ave Schenectady, NY 12305

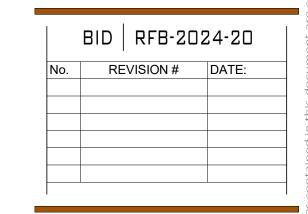


Drawn By: C2 Architecture As Noted 04/19/2024 Job No: Sheet Title: DETAILS - SECURITY DESK Sheet Number:


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A601A



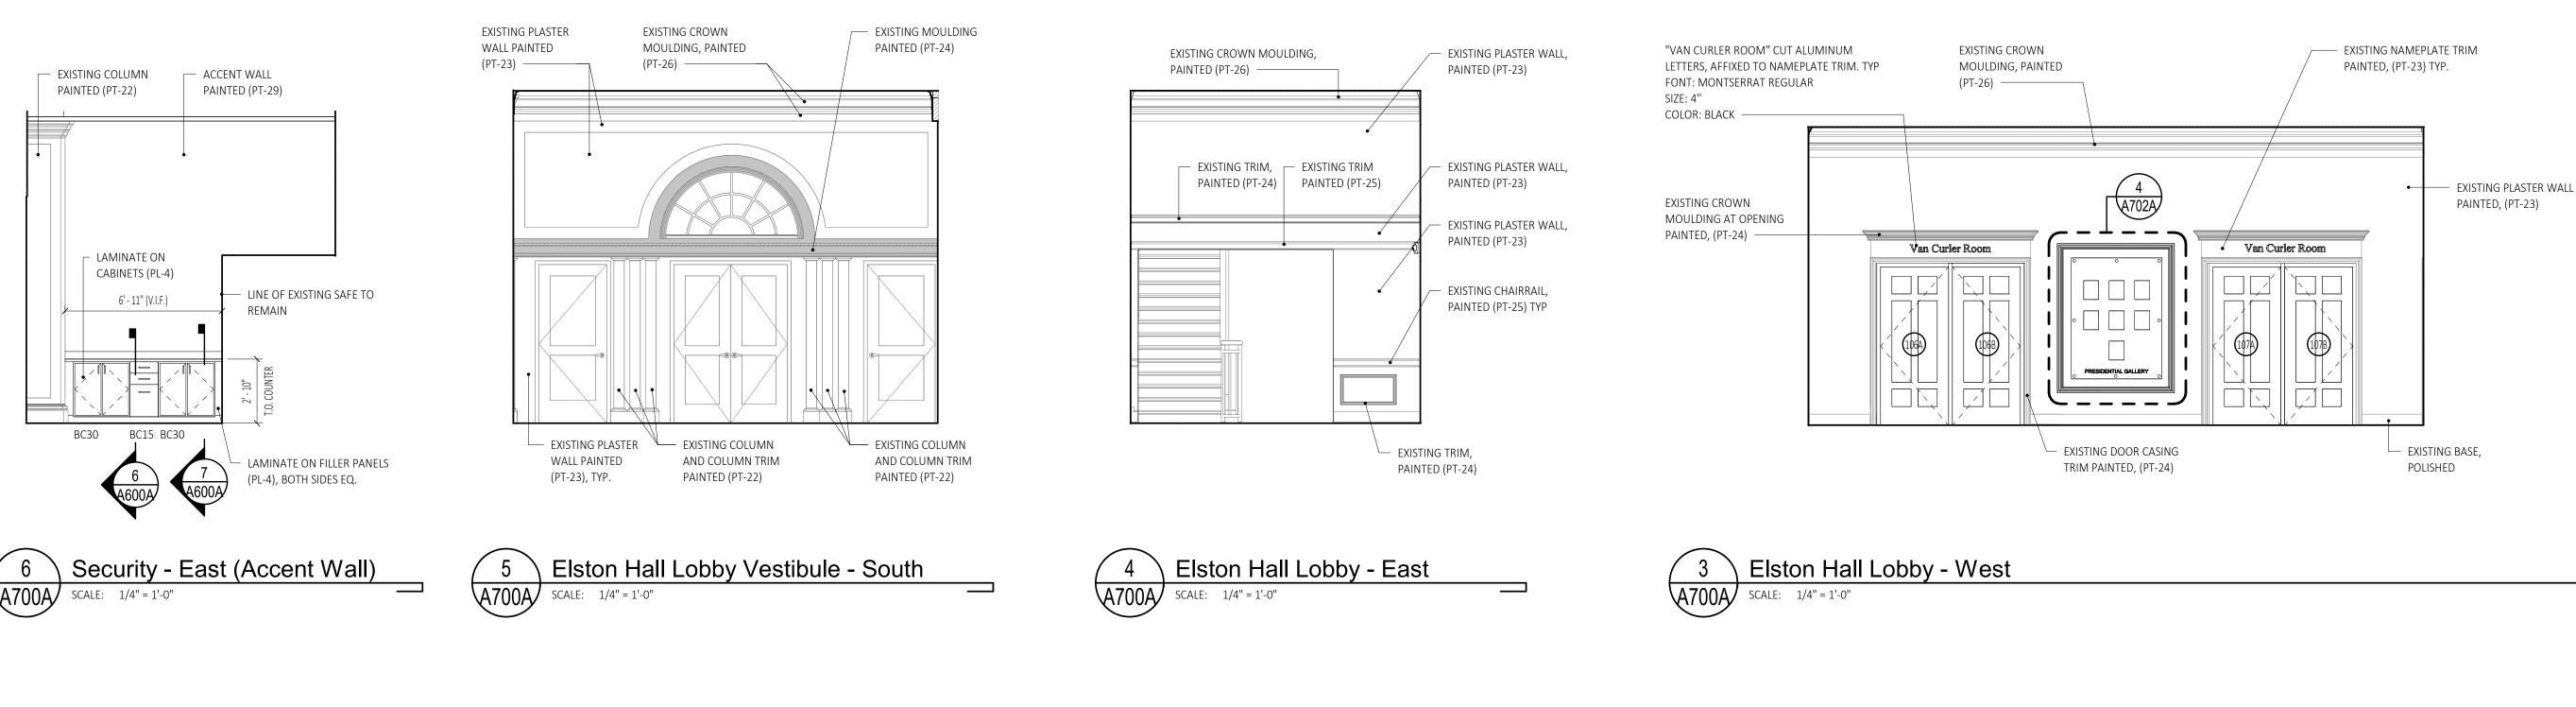

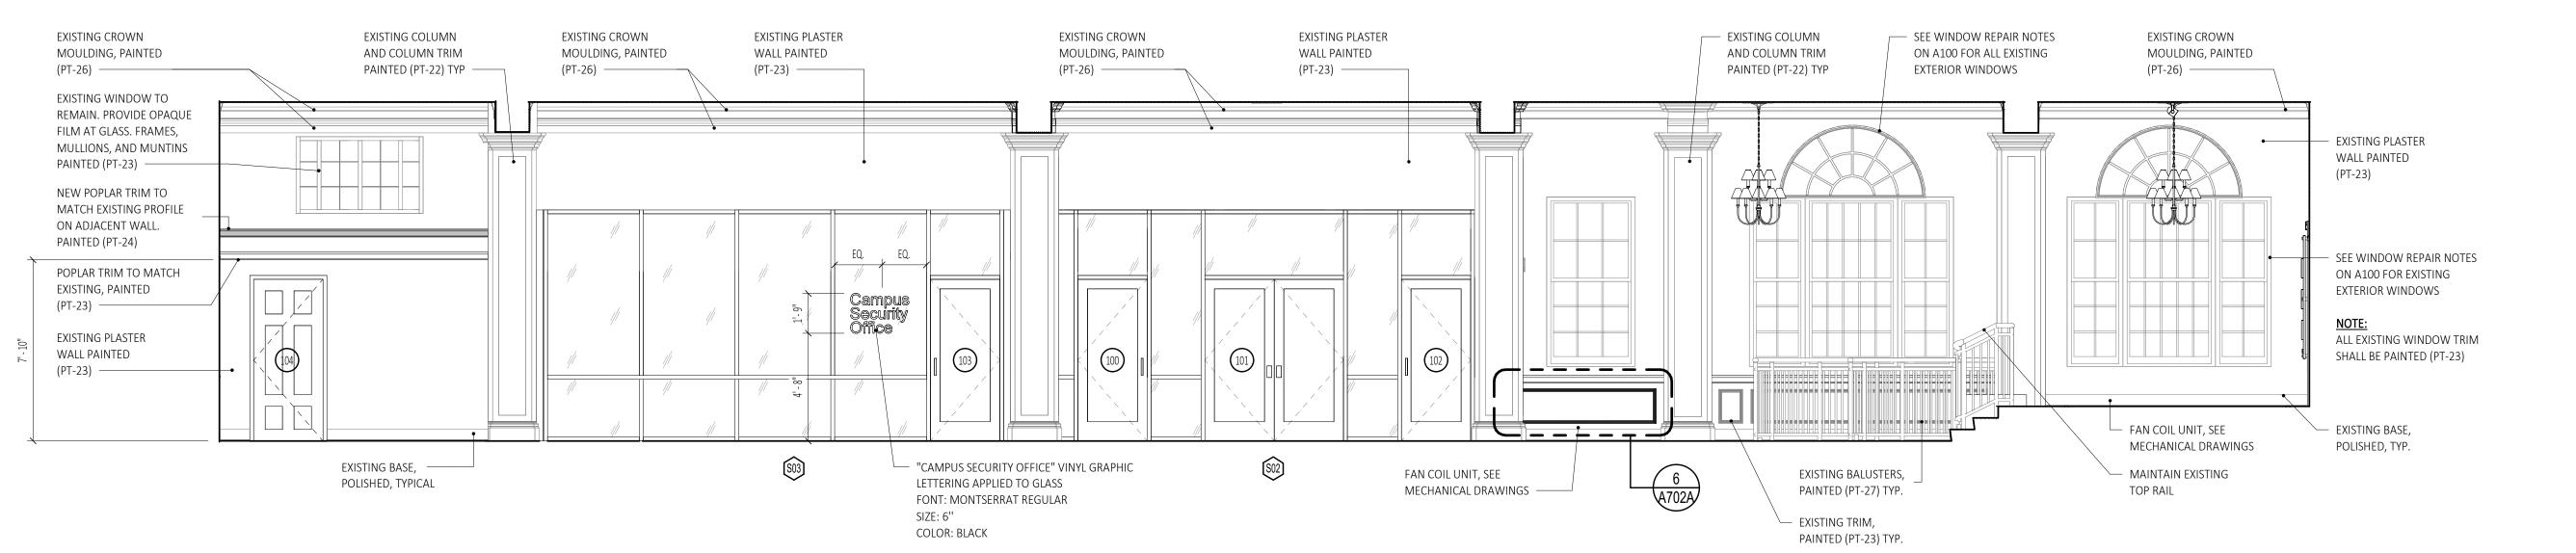



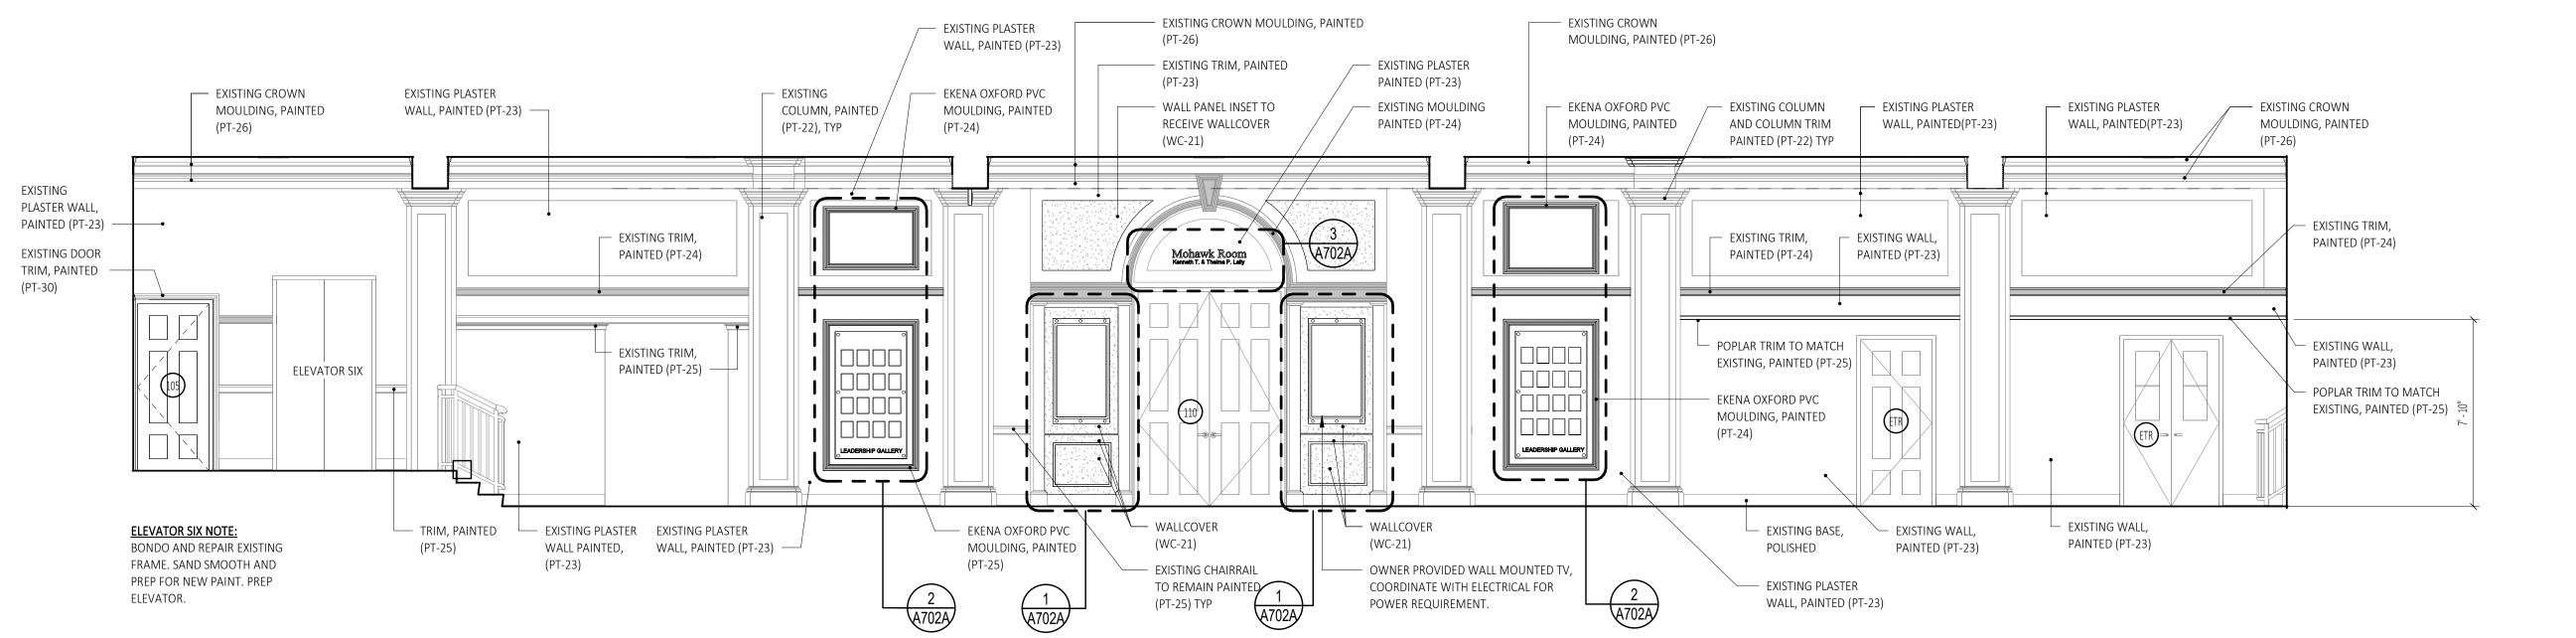

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M/E Engineering
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Schenectady, NY 12305
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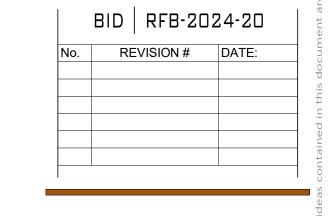
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SUNY SCCC ELSTON HALL LOBBY & MOHAWK ROOM RENOVATIONS

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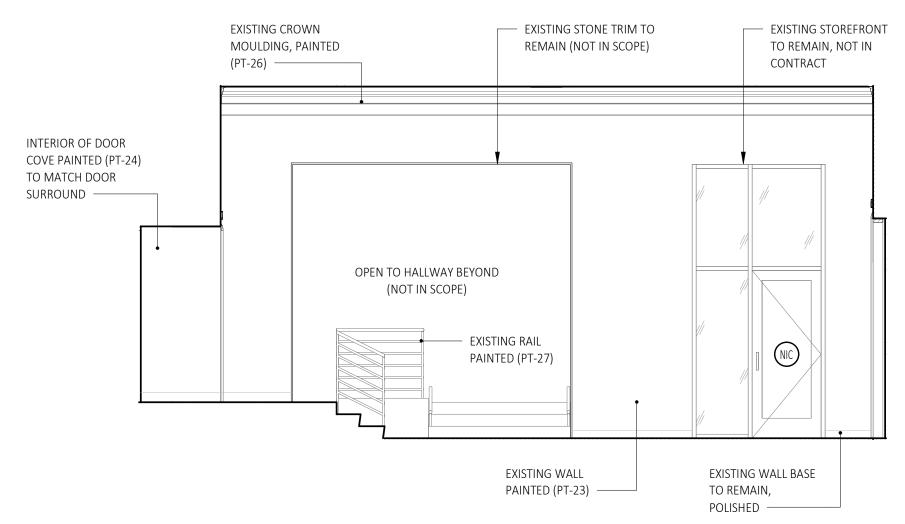



_	Drawn By:	C2 Architecture
	Scale:	As Noted
	Date:	04/19/2024
	Job No:	2349
	Sheet Title:	
	INTERIOR	ELEVATIONS -
	ELSTON	HALL LOBBY


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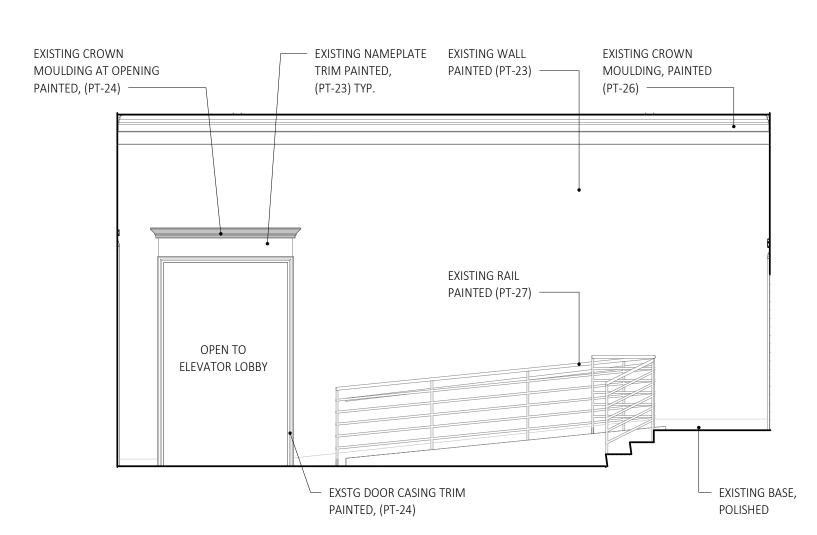
A700A








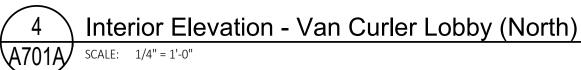

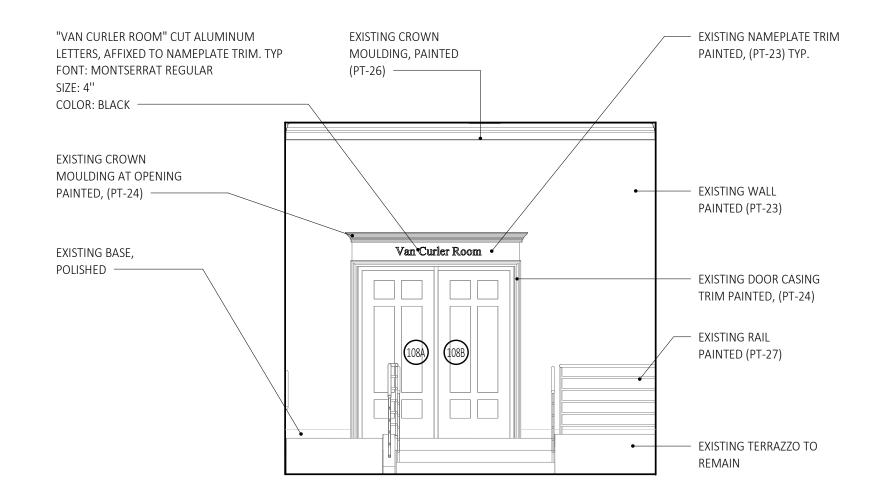



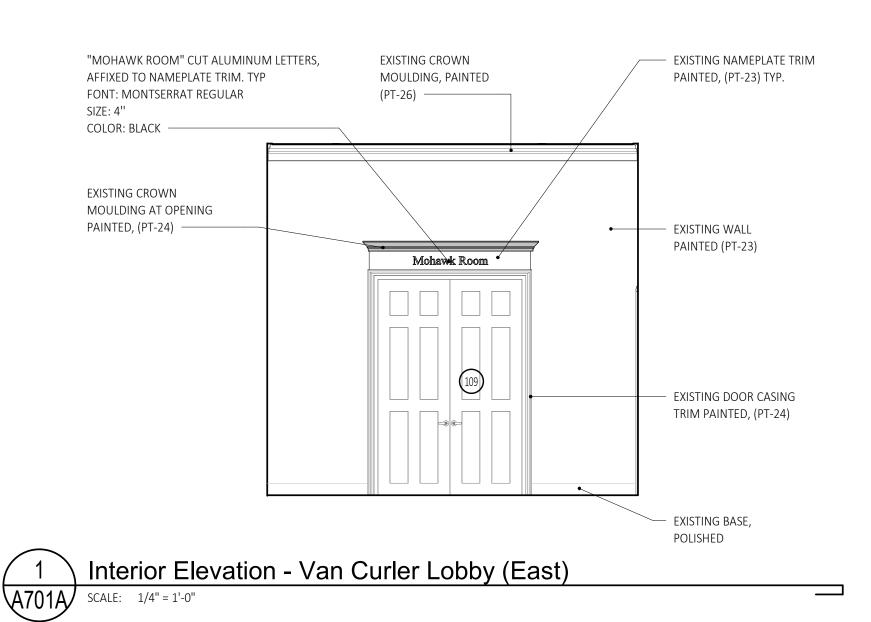

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SUNY SCCC ELSTON HALL LOBBY & MOHAWK ROOM RENOVATIONS

78 Washington Ave Schenectady, NY 12305

BID RFB-2024-20

No. REVISION # DATE:

Drawn By: C2 Architecture

Scale: As Noted

Date: 04/19/2024

Job No: 2349


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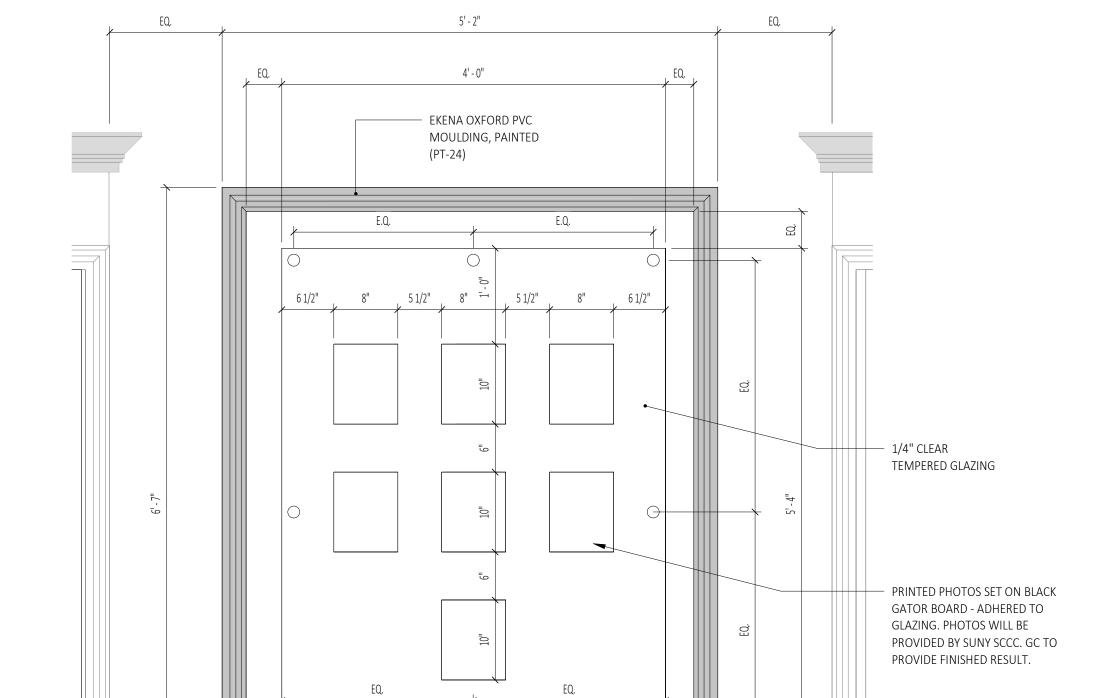
INTERIOR ELEVATIONS ELSTON HALL LOBBY

Sheet Number:

A701A

PLOT DATE: 4/26/2024 9:34:14 AM



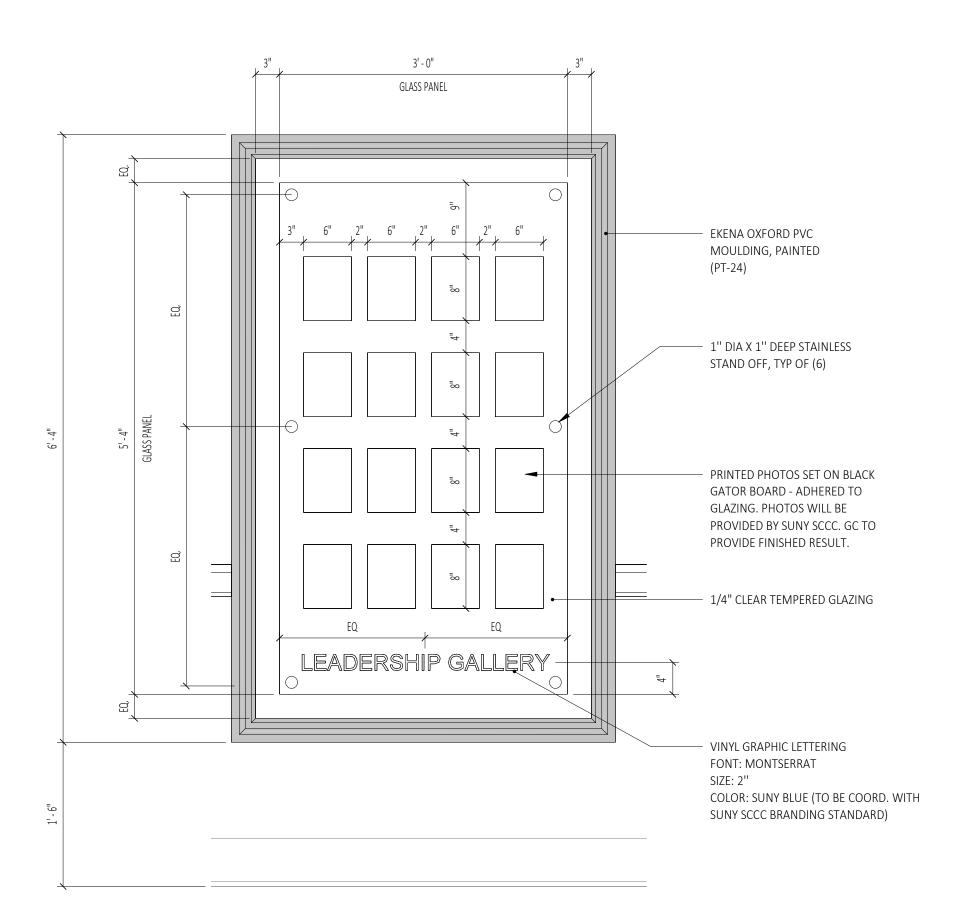

VINYL GRAPHIC LETTERING

COLOR: SUNY BLUE (TO BE COORD. WITH


SUNY SCCC BRANDING STANDARD)

FONT: MONTSERRAT

PRESIDENTIAL GALLERY

— 1" DIA X 1" DEEP

STAINLESS STAND OFF,

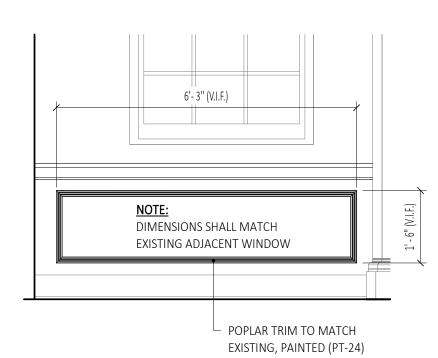


6 Enlarged Panel Elevation - South Wall
A702A SCALE: 1/2" = 1'-0"

4 Enlarged Panel Elevation - Presidential Gallery

SCALE: 1" = 1'-0"

Enlarged Panel Elevation - Leadership Display


A702A SCALE: 1" = 1'-0"

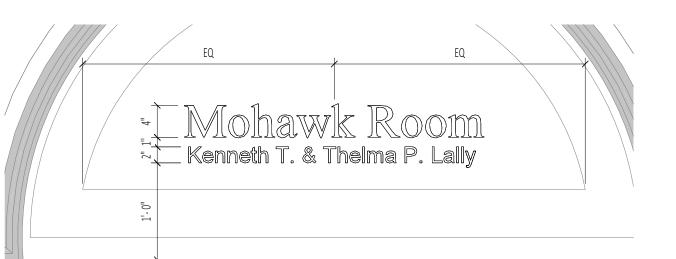

MOHAWK ROOM SIGNAGE NOTE: ALUMINUM CUT LETTERS ON

- STANDOFFS U.N.O. a. "MOHAWK ROOM"
- 4" LETTERS
- FONT: MONTSERRAT REGULAR
- COLOR: BLACK b. "KENNETH T. AND THELMA P.
- LALLY 2" LETTERS FONTI MONTSERRAT
- REGULAR
- COLOR: BLACK

Enlarged Elevation - Mohawk Room Entrance Signage A702A SCALE: 1" = 1'-0"

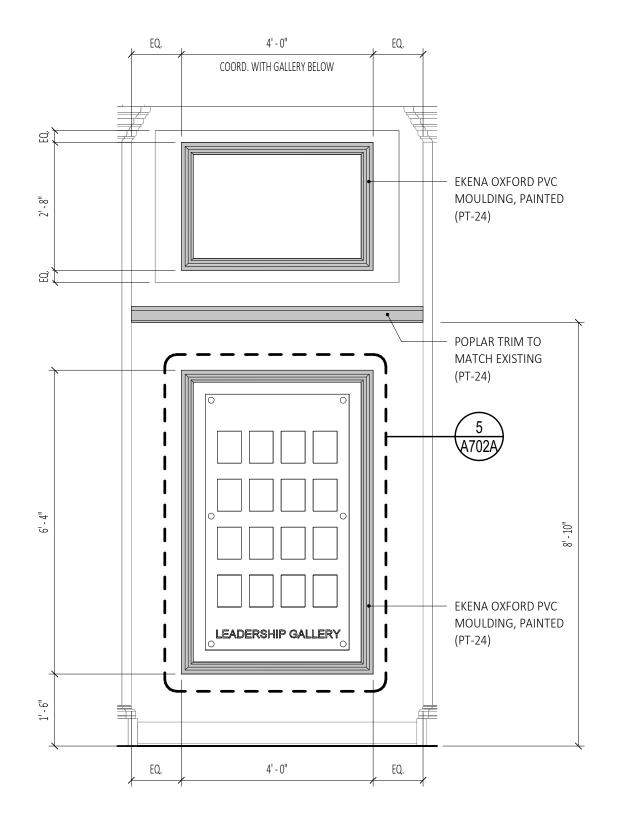



2 Enlarged Elevation - Leadership Gallery Panels

A702A SCALE: 1/2" = 1'-0"

1/4" GLASS PANEL (V.I.F.) E.Q. 1/4" TEMPERED GLAZING WITH (4) CRL SATIN CHROME ADJUSTABLE GLASS CLAMPS — WALL MOUNTED TV, COORDINATE WITH ELECTRICAL FOR POWER REQUIREMENTS. TV BY AV VENDOR (4) CRL GLASS CLAMPS (ITEM# AGC38SC), SEE INTERIOR ELEVATIONS -EKENA CLASSIC PANEL MOULDING PAINTED (PT-24) 4" 2' - 5 1/4"

1 Enlarged Panel Elevation - TV Niche

A702A SCALE: 1/2" = 1'-0"



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SUNY SCCC ELSTON HALL LOBBY & MOHAWK ROOM RENOVATIONS

78 Washington Ave Schenectady, NY 12305




C2 Architecture Drawn By: 04/19/2024 Job No: Sheet Title: INTERIOR ELEVATIONS AND

DETAILS - ELSTON HALL LOBBY

Sheet Number:

A702A

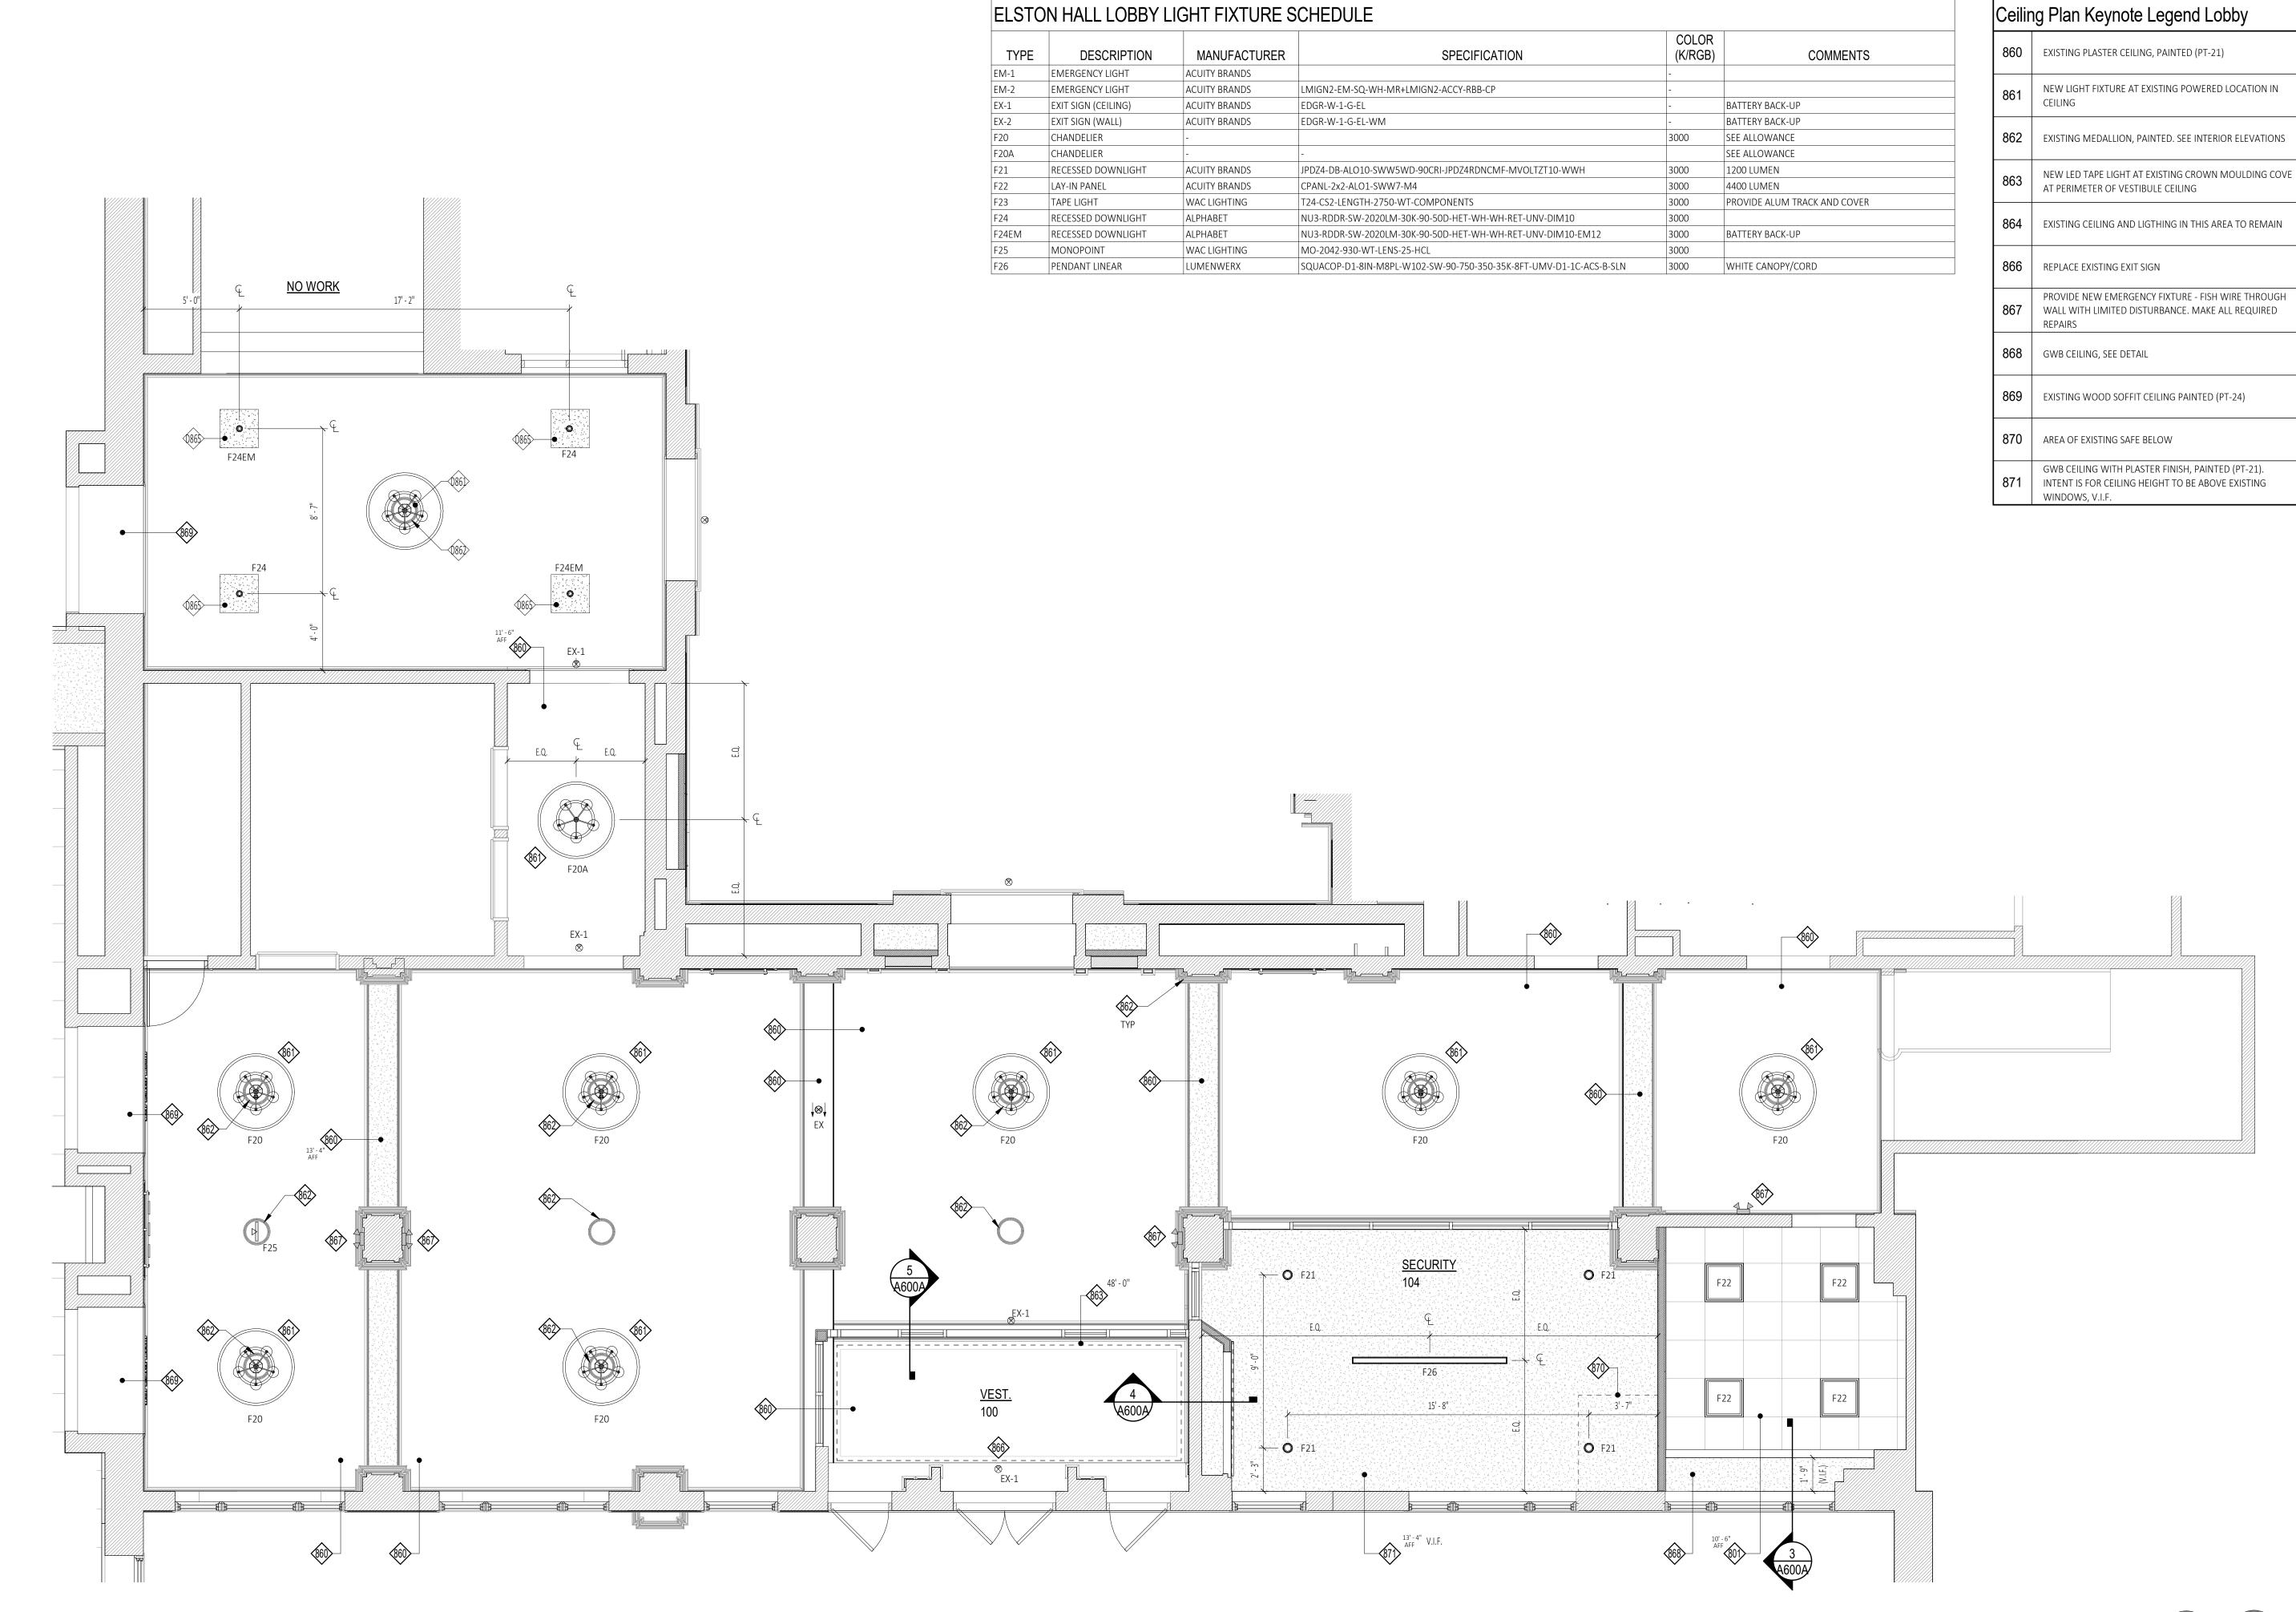

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SUNY SCCC ELSTON HALL LOBBY & MOHAWK ROOM RENOVATIONS

78 Washington Ave Schenectady, NY 12305

No.	REVISION #	DATE:
140.	112 101011 #	D/(IL.


Drawn By:	C2 Architecture
Scale:	As Noted
Date:	04/19/2024
Job No:	2349
Sheet Title:	
ELSTON	HALL LOBBY

ELSTON HALL LOBBY
REFLECTED CEILING PLAN

Sheet Number:

TRUE NORTH PROJECT NORTH

A800A

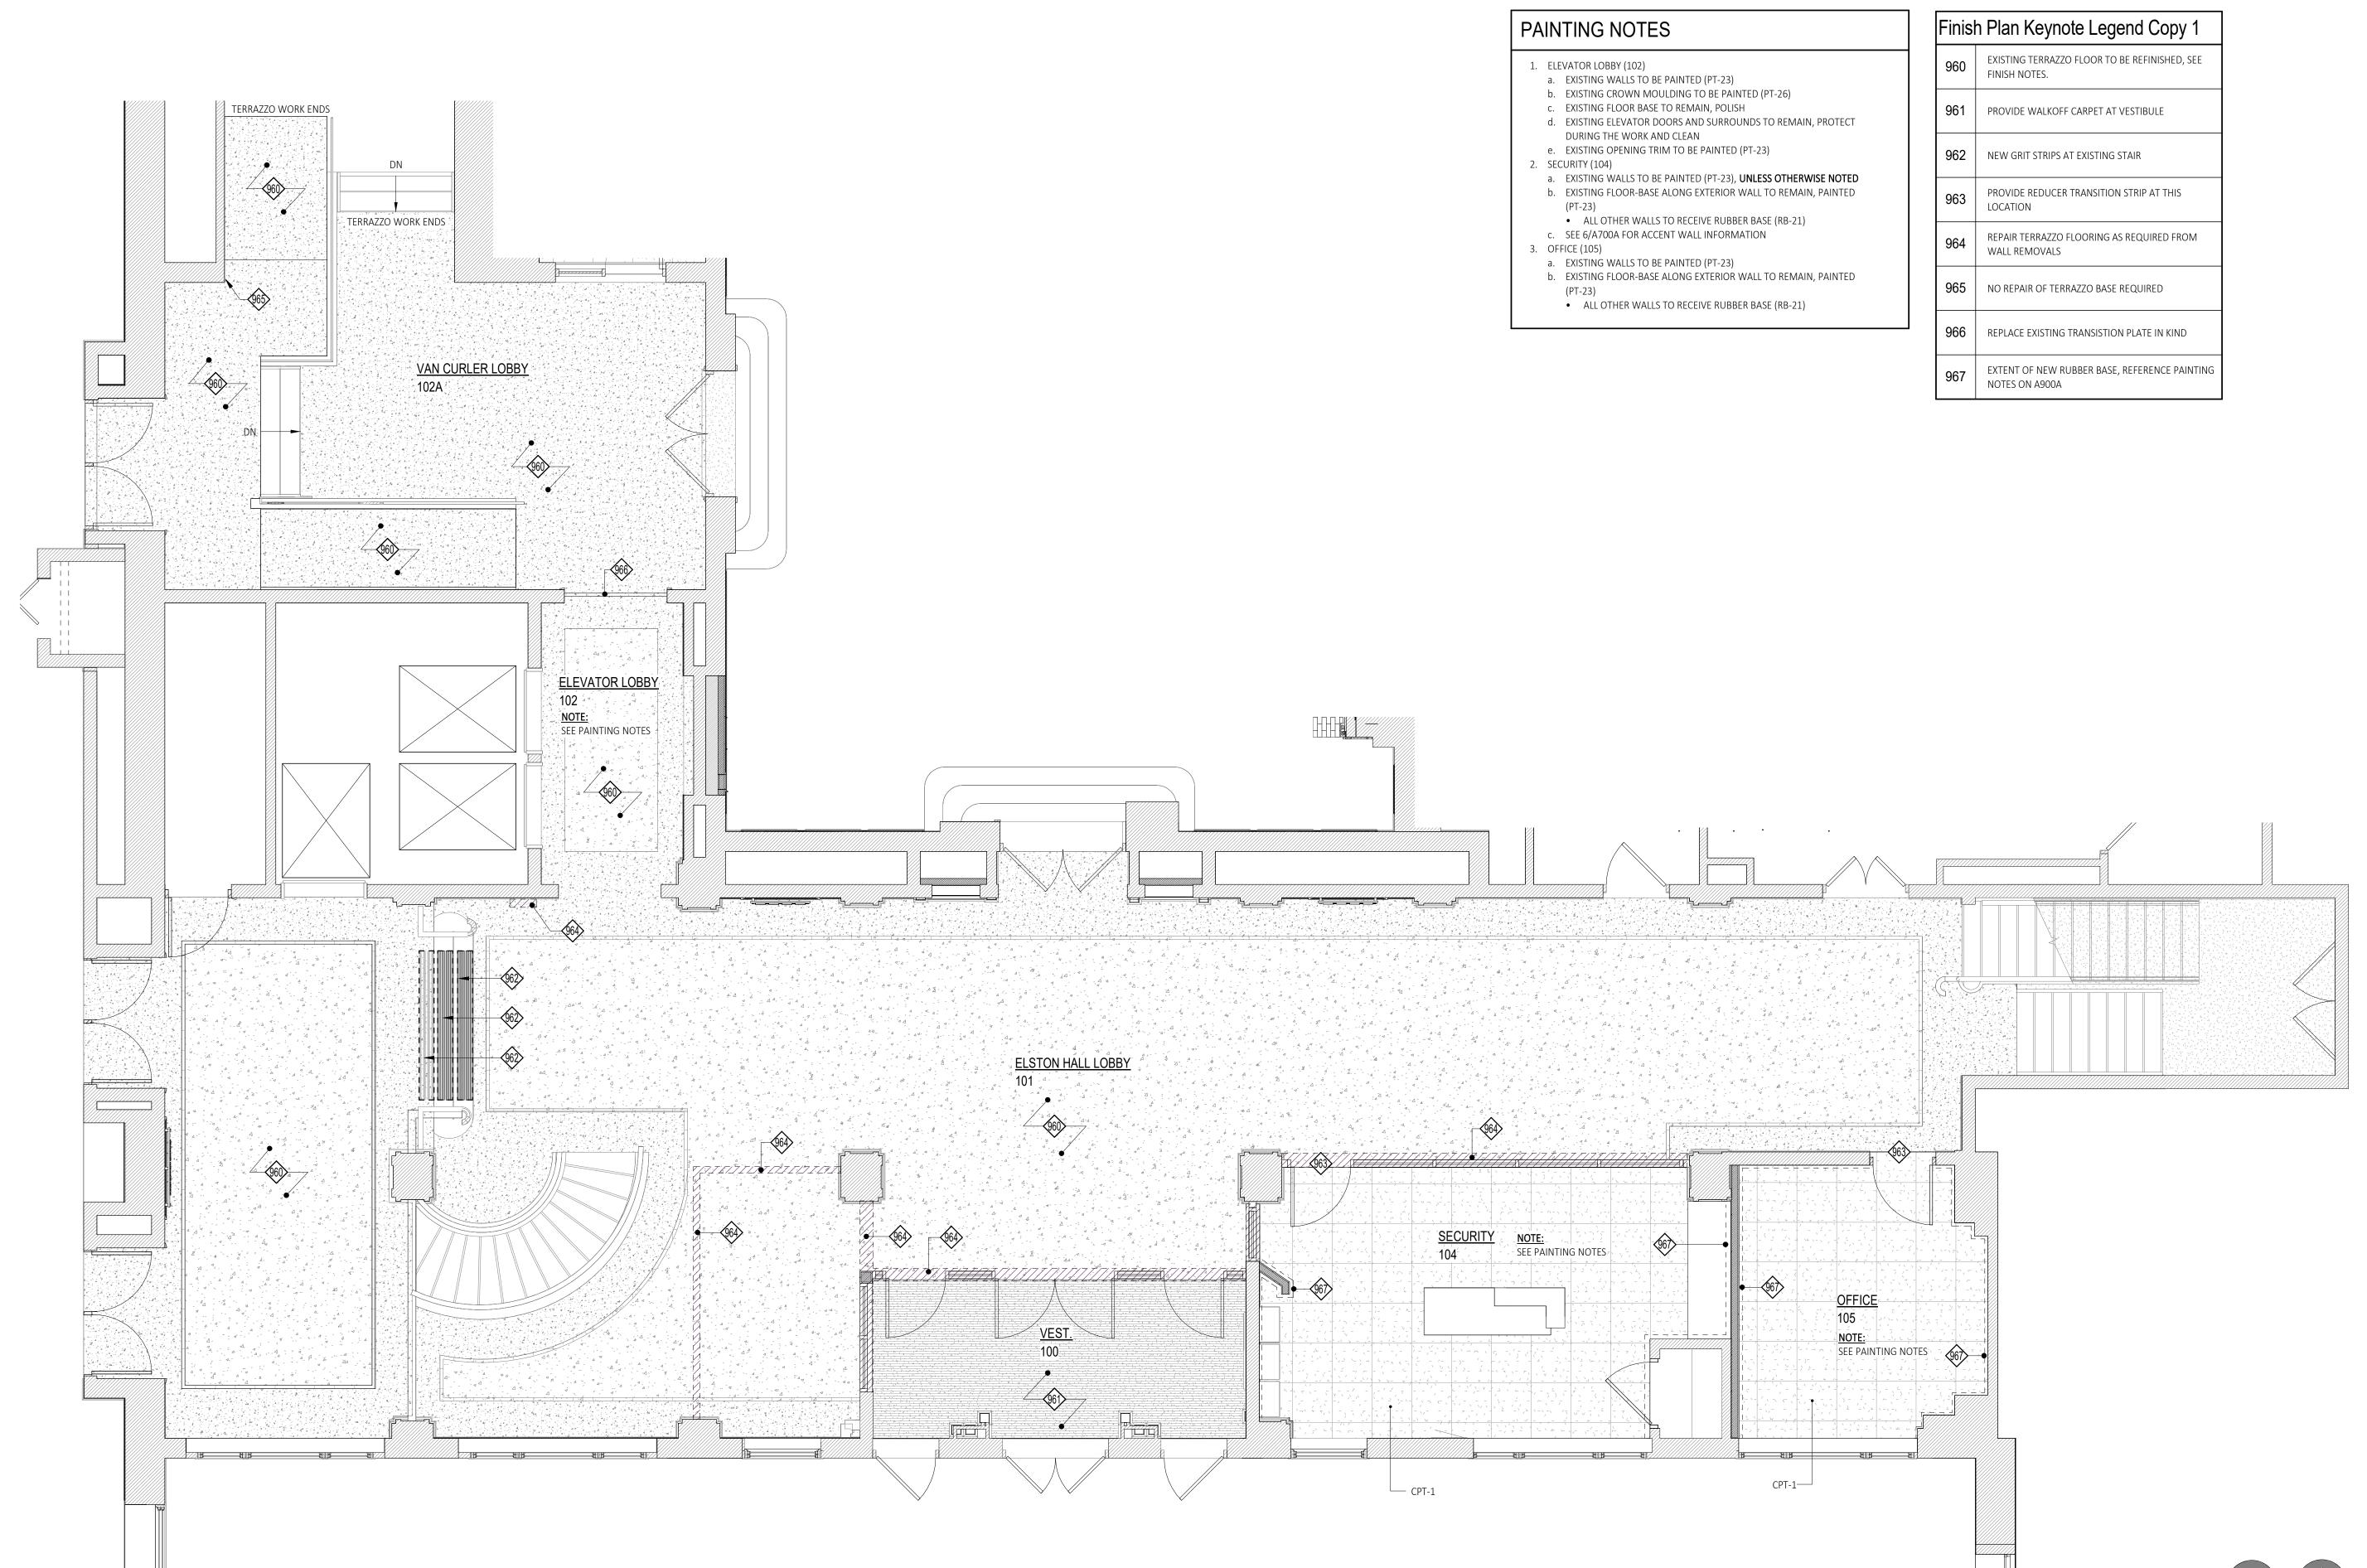

Elston Hall Lobby Finish Plan

A900A SCALE: 1/4" = 1'-0"

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SUNY SCCC ELSTON HALL LOBBY & MOHAWK ROOM RENOVATIONS

78 Washington Ave Schenectady, NY 12305

No. REVISION # DATE:

Drawn By: C2 Architecture

Scale: As Noted

Date: 04/19/2024

Job No: 2349

Sheet Title:

ELSTON HALL LOBBY

FINISH PLAN

T NORTH A900A

Sheet Number:

Door Schedule - Elston Hall Lobby DOOR FRAME Door No. Rating Hardware Comments Thk. Material Type | Glazing | Material Finish Head Jamb Location Finish Type VEST 100c / ELSTON HALL LOBBY 101c 7' - 0" 0' - 1 3/4" AL/GL ANNOD. ANNOD. SET 1 101 VEST 100c / ELSTON HALL LOBBY 101c 6' - 0" 7' - 0" 0' - 1 3/4" AL/GL ANNOD. AW TEMPERED ANNOD. SET 2 VEST 100c / ELSTON HALL LOBBY 101c 3' - 0" 7' - 0" 0' - 1 3/4" AL/GL ANNOD. AW ANNOD. SET 1 ELSTON HALL LOBBY 101 / SECURITY 104c 3' - 0" | 7' - 0" | 0' - 1 3/4" | AL/GL ANNOD. AW TEMPERED ANNOD. SET 1 PROVIDE POWERED LOCK AND CARD ACCESS ELSTON HALL LOBBY 101 / OFFICE 103c 3' - 0" 7' - 0" 0' - 1 3/4" WD A106 HM PT-30 H1 SET 3 105 ELSTON HALL LOBBY 101 / STORAGE 3' - 0" 7' - 0" 0' - 1 3/4" WD A106 ETR PT-30 MATCH EX. NEW DOOR IN EXISTING FRAME, V.I.F. ELSTON HALL LOBBY 101 / STORAGE 3' - 0" 7' - 0" 0' - 1 3/4" WD A106 ETR PT-30 MATCH EX. NEW DOOR IN EXISTING FRAME, V.I.F. 106A ELSTON LOBBY 101C / VAN CURLER 100A WD PT-7 ETR PT-6 2/A901A 1/A901A SET 4 ELSTON LOBBY 101C / VAN CURLER 100A 3' - 0" 7' - 0" 0' - 1 3/4" WD PT-7 ETR PT-6 2/A901A 1/A901A 90 SET 4 107A ELSTON LOBBY 101C / VAN CURLER 100A 3' - 0" 7' - 0" 0' - 1 3/4" WD PT-7 ETR PT-6 2/A901A 1/A901A 90 SET 4 ELSTON LOBBY 101C / VAN CURLER 100A 3' - 0" 7' - 0" 0' - 1 3/4" WD PT-7 ETR PT-6 2/A901A 1/A901A SET 4 108A VAN CURLER 100A / VAN CURLER LOBBY WD PT-7 ETR PT-6 2/A901A 1/A901A 90 SET 4 VAN CURLER 100A / VAN CURLER LOBBY 3' - 0" 7' - 0" 0' - 1 3/4" WD PT-7 ETR PT-6 2/A901A 1/A901A 90 SET 4 MOHAWK ROOM 100b / VAN CURLER LOBBY 6' - 0" 9' - 0" 0' - 1 3/4" ETR PT-15 ETR PT-16 SEE MOHAWK DOOR REPAIR NOTES MOHAWK ROOM 100b / ELSTON HALL LOBBY 100c 6' - 0" 9' - 0" 0' - 1 3/4" ETR PT-15 ETR PT-16 SEE MOHAWK DOOR REPAIR NOTES


Door Hardware Sets										
SET 1: 1 EA 1 EA 1 EA 1 EA 1 EA 1 EA 1 Se	Pivot Set Push/Pull Bar	7226FINT 7226F SET 9190-0 100S TDC-40 Alum Supply	630 630 630 630 TST	IVE IVE IVE GLY	<u>SE</u> * • •	7 2 2 EA 2 EA 2 EA 2 EA 1 EA 1 Seat	Intermediate Pivot Pivot Set Push/Pull Bar Overhead Stop CLOSER Seak	7226FINT 7226F SET 9190-0 100S TDC-40 Alum Supply	630 630 630 630 TST	IVE IVE IVE GLY
SET 3 3 EA 1 EA 1 EA 3 EA	Entrance CLOSER Stop	5BB1 ND53 RHO TDC-40 WA407 SR64	PBB 626 TST 32D BLK	IVE SCH IVE IVE	<u>SE</u> * • • •	3 EA 1 EA 1EA 1 EA 3 EA	Hinge Entrance CLOSER Stop Silencer	5BB1 ND53 RHO TDC-40 WA407 SR64	PBB 626 TST 32D BLK	IVE SCH IVE IVE


General Finish Notes


- 1. INTERIOR WALL AND CEILING FINISHES IN INTERIOR EXIT STAIRWAYS, EXIT PASSAGEWAYS, CORRIDORS, AND ENCLOSURE FOR EXIT ACCESS STAIRWAYS SHALL BE CLASS A (0-25 FLAME SPREAD INDEX; 0-450 SMOKE-DEVELOPMENT INDEX) OR BETTER, WHEN TESTED IN ACCORDANCE WITH ASTM E84-2007 OR UL 723-2003
- 2. INTERIOR WALL AND CEILING FINISHES IN SPACES OTHER THAN THOSE NOTED ABOVE SHALL BE CLASS B (25-75 FLAME SPREAD INDEX; 0-450 SMOKE DEVELOPMENT INDEX) OR BETTER, WHEN TESTED IN ACCORDANCE WITH ASTM E84-2007
- 3. FLOOR FINISHES SHALL COMPLY WITH THE DOC FF-1 "PILL TEST" CPSC 160CFR PART 1630-2000
- 4. GC TO PROVIDE SIGNAGE AS OUTLINED IN THE SPECIFICATIONS ALONG WITH ANY ADDITIONAL REQUIRED SIGNAGE REQUIRED BY THE AUTHORITY HAVING JURISDICTION.
- 5. <u>TERRAZZO REPAIR/CLEANING/POLISHING:</u>
- A. TERRAZZO CONTRACTOR SHALL VISIT SITE AND INSPECT ALL TERRAZZO AREAS PRIOR TO BID. TERRAZZO CONTRACTOR SHALL INCLUDE IN THEIR BID, ALL PREPARATION, PATCHING AND REPAIR AS NEEDED TO COMPLETE THE DESIGN INTENT - REGARDLESS IF INDICATED ON THE DRAWINGS - FOR THE SCOPE OF WORK.
- B. AREAS OF TERRAZZO REPAIR SHALL BE PREPARED AS FOLLOWS: a. CLEAN AND STRIP EXISTING TERRAZZO AREAS.
- 1. USE PIONEER ECLIPSI FORMULA X (OR APPROVED EQUAL)
- b. GRIND FLOOR
- 1. 1ST PASS GRIND (150 GRIT METAL BONDED DIAMOND PAD) 2. 2ND PASS GRIND (100 GRIT CERAMIC PAD)
- 3. 3RD PASS GRIND (200 GRIT CERAMIC PAD)
- 4. 4TH PASS GRIND (400 GRIT CERAMIC PAD) 5. 5TH PASS GRIND (800 GRIT CERAMIC PAD)
- c. SEAL FLOOR. 1. USE DIVERSEY PLAZA PLUS (OR APPROVED EQUAL)
- 6. WOOD FLOOR NOTES:
- A. EXISTING WOOD FLOOR IN THE VAN CURLER ROOM SHALL BE PREPARED AND REFINISHED PER SPECIFICATIONS.
- . WINDOW SHADES:
- A. WINDOW SHADES SHALL BE "WINDOWS, SHADES AND MORE" SCHENECTADY, NY (OR APPROVED EQUAL).
- B. SHADE SYSTEMS SHALL INCLUDE ALL REQUIRED COMPONENTS FOR MANUAL OPERATION, INCLUDING LIFT ASSIST MECHANISM BASED ON OPENING SIZE. SHADE SYSTEMS SHALL BE COMPLETE WITH INTEGRAL FASCIAS.
- C. WINDOW SHADES SHALL BE PROVIDED AT WINDOWS AS FOLLOWS: a. ELSTON HALL AND SECURITY OFFICES:
- 1. PROVIDE (1) SHADE PER WINDOW
 - 1. LIGHT FILTERING (3%), COLOR TO BE SELECTED (OFF-WHITE) 2. PROVIDE TRANSLUCENT VINYL FILM FOR HALFMOON TRANSOM WINDOW ABOVE
- 8. WINDOW TREATMENTS:
- A. SEE ALLOWANCES FOR WINDOW TREATMENTS. WINDOW TREATMENTS SHALL BE PROVIDED
- 9. PICTURE RAIL ART SUSPENSION SYSTEM:
 - a. MOHAWK ROOM 1. PROVIDE SYSTEMATIC ART - CLICK ART DECO MODEL
 - 2. PROVIDE SUSPENSION COMPONENTS FOR (16) SIXTEEN TOTAL PIECES OF ARTWORK
 - A. SUSPENSION COMPONENTS SHALL INCLUDE ALL ITEMS REQUIRED TO SUSPEND THE ARTWORK
 - INCLUDING BUT NOT LIMITED TO HOOKS/RODS, CABLES, HARDWARE CONNECTION TO FRAME B. SUSPENSION CABLES SHALL BE COBRA CABLES.


Mohawk Room Door Repair Notes:

- 1. MAINTAIN EXISTING DOOR HARDWARE. EXISTING DOOR HARDWARE SHALL BE REFURBISHED TO LIKE NEW CONDITION.
- A) HINGE PINS SHALL BE REMOVED, CLEANED AND LUBRICATED TO ALLOW SMOOTH AND NOISE FREE OPERATION B) KNOBS AND LEVERS SHALL BE RESTORED AND REFINISHED INCLUDING ANY ASSOCIATED PUSH
- C) DEADBOLTS SHALL BE REMOVED AND REPLACED WITH COVER TO MATCH POOR PAINT.
- 2. DOORS SHALL BE SANDED SMOOTH AND DEBRIS REMOVED.
- 3. WHERE DINGS/DENTS OCCUR ON THE DOOR AND OTHER AREAS OF REPAIR/RESTORATION DOORS SHALL BE FILLED/MOLDED WITH EXPOXY FILLER PUTTY (OR APPROVED EQUAL) AND SANDED TO RESTORE THE ORIGINAL PROFILE.
- 4. PREP DOORS AS REQUIRED FOR NEW PAINT.

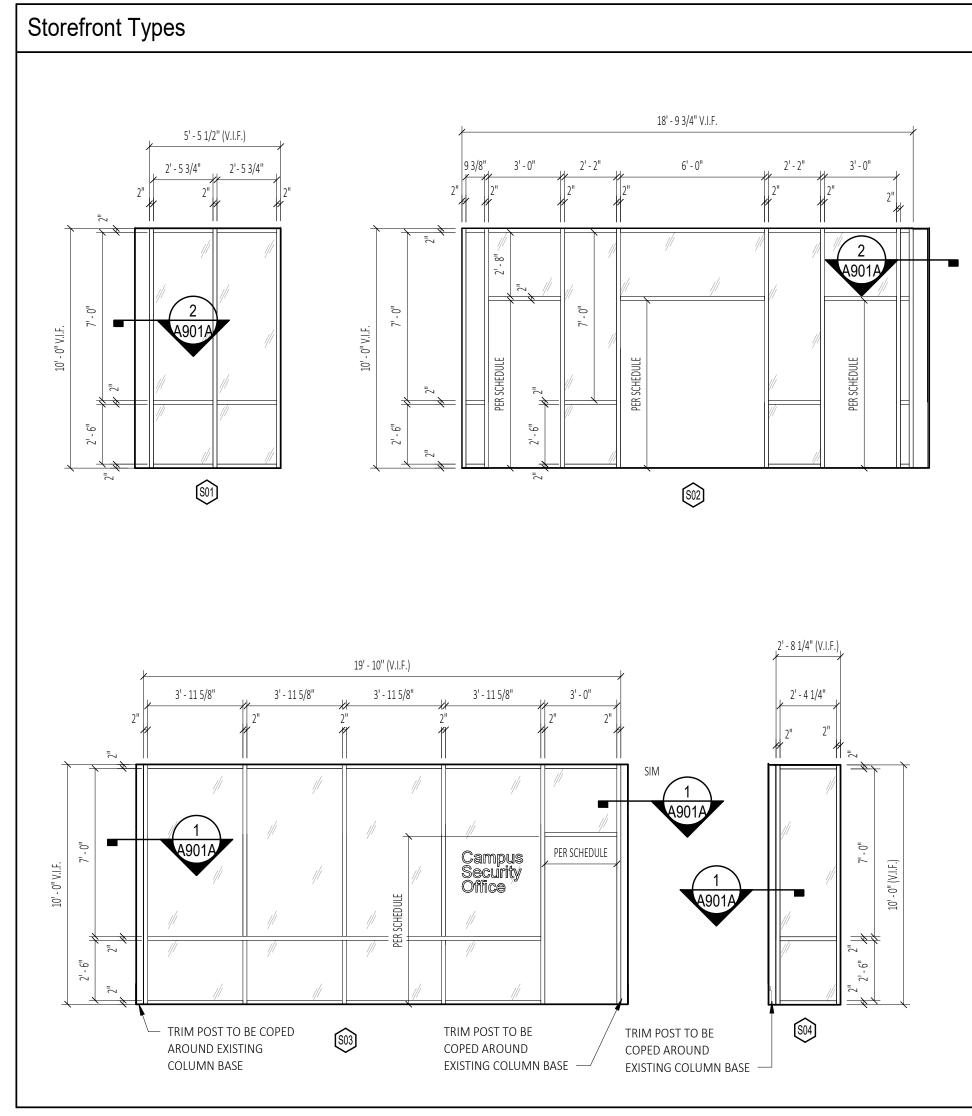

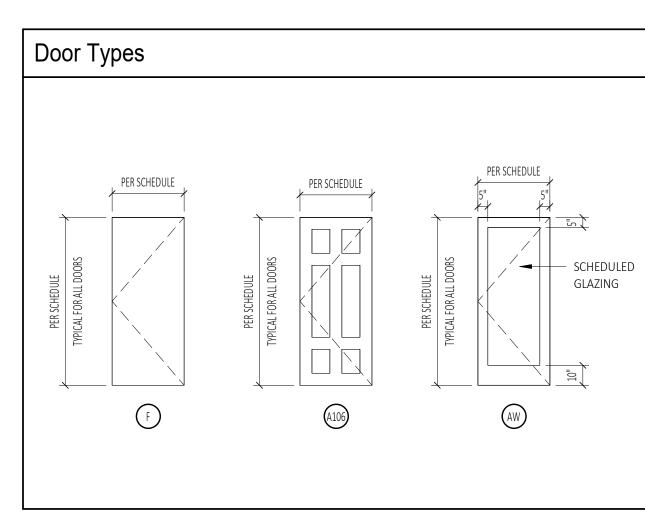

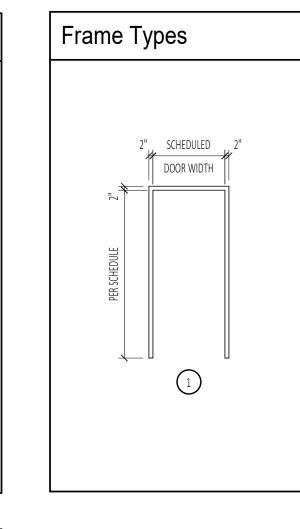


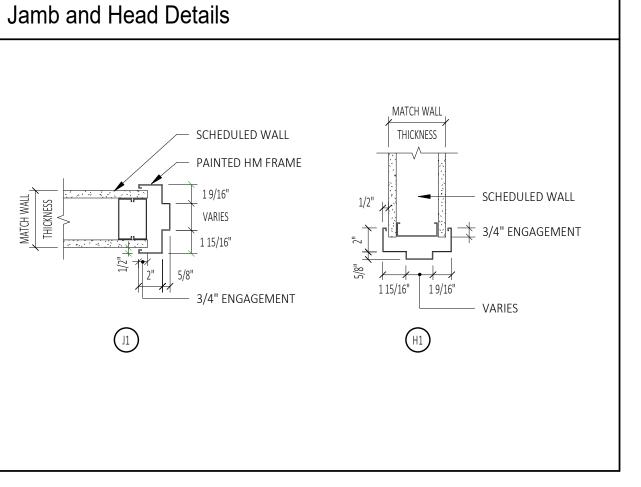



- LINE OF GYPSUM


BOARD HEADER /

SOFFIT ABOVE

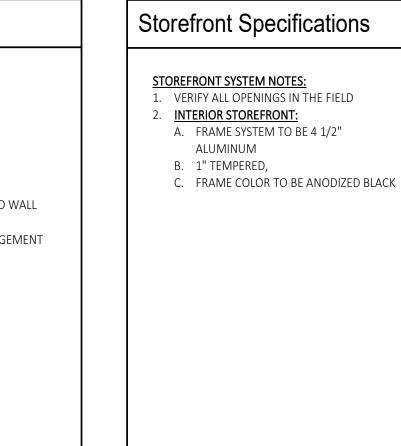

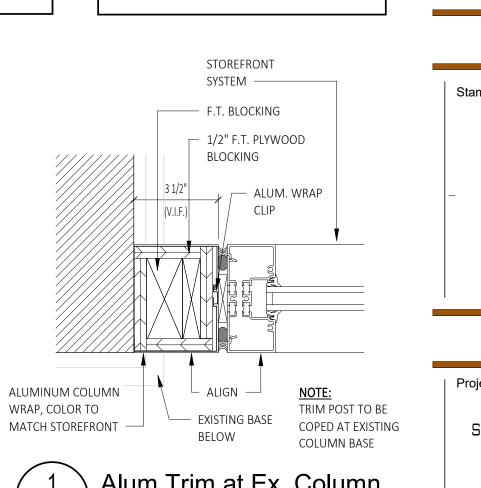

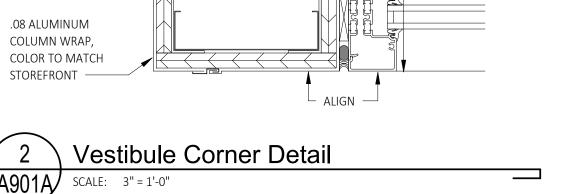

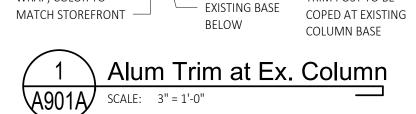

Iston H	all Lobby Finish Legend				
inish No.	Manufacturer	Series Style Color	Size	Location	Comments
OUSTICAL CE	EILING TILE				
ACT-21	USG	MARS HIGH-NRC PANELS FLB 86347 WHITE	24" X 24"	ULTILITY, SECURITY, OFFICE CEILING	
ACT-GRD	USG	FINELINE DXF	-	ULTILITY, SECURITY, OFFICE CEILING	
RPET					
CPT-21	SHAW CONTRACT	INTENT 08530 SKYLIGHT	24" X 24"	ULTILITY, SECURITY, OFFICE	MONOLITHIC INSTALLATION
TRANCE FLO	ORING				
EF-21	MILLIKEN	OBEX TILE CUTX-FIZZ FZX118-119 DARK GREY	19.69" X 19.69"	VESTIBULE	
INT					
PT-21	SHERWIN WILLIAMS	SW 7558 MEDICI IVORY	-	CEILING	FLAT FINISH
PT-22	SHERWIN WILLIAMS	SW 7569 STUCCO	-	COLUMNS	SEMI-GLOSS FINISH
PT-23	SHERWIN WILLIAMS	SW 9180 AGED WHITE	-	FIELD	EGGSHELL FINISH
PT-24	SHERWIN WILLIAMS	SW 7039 VIRTUAL TAUPE	-	TRIMS (DARK)	SEMI-GLOSS FINISH
PT-25	SHERWIN WILLIAMS	SW 9180 AGED WHITE	-	TRIMS (LIGHT)	SEMI-GLOSS FINISH
PT-26	SHERWIN WILLIAMS	SW 7558 MEDICI IVORY	-	CROWN MOLDING	SEMI-GLOSS FINISH
PT-27	SHERWIN WILLIAMS	SW 6990 CAVIAR	-	BALUSTERS	SEMI-GLOSS FINISH
PT-28	SHERWIN WILLIAMS	SW 6804 DIGNITY BLUE	-	SECURITY (ACCENT WALL)	EGGSHELL FINISH
PT-29	SHERWIN WILLIAMS	SW 7558 MEDICI IVORY	-	DOORS	SEMI-GLOSS FINISH
PT-30	SHERWIN WILLIAMS	SW 7558 MEDICI IVORY	-	DOOR FRAMES	SEMI-GLOSS FINISH
ASTIC LAMIN	ATE				
PL-4	WILSONART	SOLICOR MATTE FINISH LINEN D427-60	-		
PL-5	NEVAMAR	THRUCOLOR REGIMENTAL BLUE S3016T	-		
BBER BASE					
RB-21	ROPPE	CONTOURS PROFILE WALL BASE FASHION #85 PV6085 100 BLACK	6 1/4" HIGH	SECURITY, OFFICE	
LID SURFACE					
SS-1	WILSONART	DESIGNER WHITE D354SL	3/4" (UNO)	AS SPECIFIED	
SS-2	WILSONART	GREY BEOLA 9218CM	3/4" (UNO)	AS SPECIFIED	
ALLCOVERING	<u> </u>				
WC-21	SURFACE MATERIALS	DE NOVO CANYON LINEN DN2-CNL-16 VERMILLION CLIFFS	-	SEE ELEVATION	

STOREFRONT SYSTEM →

6" METAL STUD BOX

5/8" F.T PLYWOOD -




Owner: SUNY SCCC 78 Washington Ave. Schenectady, NY 12305

SC Office of Facilities: Schenectady County 620 State Street Schenectady, NY 12305 518.388.4200

Architect: C2 Architecture, PC 24 Airport Road Schenectady, NY 12302 T: 518.320.8250

M/E/P Engineer: M/E Engineering 433 State Street, 4th Floor Schenectady, NY 12305 T: 518.533.2171

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SUNY SCCC ELSTON HALL LOBBY & MOHAWK ROOM RENOVATIONS
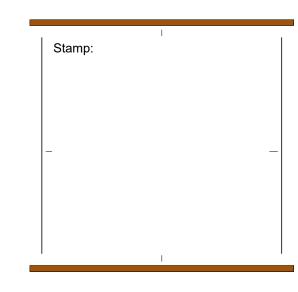
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> Drawn By: C2 Architecture As Noted 04/19/2024 Job No: Sheet Title: SCHEDULES-ELSTON HALL LOBBY

Sheet Number:

PLOT DATE: 4/26/2024 9:34:21 AM

PHOTO 5 | ENTRANCE TO LOBBY



PHOTO 4 | TYPICAL WALL CONDUIT



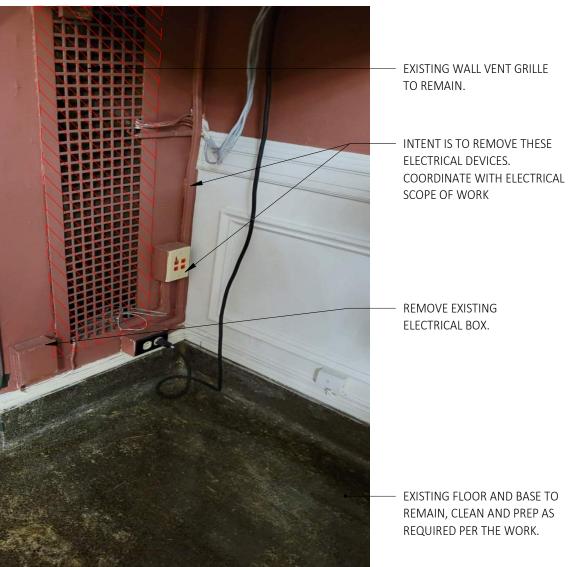


PHOTO 2 | AV AT MID-ROOM OPENING



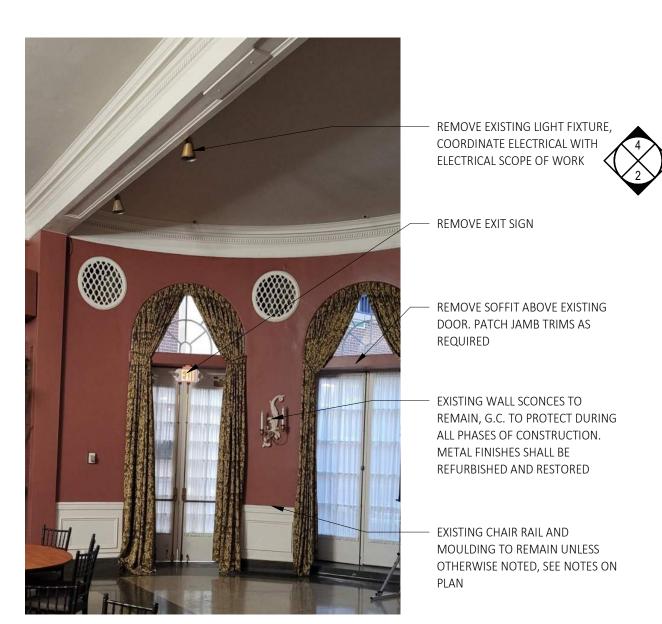


PHOTO 1 | WINDOW TREATMENTS

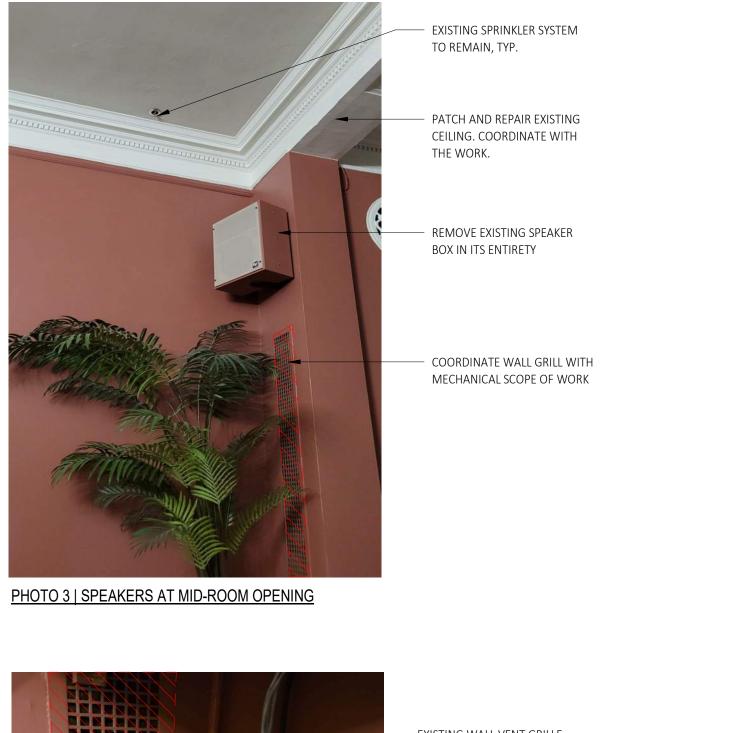

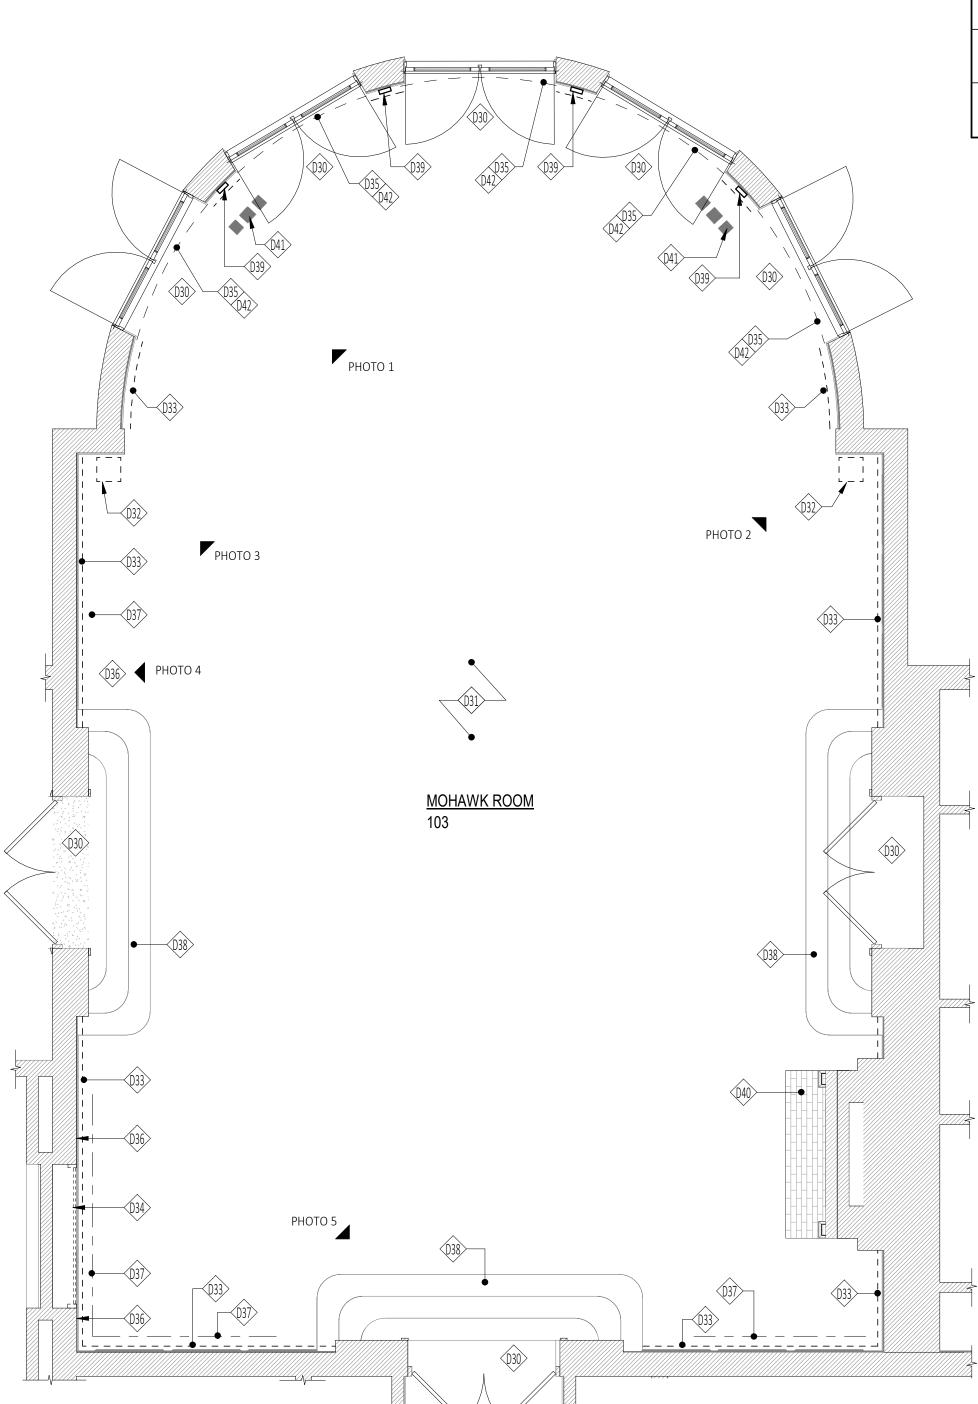

Supplemental Demolition Notes | Mohawk Room Only

3) REMOVE ALL EXISTING DRAPERIES, CURTAINS AND CURTAIN RODS. SALVAGE TO OWNER.

MAY REQUIRE SELECTIVE REMOVALS OF CEILING AREAS TO ALLOW CIRCUITING AND ACCESS.

4) REFERENCE ELECTRICAL PLANS FOR ELECTRICAL SCOPE OF WORK. INSTALLATION OF NEW LIGHTING


6) FOR BID PURPOSES, ASSUME ALL MISCELLANEOUS FURNISHINGS SHALL BE REMOVED AND STORED


OF THE BID WITH NO ADDITIONAL COSTS TO THE OWNER.

BY THE OWNER.

5) REMOVE AND SALVAGE ALL WIFI AND AV DEVICES BACK TO OWNER.

1) ALL REMOVALS SHALL BE COORDINATED WITH THE OVERALL SCOPE OF WORK. ANY REMOVAL REQUIRED TO ALLOW THE DESIGN INTENT AND SCOPE OF WORK TO BE COMPLETED SHALL BE PART

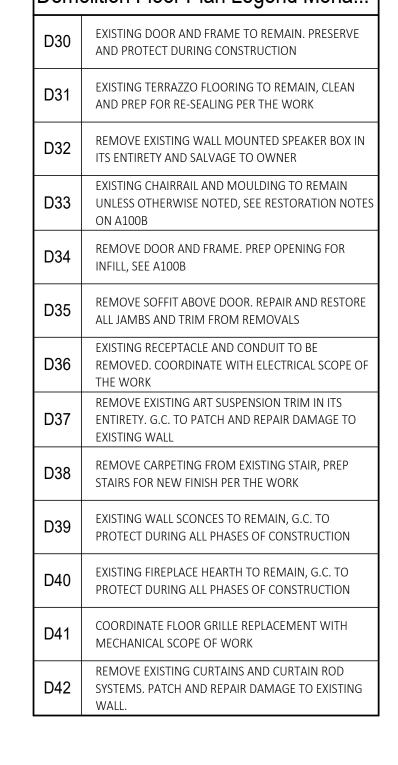

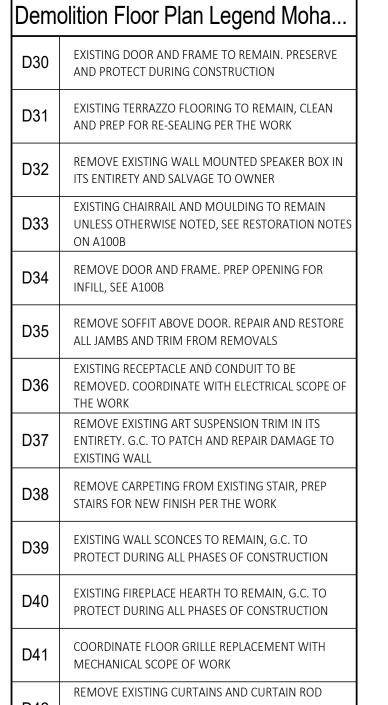

DESIGN GROUP

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24 AIRPORT ROAD

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SUNY SCCC

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620 State Street

518.388.4200

Architect:

SUNY SCCC ELSTON HALL LOBBY & MOHAWK ROOM RENOVATIONS

78 Washington Ave Schenectady, NY 12305



Dra	wn By:	C2 Architecture
Sca	le:	As Noted
Date	э:	04/19/2024
Job	No:	2349
She	et Title:	

Mohawk Room Demolition PLAN


---- CHAIRRAIL

— — — ART SUSPENSION SYSTEM

_ _ _ _ CURTAIN SYSTEM

Sheet Number:

Demolition Plan - Mohawk Room TRUE NORTH PROJECT NORTH

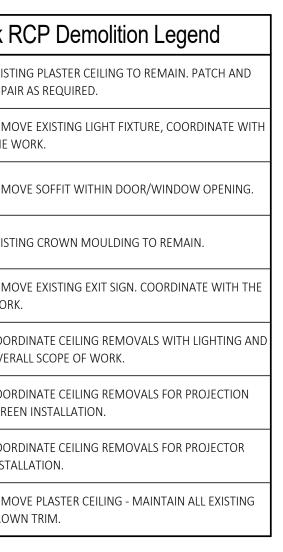



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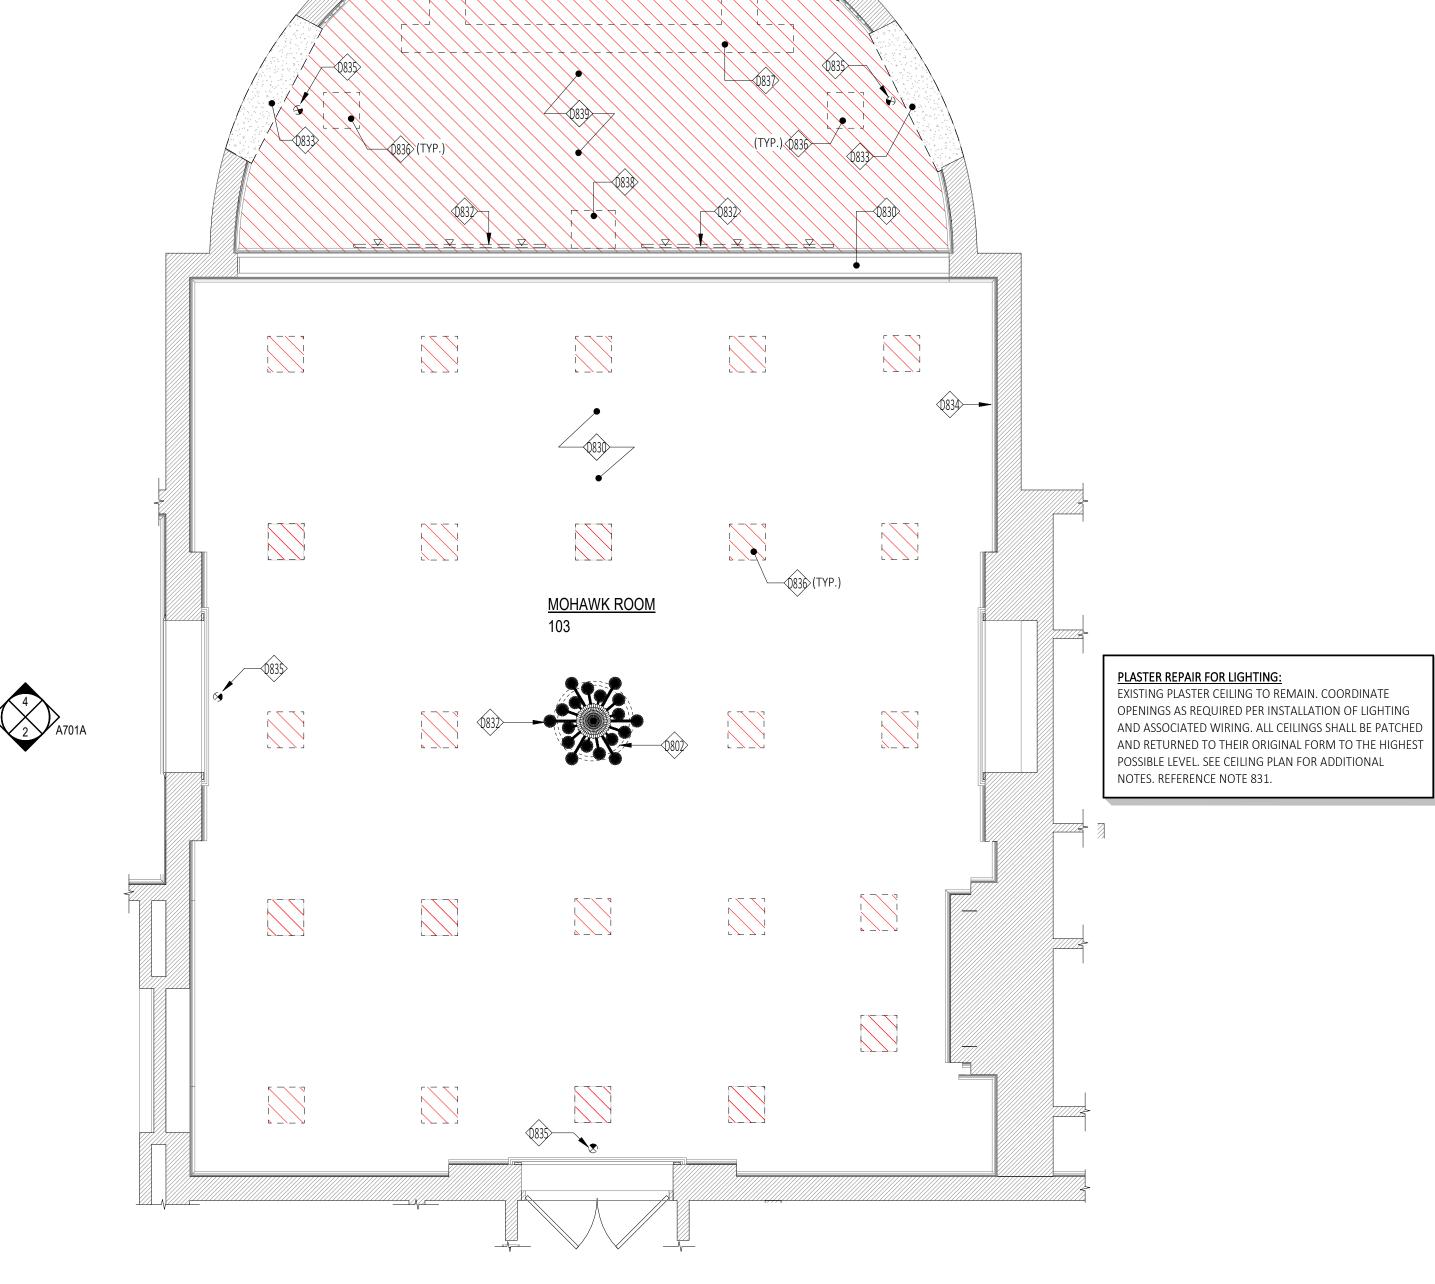
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Scale:		As Noted
Date:		04/19/2024
Job No:		2349
Sheet Title:		
Mohawk	Rоом	CEILING

DEMOLITION PLAN


Sheet Number:

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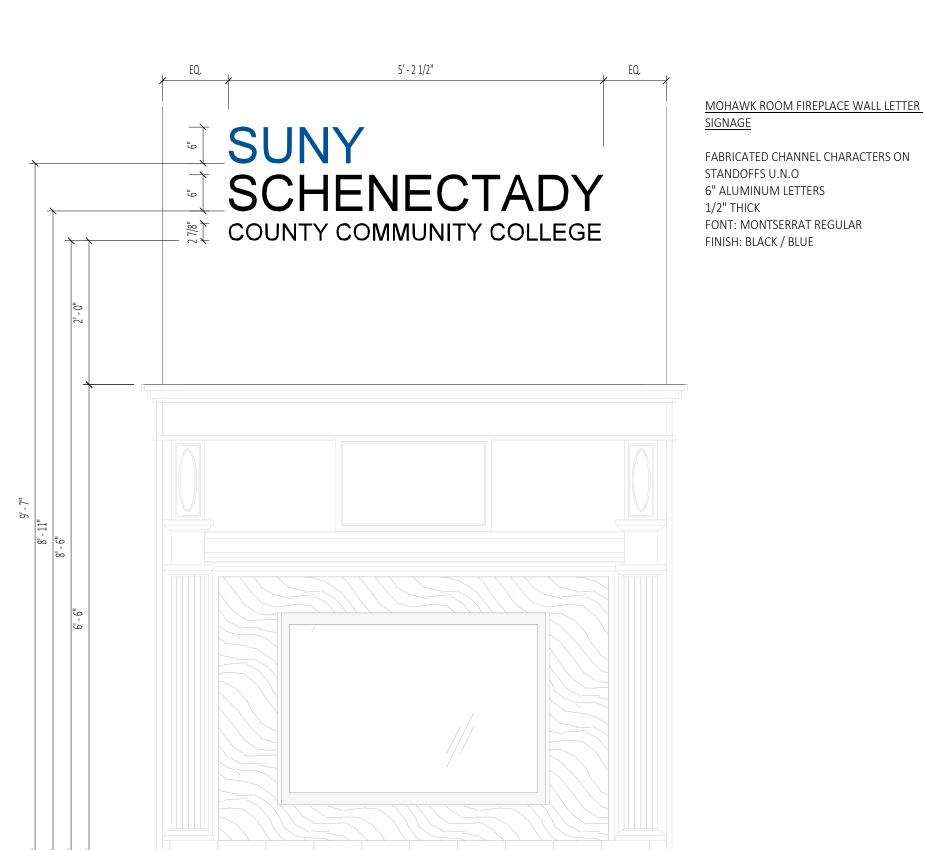







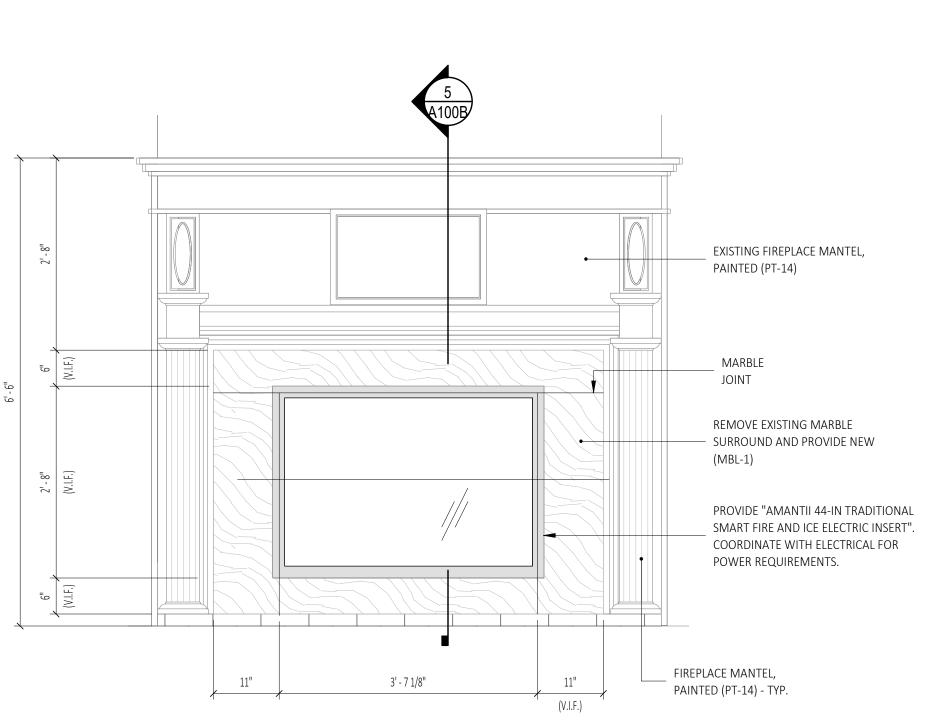


A100B SCALE: 3/4" = 1'-0"





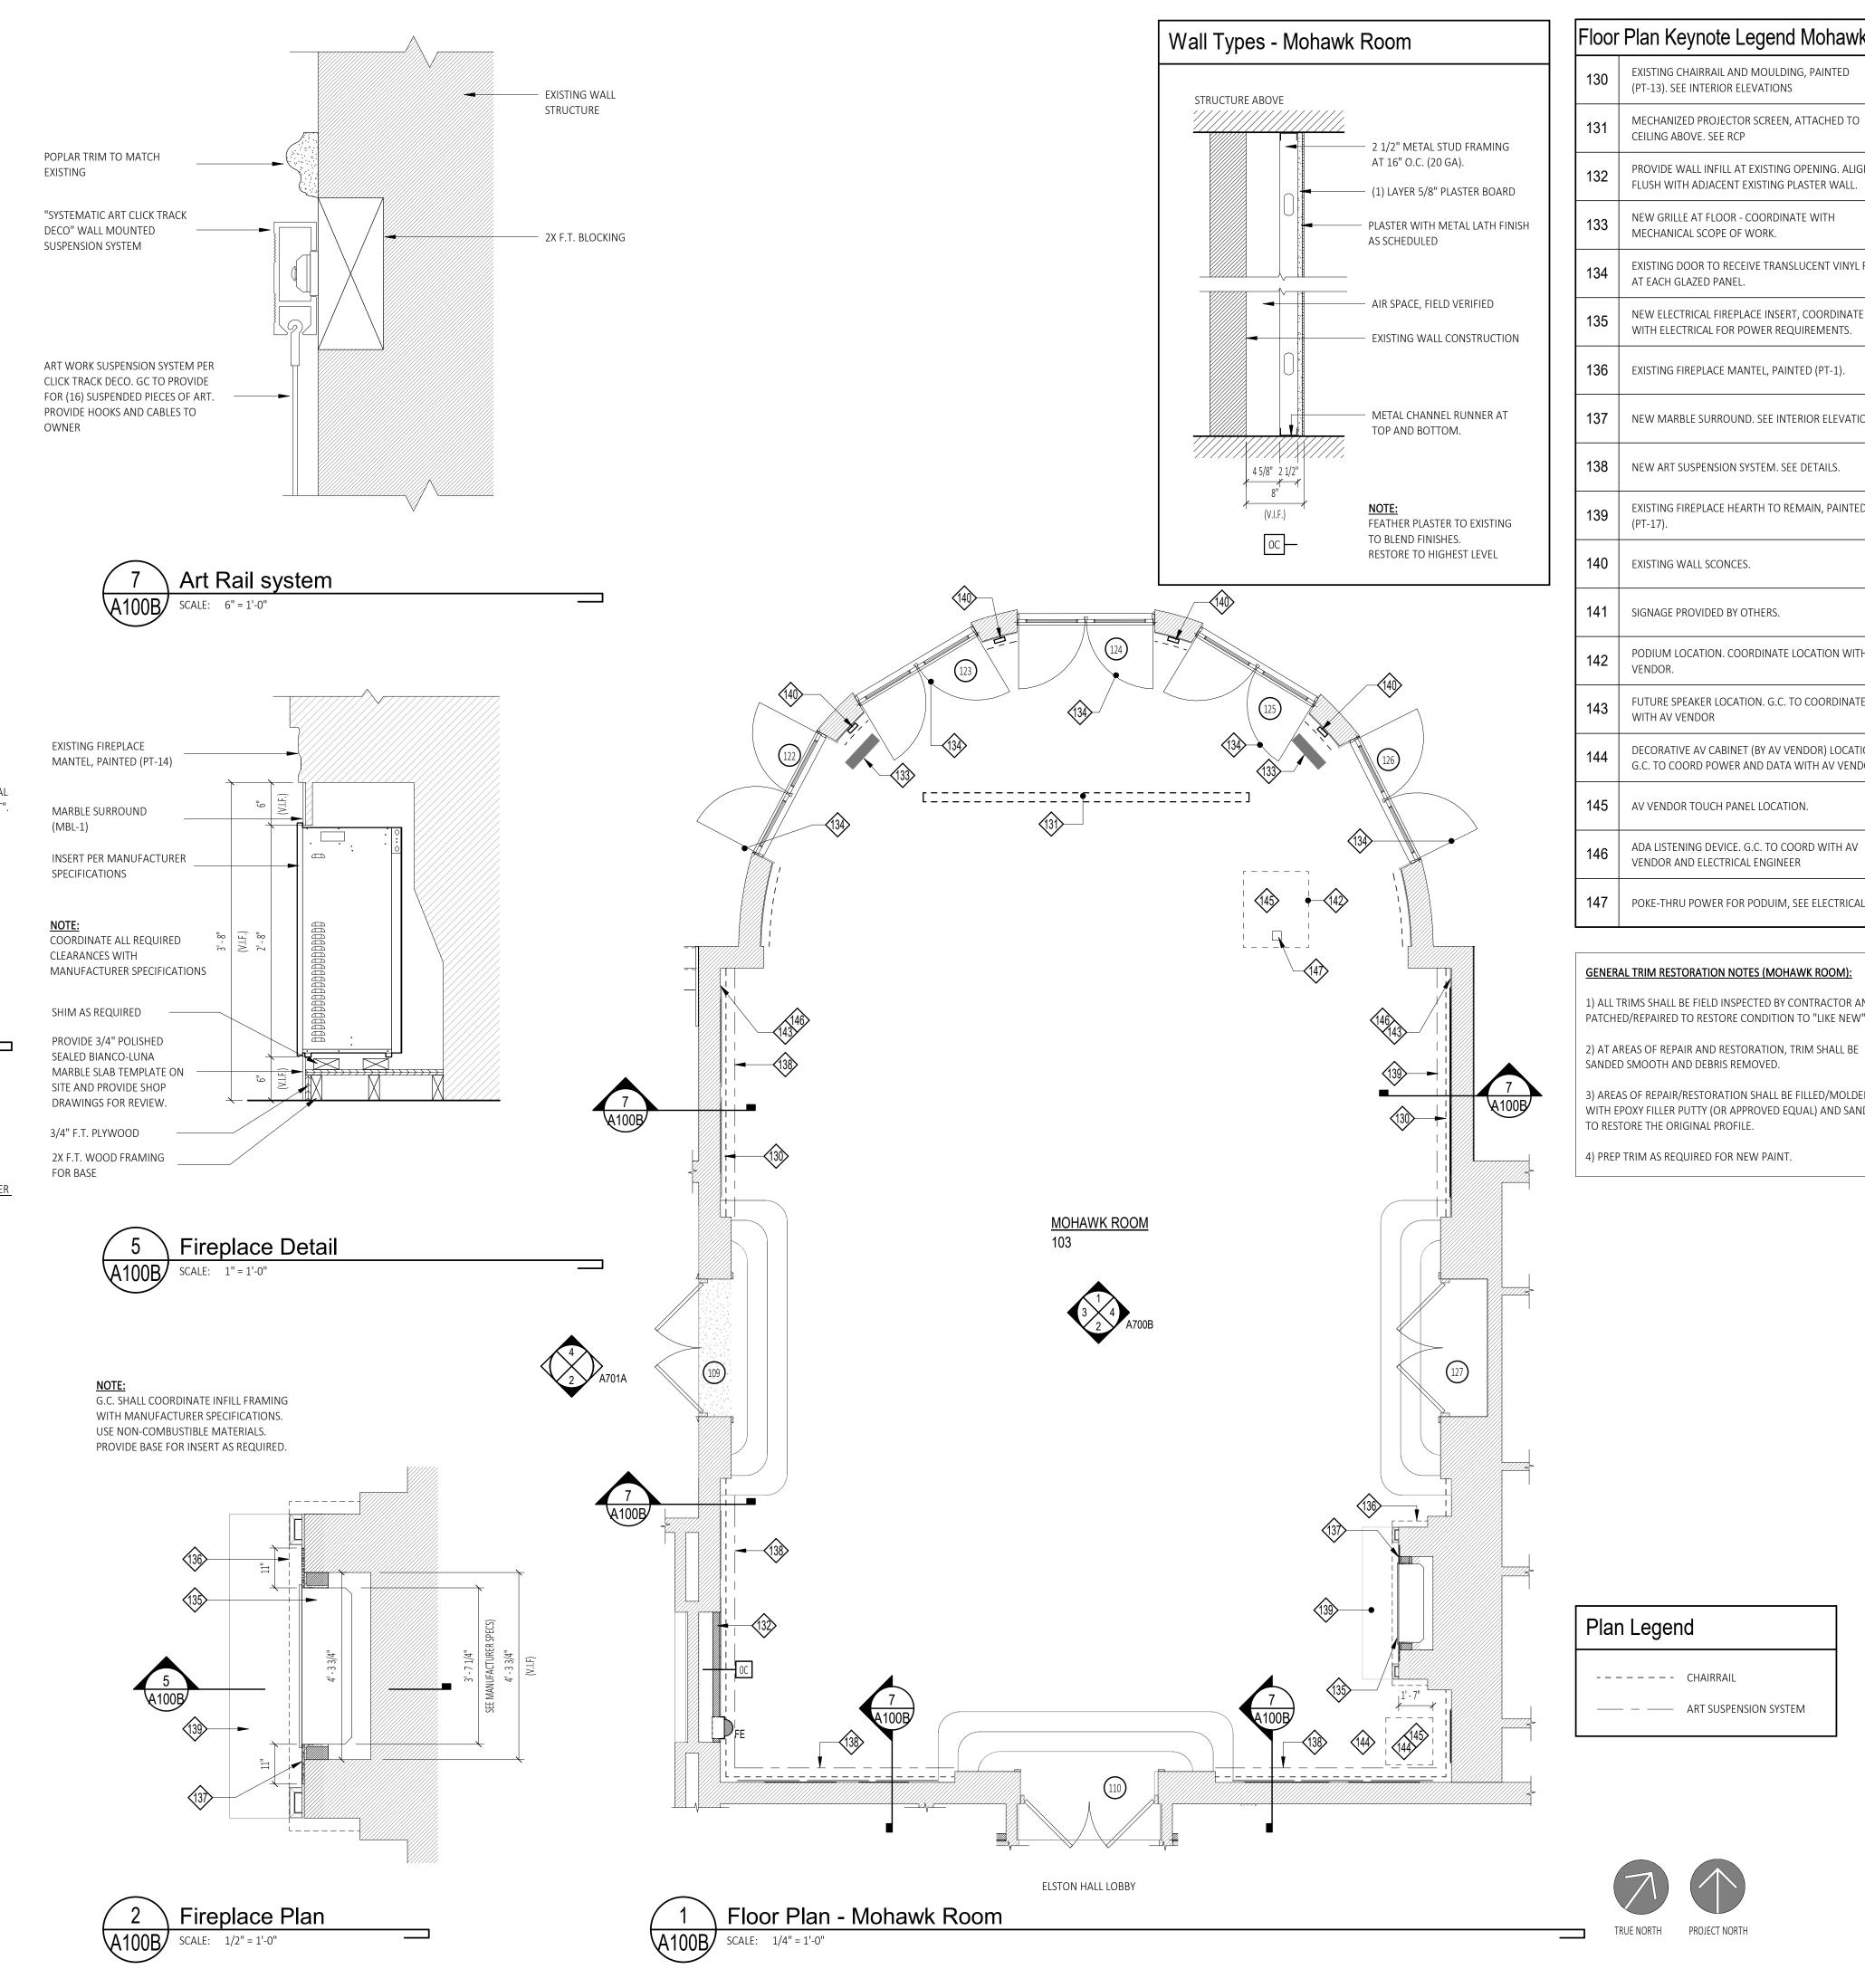

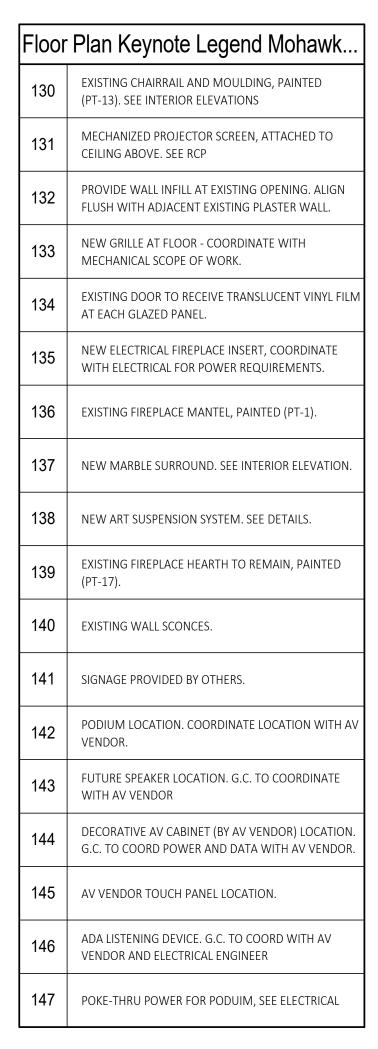



1) ALL TRIMS SHALL BE FIELD INSPECTED BY CONTRACTOR AND PATCHED/REPAIRED TO RESTORE CONDITION TO "LIKE NEW".

SANDED SMOOTH AND DEBRIS REMOVED.

PROJECT NORTH

3) AREAS OF REPAIR/RESTORATION SHALL BE FILLED/MOLDED WITH EPOXY FILLER PUTTY (OR APPROVED EQUAL) AND SANDED TO RESTORE THE ORIGINAL PROFILE.

4) PREP TRIM AS REQUIRED FOR NEW PAINT.

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Architect:

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SUNY SCCC ELSTON HALL Lовву & Монаwk Room RENOVATIONS

78 Washington Ave Schenectady, NY 12305


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MOHAWK ROOM FLOOR PLAN

Sheet Number:

A100B



4 Interior Elevation - Mohawk Room (East)

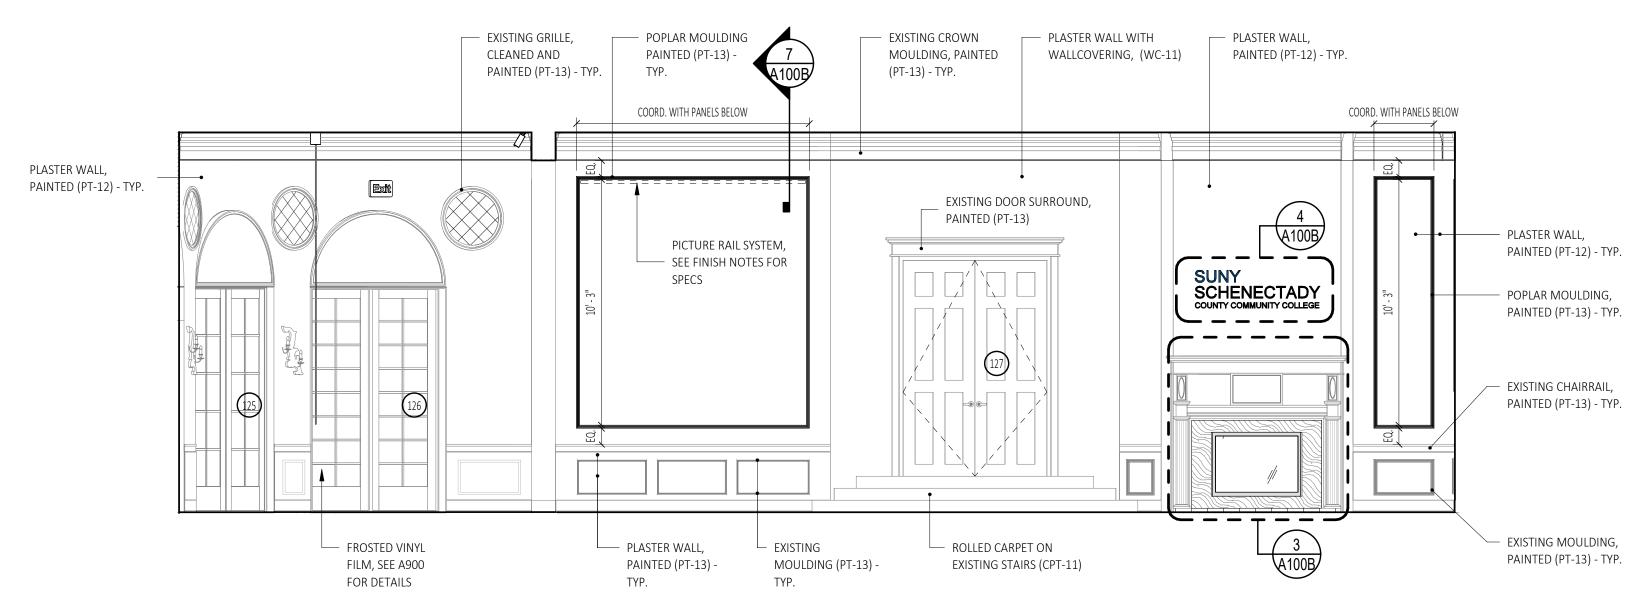
PICTURE RAIL SYSTEM, SEE – PLASTER WALL WITH EXISTING CROWN PICTURE RAIL - EXISTING GRILLE, FINISH NOTES FOR SPECS WALLCOVERING MOULDING, PAINTED SYSTEM, SEE FINISH PAINTED (PT-13) NOTES FOR SPECS (WC-11) (PT-13) PLASTER WALL, PAINTED POPLAR WALL (PT-12) MOULDING, PAINTED (PT - 13) - TYP. —— PLASTER WALL, PAINTED (PT-12)- TYP. COORD. WITH PANELS BELOW 9' - 8 1/2" COORD. WITH PANELS BELOW CHAIR RAIL, PAINTED (PT-13) - TYP. L PLASTER WALL, PLASTER WALL, PAINTED FROSTED VINYL FILM, SEE └─ EXISTING MOULDING, PAINTED (PT-13) - TYP. PAINTED (PT-13) DIMENSION IS TO MATCH A900 FOR DETAILS - EXISTING DOOR **EXISTING TRIM OFFSET** (PT-13) - TYP. PLASTER WALL, PAINTED SURROUND, PAINTED DIMENSION ON OPPOSITE WALL

(PT-13)

3 Interior Elevation - Mohawk Room (West)
A700B SCALE: 1/4" = 1'-0"

m (West)

(PL-13) - TYP.

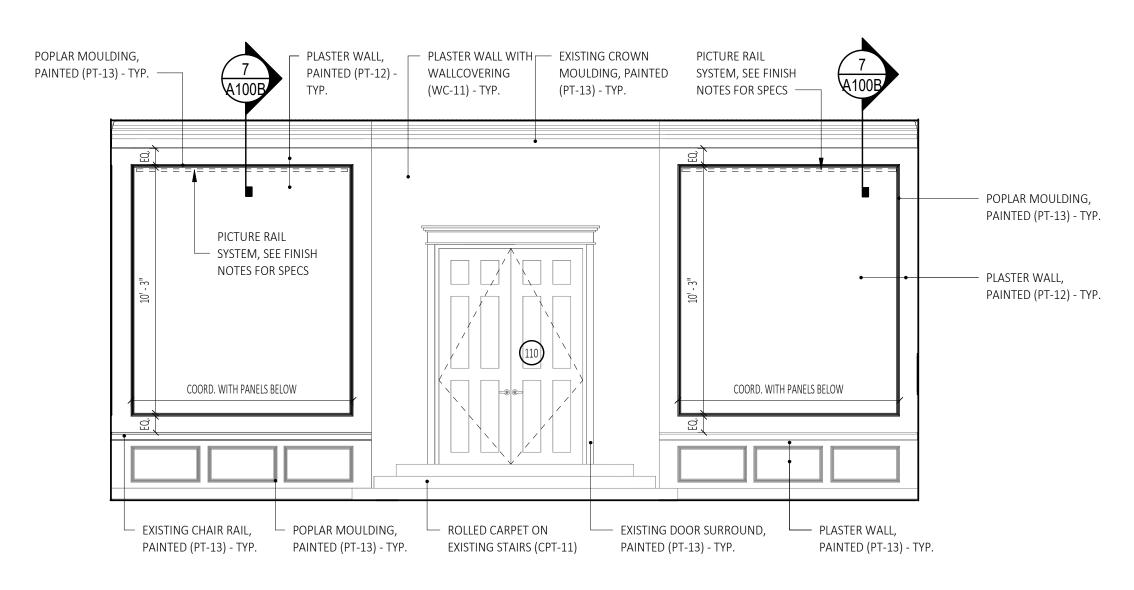

2 Interior Elevation - Mohawk Room (South)

 EXISTING CROWN MOULDING EXISTING GRILLE, PAINTED (PT-13) - TYP. PAINTED (PT-13) - TYP. PLASTER WALL, PAINTED (PT-12) - TYP. EXISTING GRILLE, PAINTED (PT-12) -EXISTING CHAIRRAIL, PAINTED (PT-13) - TYP. EXISTING CHAIRRAIL, FROSTED VINYL FILM, SEE PAINTED (PT-13) - TYP. DETAIL - EXISTING TRIM AND PLASTER WALL BENEATH CHAIRRAIL PAINTED (PT-13).

Interior Elevation - Mohawk Room (North)

A700B SCALE: 1/4" = 1'-0"



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INTERIOR ELEVATIONS MOHAWK ROOM

Sheet Number:

A700B

PLOT DATE: 4/26/2024 9:33:56 AM

ivionaw	vk Room Light Fixt	ure Schedule			
TYPE	DESCRIPTION	MANUFACTURER	SPECIFICATION	COLOR (K/RGB)	COMMENTS
F10	RECESSED DOWNLIGHT	ALPHABET	NU3-RDDR-SW-2020LM-30K-90-50D-HET-WH-WH-RET-UNV-DIM10	3000	
F10EM	RECESSED DOWNLIGHT	ALPHABET	NU3-RDDR-SW-2020LM-30K-90-50D-HET-WH-WH-RET-UNV-DIM10-EM12	3000	BATTERY BACK-UP
F11A	TRACK SYSTEM	BRUCK LIGHTING	370GES-208-WH-COMPONENTS	-	
F11B	TRACK HEAD	BRUCK LIGHTING	LX-PRO-SPOT-15LM-30K-90-DZ2-HET-NA-WH-ECOH-VOLT-DIM10	3000	
F12	CHANDELIER	-		3000	SEE ALLOWANCES
EX-1	EXIT SIGN (CEILING)	ACUITY BRANDS	EDGR-W-1-G-EL	-	BATTERY BACK-UP
F10W	RECESSED DOWNLIGHT	ALPHABET	NUR3-RW-SW-20LM-30K-90-WW-WH-WH-RET-UNV-DIM10	3000	

1 Reflected Ceiling Plan - Mohawk Room

800B SCALE: 1/4" = 1'-0"

	Се
-S	83
	83
	83


Ceili	ng Plan Keynote Legend Mohawk
830	EXISTING CROWN MOULDING, PAINTED (PT-11)
831	EXISTING PLASTER CEILING TO BE PATCHED AND REPAIRED WITH SPRAY APPLIED LEVEL 5 FINISH AND PAINTED (PT-11)
832	EXISTING CEILING MEDALLION, PAINTED (PT-11)
833	SURFACE MOUNTED MOTORIZED PROJECTOR SCREEN, G.C. TO COORDINATE POWER WITH ELECTRICAL.

SURFACE MOUNTED PROJECTOR. G.C. TO COORDINATE INSTALLATION WITH AV CONSULTANT. G.C. TO COORDINAT


EPOWER WITH ELECTRICAL. G.C. TO CORDINATE

835 PROVIDE NEW PLASTER STYLE CEILING ON EXISTING

INSTALLATION WITH EXISTING CEILING STRUCTURE

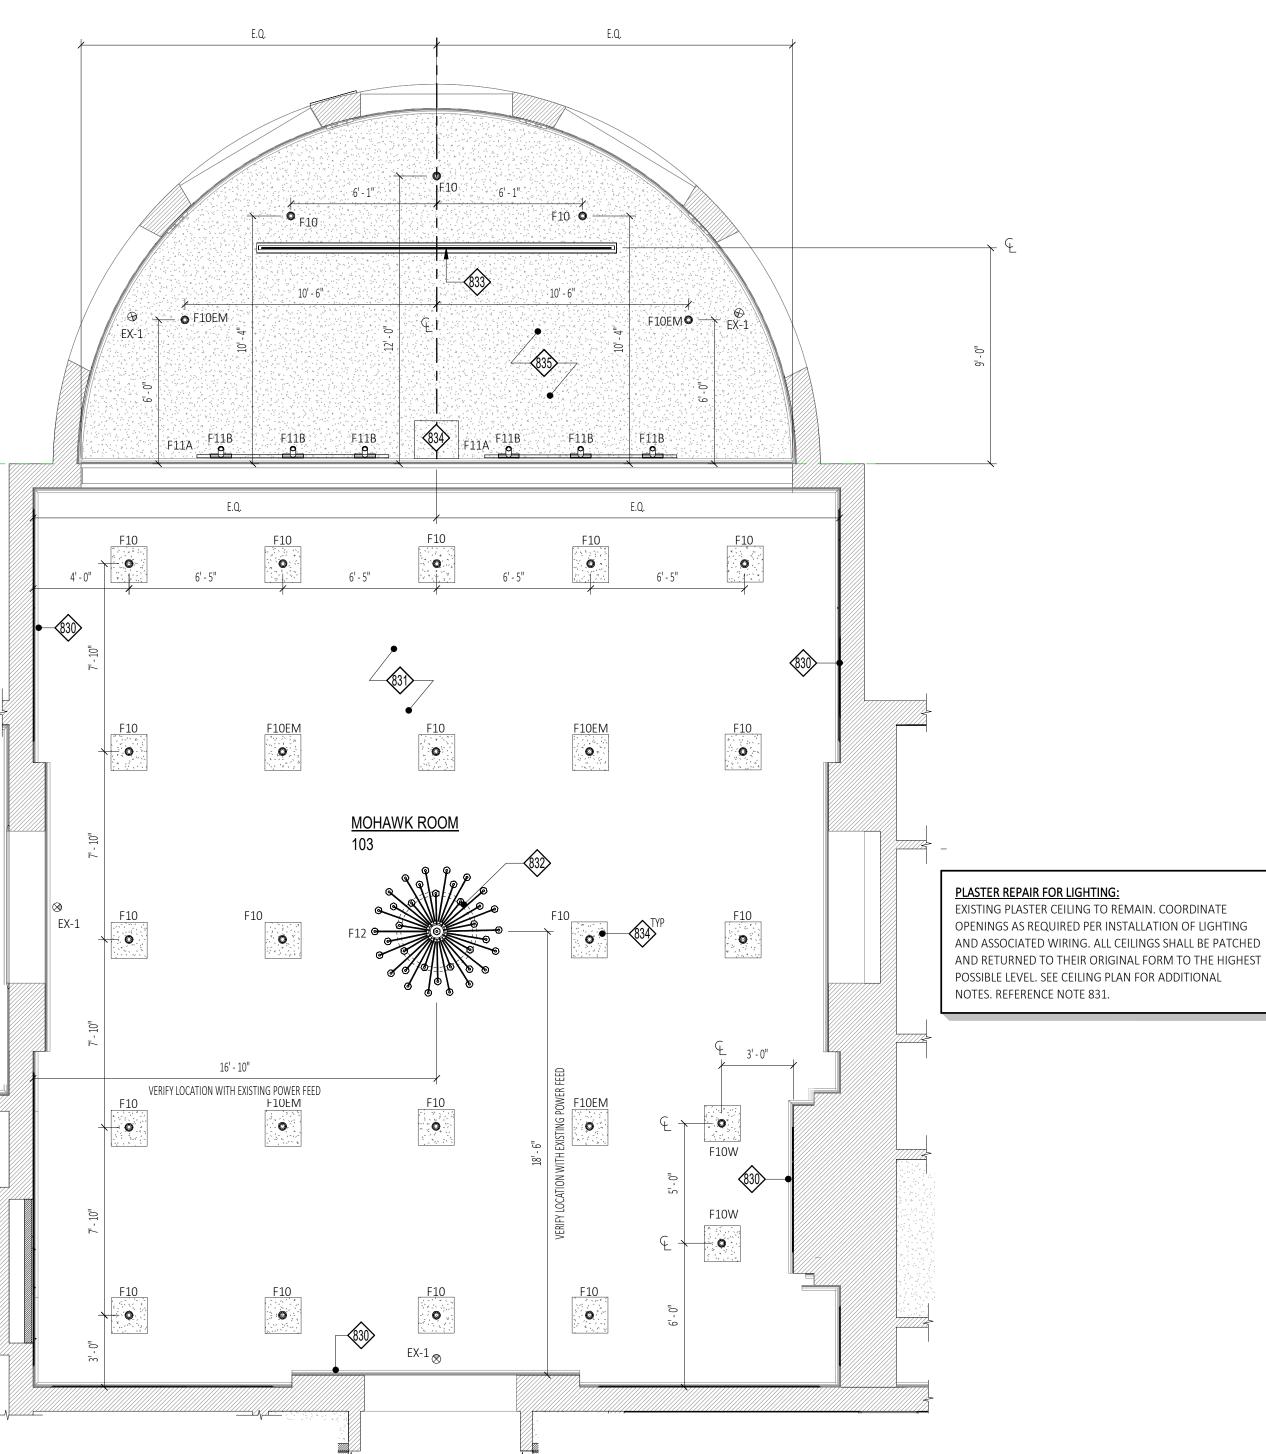



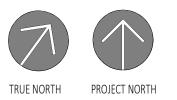



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SUNY SCCC ELSTON HALL LOBBY & MOHAWK ROOM RENOVATIONS

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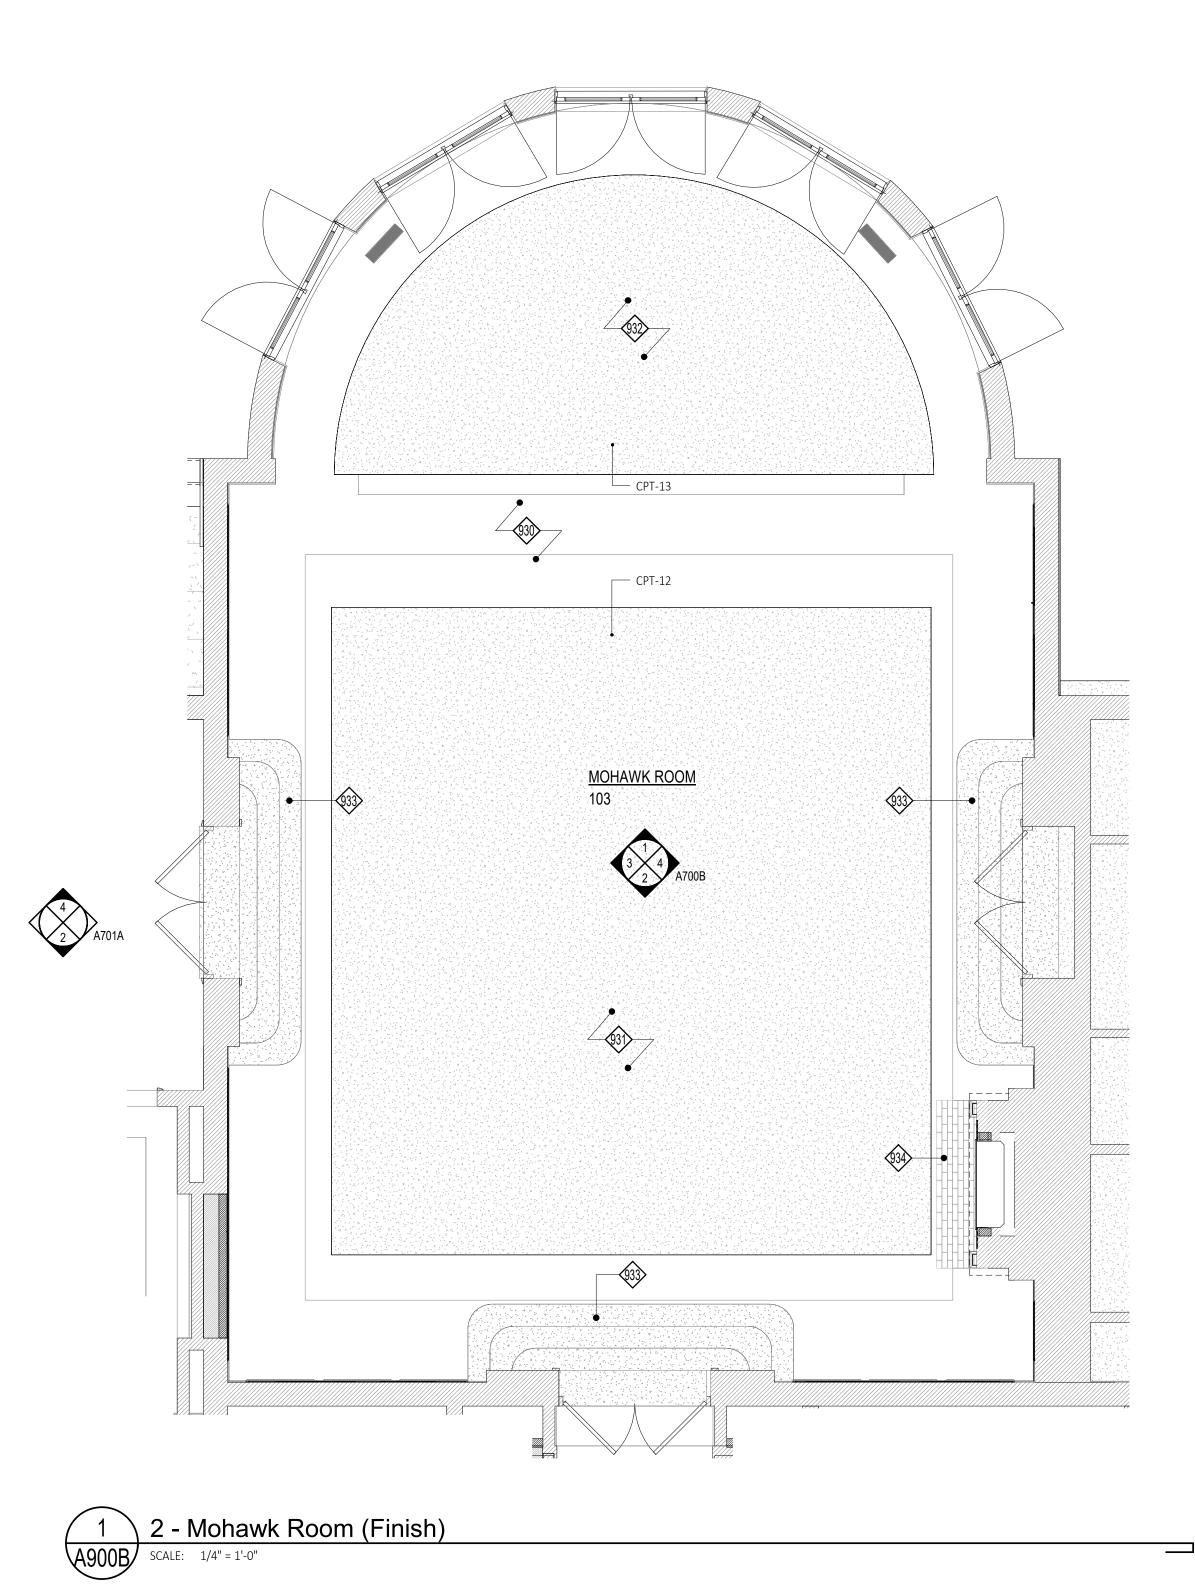
MOHAWK ROOM REFLECTED CEILING PLAN

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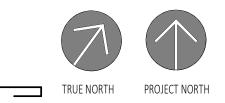
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PLOT DATE: 4/26/2024 9:33:57 AM

Finis	h Plan Keynote Legend
930	EXISTING TERRAZZO FLOOR TO BE REFINISHED, SEE FINISH NOTES.
931	AREA RUG (CPT-12)ACTUAL EXTENTS BY MANUFACTURER, CENTERED IN ROOM AS SHOWN
932	AREA RUG (CPT-13)ACTUAL EXTENTS BY MANUFACTURER.
933	EXISTING STEPS TO RECEIVE CARPET (CPT-11).
934	EXISTING FIREPLACE BRICK HEARTH PAINTED (PT-16).









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Монажк	Rоом	FINISH
	PLAN	


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PLOT DATE: 4/26/2024 9:33:58 AM

Door Schedule - Mohawk


Door No.	Door No. Location DOOR DOOR DOOR DOOR Width Total Width Height Thk. Material Fin				DOOR							FRA	AME			Hordwore	Rating	Comments	Door No.
DOOLING.				Finish	Type	Glazing	Material	Finish	Туре	Head	Jamb	Sill	Hardware	Railig	Comments	Door No.			
122	MOHAWK ROOM 100b / GATHERING SPACE	3' - 2"	6' - 4"	9' - 5"		ETR	PT-15	ETR	ETR	ETR	PT-16	ETR	-	-	-			FOR FILM DETAILS SEE A900	122
123	MOHAWK ROOM 100b / GATHERING SPACE	3' - 2"	6' - 4"	9' - 5"		ETR	PT-15	ETR	ETR	ETR	PT-16	ETR	-	-	-			FOR FILM DETAILS SEE A900	123
124	MOHAWK ROOM 100b / GATHERING SPACE	3' - 2"	6' - 4"	9' - 5"		ETR	PT-15	ETR	ETR	ETR	PT-16	ETR	-	-	-			FOR FILM DETAILS SEE A900	124
125	MOHAWK ROOM 100b / GATHERING SPACE	3' - 2"	6' - 4"	9' - 5"		ETR	PT-15	ETR	ETR	ETR	PT-16	ETR	-	-	-			FOR FILM DETAILS SEE A900	125
126	MOHAWK ROOM 100b / GATHERING SPACE	3' - 2"	6' - 4"	9' - 5"		ETR	PT-15	ETR	ETR	ETR	PT-16	ETR	-	-	-			FOR FILM DETAILS SEE A900	126
127	MOHAWK ROOM 100b	3' - 0"	6' - 0"	9' - 0"	0' - 1 3/4"	ETR	PT-15	ETR	ETR	ETR	PT-16	ETR	-	-	-				127

Mohawk	Room Finish Legend				
Finish No.	Manufacturer	Series Style Color	Size	Location	Comments
CARPET			-		
CPT-11	SHAW CONTRACT	SHADE BROADLOOM GRADIENT 34761 BIRD'S EYE	-	STAIRS	
CPT-12	SHAW CONTRACT	CULTIVATE SOUL BROADLOOM ADAGE ULTRALOC MB 27585 VIRTUE	27' LONG X 25' WIDE		
CPT-13	SHAW CONTRACT	CULTIVATE SOUL BROADLOOM ADAGE ULTRALOC MB 27585 VIRTUE	13' LONG X 25' WIDE		HALF ROUND
MARBLE	•		·		
MBL-1	-	POLISHED BINACO-LUNA	-	FIREPLACE SURROUND	
PAINT	•				
PT-11	SHERWIN WILLIAMS	SW 7558 MEDICI IVORY	-	CEILING	FLAT FINISH
PT-12	SHERWIN WILLIAMS	SW 7637 OYSTER WHITE	-	FIELD, INSETS	EGGSHELL FINISH
PT-13	SHERWIN WILLIAMS	SW 7558 MEDICI IVORY	-	TRIMS, WAINSCOT	SEMI-GLOSS FINISH
PT-14	SHERWIN WILLIAMS	SW 2822 DOWNING SAND	-	FIREPLACE BODY AND MANTEL	EGGSHELL FINISH
PT-15	SHERWIN WILLIAMS	SW 7558 MEDICI IVORY	-	DOORS	SEMI-GLOSS FINISH
PT-16	SHERWIN WILLIAMS	SW 7558 MEDICI IVORY	-	DOOR FRAMES	SEMI-GLOSS FINISH
PT-17	SHERWIN WILLIAMS	SW 7515 HOMESTEAD BROWN	-	FIREPLACE HEARTH	
TRANSITION ST	RIP		·		
TS-11	SHAW CONTRACT	1.31 REDUCER 144VS CLAY 00040	-	SEE FINISH PLAN	
WALLCOVERING	i .		·		·
WC-11	SURFACE MATERIALS	DE NOVO CANYON LINEN DN2-CNL-16 VERMILLION CLIFFS	-	SEE ELEVATIONS	

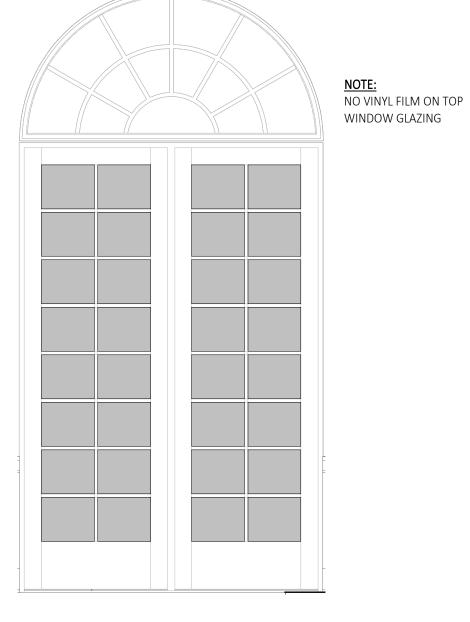


NOTE:
PROVIDE TRANSLUCENT VINYL FILM AT EACH GLAZED DOOR LITE - TYPICAL FOR DOORS OF THE SAME TYPE WITHIN THE ROOM.



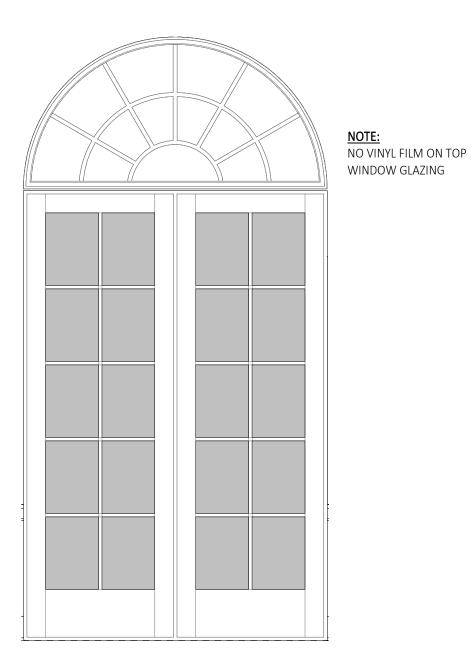

NOTE:
PROVIDE TRANSLUCENT VINYL FILM AT
EACH GLAZED DOOR LITE - TYPICAL FOR
DOORS OF THE SAME TYPE WITHIN THE
ROOM.

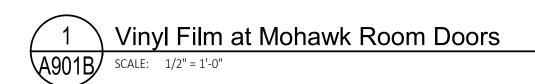

General Finish Notes

- 1. INTERIOR WALL AND CEILING FINISHES IN INTERIOR EXIT STAIRWAYS, EXIT PASSAGEWAYS, CORRIDORS, AND ENCLOSURE FOR EXIT ACCESS STAIRWAYS SHALL BE CLASS A (0-25 FLAME SPREAD INDEX; 0-450 SMOKE-DEVELOPMENT INDEX) OR BETTER, WHEN TESTED IN ACCORDANCE WITH ASTM E84-2007 OR UL 723-2003
- 2. INTERIOR WALL AND CEILING FINISHES IN SPACES OTHER THAN THOSE NOTED ABOVE SHALL BE CLASS B (25-75 FLAME SPREAD INDEX; 0-450 SMOKE DEVELOPMENT INDEX) OR BETTER, WHEN TESTED IN ACCORDANCE WITH ASTM E84-2007 OR UL 723-2003
- 3. FLOOR FINISHES SHALL COMPLY WITH THE DOC FF-1 "PILL TEST" CPSC 160CFR PART 1630-2000
- 4. GC TO PROVIDE SIGNAGE AS OUTLINED IN THE SPECIFICATIONS ALONG WITH ANY ADDITIONAL REQUIRED SIGNAGE REQUIRED BY THE AUTHORITY HAVING JURISDICTION.
 5. TERRAZZO REPAIR/CLEANING/POLISHING:


CONTRACTOR SHALL INCLUDE IN THEIR BID, ALL PREPARATION, PATCHING AND REPAIR AS NEEDED TO COMPLETE

A. TERRAZZO CONTRACTOR SHALL VISIT SITE AND INSPECT ALL TERRAZZO AREAS PRIOR TO BID. TERRAZZO

- THE DESIGN INTENT REGARDLESS IF INDICATED ON THE DRAWINGS FOR THE SCOPE OF WORK.
- B. AREAS OF TERRAZZO REPAIR SHALL BE PREPARED AS FOLLOWS:
- a. CLEAN AND STRIP EXISTING TERRAZZO AREAS.
- USE PIONEER ECLIPSI FORMULA X (OR APPROVED EQUAL)
 GRIND FLOOR
- 1. 1ST PASS GRIND (150 GRIT METAL BONDED DIAMOND PAD)
 2. 2ND PASS GRIND (100 GRIT CERAMIC PAD)
- 3. 3RD PASS GRIND (200 GRIT CERAMIC PAD)
- 4. 4TH PASS GRIND (400 GRIT CERAMIC PAD)5. 5TH PASS GRIND (800 GRIT CERAMIC PAD)
- 5. 5TH PASS GRIND (800 GRIT CERAMIC PAD)
 c. SEAL FLOOR.
- USE DIVERSEY PLAZA PLUS (OR APPROVED EQUAL)
 WOOD FLOOR NOTES:
- A. EXISTING WOOD FLOOR IN THE VAN CURLER ROOM SHALL BE PREPARED AND REFINISHED PER SPECIFICATIONS.
- A. WINDOW SHADES SHALL BE "WINDOWS, SHADES AND MORE" SCHENECTADY, NY (OR APPROVED EQUAL).

 B. SHADE SYSTEMS SHALL INCLUDE ALL REQUIRED COMPONENTS FOR MANUAL OPERATION, INCLUDING LIFT ASSIST
- MECHANISM BASED ON OPENING SIZE. SHADE SYSTEMS SHALL BE COMPLETE WITH INTEGRAL FASCIAS.

 C. WINDOW SHADES SHALL BE PROVIDED AT WINDOWS AS FOLLOWS:
- a. ELSTON HALL AND SECURITY OFFICES:
- PROVIDE (1) SHADE PER WINDOW
 LIGHT FILTERING (3%), COLOR TO BE SELECTED (OFF-WHITE)
- 2. PROVIDE TRANSLUCENT VINYL FILM FOR HALFMOON TRANSOM WINDOW ABOVE
- 8. <u>WINDOW TREATMENTS:</u>
 A. SEE ALLOWANCES FOR WINDOW TREATMENTS. WINDOW TREATMENTS SHALL BE PROVIDED
- PICTURE RAIL ART SUSPENSION SYSTEM:
 a. MOHAWK ROOM
 - 1. PROVIDE SYSTEMATIC ART CLICK ART DECO MODEL
 - 2. PROVIDE SUSPENSION COMPONENTS FOR (16) SIXTEEN TOTAL PIECES OF ARTWORK
 - A. SUSPENSION COMPONENTS SHALL INCLUDE ALL ITEMS REQUIRED TO SUSPEND THE ARTWORK INCLUDING BUT NOT LIMITED TO HOOKS/RODS, CABLES, HARDWARE CONNECTION TO FRAME
 - B. SUSPENSION CABLES SHALL BE COBRA CABLES.

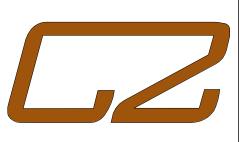

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24 AIRPORT ROAD

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SUNY SCCC ELSTON HALL LOBBY & MOHAWK ROOM RENOVATIONS


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Door Schedule - Mohawk

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DETAIL NOTES:

- A. ARRANGE PIPING TO ALLOW INSTALLATION OF PIPE INSULATION. PIPES ARE NOT TO COME IN CONTACT WITH EACH OTHER OR CABINET.
- B. DRAIN PIPING BY THE PLUMBING CONTRACTOR.
- C. PROVIDE 3-WAY VALVES WHERE SHOWN ON PLANS PIPE ACCORDING TO CONTROL VALVE SUPPLIER.

CONSOLE FAN COIL UNIT PIPING DETAIL NOT TO SCALE

UNIT NO.	LOCATION	TYPE	AIR SIDE			COOLING CO	DIL - CHANGE	OVER											HEATING CO	IL - CHANGE	OVER						FAN MOTOF			MANUFACTURER & MODEL No.	REMARKS
			AIR	MIN	EXT.	CAPACITY			EAT (DEG	€. F)	LAT (DEC	6. F)	WATER	WATER	ENT. WATER	LVG. WATER	FLUID	ROWS FPI	CAPACITY	ENT. AIR	LVG. AIR	WATER	WATER	ENT. WATER	LVG. WATER	FLUID	RPM W	VOLTS	PHASE		
			FLOW	O.A.	STATIC	SENSIBLE	LATENT	TOTAL	DB	WB	DB	WB	FLOW	P.D.	TEMP.	TEMP.			(MBH)	TEMP.	TEMP.	FLOW	P.D.	TEMP.	TEMP.						
			(CFM)	(CFM)	(In. WC)	(MBH)	(MBH)	(TONS)					(GPM)	(Ft. HD)	(DEG. F)	(DEG. F)				(DEG. F)	(DEG. F)	(GPM)	(Ft. HD)	(DEG. F)	(DEG. F)						
FCU-1	1ST FLOOR	VERTICAL CABINET	933	20	0.1	22.73	6.68	2	75	63	52.62	51.96	6.0	11.4	45	55	WATER	4	114.74	40	153.4	6	10.2	180	142	WATER	209	120	1	TRANE SIZE 100	
FCU-2	1ST FLOOR	VERTICAL CABINET	933	20	0.1	22.73	6.68	2	75	63	52.62	51.96	6.0	11.4	45	55	WATER	4	114.74	40	153.4	6	10.2	180	142	WATER	209	120	1	TRANE SIZE 100	
FCU-3	1ST FLOOR	VERTICAL CABINET	217	20	0.1	5.04	1.18	0.5	75	63	53.66	53.05	1.31	3.4	45	55	WATER	4	26.54	40	152.7	1.31	11.54	180	140	WATER	50	120	1	TRANE SIZE 20	
FCU-4	1ST FLOOR	VERTICAL CABINET	217	20	0.1	5.04	1.18	0.5	75	63	53.66	53.05	1.31	3.4	45	55	WATER	4	26.54	40	152.7	1.31	11.54	180	140	WATER	50	120	1	TRANE SIZE 20	
FCU-5	1ST FLOOR	VERTICAL CABINET	217	20	0.1	5.04	1.18	0.5	75	63	53.66	53.05	1.31	3.4	45	55	WATER	4	26.54	40	152.7	1.31	11.54	180	140	WATER	50	120	1	TRANE SIZE 20	
FCU-6	1ST FLOOR	VERTICAL CABINET	500	20	0.1	20	13.95	1.7	80	67	54.4	53.8	4.32	8.44	45	55	WATER	4	53.2	60	158	4.32	7.5	180	155	WATER	97	120	1	TRANE SIZE 60	
FCU-7	1ST FLOOR	VERTICAL CABINET	500	20	0.1	20	13.95	1.7	80	67	54.4	53.8	4.32	8 44	45	55	WATER	4	53.2	60	158	4.32	7.5	180	155	WATER	97	120	1	TRANE SIZE 60	

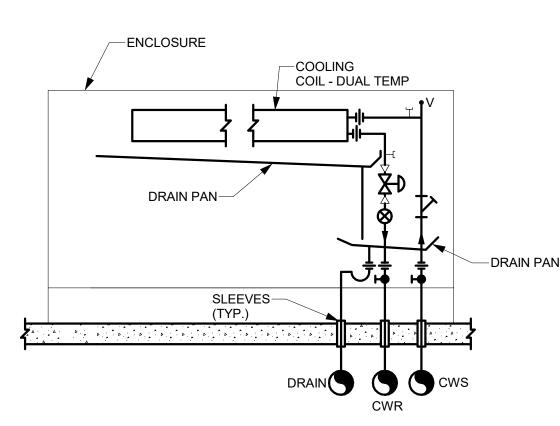SYMBOL	DESCRIPTION	SYMBOL	DESCRIPTION
	EXISTING WORK TO BE REMOVED	—— A —————————————————————————————————	COMPRESSED AIR VENT
	POINT OF CONNECTION	v	BOILER BLOW DOWN
	POINT OF DISCONNECTION	CS	CONDENSER WATER SUPPLY
	I OINT OF DISCONNECTION	——CR——	CONDENSER WATER RETURN
(\mathbf{x})	DRAWING KEYNOTE	CWS	CHILLED WATER SUPPLY
		——CWR——	CHILLED WATER RETURN DRAIN
X	DEMOLITION KEYNOTE	FOF	FUEL OIL FILL
MBH	THOUSAND BTU/HOUR	——FOG——	FUEL OIL GAUGE
NTS	NOT TO SCALE	——FOS——	FUEL OIL SUPPLY
(E) (L)	EXISTING ACOUSTIC THERMAL LINING - 1-1/2" THICK	—— FOR ——	FUEL OIL RETURN FUEL OIL TANK VENT
(2L)	ACOUSTIC THERMAL LINING - 2" THICK		GAS
(DBL)	DOUBLE WALL LINED DUCT	——GS——	GLYCOL SUPPLY
FPM	FEET PER MINUTE	——GR——	GLYCOL RETURN
CFM OBVD	CUBIC FEET PER MINUTE OPPOSED BLADE VOLUME DAMPER	— HPWS — HPWR —	HEAT PUMP WATER SUPPLY HEAT PUMP WATER RETURN
AFF	ABOVE FINISHED FLOOR	——HWS——	HOT WATER SUPPLY
AD	ACCESS DOOR	——HWR——	HOT WATER RETURN
W/W	WALL TO WALL	—— LPS ——	LOW PRESSURE STEAM
G.C. M.C.	GENERAL CONTRACTOR MECHANICAL CONTRACTOR	—— LPC ——	LOW PRESSURE CONDENSATE MEDIUM PRESSURE STEAM
P.C.	PLUMBING CONTRACTOR	MPC	MEDIUM PRESSURE CONDENSATE
E.C.	ELECTRICAL CONTRACTOR	—— HPS ——	HIGH PRESSURE STEAM
N.O.	NORMALLY OPEN	——HPC——	HIGH PRESSURE CONDENSATE
N.C.	NORMALLY CLOSED FLEXIBLE DUCTWORK	—— PC —— —— RD ——	PUMPED CONDENSATE REFRIGERANT DISCHARGE
ΔyB		——RL——	REFRIGERANT LIQUID
FO	DUCT SECTION - FLAT OVAL (FO)	RS	REFRIGERANT SUCTION
12"	ROUND DUCT - IN INCHES	——HG——	HOT GAS
		—— VAC —————————————————————————————————	VACUUM DOMESTIC COLD WATER
	DUCT SECTION - SUPPLY	TD	TRIPLE DUTY VALVE
	DUCT SECTION - RETURN		GLOBE VALVE
^	2001 SECTION - INCIDINA		BALL VALVE
AB	WIDTH A x DEPTH B		GATE VALVE CONTROL VALVE
	TRANSITION SQUARE TO ROUND		THREE WAY CONTROL VALVE
R	RISE IN DUCT - IN DIRECTION OF AIRFLOW		CHECK VALVE
-	THE IN SECTION OF THE LEW		BALANCING VALVE
D >	DROP IN DUCT - IN DIRECTION OF AIRFLOW		BUTTERFLY VALVE
24x12 UP	SUPPLY DUCT TURNING UP OR DOWN		RELIEF VALVE
01 	SUPPLY DUCT TURNING UP OR DOWN	PRV_	PRESSURE REDUCING VALVE
24x12 UP	RETURN DUCT TURNING UP OR DOWN	(PRESSURE/TEMPERATURE TEST PLUG SINGLE LINE PIPE CONTINUED
√			DOUBLE LINE PIPE OR
Y TAP 14x8 <	SUPPLY/RETURN	·	ROUND DUCT CONTINUED
14x8 Z	RECTANGULAR MAIN RECTANGULAR BRANCH		DOUBLE LINE RECTANGULAR
<u>√</u>			DUCT CONTINUED AIR FLOW
	SUPPLY/RETURN		PIPE ANCHOR
Y / TAP	RECTANGULAR MAIN ROUND BRANCH		PIPE GUIDE
CONICAL		W	EXPANSION COMPENSATOR WITH GUIDES
CONICAL TEE	SUPPLY/RETURN		PRE-FAB EXPANSION LOOP
14"	ROUND MAIN ROUND BRANCH		STRAINER
	ROUND BRANCH	<u> </u>	PRESSURE GAUGE
LATERAL	SUPPLY/RETURN		THERMOMETER
	ROUND MAIN	† V	UNION AIR VENT
14"	ROUND BRANCH	■ TT	THERMOSTATIC TRAP
		■ FT	FLOAT & THERMOSTATIC TRAP
	MITERED ELBOW WITH TURNING VANES	■ TD	THERMODYNAMIC TRAP
		■ BT	BUCKET TRAP DIRECTION OF FLOW
	CURRI V DIEFUCED DECISTED OF COURT		REDUCER
	SUPPLY DIFFUSER, REGISTER OR GRILLE		CAP OR PLUG
	RETURN REGISTER		ELBOW DOWN
	- · · · · · · - · · · · ·		ELBOW UP BOTTOM TAP
	EXHAUST GRILLE	AAD	
	FIN TUBE RADIATION	FD	FIRE DAMPER
	VALANCE	SD	SMOKE DAMPER
	REGISTER, GRILLE OR DIFFUSER TAG	FSD	
В	A = TYPE	FC	FLEX CONNECTOR - DUCTWORK
C	B = NECK SIZE C = CFM	MD	MOTORIZED DAMPER
A	LINEAR DIFFUSER TAG A = TYPE	— BG	BLAST GATE
B C	B = NECK SIZE	SD	VOLUME DAMPER SUCTION DIFFUSER
D	C = DIFFUSER LENGTH D = CFM		FLEXIBLE CONNECTOR - PIPING
FT-A	FIN TUBE RADIATION TAG	-∳ ∃	DRAIN VALVE WITH HOSE CONNECTION,
В	FT-A = TYPE B = FIN TUBE LENGTH		CAP AND CHAIN
D	C = ENCLOSURE LENGTH	FS TS	WATER FLOW SENSOR WATER TEMPERATURE SENSOR
Α	D = GPM RADIANT CEILING PANEL TAG	SP—•	STATIC PRESSURE SENSOR
В	A = TYPE B = LENGTH	H	HUMIDISTAT
С	C = GPM	<u>\$</u>	TEMPERATURE SENSOR
A	VALANCE TAG A = TYPE	© ©	CARBON DIOXIDE SENSOR CARBON MONOXIDE SENSOR
С	B = COIL SIZE	(S)	NITROGEN DIOXIDE SENSOR
D	C = COOLING GPM D = HEATING GPM	G	GAS SENSOR
	AIR TERMINAL UNIT AND TAG (OPTION 1)	(T) (T) E	PNEUMATIC/ELECTRIC THERMOSTAT
		T G S G	THERMOSTAT/SENSOR WITH GUARD
В	AIR TERMINAL UNIT TAG (OPTION 2)		



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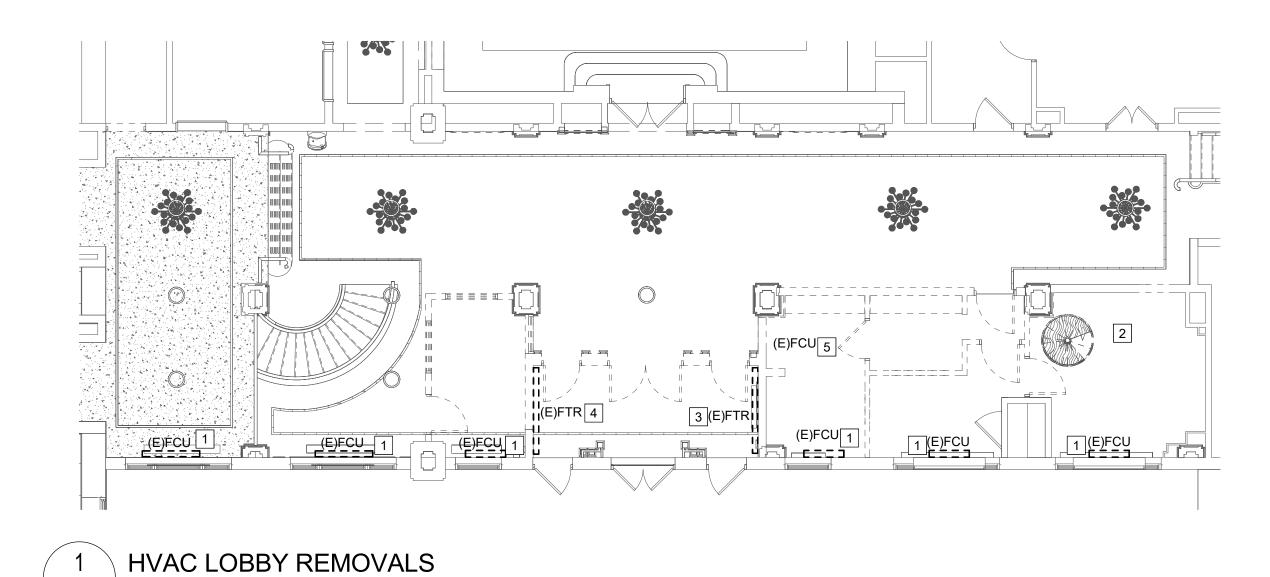
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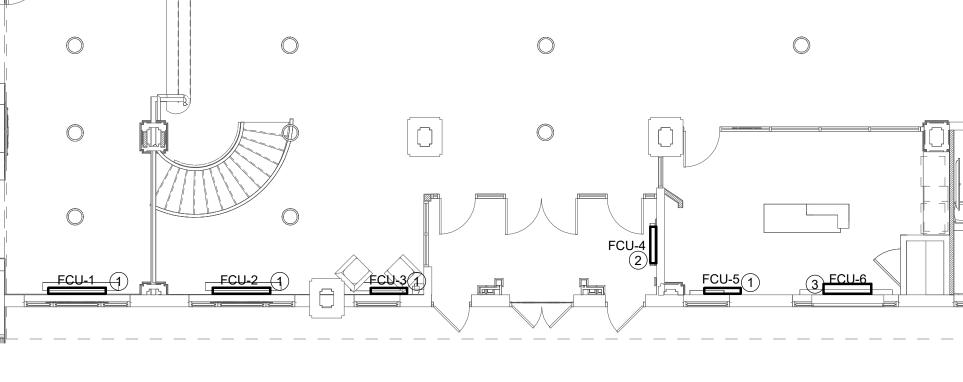
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Job No:	2349					
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HVAC SYMBOLS LIST,						
DETAILS AND						
SCHE	DULES					

Sheet Number:

PLOT DATE: 4/29/2024 3:09:55 PM



M101A SCALE: 1/8" = 1'-0"





M101A DEMOLITION NOTES X

- 1 REMOVE (E)FCU. DISCONNECT DUAL TEMPERATURE SYSTEM PIPING FROM FAN COIL AND PREPARE ENDS FOR RECONNECTION.
- 2 REMOVE ABANDONED AIR HANDLING UNIT IN ATTIC SPACE OF THIS ROOM. REMOVE ALL ASSOCIATED DUCTWORK AND PIPING.
- 3 REMOVE (E)FTR. DISCONNECT DUAL TEMPERATURE SYSTEM PIPING FROM FIN TUBE RADIATION AND PREPARE ENDS FOR RECONNECTION.
- 4 REMOVE (E)FTR. DISCONNECT DUAL TEMPERATURE SYSTEM PIPING FROM FIN TUBE
 RADIATION AND CAP FNDS OF PIPING RELOW FLOOR LEVEL
- RADIATION AND CAP ENDS OF PIPING BELOW FLOOR LEVEL.

 5 REMOVE (E)FCU. DISCONNECT DUAL TEMPERATURE SYSTEM PIPING FROM FAN COIL AND
- 5 REMOVE (E)FCU. DISCONNECT DUAL TEMPERATURE SYSTEM PIPING FROM FAN CC CAP ENDS.

M101A DRAWING NOTES

- 1 RECONNECT BACK TO DUAL TEMPERATURE SYSTEM PIPING.
- 2 RECONNECT BACK TO DUAL TEMPERATURE SYSTEM PIPING. PROVIDE 3/4" DRAIN LINE DOWN TO CONDENSATE DRAIN SYSTEM LOCATED IN BASEMENT.
- 3 PROVIDE 1" PIPING FROM MAINS IN BASEMENT UP TO FCU. INSTALL PER DETAIL AND CONNECT TO CAMPUS BMS.



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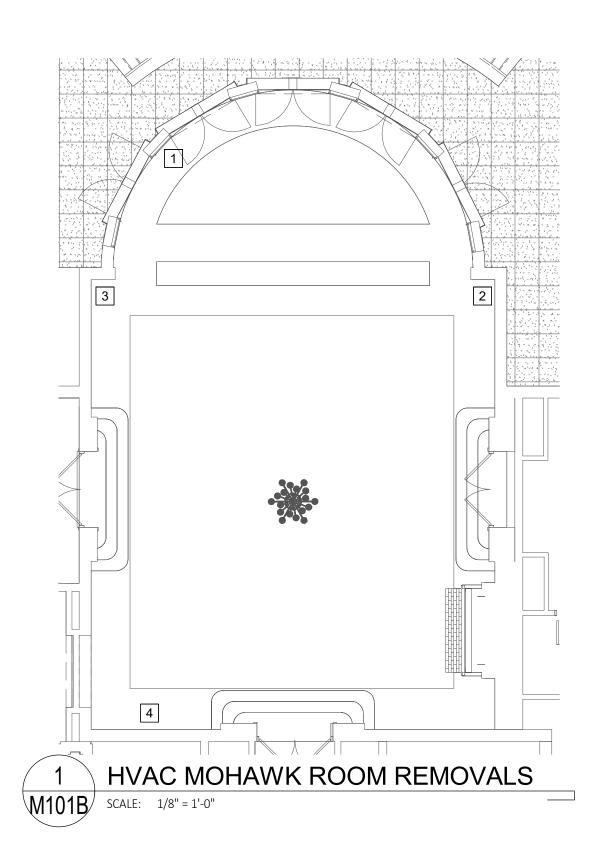
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	Job No:	2349
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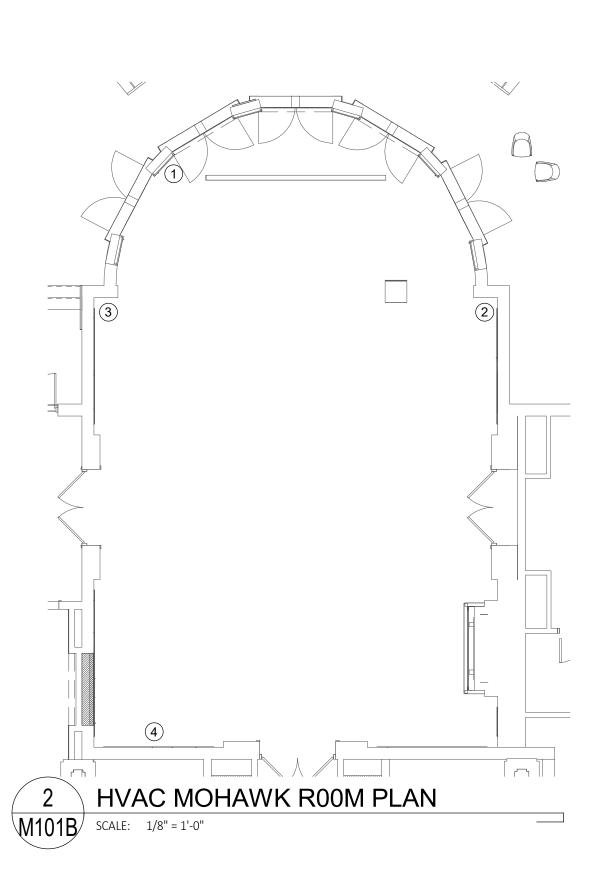
MECHANCIAL REMOVAL

AND RENOVATION PLAN

Sheet Number:

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M101B DEMOLITION NOTES X

- 1 MEASURE AND REMOVE EXISTING FLOOR GRILLE AT THIS LOCATION.
- MEASURE AND REMOVE EXISTING LINEAR FLOOR GRILLE AT THIS LOCATION.
 MEASURE AND REMOVE EXISTING LINEAR WALL GRILLE AT THIS LOCATION.
- 4 MEASURE AND REMOVE EXISTING LINEAR FLOOR GRILLE AT THIS LOCATION.

M101B DRAWING NOTES (X)

- 1 PROVIDE TITUS CT-TAF-481 FLOOR GRILLE TO MATCH EXISTING FLOOR GRILLE DIMENSIONS. GRILLE COLOR TO MATCH FLOORING.
- 2 PROVIDE TITUS CT-TAF-L FLOOR GRILLE TO MATCH EXISTING FLOOR GRILLE
- DIMENSIONS. GRILLE COLOR TO MATCH FLOORING.

 3 PROVIDE TITUS CT-TAF-L FLOOR GRILLE TO MATCH EXISTING WALL GRILLE DIMENSIONS. GRILLE TO MATCH WALL COLOR.
- 4 PROVIDE TITUS CT-TAF-L FLOOR GRILLE TO MATCH EXISTING FLOOR GRILLE DIMENSIONS. GRILLE TO MATCH FLOORING.
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M101B

- (APPLY TO ALL DRAWINGS):

 A. PROVIDE ALL LABOR, MATERIALS, EQUIPMENT AND SERVICES TO PERFORM ALL OPERATIONS REQUIRED FOR THE COMPLETE INSTALLATION AND RELATED WORK AS SHOWN ON THE DRAWINGS AND AS SPECIFIED HEREIN. ELECTRIC EQUIPMENT SHALL BE INSTALLED IN A NEAT AND WORKMANLIKE MANNER.
- PROVIDE ALL ELECTRICAL EQUIPMENT CONNECTIONS.
- C. PROVIDE ALL REQUIRED SUPPORTS AND ACCESSORIES.
- PROVIDE ALL WORK IN COMPLIANCE WITH THE NATIONAL ELECTRICAL CODE (NEC) AND THE LATEST EDITION OF THE:
- 1. BUILDING CODE OF NEW YORK STATE
 2. ENERGY CONSERVATION CONSTRUCTION CODE OF NEW YORK STATE
 3. OSHA REQUIREMENTS
- 4. LOCAL MUNICIPAL ORDINANCES AND CODES
 5. AUTHORITY HAVING JURISDICTION (AHJ)
 6. SERVING UTILITY COMPANIES
- E. PROVIDE ELECTRICAL INSPECTION CERTIFICATE FROM INSPECTION AGENCY RECOGNIZED AS ACCEPTABLE FROM THE AHJ.
- F. ALL RECEPTACLES INDICATED AS GFI TYPE MUST BE A GFI RECEPTACLE. CONNECTING NORMAL RECEPTACLES DOWNSTREAM OF ONE GFI RECEPTACLE IS NOT ACCEPTABLE
- PROVIDE TEMPORARY ELECTRICAL SERVICE IN SIZES TO ACCOMMODATE CONSTRUCTION WHERE REQUIRED.
- G. REPAIR OR REPLACE ALL DEFECTS IN MATERIAL OR WORKMANSHIP WITHIN ONE YEAR OF CONSTRUCTION CLOSE OUT DATE AT NO ADDITIONAL COST TO THE OWNER.
- H. PERFORM ALL OPERATIONS REQUIRED FOR A COMPLETE SYSTEM TEST. PRIOR TO CLOSE OUT DATE SUBMIT ALL SATISFACTORY SYSTEM TEST RESULTS FOR RECORD.
- J. SUBMITTALS:

REFLECTED CEILING PLANS.

(REFER TO NFPA 72).

- ALL ITEMS OF EQUIPMENT AND MATERIALS PROVIDED SHALL BE SUBMITTED FOR ENGINEERING REVIEW.
 SUBMIT A MINIMUM OF THREE COPIES OF SHOP DRAWINGS/PRODUCT DATA INFORMATION.
- K. CONTRACTOR IS HERE BY CAUTIONED THAT ELECTRIC POWER CHARACTERISTICS (VOLTAGE, PHASE, HORSEPOWER, AMPERAGE, ETC.) OF EQUIPMENT IS BASED ON AVAILABLE INFORMATION AT THE TIME OF PROJECT DESIGN. CONTRACTOR MUST VERIFY CHARACTERISTICS FOR EACH PIECE OF NEW EQUIPMENT PRIOR TO ORDERING ELECTRICAL EQUIPMENT. INDICATE VERIFICATION ON SUBMITTALS.
- L. LOCATIONS INDICATED FOR LIGHTING FIXTURES ARE APPROXIMATE. LOCATE FIXTURES AS REQUIRED TO AVOID INTERFERENCE WITH BUILDING STEEL, PIPING, DUCTWORK, CONDUIT, DIFFUSERS, GRILLES, SPEAKERS, SMOKE DETECTORS, ETC. FIELD COORDINATE EXACT LOCATIONS AS NEAR AS POSSIBLE TO THE LOCATION INDICATED. VERIFY COMPLIANCE WITH NEC ARTICLE 410.16 FOR INSTALLATION OF LIGHT FIXTURES


IN CLOTHES CLOSETS, PRIOR TO ROUGH-IN. REFER TO ARCHITECTURAL

- M. EXACT LOCATIONS OF CEILING MOUNTED SMOKE DETECTORS, EXIT SIGNS, ETC. SHALL BE COORDINATED WITH OTHER CEILING MOUNTED EQUIPMENT TO AVOID CONFLICT. LOCATE DEVICES AS NEAR AS POSSIBLE TO THE LOCATION INDICATED. FIRE ALARM SMOKE AND HEAT DETECTORS SHALL BE LOCATED 3'-0 MINIMUM FROM HVAC DIFFUSERS, REGISTERS, GRILLES, ETC. SMOKE DETECTORS AT SMOKE DOORS MUST BE INSTALLED WITHIN 5'-0 OF THE DOORS
- N. ALL NEW CIRCUITING SHALL BE CONCEALED (EXCEPT IN UNFINISHED SPACES). PROVIDE ALL CUTTING AND PATCHING AS REQUIRED.
- D. CONTRACTOR SHALL REVIEW ALL TRADES' CONTRACT DOCUMENTS TO DETERMINE SPECIFIC MOUNTING LOCATIONS FOR ELECTRICAL EQUIPMENT. COORDINATE EXACT MOUNTING LOCATIONS WITH THE ARCHITECT AND OTHER CONTRACTORS. REFER TO ARCHITECTURAL PLANS FOR CASEWORK LAYOUT, ELEVATIONS, ETC. COORDINATE WITH LOCATIONS OF ELECTRICAL DEVICES AND OUTLETS
- P. EXACT LOCATION OF MECHANICAL AND PLUMBING EQUIPMENT THAT REQUIRE ELECTRICAL CONNECTIONS ARE SHOWN ON THE MECHANICAL AND PLUMBING DRAWINGS.
- Q. PROVIDE CONDUIT/WIRING (CIRCUITING) AND REQUIRED CONNECTIONS TO ALL DEVICES/ EQUIPMENT. CONNECT TO CIRCUIT(S) AS INDICATED.
- R. COORDINATE ALL WORK WITH OTHER TRADES; REFER TO ARCHITECTURAL DRAWINGS FOR COORDINATING LOCATIONS.
- S. RE-INSTALL REMOVED SYSTEM DEVICES REMOVED AS A RESULT IN WALL, PARTITION OR CEILING REPLACEMENT WORK. PROVIDE POWER AND COMMUNICATION WALL AND PARTITION MOUNTED DEVICES AND RECONNECT TO EXISTING SYSTEMS. CLEAN EXISTING CEILING MOUNTED DEVICES. EXTEND EXISTING SYSTEM CIRCUITS AS REQUIRED FOR REINSTALLATION. COORDINATE WITH EXISTING SYSTEM MANUFACTURER.
- SLEEVE AND SEAL ALL WALL AND FLOOR PENETRATIONS. PROVIDE APPROPRIATE FIRE STOPPING FOR ALL PENETRATIONS.
- U. SHARED NEUTRAL SHALL NOT BE ALLOWED ON ANY BRANCH CIRCUITS.
 MAINTAIN SERVICE CLEARANCES OF ALL EQUIPMENT. ADVISE OTHER TRADES
 OF SERVICE CLEARANCES AND ENSURE NO SERVICES OR TRADES RUN
 THROUGH SERVICE AREA.
- V. ALL WIRING INDICATED ON PLANS IS TO BE COPPER WIRING UNLESS OTHERWISE NOTED.
- W. REFER TO ONE-LINE DIAGRAM. RATINGS TO MATCH THE RATING OF THE WALL/CEILING. UTILIZE FIRE RATED PUDDY PADS IN THESE LOCATIONS.
- X. REFER TO ARCHITECTURAL DRAWINGS FOR MOUNTING OF RECEPTACLES IN AND NEAR ALL MILLWORK AND CABINETRY.
- Y. THE CONTRACTOR MUST FOLLOW FEDERAL AND STATE ELECTRICAL SAFETY PRACTICE INCLUDING LOCK OUT TAG OUT (LOTO). THE CONTRACTOR MUST AFFIX THEIR COMPANY'S INDIVIDUAL LOTO LOCKS AND TAGS TO CONTROL HAZARDOUS ENERGIES AND TO PREVENT INJURIES.
- Z. PROVIDE SURFACE MOUNTED BOXES AND SURFACE METAL RACEWAY FOR ALL DEVICES INDICATED TO BE INSTALLED ON EXISTING WALLS, UNLESS OTHERWISE NOTED; COLOR TO MATCH EXISTING WALL.
- AA. PROVIDE RECESSED BOXES AND RACEWAYS FOR ALL DEVICES INDICATED TO BE INSTALLED ON NEW WALLS, UNLESS OTHERWISE NOTED.

	ABBREVIATIONS
ABBREV.	DESCRIPTION
Α	AMPERE
AC	MOUNTED ABOVE COUNTER HEIGHT
AFF	ABOVE FINISHED FLOOR
AFG	ABOVE FINISHED GRADE
AIC	AMPERE INTERRUPTING CURRENT
AL	ALUMINUM
ASD	ADJUSTABLE SPEED DRIVE
ATS	AUTOMATIC TRANSFER SWITCH
AV	AUDIO VISUAL
AWG	AMERICAN WIRE GAUGE
С	CONDUIT
CU	COPPER
EC	ELECTRICAL CONTRACTOR/TRADE
FACP	FIRE ALARM CONTROL PANEL
G	GROUND
GC	GENERAL CONTRACTOR/TRADE
GEN	GENERATOR
GFCI/GFI	GROUND FAULT CIRCUIT INTERRUPTER
НН	HAND HOLE
HP	HORSE POWER
HVAC	HEATING, VENTILATION & AIR CONDITIONING CONTRACTOR/TRADE
JB	JUNCTION BOX
KV	KILOVOLT
KVA	KILOVOLT AMPERES
KW	KILOWATT
LED	LIGHT EMITTING DIODE
MCB	MAIN CIRCUIT BREAKER
MLO	MAIN LUG ONLY
MTS	MANUAL TRANSFER SWITCH
NA	NOT APPLICABLE
NC	NORMALLY CLOSED
NEC	NATIONAL ELECTRIC CODE
NIC	NOT IN CONTRACT
NL	NIGHT LIGHT
NTS	NOT TO SCALE
Р	POLE
SMR	SURFACE METAL RACEWAY
SPEC	SPECIFICATION
TYP	TYPICAL
UC	MOUNTED UNDER COUNTER HEIGHT
UL	UNDERWRITER'S LABORATORY
V	VOLT
W	WIRE/WATT

BRANCH CIRCUITING IDENTIFICATION

WEATHERPROOF

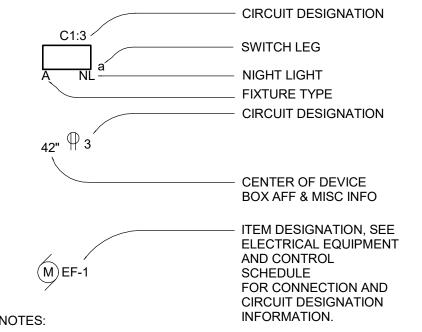

1. TYPICAL FOR ALL FIXTURES DEVICES & EQUIPMENT.

2. PANEL DESIGNATION WILL BE REFERENCED BY DRAWING NOTE FOR INDIVIDUAL ROOMS. SEE DRAWING NOTES ON EACH PLAN DRAWING.

BASIC MATERIALS AND METHODS **EXISTING TO REMAIN - INDICATES EXISTING** ITEM SHALL REMAIN. MAINTAIN EXISTING ELECTRICAL CONNECTIONS UNLESS OTHERWISE NOTED. EXISTING TO BE RELOCATED - INDICATES EXISTING ITEM SHALL BE RELOCATED. DISCONNECT AND REMOVE, REINSTALL AT NEW LOCATION AND RECONNECT ITEM AS EXISTING ELECTRICAL WIRING, EQUIPMENT OR - - - , (I) DEVICE, DASHED LIGHT IS EXISTING TO BE REMOVED OR RELOCATED \longrightarrow \bigcirc EXISTING ELECTRICAL WIRING, EQUIPMENT OR SOLID LIGHT IS EXISTING TO REMAIN **HEAVY SOLID IS NEW** REFERENCE TO DRAWING NOTE REFERENCE TO REMOVAL NOTE JUNCTION BOX SPECIAL PURPOSE RECEPTACLE. PROVIDE PROPER VOLTAGE, CLASS, CURRENT RATING AND NEMA CONFIGURATION AS REQUIRED BY BRANCH CIRCUIT AND/OR MATCH CAP ON EQUIPMENT BEING FURNISHED BY OTHERS. PROVIDE CORD AND CAP. DUPLEX RECEPTACLE, 20 AMP, 125 VOLT SUBSCRIPTS INDICATE TYPE: OC - OVER THE COUNTER UC - UNDER THE COUNTER WP - WEATHER PROOF GFI - GROUND FAULT INTERRUPTER USB - UNIVERSAL SERIAL BUS QUAD RECEPTACLE 20 AMP, 125 VOLT TOGGLE SWITCH, VOLTAGE AS INDICATED ON FIXTURE SCHEDULE, SUBSCRIPTS INDICATE TYPE: 3 - THREE WAY SWITCH 4 - FOUR WAY SWITCH K - KEYED SWITCH LV - LOW VOLTAGE, MOMENTARY CONTACT OS - OCCUPANCY SENSOR **VS - VACANCY SENSOR** a,b,c - SWITCHING DESIGNATIONS NUMBER OF LETTERS EQUALS NO. OF GANGED SWITCHES CEILING MOUNTED VACANCY SENSOR CEILING MOUNTED OCCUPANCY SENSOR FLUSH POKE THROUGH FLOOR MOUNTED COMBINATION POWER AND DATA DROP. DIMMER WITH ON/OFF SWITCH

AND CONTROL 208Y/120 VOLT PANELBOARD. EQUIPMENT CONNECTION. REFER TO ELECTRIC EQUIPMENT AND CONTROL SCHEDULE FOR DESCRIPTION. LETTERS AND NUMBERS INDICATE "ITEM DESIGNATION" ON THE SCHEDULE.

POWER DISTRIBUTION


DESCRIPTION. LETTERS AND NUMBERS INDICATE "ITE DESIGNATION" ON THE SCHEDULE.

SINGLE POINT CONNECTION TO EQUIPMENT, SEE DRAWING NOTES FOR REQUIREMENTS.
SUBSCRIPT INDICATES ASSOCIATED EQUIPMENT/DEVICE:


	FIRE ALARM
S	SMOKE DETECTOR
F	MANUAL PULL STATION
F■ ¹⁵ _{A/V}	WALL MOUNTED COMBINATION HORN AND STROBE # INDICATES STROBE CANDELA
F△ ¹⁵ _V	WALL MOUNTED STROBE ONLY # INDICATES STROBE CANDELA
Н	COMBINATION SET TEMPERATURE AND RATE OF RISE HEAT DETECTOR
FACP	FIRE ALARM CONTROL PANEL

C - COOK TOP

H - RANGE HOOD

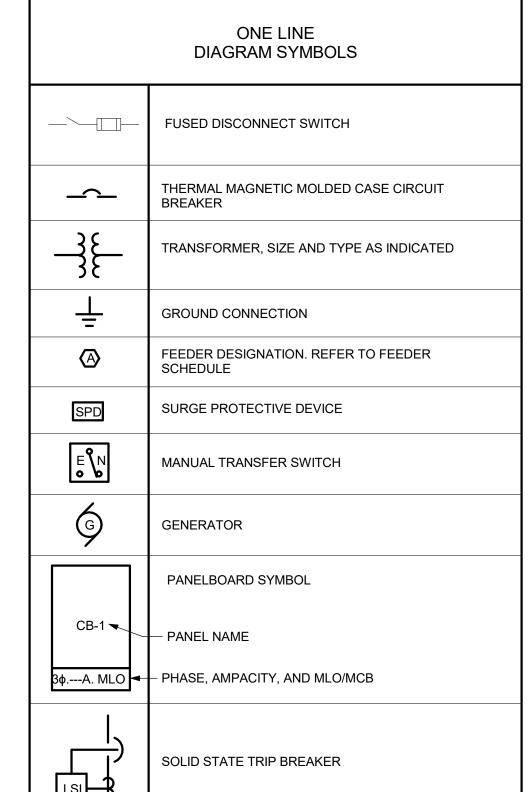

	SYSTEMS
$\nabla_{\!$	TELE/DATA OUTLET ONLY. PROVIDE BACKBOX AND 1" CONDUIT STUBBED TO ABOVE ACCESSIBLE CEILING SPACE. SUBSCRIPT INDICATES TYPE AND/OR QUANTITY: T=TELEPHONE (MOUNT 48" AFF). AC=ABOVE COUNTER #D=QUANTITY OF DATA PORTS. IF NO QUANTITY IS INDICATED, PROVIDE (2).
	COMBINATION POWER AND TELE/DATA OUTLETS; REFER TO TYPICAL POWER AND TELE/DATA OUTLET DETAIL. SUBSCRIPT INDICATES QUANTITY: #P=QUANTITY OF DUPLEX RECEPTACLES. #D=QUANTITY OF DATA PORTS. IF NO QUANTITY IS INDICATED, PROVIDE (2).
FB _A	FLOOR BOX
TV	TELEVISION OUTLET; REFER TO TYPICAL COMBINATION POWER AND TELEVISION OUTLET DETAIL.
WAP	WIRELESS ACCESS POINT. PROVIDE (1) CAT6 CABLE FROM IT ROOM. (ACCESS POINT PROVIDED BY OTHERS).
VP	VIDEO PROJECTOR (MOUNT AND PROJECTOR PROVIDED BY OTHERS). PROVIDE (1) FLUSH MOUNTED DUPLEX RECEPTACLE.
₽	SECURITY CAMERA, DEVICE AND WIRING BY OTHERS
CR	CARD READER, DEVICE AND WIRING BY OTHERS

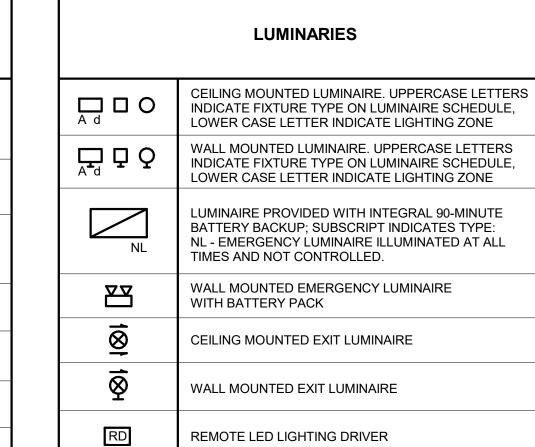

GENERAL FIRE ALARM NOTES

- (APPLY TO ALL DRAWINGS):

 A. THE CONTRACTOR SHALL PROVIDE A COMPLETE TEST OF THE
 EXISTING SYSTEM PRIOR TO MAKING MODIFICATIONS TO ASSESS THE
 CONDITION AND CAPABILITY OF DEVICES AND CIRCUITS TO BE REUSED.
 WHERE POSSIBLE, THE CONTRACTOR SHALL HAVE THE OPTION TO
 REUSE EXISTING DEVICES, BOXES AND WIRING.
- B. IN GENERAL, EXISTING INITIATION AND NOTIFICATION APPLIANCE CIRCUITS SHALL BE RETAINED AND EXTENDED TO THE NEW CONTROL PANEL FOR DEVICES IN AREAS UNAFFECTED BY THE SCOPE OF WORK. NEW DEVICES SHALL BE TIED INTO EXISTING CIRCUITS, OR NEW CIRCUITS SHALL BE PROVIDED AS REQUIRED TO PROVIDE A COMPLETE SYSTEM AS INDICATED.
- C. ALL WIRING SHALL BE COPPER, INSTALLED IN A DEDICATED/SEGREGATED EMT CONDUIT SYSTEM AND SHALL CONFORM TO THE NEC AND TO NFPA-72, NATIONAL FIRE ALARM CODE. INSTALL IN ACCORDANCE WITH THE MANUFACTURER'S RECOMMENDATIONS.
- D. THE COMPLETE FIRE ALARM SYSTEM SHALL BE FULLY TESTED AFTER THE WORK IS COMPLETE. TESTING SHALL INCLUDE ALL DEVICES, CONTROL PANEL, ANNUNCIATOR PANEL, OTHER PANELS, FEATURES AND FUNCTIONS. TESTING SHALL BE WITNESSED BY THE OWNER'S REPRESENTATIVE AND BE IN ACCORDANCE WITH THE NFPA. PROVIDE A TESTING REPORT TO THE AHJ AND THE ENGINEER AS A SUBMITTAL. REFER TO SPECIFICATION SECTION 283103.

GENERAL REMOVAL NOTES

- A. DISCONNECT AND REMOVE ALL EXISTING ELECTRICAL EQUIPMENT SHOWN TO BE REMOVED, OR REQUIRED TO BE REMOVED AS A RESULT OF EQUIPMENT/BUILDING DEMOLITION WORK. COORDINATE REQUIREMENT WITH GENERAL CONTRACTOR. REMOVE ALL ASSOCIATED BRANCH CIRCUIT AND CONTROL WIRING AND RACEWAYS. WHERE EXISTING DEVICES ARE NOT BEING REUSED, THEY AND THEIR ASSOCIATED WIRING SHALL BE COMPLETELY REMOVED BACK TO THEIR SOURCES (UNLESS OTHER WISE NOTED). DISCONNECT AND REMOVE ALL EMPTY AND ABANDONED RACEWAYS. CUT FLUSH WITH FLOOR OR WALL WHERE APPLICABLE AND PLUG CONDUIT WATERTIGHT. SEE FRONT END SPECS FOR "HOT WORK PERMIT" REQUIREMENTS.
- B. EXISTING CONDITIONS ARE TAKEN FROM FIELD OBSERVATIONS AND PRIOR CONSTRUCTION DOCUMENTS WHEN AVAILABLE AND ARE NOT GUARANTEED ACCURATE. EC SHALL FIELD VERIFY ALL EXISTING CONDITIONS PRIOR TO BID.
- C. COORDINATE ALL WORK WITH OTHER TRADES. ANY WORK PREFROMED TO DUE TO LACK OF COORDINATION SHALL BE PREFROMED AT THE CONTRACTOR'S EXPENSE WITH NO COST TO THE OWNER.
- D. CUTTING, PATCHING AND FIRESTOPPING OF EXISTING BUILDING FINISHES AND ELEMENTS TO FACILITATE ELECTRICAL REMOVAL WORK SHALL BE THE RESPONSIBILITY OF THE ELECTRICAL CONTRACTOR.
- PROVIDE A TEST PRIOR TO THE BEGINNING ELECTRICAL REMOVAL WORK, OF EACH AND EVERY SYSTEM AFFECTED BY THE WORK TO ASCERTAIN AND DOCUMENT PRE-CONSTRUCTION CONDITIONS OF EACH INDIVIDUAL DEVICE ON EACH SYSTEM. SYSTEMS AND DEVICES WHICH ARE UNTESTED WILL BE ASSUMED TO BE IN PERFECT WORKING ORDER PRIOR TO THE BEGINNING OF CONSTRUCTION. TEST THESE AND NEW DEVICES AND SYSTEMS AFTER CONSTRUCTION TO INDICATE AND DOCUMENT POST-CONSTRUCTION CONDITIONS. ELECTRICAL CONTRACTOR SHALL BE RESPONSIBLE FOR RETURNING ALL EXISTING SYSTEMS AND DEVICES TO PRE-CONSTRUCTION CONDITION OR BETTER. OBTAIN THE SERVICES OF A CERTIFIED TESTING ORGANIZATION TO TEST AND DOCUMENT EACH SYSTEM. BOTH PRE AND POST CONSTRUCTION. SUCH SYSTEMS SHALL INCLUDE, BUT ARE NOT NECESSARILY LIMITED TO: HVAC, WWTP PROCESS, GENERATOR DISTRIBUTION SYSTEM, SECURITY ACCESS CONTROL SYSTEM, PUBLIC ADDRESS SYSTEM, LOCAL AREA NETWORK SYSTEM, TELEPHONE SYSTEM, EMERGENCY EGRESS LIGHTING SYSTEM, INTRUSION DETECTION SYSTEMS, AUTOMATIC LIGHTING CONTROL SYSTEM AND FIRE ALARM SYSTEM. SUBMIT TEST RESULTS TO OWNER AND ENGINEER FOR REVIEW AND APPROVAL



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LOBBY & MOHAWK

RENOVATIONS

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ELECTRICAL LEGEND & ABBREVIATIONS

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C2 Architecture


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- A. REMOVE ALL EXISTING ELECTICAL EQUIPMENT AND DEVICES THAT ARE INCDICATED TO BE REMOVED (SHOWN DASHED). UNLESS OTHERWISE NOTED, REMOVE ASSOCIATED BRANCH CIRCUIT CONDUIT AND WIRING BACK TO SOURCE. MAINTAIN AND PROTECT ALL EQUIPMENT AND DEVICES THAT ARE IDNICATED TO REMAIN.
- B. MAINTAIN EXISTING RECEPTACLE CIRCUITS WITH REMOVALS OF RECEPTACLES FOR RECONNECTION.

ER101A REMOVALS NOTES

- 1 DISCONNECT EXISTING MEZZANINE MECHANICAL EQUIPMENT BACK TO SOURCE WITH REMOVALS, DISCONNECT AND REMOVE ASSOCIATED DISCONNECTS.
- 2 DISCONNECT EXISTING FCU WITH REMOVAL OF FCU, MAINTAIN EXISTING FCU CIRCUIT FOR RECONNECTION.
- 3 PRIOR TO RELOCATION VERIFY TIMECLOCK IS STILL OPERATIONAL. IF TIMECLOCK IS FOUND TO BE OPERATIONAL MAINTAIN EXISTING WIRING FOR RECONNECTION. IF TIMECLOCK IS FOUND TO BE NO LONGER OPERATIONAL, DISCONNECT AND TURN OVER TO THE OWNER.
- 4 EXISTING FIRE ALARM CONDUIT AND WIRING FROM EXISTING JUNCTION BOX. DISCONNECT AND REMOVE EXISTING FIRE ALARM CONDUIT, MAINTAIN EXISTING WIRING FOR RECONNECTION AND REROUTING. EXISTING JUNCTION BOX TO REMAIN.
- 5 EXISTING EXPOSED CABLING NEXT TO EXISTING PANEL SHALL BE MAINTAINED THROUGH CONSTRUCTION. EXISTING TELEPHONE CABLING ABANADONED IN PLACE SHALL BE REMOVED.



1 ELSTON HALL LOBBY POWER & SYSTEMS REOMVALS PLAN ER101A SCALE: 1/4" = 1'-0"

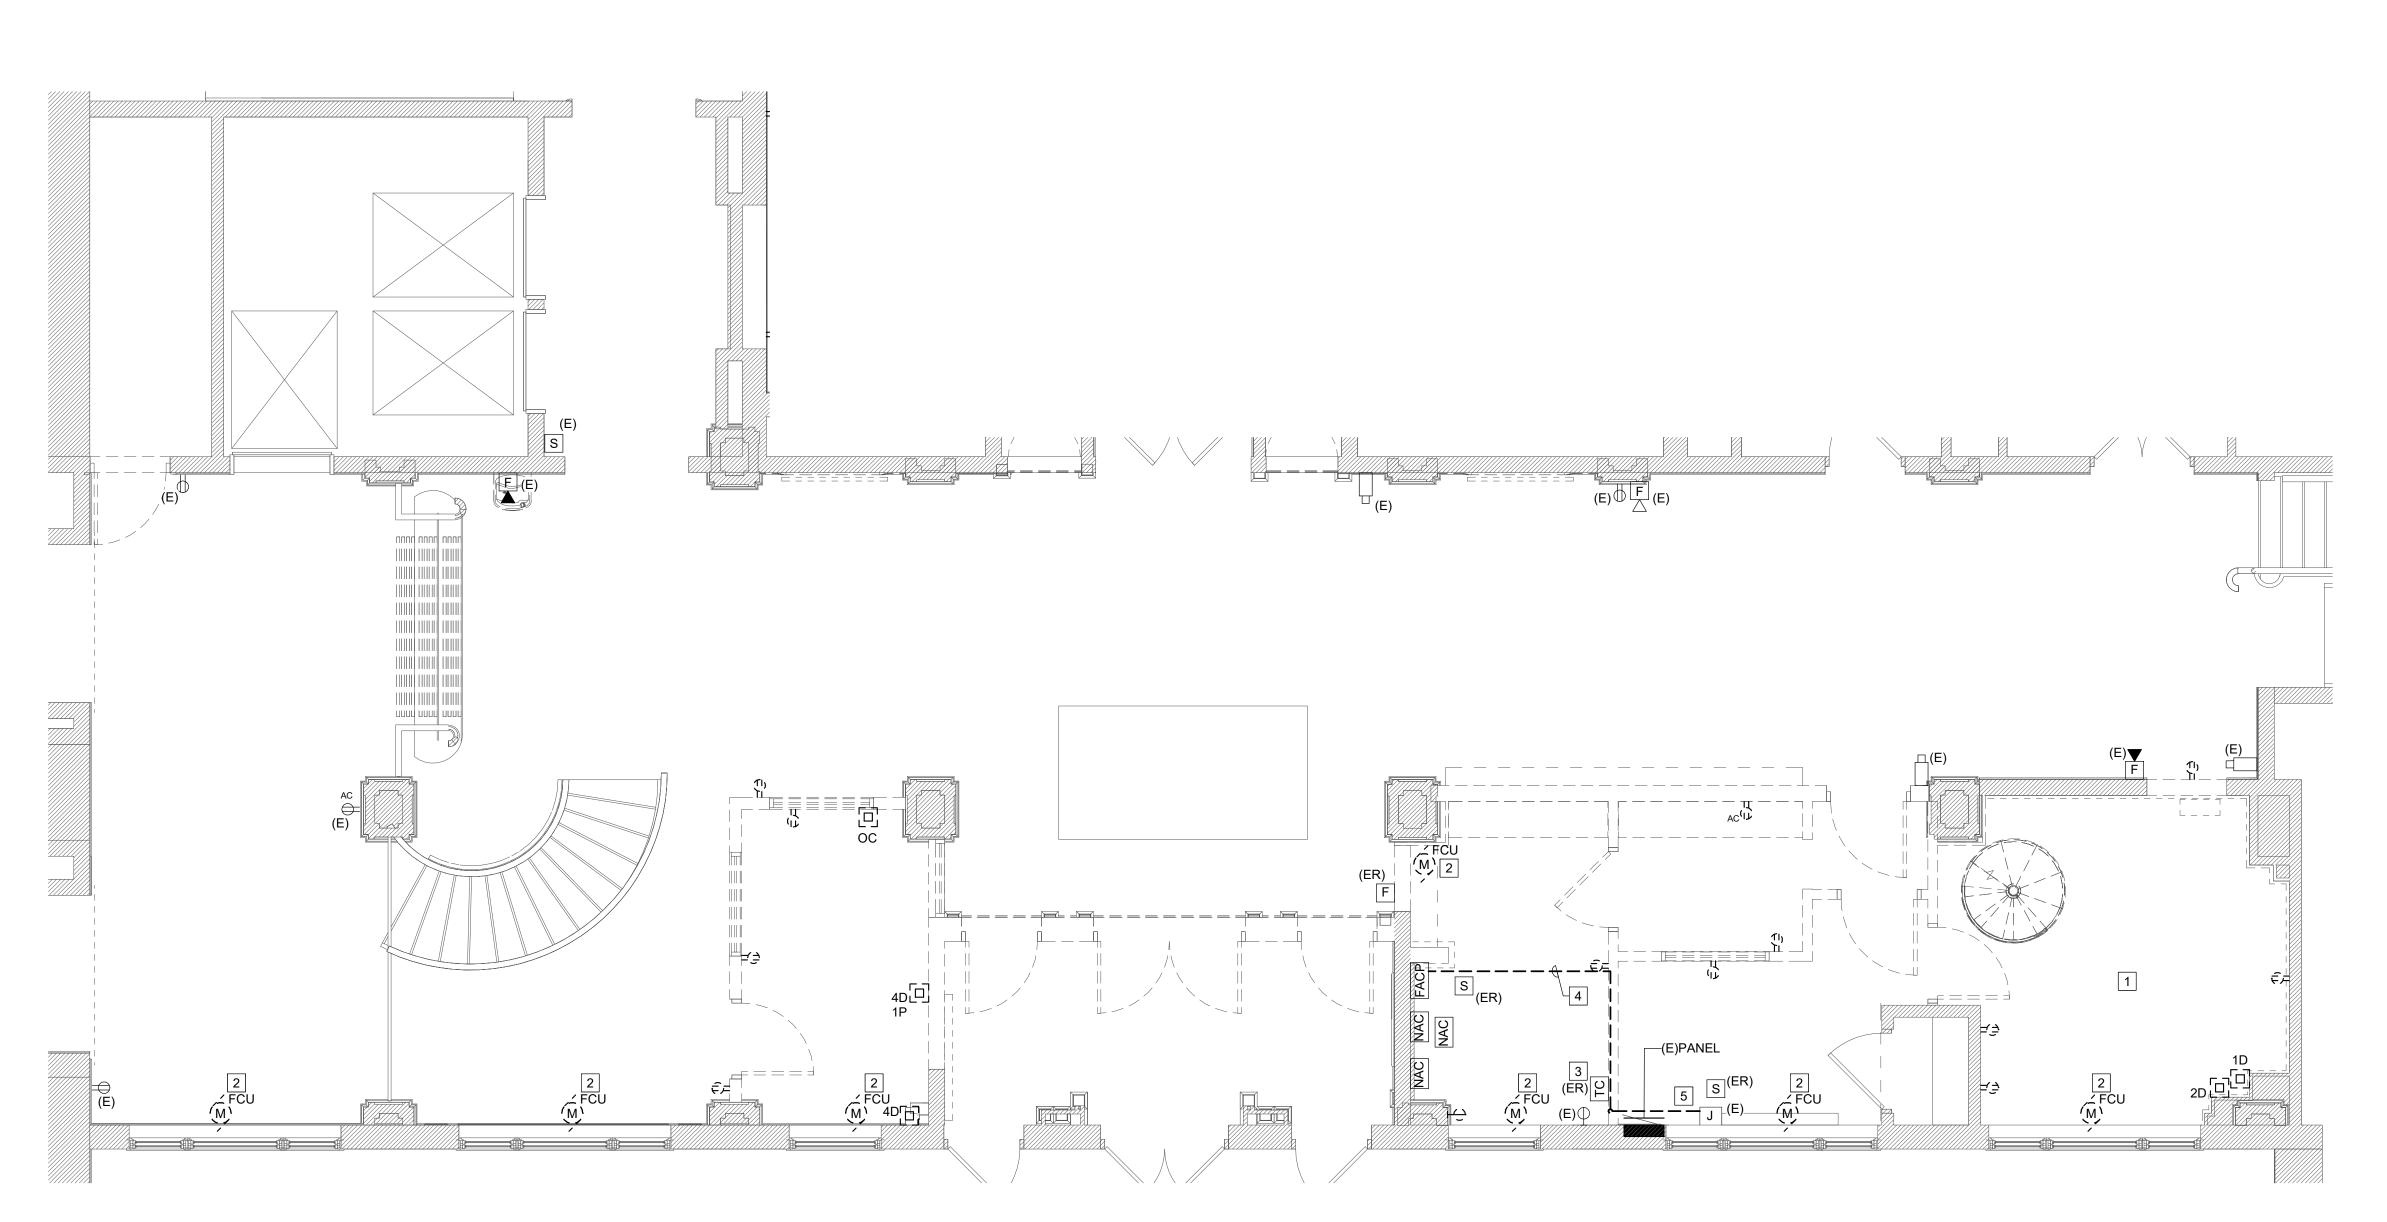

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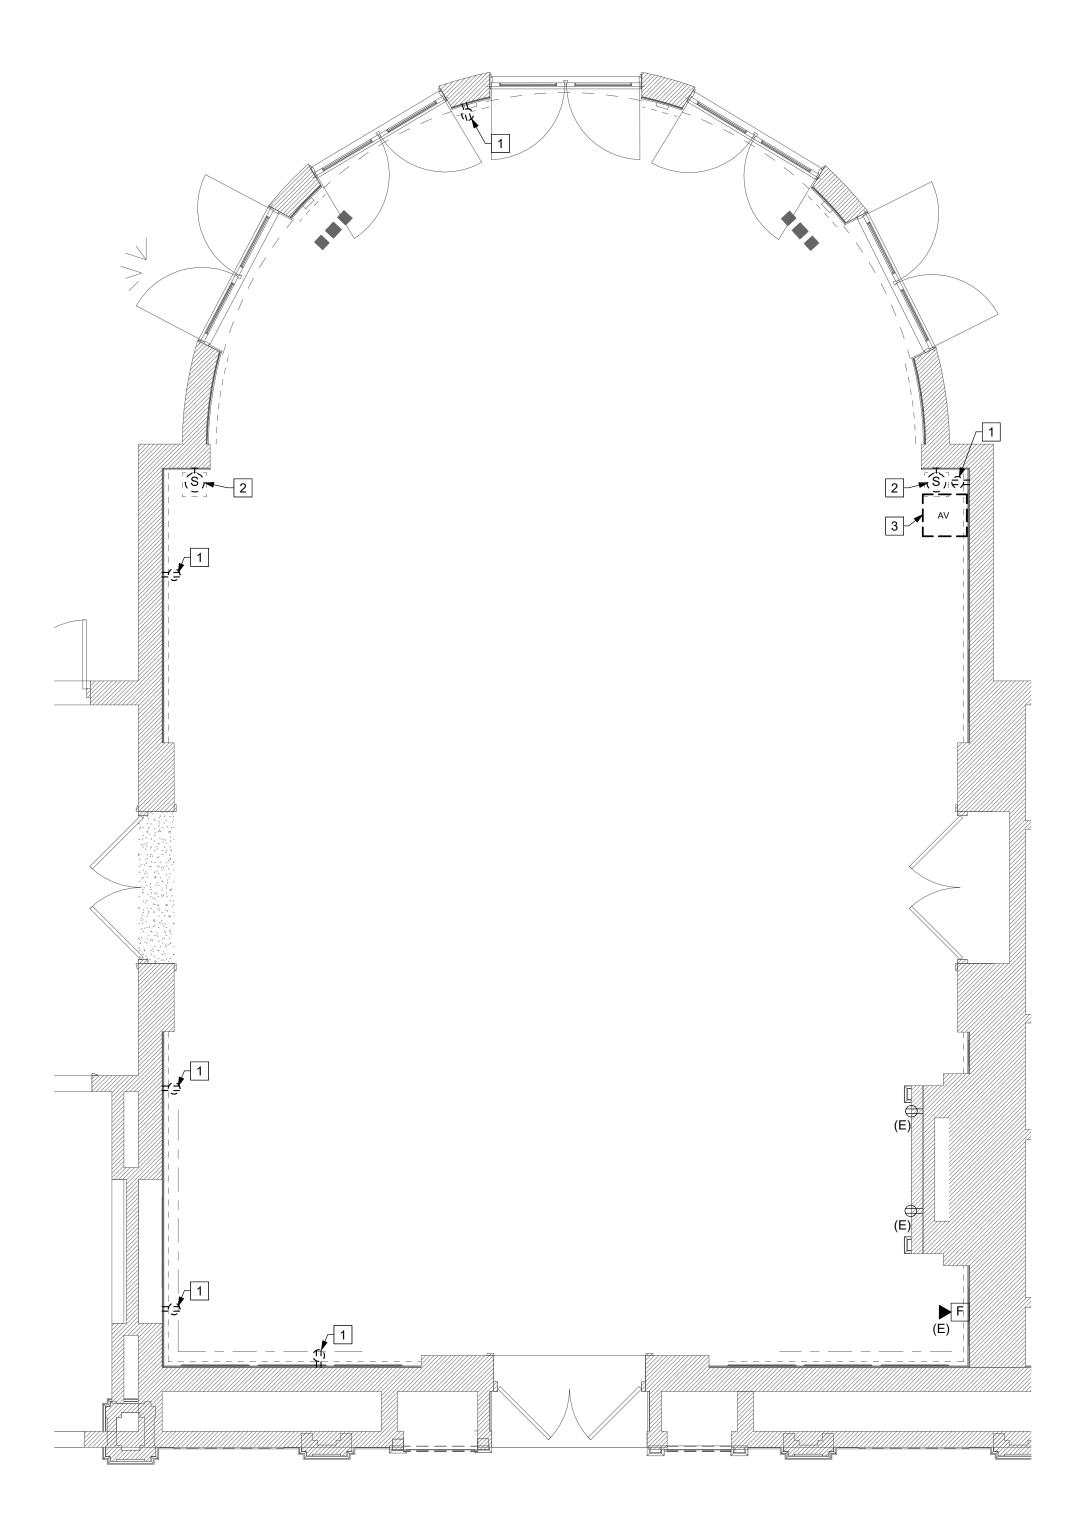
ELSTON HALL LOBBY

POWER AND SYSTEMS

REMOVALS PLAN

Sheet Number:

ER101A



1 ELECTRICAL REMOVALS MOHAWK ROOM - ALTERNATE #1 ER101B SCALE: 1/4" = 1'-0"

A. REMOVE ALL EXISTING ELECTICAL EQUIPMENT AND DEVICES THAT ARE INCDICATED TO BE REMOVED (SHOWN DASHED). UNLESS OTHERWISE NOTED, REMOVE ASSOCIATED BRANCH CIRCUIT CONDUIT AND WIRING BACK TO SOURCE. MAINTAIN AND PROTECT ALL EQUIPMENT AND DEVICES THAT ARE IDNICATED TO REMAIN.

ER101B REMOVALS NOTES

- 1 DISCONNECT AND REMOVE RECEPTACLE. MAINTIAN EXISTING CIRCUIT FOR RECONNECTION.
- 2 DISCONNECT SPEAKER AND TURNOVER TO OWNER.
- 3 DISCONNECT AV BOX AND TURNOVER TO OWNER.



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	MOHAWK	(ROOM
	ELECTRICAL	REMOVALS

PLAN
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ER101B

PLOT DATE: 4/29/2024 3:05:16 PM

- A. REMOVE ALL EXISTING ELECTRICAL EQUIPMENT AND DEVICES THAT ARE INDICATED TO BE REMOVED (SHOWN DASHED). UNLESS OTHERWISE NOTED, REMOVE ASSOCIATED BRANCH CIRCUIT CONDUIT AND WIRING BACK TO SOURCE. MAINTAIN AND PROTECT ALL EQUIPMENT AND DEVICES THAT ARE INDICATED TO REMAIN.
- B. MAINTAIN EXISTING LIGHTING CIRCUITS FOR RECONNECTION.

ER201A REMOVALS NOTES

- 1 DISCONNECT AND REMOVE EXISTING LIGHT FIXTURES IN MEZZANINE.
- 2 MAINTAIN EXISTING LIGHTING CIRCUIT AND CONTROLS FOR RECONNECTION.



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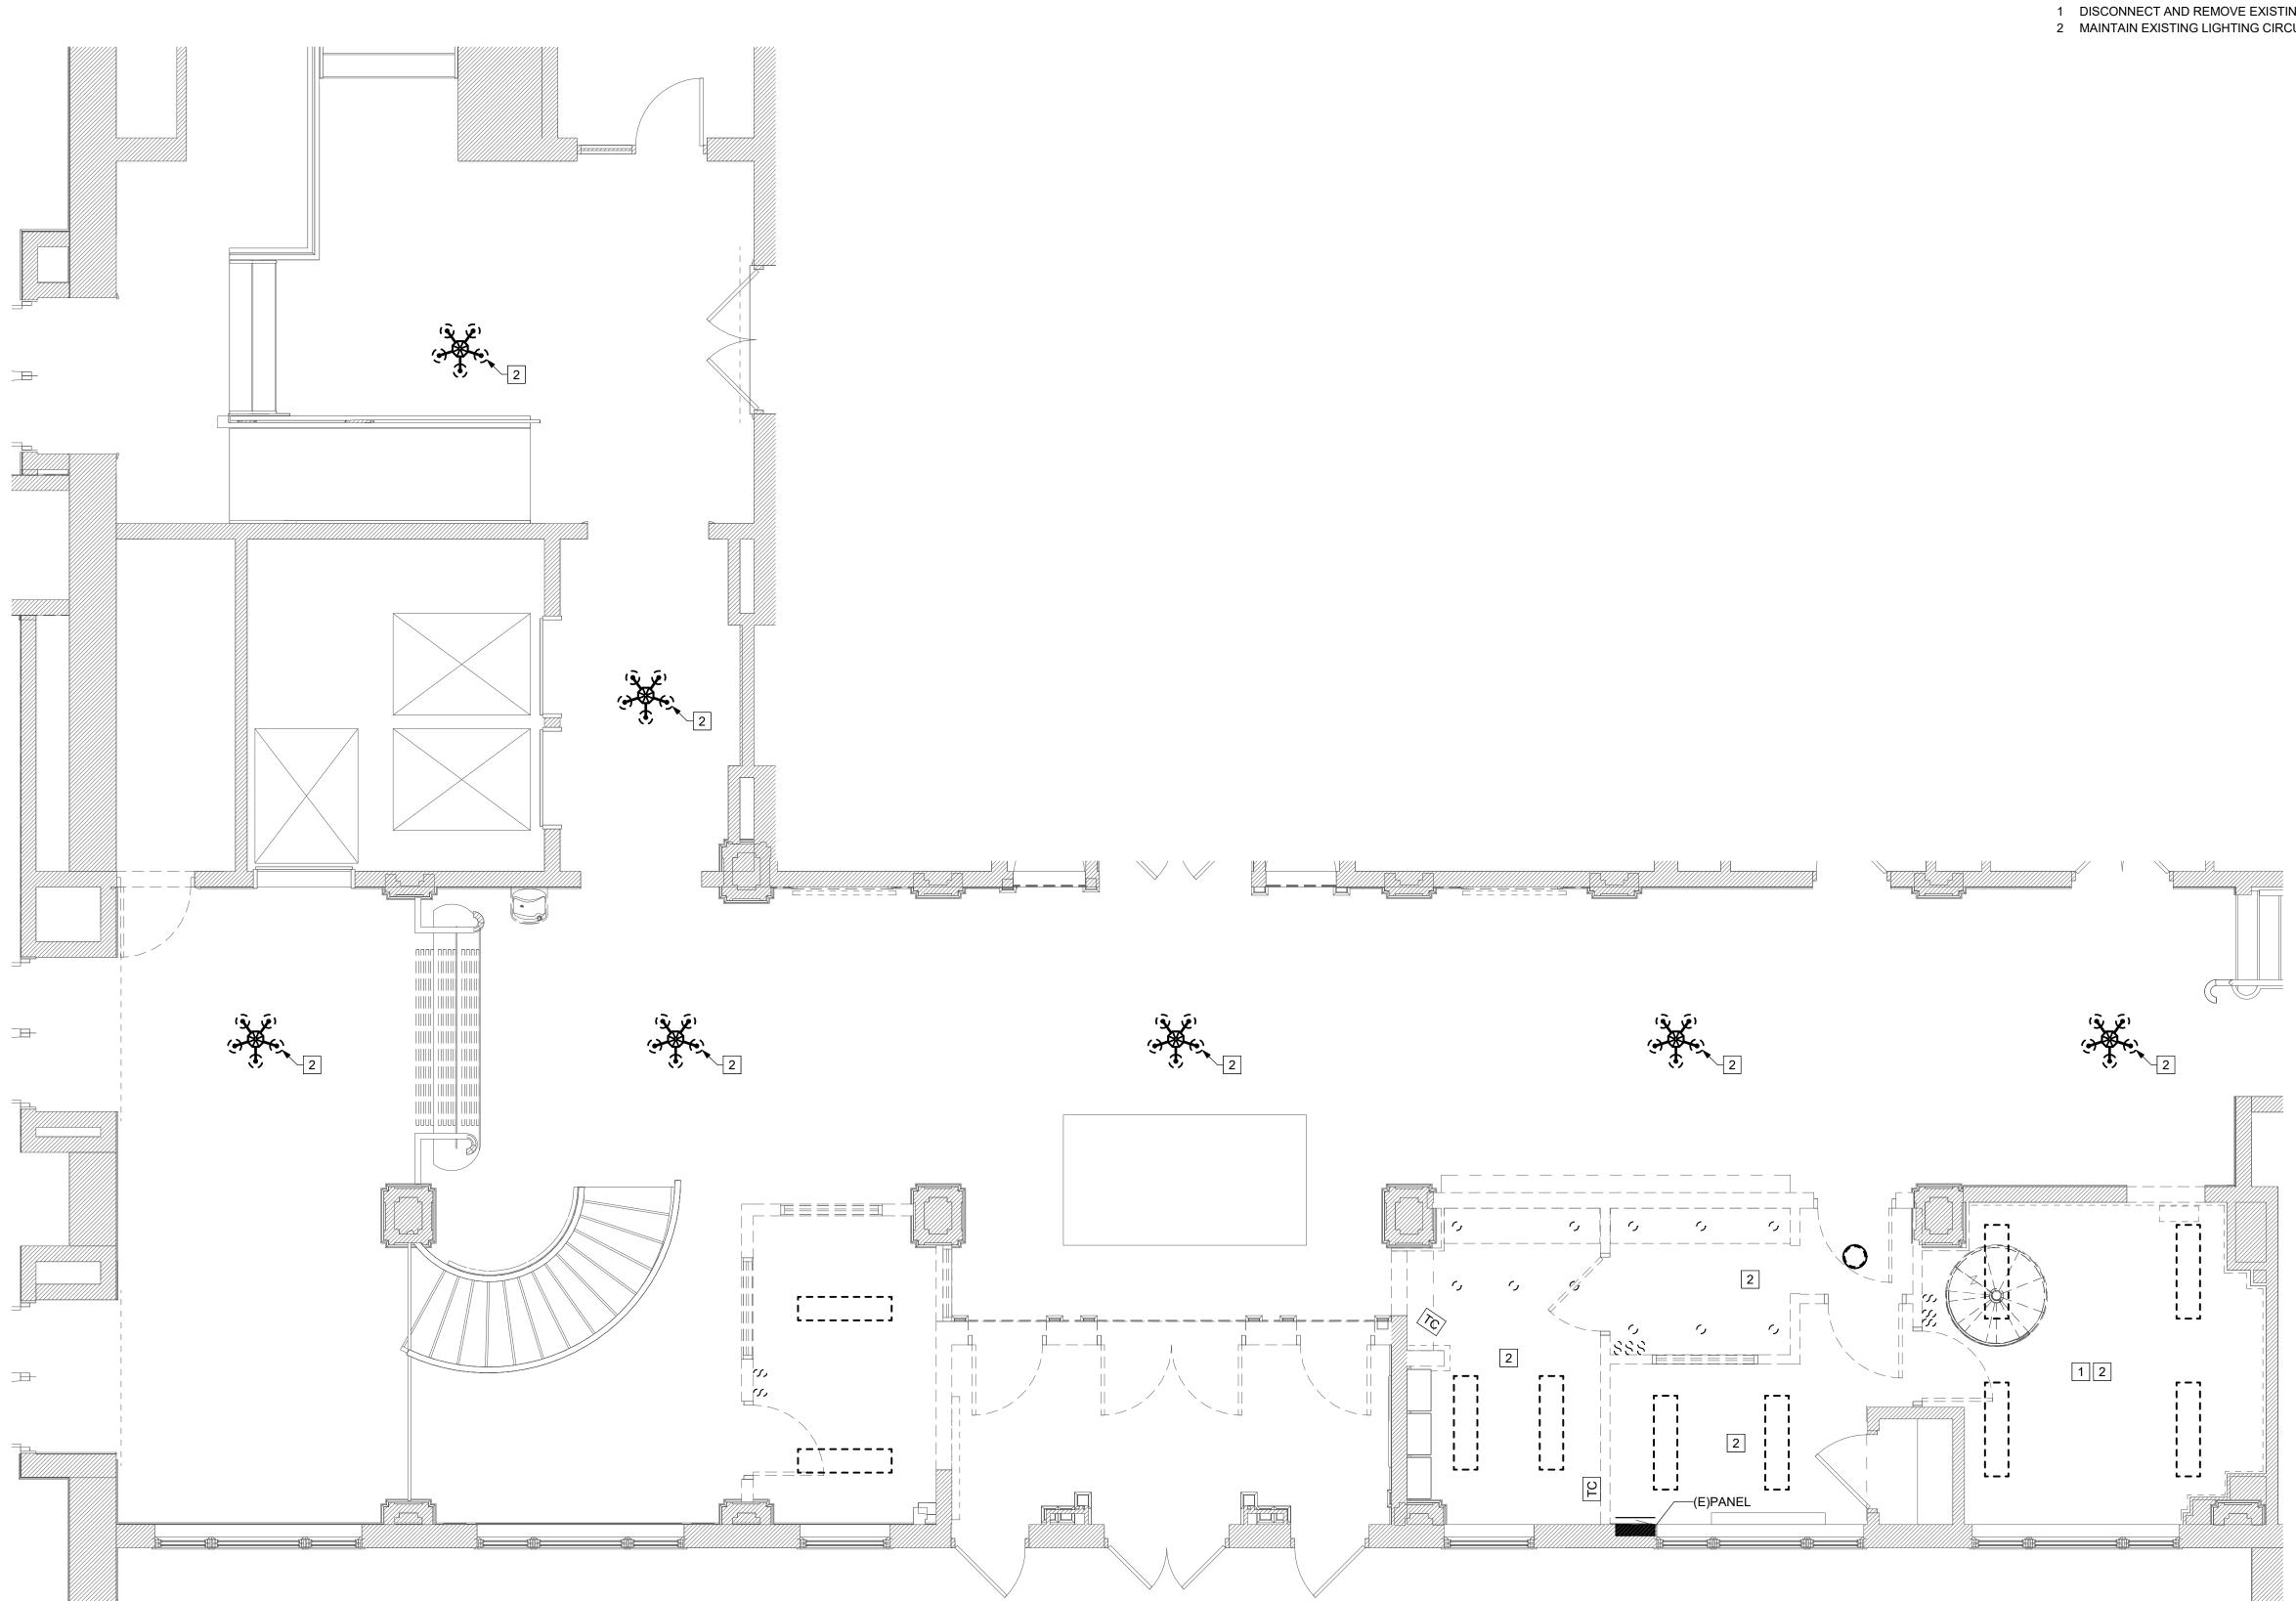
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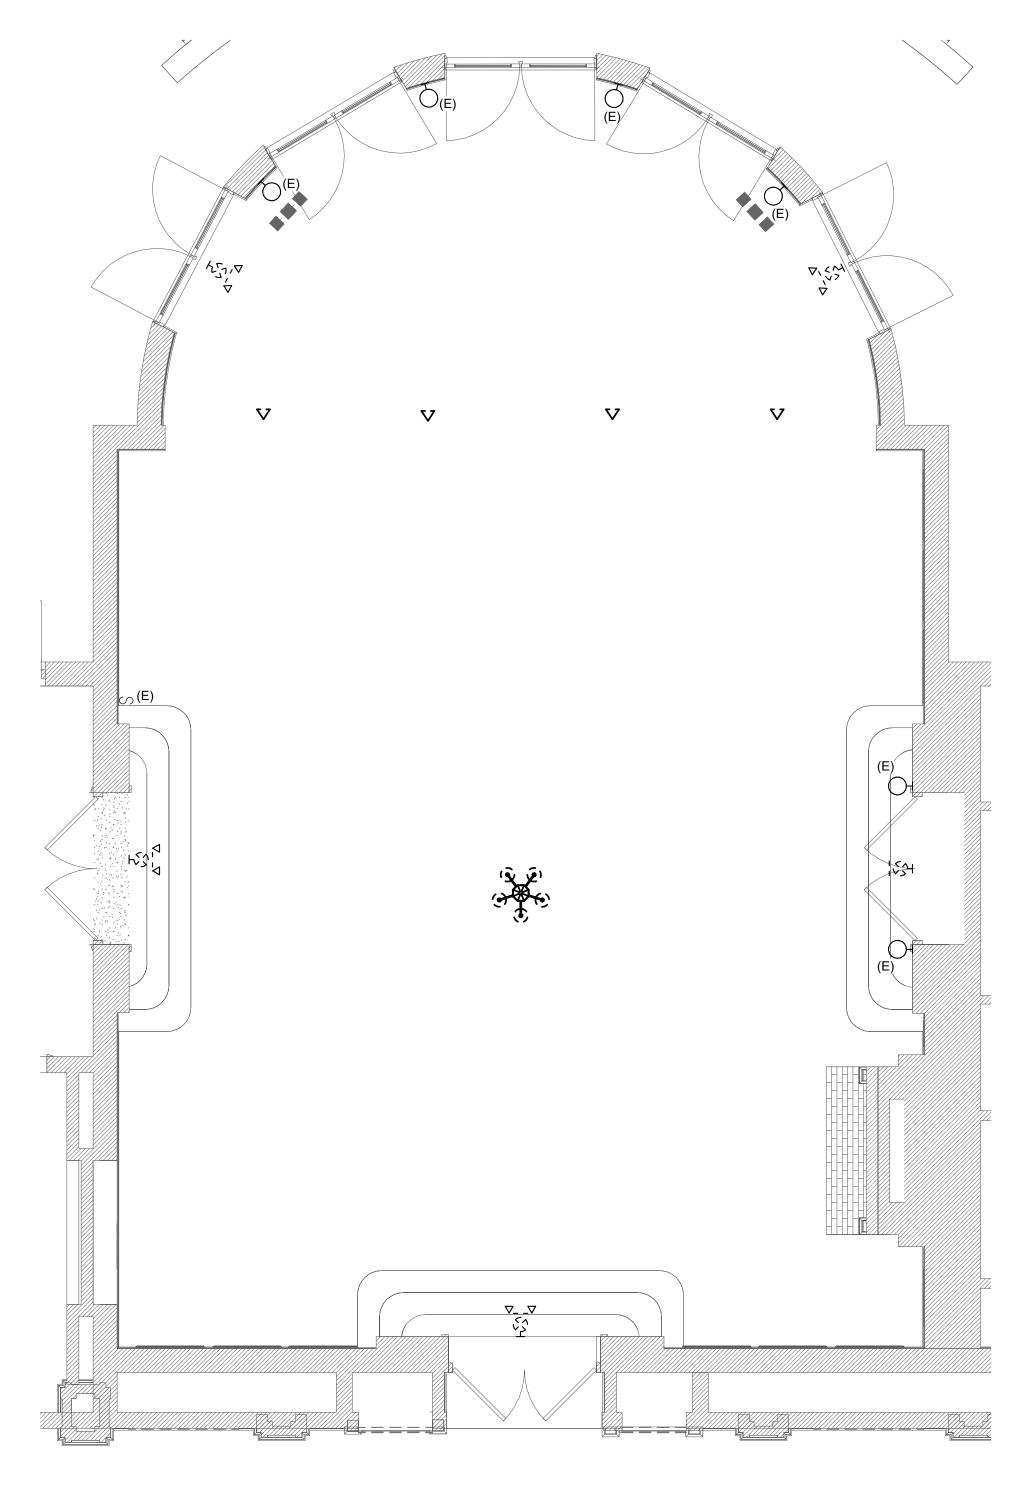
LIGHTING FLOOR PLAN

Sheet Number: ER201A

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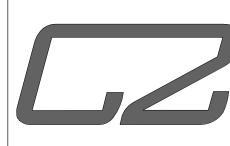


1 LOBBY AND OFFICES LIGHTING REMOVALS PAN ER201A SCALE: 1/4" = 1'-0"





- A. MAINTAIN EXISTING LIGHTING CIRUITS FOR RECONNECTION.
- B. REMOVE ALL EXISTING ELECTRICAL EQUIPMENT AND DEVICES THAT ARE INDICATED TO BE REMOVED (SHOWN DASHED). UNLESS OTHERWISE NOTED, REMOVE ASSOCIATED BRANCH CIRCUIT CONDUIT AND WIRING BACK TO SOURCE. MAINTAIN AND PROTECT ALL EQUIPMENT AND DEVICES THAT ARE INDICATED TO REMAIN.



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	LIGHTING R	EMOVALS

Sheet Number:

ER201B

PLAN

PLOT DATE: 4/29/2024 3:05:17 PM

- A. CONNECT RECEPTACLES TO EXISTING RECEPTACLE CIRCUITS MAINTAINED WITH REMOVALS. MINIMUM CIRCUIT WIRING SHALL BE (2)#12 & (1)#12G IN 3/4" CONDUIT.
- B. ROUTE CONDUITS FOR DATA DROPS DOWN INTO THE BASEMENT TO A JUNCTIN BOX LOCATED IN AN ACCESSIBLE LOCATION. VERIFY AND COORDINATE EXACT ROUTING IN FIELD WITH THE CAMPUS.

E101A DRAWING NOTES

- 1 ROUTE EXISTING FIRE ALARM WIRING MAINTAINED WITH REMOVALS IN NEW 3/4" CONDUIT. ROUTE CONDUIT TIGHT TO WALL AND UP TO ABOVE NEW CEILING. PAINT CONDUIT TO MATCH SURFACE WHERE EXPOSED. SPLICE AND EXTEND WIRING AS
- 2 PROVIDE CONDUIT FOR CIRCUITING AND DATA FROM BELOW IN BASEMENT.
- 3 PROVIDE BACKBOX AND CONDUIT FOR NEW CAMERA, CONFIRM EXACT LOCATION AND CONDUIT ROUTING WITH CAMPUS IN FIELD.
- 4 CIRCUIT TO EXISTING LOBBY RECEPTACLE CIRCUIT. ROUTE ASSOICATED CONDUITS BELOW IN BASEMENT. 5 PROVIDE NEW SURFACE MOUNTED CONDUITS FOR EXISTING COMMUNICATIONS AND POWER CABLES. CUT AND PULL BACK CABLES WHERE REQUIRED TO PULL THROUGH
- 6 CONNECT FCU TO FCU CIRCUIT MAINTAINED WITH REMOVALS. SPLICE AND EXTEND
- 7 PROVIDE SINGLE GANG BACKBOX AND CONDUIT FOR CARD READER AND WIRING BY OTHERS. CONFIRM CONDUIT ROUTING AND FINAL CARD READER LOCATION IN FIELD
- 8 PROVIDE 15A/1P CIRCUIT FROM EXISTING SERUCITY ROOM PANEL TO SECURITY DEVICE



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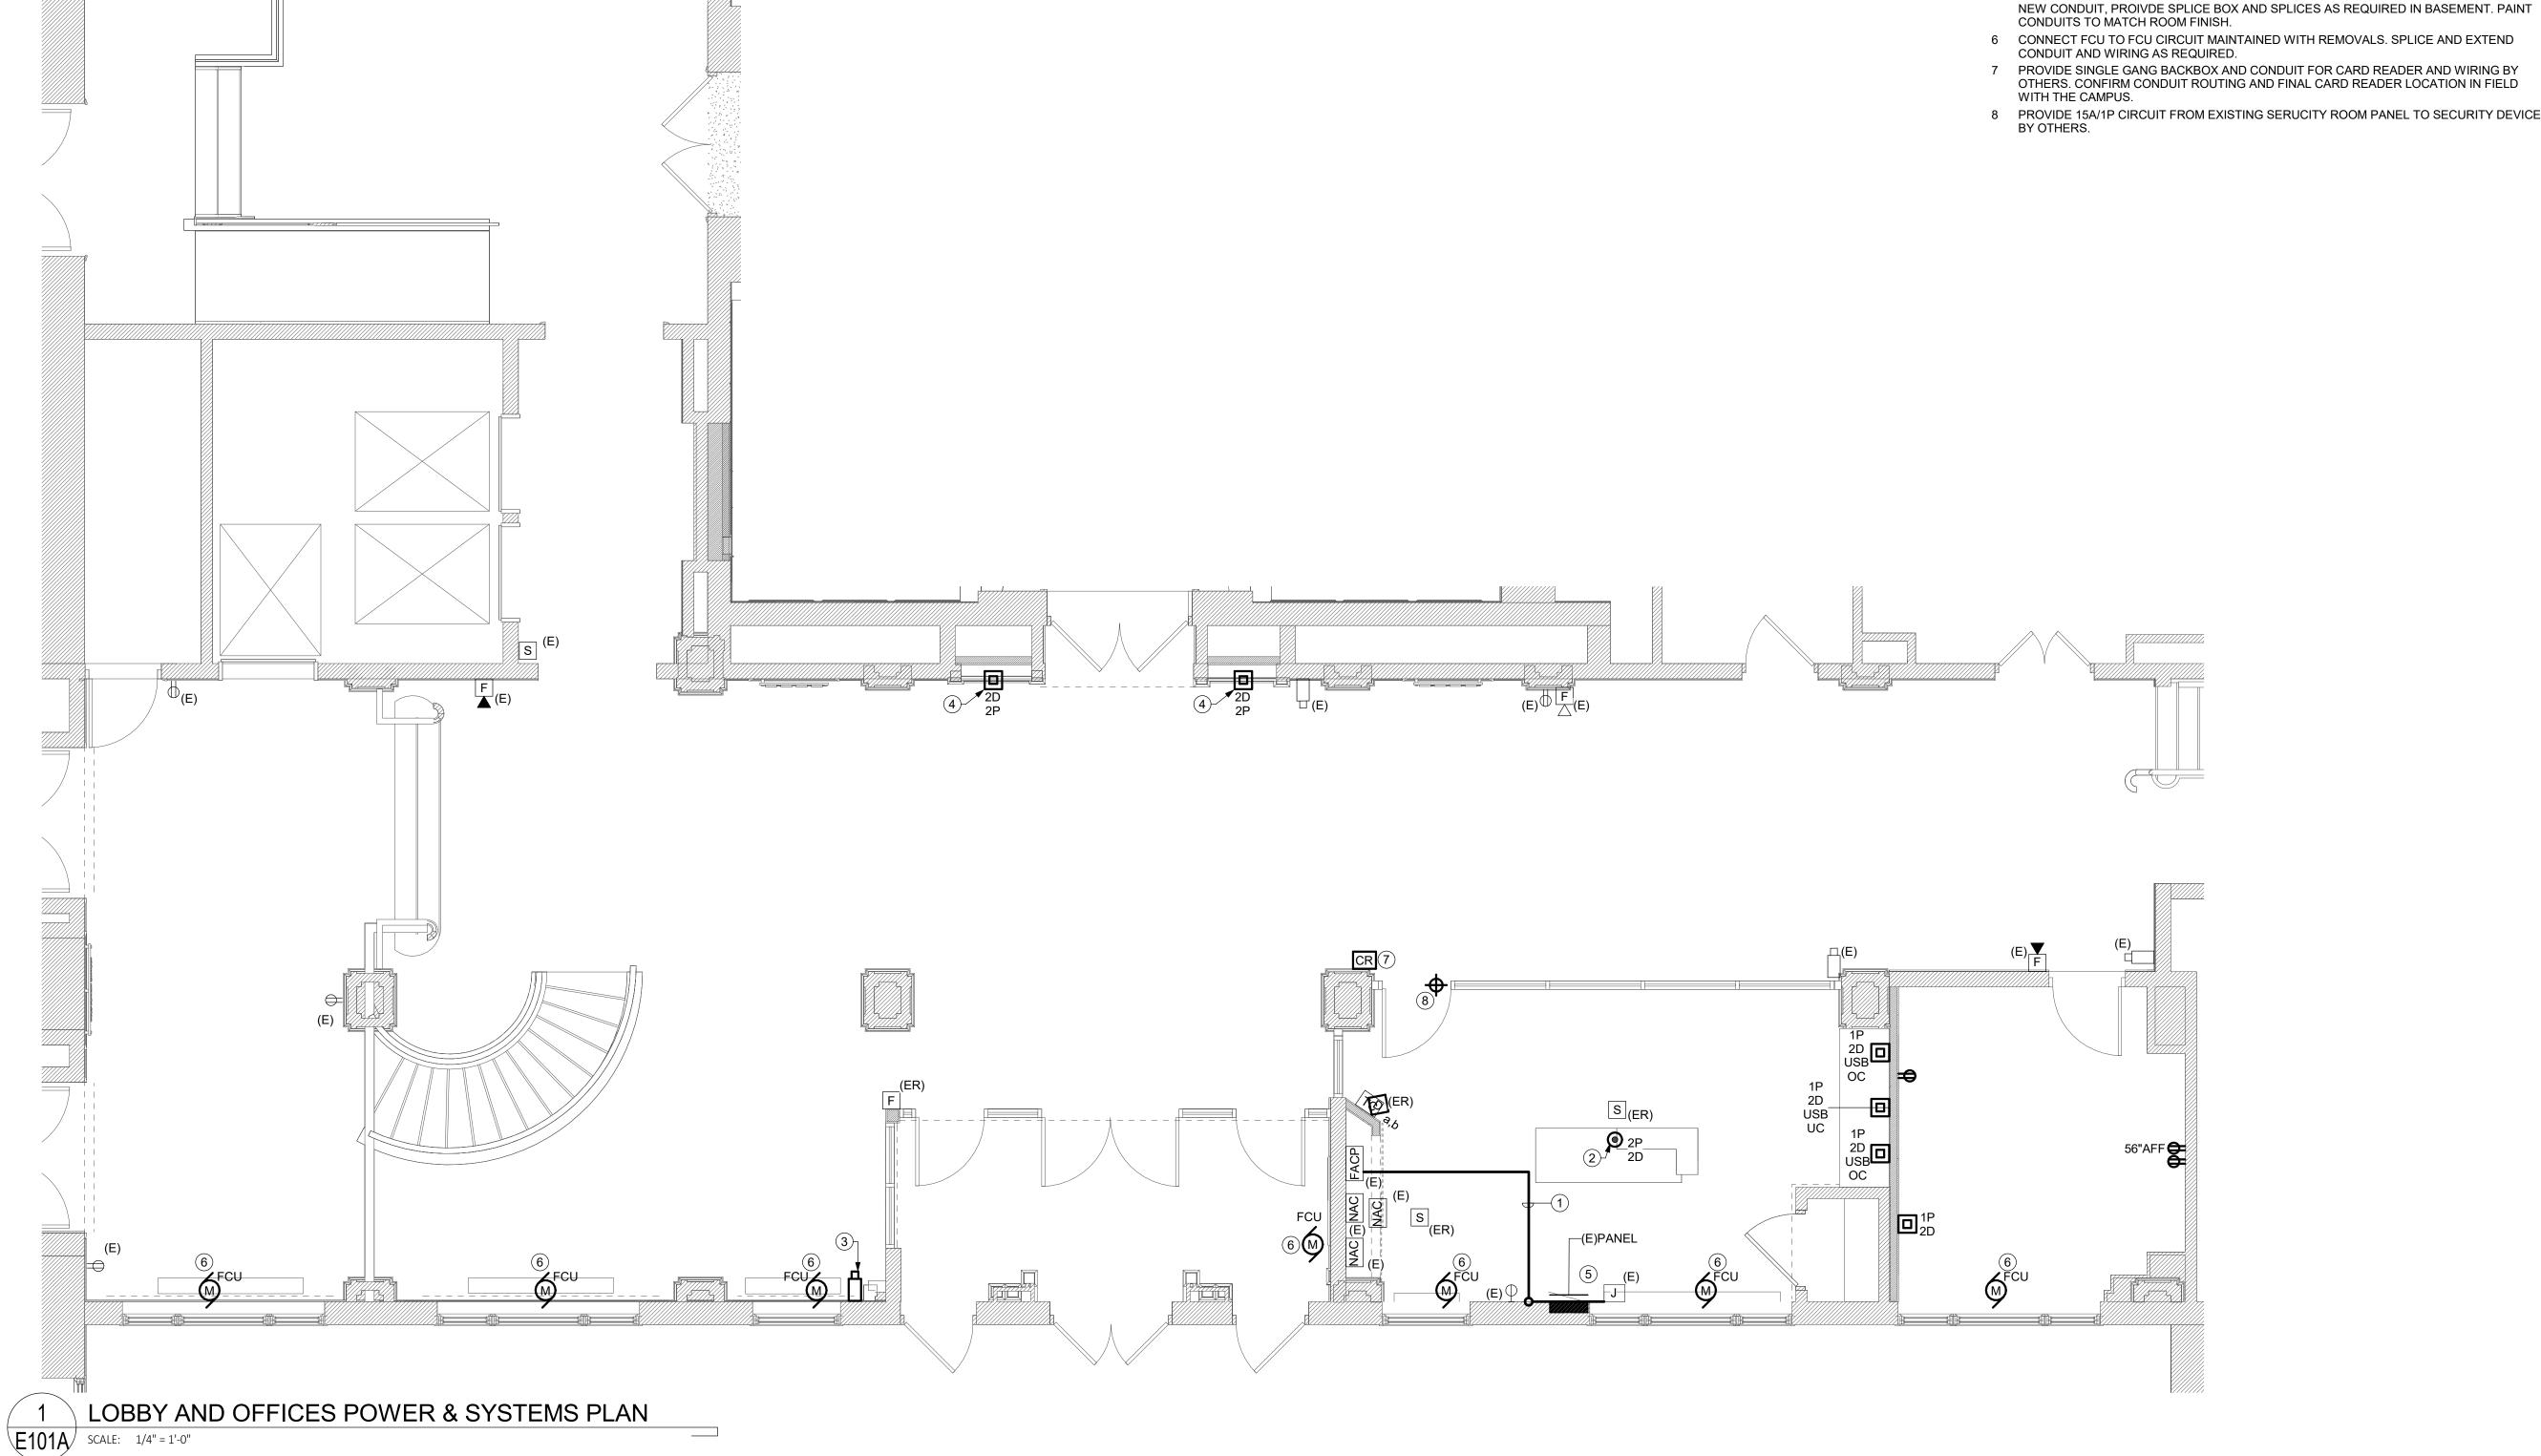
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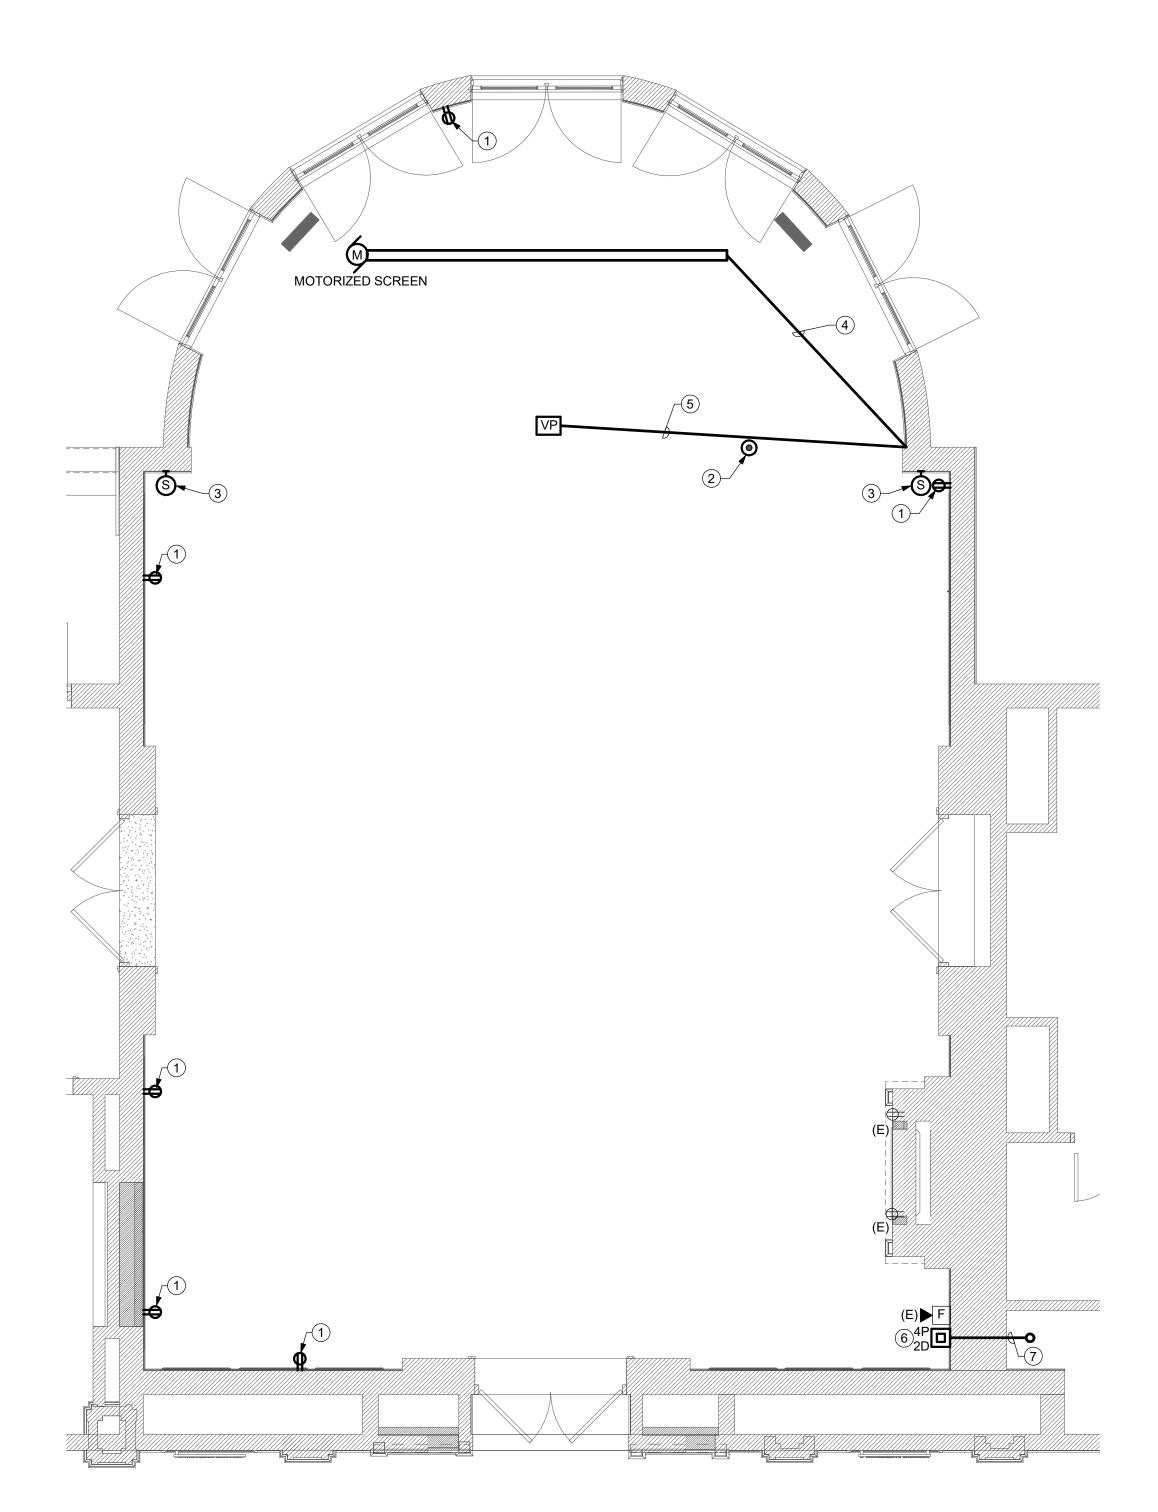
C2 Architecture 04/19/2024 Job No: Sheet Title: ELSTON HALL LOBBY

POWER AND SYSTEMS PLAN

Sheet Number:

E101A





1 MOHAWK ROOM POWER & SYSTEMS PLAN

A. MINIMUM CIRCUIT WIRING SHALL BE (2)#12 & (1)#12G IN 3/4" CONDUIT.

E101B DRAWING NOTES

- 1 PROVIDE RECESSED RETROFIT RECEPTACLE IN EXISTING PLASTER WALL, PROVIDE MC CABLE UP FROM BASEMENT TO CIRCUIT RECEPTACLE. CONNECT TO EXISTING RECEPTACLE CIRCUIT MAINTAINED WITH REMOVALS.
- 2 PROVIDE 2 GANG POKE THROUGH FLOORBOX FOR AV AND POWER. COORDINATE EXACT REQUIREMENTS WITH AV VENDOR. FINAL LOCAITON SHALL BE DETERMINED IN FIELD WITH AV VENDOR AND OWNER'S REPRESENTATIVE. CIRCUIT TO NEAREST EXISTING MOHAWK ROOM RECEPTACLE CIRCUIT.
- 3 PROVIDE 1" CONDUIT FROM SPEAKER MOUNTED IN CHASE BEHIND WALL. ROUTE CONDUIT BELOW IN BASEMENT OVER TO AV RACK IN SOUTHEAST CORNER OF MOHAWK ROOM.
- 4 PROVIDE 1" CONDUIT FROM MOTORIZED SCREEN ABOVE CEILING TO CORNER OF ROOM. ROUTE CONDUIT SURFACE MOUNTED DOWN WALL AND BELOW INTO BASEMENT. ROUTE OVER TO AV RACK IN SOUTHEAST CORNER.
- 5 PROVIDE (2)1" CONDUIT FROM VIDEO PROJECTOR ABOVE CEILING TO CORNER OF ROOM. ROUTE CONDUIT SURFACE MOUNTED DOWN WALL AND BELOW INTO BASEMENT. ROUTE OVER TO AV RACK IN SOUTHEAST CORNER.
- 6 PROVIDE (1)20A/1P CIRCUIT IN EXISTING PANEL LOCATED IN NEW SECURITY OFFICE. CIRCUIT VIDEO PROJECTOR, MOTORIZED SCREEN, AND AV RACK TO THIS CIRCUIT.
- 7 PROVIDE (1)3/4" CONDUIT FOR CIRCUITNG AND (1)1" CONDUIT FOR AV & DATA WIRING. ROUTE CONDUITS THROUGH WALL INTO CHASE AND DOWN INTO BASEMENT BELOW...



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MOHAWK ROOM POWER & SYSTEMS PLAN

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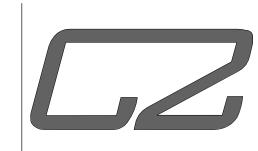
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- A. CONNECT ALL LIGHT FIXTURES TO EXISTING LIGHTING CIRCUITS MAINTAINED WITH REMOVALS. CIRCUITING SHALL BE MINIMUM (2)#12+(1)#12G IN 3/4" CONDUIT.
- B. COORDINATE NEW DOWLIGHTS WITH EXISTING PLASTER CEILING. ADVISE ANY CONFLICTS IN LAYOUT WITH ARCHITECT PRIOR TO FINAL INSTALLATION.
- C. CIRCUIT ALL EXIT SIGNS AND EMERGENCY WALL PACK AHEAD OF ANY LIGHTING CONTROLS.
- D. CONNECT LOBBY AND VESTIBULE FIXTURES TO EXISTING LOBBY LIGHTING CONTROLS MAINTAINED WITH REMOVALS.

E201A DRAWING NOTES

- 1 PRIOR TO ROUGH IN, INVESTIGATE AND VERIFY CONDITION OF ANY EXISTING LIGHTING CIRCUIT WIRING AT EXISTING PENNDANT MEDALLION. CIRCUIT NEW PENDANT TO EXISTING CIRCUIT SHOULD THE EXISTING CIRCUIT BE FOUND IN GOOD CONDITION.IF EXISTING WIRING IS FOUND TO NOT BE IN GOOD CONDITION, COORDINATE CUTTING AND PATCHING CEILING TO ALLOW FOR CIRCUITING TO NEAREST EXISTING PENDANT LIGHT.
- 2 SEE ARCHITECTURAL DETAILS FOR INSTALLATION OF TAPE LIGHT.



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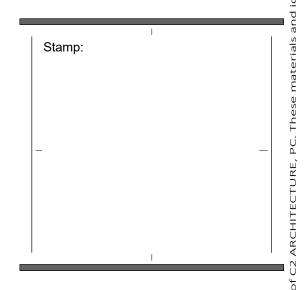
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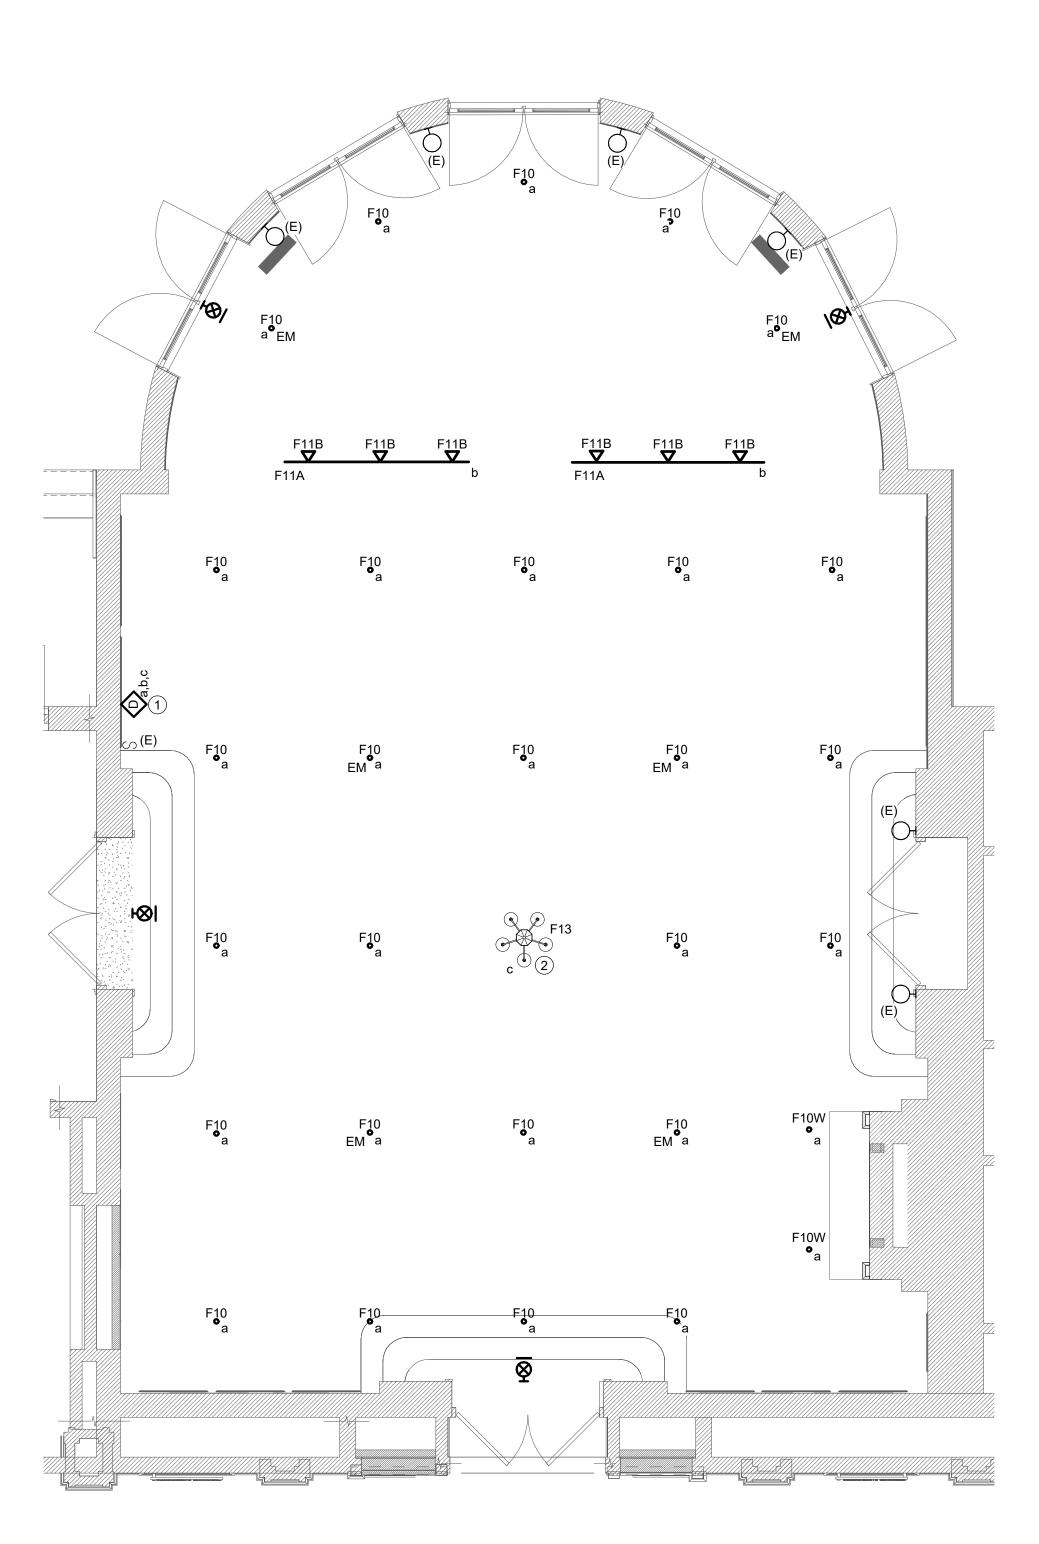
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ELSTON H	ALL LOBBY
LIGHTING F	LOOR PLAN
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F24 • EM

F20 •

E201A



1 MOHAWK ROOM LIGHTING PLAN - ALTERNATE #1 E201B SCALE: 1/4" = 1'-0"

- A. CONNECT ALL LIGHT FIXTURES TO EXISTING CHANDELIER CIRCUIT. CIRCUITING SHALL BE MINIMUM (2)#12+(1)#12G IN 3/4" CONDUIT.
- B. COORDINATE NEW DOWLIGHTS WITH EXISTING PLASTER CEILING. ADVISE ANY CONFLICTS IN LAYOUT WITH ARCHITECT PRIOR TO FINAL INSTALLATION.

E-201 DRAWING NOTES

- 1 PROVIDE CASAMBI WIRELESS CONTROL PLATFORM SWITCH(ES) FOR ON/OFF AND DIMMING CONTROL OF MOHAWK ROOM LIGHT FIXTURES (CASAMBI SWITCH 55 SERIES). PROVIDE (1) CR03 HANDHELD REMOTE CONTROLLER AT PODIUM.
- 2 PROVIDE FDELV600W ELV POWER PACK FOR WIRELESS CONTROL OF CHANDELIER BY CASAMBI SWITCHES.



DESIGN GROUP

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24 AIRPORT ROAD

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SUNY SCCC ELSTON HALL LOBBY & MOHAWK RENOVATIONS

78 Washington Ave Schenectady, NY 12305

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No.	REVISION#	DATE:

Drawn By:	C2 Architecture
Scale:	As Noted
Date:	04/19/2024
Job No:	2349
Sheet Title:	
MOHAV	VK ROOM
LIGHTI	NG PLAN

Sheet Number:


E201B

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		LUMI	NAIRE SCHEE	DULE			
TYPE	DESCRIPTION	MFR. & CATALOG No.	LAMP	VOLTAGE	MOUNTING	UNIT WATTS	REFERENCE NOTES
F10	3' RECESSED DOWNLIGHT DEEP REGRESS, 50 DEGREE BEAM, HIGH EFFICIENCY TEXTURED LENS, RETROFIT MOUNT, 0-10V DIMMING TO 1%	ALPHABET NU3	LED 3000K 90CRI 1680 LUMENS	UNV	CEILING MOUNTED	17	1,3
F10W	SAME AS F10, EXCEPT WALL WASH						1,3
F11A	TRACK SYSTEM, 7'-8" LENGTH, WHITE FINISH	BRUCK 370GES	-	120V	SURFACE		
F11B	TRACK LIGHT FIXTURE WITH 0-10V DIMMING, SPOT LIGHT DYNAMIC ZOOM 21-40 DEGREES, TRACK MOUNTING, HIGH EFFICEINCY TEXTURED LENS, 0-10V DIMMING TO 1%	BRUCK LX PRO	LED 3000K 90CRI 1540 LUMENS	120V	TRACK MOUNT	13	3
F13	CHANDELIER		LED	120V	PENDANT	75	2
F20	CHANDELIER		LED	120V	PENDANT	75	2
F20A	CHANDELIER		LED	120V	PENDANT	75	2
F21	4" RECESSED ROUND BAFFLE DOWNLIGHT, ADJUSTABLE LUMEN OUTPUT, SWITCHABLE WHITE, NEW CONSTRUCION MOUNTING FRAME, 0-10V DIMMING 10% DIM, WHITE FINISH	ACUITY BRANDS JPDZ4	LED 3500K 1200 LUMENS	MVOLT	RECESSED	15	
F22	LAY-IN PANEL, 2X2, SWITCHABLE LUMENS AND COLOR TEMPERATURE	ACUITY BRANDS CPANL	LED 3500K 4400 LUMENS	MVOLT	RECESSED	40.5	
F23	24V COLOR TEMPERATURE SELECTABLE LED TAPE LIGHT	WAC LIGHTING T24	LED 3000K 200 LM/FT	120	SURFACE	2.4W/FT	4
F24	SAME AS F10						1
F25	8'-0" LINEAR PENDANT, DIRECT/INDIRECT LIGHTING, MATTE BLACK PARABOLIC LOUVER, WIDESPREAD INDIRECT OPTIC, STATIC WHITE, 0-10V DIMMING 1% DIM, ARICRAFT CABLE SUSPENDED	ACUITY BRANDS CLX	LED 3000K 90CRI 750 LM/FT DIRECT 350 LM/FT INDIRECT	MVOLT	SUSPENDED	14.1 W/FT	
F26	MONO POINT SPOTLIGHT FIXTURE, ADJUSTABLE BEAM 15-50 DEGREES	WAC LIGHITNG MO-2042	LED 3000K 2520 LUMENS	120-277V	SURFACE	42	
F27	24" STRIP LIGHT FIXTURE, STANDARD EFFICEINCY, FLAT DIFFUSE LENS, 0-10V DIMMING TO 10% DIM	ACUITY BRANDS CLX	LED 3000K 80CRI 2000 LUMENS	MVOLT	SURFACE WALL	18	
EX-1	EXIT SIGN, INTEGRAL BATTERY BACKUP	ACUITY BRANDS EDGR-W-1-G-EL	LED	120V	CEILING		
EX-2	EXIT SIGN, INTEGRAL BATTERY BACKUP	ACUITY BRANDS EDGR-W-1-G-EL-WM	LED	120V	WALL		
EM-1	EMERGENCY WALLPACK	ACUITY BRANDS LMIGN2-EM-SQ-WH-MR+LM IGN2-ACCY-RBB-CP	LED	120V	CEILING		
EM-2	EMERGENCY WALLPACK	ACUITY BRANDS LMIGN2-EM-SQ-WH-MR+LM IGN2-ACCY-RBB-CP	LED	120V	WALL		

REFERENCE NOTES:

- 1. PROVIDE WITH INTEGRAL BATTERY WHERE CALLED FOR ON DRAWINGS.
- 2. SEE SPECIFICATIONS FOR ALLOWANCES, BASE BIDSHALL INCLUDE INSTALLATION OF LIGHT FIXTURE AS WELL AS PROVIDING ASSOCIATED CONDUIT AND WIRING.
- 3. PROVIDE WITH CASAMBI BLUETOOTH CONTROL FOR INSTALLATIONS IN THE MOHAWK ROOM.
- 4. CONFIRM FINAL LENGTHS IN FIELD, SEE ARCHITECTURAL DRAWINGS FOR ADDITIONAL INFORMATION. PROVIDE REMOTE DRIVER.

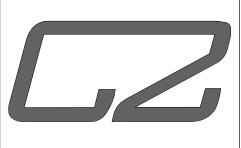

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	TRICAL DULES
	DULES

E701

Sheet Number:

PLOT DATE: 4/29/2024 3:05:20 PM