COMMUNICATIONS SYSTEM LEGEND

DESCRIPTION

SYMBOL	DESCRIPTION	HEIGHT	
CR	HARDWIRED RCU RFID PROXIMITY CARD READER, WITH BATTERY-BACKUP IN CASE OF POWER FAILURE; SEE NOTE SC-8 ON THIS SHEET	SEE DETAI 6/TO.01	
©	DOOR CONTACT		
E	ELECTRIC STRIKE OR ELECTRIC DOOR LOCK; COORDINATE WITH DOOR HARDWARE SCHEDULE FOR EXACT EQUIPMENT		
FOB	RFID FOB RECEIVER FOR VEHICLE ENTRY		
	INDUCTIVE LOOP DETECTOR		
KP	KEY PAD	SEE DETAI 6/TO.01	
MAG	MAGNETIC DOOR LOCK; COORDINATE WITH DOOR HARDWARE SCHEDULE FOR EXACT EQUIPMENT		
abla	PASSIVE INFRARED SENSOR (PIR)		
REX	REQUEST-TO-EXIT	SEE DETA 6/TO.01	
•	DOOR RELEASE PUSHBUTTON	SEE DETA 6/TO.01	
TELE ENTRY	TELEPHONE—ENTRY STATION, BUTTERFLYMX (OR EQUAL); PROVIDE COMPATIBLE PEDESTAL WHERE REQUIRED	SEE DETAI 6/T0.01	

CONSULTANT; THESE ITEMS ARE NOT WITHIN THE JSE LOW VOLTAGE SCOPE OF WORK.

IP CAMERA SYSTEM LEGEND		
SYMBOL	DESCRIPTION	HEIGHT
⊳ C1	FIXED IP CAMERA; ONE (1) CAT 6 CABLE DROP ONLY FOR FUTURE CAMERA LOCATION; CAMERAS & ASSOCIATED HARDWARE ARE TO BE PROVIDED & INSTALLED BY OWNER.	
∇ C1	270° MULTISENSOR IP CAMERA; ONE (1) CAT 6 CABLE DROP ONLY FOR FUTURE CAMERA LOCATION; CAMERAS & ASSOCIATED HARDWARE ARE TO BE PROVIDED & INSTALLED BY OWNER.	
∇ C1 Δ	360° MULTISENSOR IP CAMERA; ONE (1) CAT 6 CABLE DROP ONLY FOR FUTURE CAMERA LOCATION; CAMERAS & ASSOCIATED HARDWARE ARE TO BE PROVIDED & INSTALLED BY OWNER.	
CÍ ✓	DUAL SENSOR FIXED IP CAMERA; ONE (1) CAT 6 CABLE DROP ONLY FOR FUTURE CAMERA LOCATION; CAMERAS & ASSOCIATED HARDWARE ARE TO BE PROVIDED & INSTALLED BY OWNER.	

AUDIO-VISUAL SYSTEM LEGEND			
SYMBOL	DESCRIPTION	HEIGHT	
S	CEILING-MOUNTED SPEAKER; DAISY CHAIN ALL SPEAKERS, CONTROLS, ETC. WITHIN A GIVEN ZONE, THEN HOME RUN TO THE A/V HEAD END LOCATION		
SW	WALL-MOUNTED SPEAKER; DAISY CHAIN ALL SPEAKERS, CONTROLS, ETC. WITHIN A GIVEN ZONE, THEN HOME RUN TO THE A/V HEAD END LOCATION		
SL	LANDSCAPE SPEAKER; DAISY CHAIN ALL SPEAKERS, CONTROLS, ETC. WITHIN A GIVEN ZONE, THEN HOME RUN TO THE A/V HEAD END LOCATION		
VC	VOLUME CONTROL; DAISY CHAIN ALL SPEAKERS, CONTROLS, ETC. WITHIN A GIVEN ZONE, THEN HOME RUN TO THE A/V HEAD END LOCATION	SEE DETAIL 6/TO.01	
AV	FLOOR-MOUNTED A/V CONNECTIVITY OUTLET; SEE DETAILS 14 & 16/T-002		
PROJ	CEILING-MOUNTED PROJECTOR; PROVIDE TWO (2) CEILING-MOUNTED CAT6 DROPS		
ALL A/V CABLING, INCLUDING CAT6 USED FOR A/V APPLICATIONS, SHALL BE SHIELDED, NO EXCEPTION			

RACEWAY & CIRCUITING SYSTEM		
SYMBOL	DESCRIPTION	HEIGHT
0	JUNCTION BOX. SEE FLOOR PLANS FOR EXACT SIZE.	
Js	FLOOR MOUNTED JUNCTION BOX. "S" = SURFACE, "R" = RECESSED.	
PB	GROUND MOUNTED PULL BOX.	
SEC-1	TYPICAL HOMERUN. "SEC" ADJACENT TO HOMERUN ARROWHEAD INDICATES ROUTE WIRE & CONDUIT TO THE NEAREST SECURITY EQUIPMENT CABINET.	
	RACEWAY INSTALLED CONCEALED IN WALL AND \ OR ABOVE CEILING.	
	RACEWAY INSTALLED CONCEALED IN SLAB OR BELOW GRADE.	
	RACEWAY INSTALLED EXPOSED.	
· / •	CONDUIT UP \ CONDUIT DOWN	
1	GROUND. #6 AWG TO 8'-0" COPPERWELD GROUND ROD	
SUR	SURGE PROTECTION DEVICE	

SYSTEMS COORDINATION NOTES:

- SC-1 COORDINATE EXACT STUB-OUT LOCATIONS OF SITE CONDUITS FOR INCOMING TELECOM SERVICE WITH THE OWNER'S CONTRACTED SERVICE PROVIDER(S).
- SC-2 ALL COPPER VOICE/DATA CABLING SHALL BE CATEGORY 6. ALL PATCH PANELS/PUNCH-DOWNS USED FOR WIRELESS ACCESS POINTS, SURVEILLANCE CAMERAS, & ACCESS CONTROL POWER SUPPLIES SHALL BE POWER-OVER-ETHERNET (PoE) RATED.
- SC-3 PROVIDE PULL BOX, SIZED PER N.E.C., FOR ANY CONDUIT RUN EXCEEDING 200' OR MORE THAN 270° OF CUMULATIVE BEND.
- SC-4 PROVIDE ONE (1)-1" CONDUIT TO EACH PEDESTRIAN GATE, INCLUDING POOL GATES, FROM THE NEAREST TELECOM ROOM.
- SC-5 PROVIDE ONE (1)-2" CONDUIT TO EACH VEHICLE ENTRY GATE FROM THE NEAREST TELECOM ROOM.
- SC-6

 ALL FLOOR BOX LOCATIONS SHALL BE COORDINATED WITH ELECTRICAL; SHARE SAME BOX AS ELECTRICAL, WITH DIVIDER TO SEPARATE LOW VOLTAGE. PROVIDE ONE (1)-1" CONDUIT, MINIMUM, FROM FLOOR BOX TO THE NEAREST WALL, THEN UP TO THE ACCESSIBLE CEILING SPACE FOR LOW VOLTAGE HOME RUNS.
- SC-7 CLUBHOUSE MDF ROOM SHALL BE EQUIPPED WITH A MINIMUM OF ONE (1) WALL-MOUNTED RACK, MAIN TELECOMMUNICATIONS GROUNDING BUSBAR, COAXIAL BULKHEAD PANEL, 110 BLOCKS, CONDUIT SLEEVES, SPACE FOR SERVICE PROVIDER EQUIPMENT, ETC. REQUIRED PER THE SYSTEMS SHOWN IN THE DRAWINGS & SPECIFICATIONS.
- SC-8 PROVIDE 18"W LADDER RACK IN EACH TELECOM ROOM AS REQUIRED TO DISTRIBUTE CABLING.
- SC-9 ELECTRICAL SHALL PROVIDE CLUBHOUSE MDF ROOM & EACH TELECOM UTILITY CABINET WITH A MINIMUM OF TWO (2) DEDICATED 20A QUADS & ONE (2) STANDARD DUPLEX RECEPTACLES; ALL DEDICATED QUADS SHALL BE ON EMERGENCY POWER WHERE AVAILABLE.
- SC-10 PROVIDE ONE (1) DEDICATED VOICE LINE FOR POOL EMERGENCY PHONE, TWO (2) DEDICATED VOICE LINES AT EACH BUILDING'S FIRE ALARM CONTROL PANEL (FACP), & ONE (1) DEDICATED VOICE LINE PER ELEVATOR IN THE RESPECTIVE ELEVATOR MACHINE ROOM OR ELEVATOR PIT.
- SC-11 PROVIDE WIRELESS ACCESS POINTS FOR FULL WIFI COVERAGE IN ALL AMENITY/COMMON AREAS & ADMINISTRATIVE AREAS.
- SC-12 PROVIDE COMPLETE ZONED AUDIO SYSTEMS IN AMENITY/COMMON AREAS & ADMINISTRATIVE AREAS COMPRISED OF CEILING-MOUNTED SPEAKERS (INDOORS), LANDSCAPE-STYLE SPEAKERS (OUTDOORS), VOLUME CONTROLLERS, AUDIO ZONE CONTROLLERS, MAIN AUDIO SYSTEM CONTROLLER, ETC. REQUIRED FOR A FULLY FUNCTIONING SYSTEM.
- SC-13 PROVIDE A/V CONNECTIVITY IN ALL CONFERENCE ROOMS, INCLUDING CONNECTIONS FOR HDMI, VGA, 3.5MM AUDIO, CAT6 NETWORK CONNECTIONS, ETC. ALL A/V CABLING, INCLUDING CAT6 USED FOR A/V APPLICATIONS, SHALL BE SHIELDED; NO EXCEPTIONS.
- SC-14 PROVIDE ONE (1)-1" CONDUIT BETWEEN EACH LANDSCAPE-STYLE SPEAKER LOCATION FOR SHIELDED AUDIO CABLING. LANDSCAPE-STYLE SPEAKERS ARE TYPICALLY LOCATED IN COURTYARDS OR AROUND THE POOL AREA. COORDINATE EXACT SPEAKER LOCATIONS & UNDERGROUND CONDUIT ROUTINGS WITH LANDSCAPING TO AVOID OBSTRUCTIONS.
- SC-15 PROVIDE MONITORING STATION FOR IP SURVEILLANCE CAMERA SYSTEM. MONITORING STATION SHALL BE COMPRISED OF TWO (2) LED MONITORS, NETWORKED PC, KEYBOARD, MOUSE, REQUIRED SYSTEM SOFTWARE, ETC. LOCATE MONITORING STATION IN THE LEASING/MANAGEMENT OFFICE. NETWORK VIDEO RECORDER (NVR) SHALL BE LOCATED IN THE CLUBHOUSE MDF ROOM.
- SC-16 PROVIDE MONITORING/MANAGEMENT STATION FOR ACCESS CONTROL SYSTEM FOR EACH BUILDING. MONITORING STATION SHALL BE COMPRISED OF LED MONITOR, NETWORKED PC, KEYBOARD, MOUSE, FOB ENCODER, REQUIRED SYSTEM SOFTWARE, ETC. LOCATE MONITORING STATION IN THE LEASING/MANAGEMENT OFFICE.
- SC-17 PROVIDE ADD-ALTERNATE PRICING FOR COMPLETE INTRUSION DETECTION SYSTEMS AT ALL GROUND LEVEL UNITS, AMENITY/COMMON AREAS, & ADMINISTRATIVE AREAS COMPRISED OF DOOR CONTACTS, WINDOW CONTACTS, PASSIVE INFRARED SENSORS OR GLASS BREAK SENSORS, ALARM KEYPADS, HORNS, ETC. REQUIRED FOR A FULLY FUNCTIONING SYSTEM. CONFIRM WITH OWNER IF REQUIRED.
- SC-18 COORDINATE ALL TELEVISION LOCATIONS WITH ARCHITECTURAL & INTERIORS PLANS. PROVIDE INFRASTRUCTURE FOR TV/DATA OUTLETS, COMPRISED OF RUNS OF ONE (1) CAT6 DROP & ONE (1) RG-6 COAXIAL DROP IN A SINGLE FACEPLATE, AT EACH LOCATION; TELEVISIONS ARE FF&E.

GENERAL NOTES:

- G-1 COORDINATE WITH THE MECHANICAL, ELECTRICAL & PLUMBING DRAWINGS FOR EQUIPMENT INSTALLED UNDER OTHER DIVISIONS OF THE DOCUMENTS.
- G-2 EQUIPMENT GROUNDING CONDUCTORS SHALL BE INSTALLED IN ALL RACEWAYS
- G-3

 COORDINATE LOCATION OF CEILING MOUNTED EQUIPMENT WITH THE MECHANICAL AND ELECTRICAL DEVICES INSTALLED IN OR ON THE CEILING. LAYOUT EQUIPMENT PROVIDED SHOWN ON THE SECURITY DRAWINGS FOR SYMMETRICAL LAYOUT WITH OTHER EQUIPMENT IN OR ON THE CEILING.
- G-4 "WP" INDICATES ASSOCIATED DEVICE IS WEATHERPROOF.
- G-5 COORDINATE LOCATION OF VOICE/DATA OUTLETS WITH POWER OUTLETS. SEE TYPICAL DETAILS FOR SPACING.
- G-6 CONTRACTOR SHALL SIZE CONDUIT BASED ON N.E.C. AND WIRING MANUFACTURER USED AND ON COMBINATION OF CIRCUITS IN CONDUIT. CONDUIT SIZE SHOWN ON DRAWINGS IS MINIMUM SIZE.
- G-7 MINIMUM SIZE CONDUIT, ALL SYSTEMS 3/4", UNLESS OTHERWISE NOTED.
- POWER CIRCUITS FOR THE SECURITY EQUIPMENT ARE SHOWN ON THE ELECTRICAL PANEL BOARD SCHEDULES & DRAWINGS. CONDUIT, WIRING & TERMINATIONS AT THE DEVICES ARE BY THE ELECTRICAL CONTRACTOR. TERMINATIONS AT THE POWER PANEL BOARD ARE BY THE ELECTRICAL CONTRACTOR.
- G-9 COORDINATE ALL SYSTEMS WITH THE ELECTRICAL DRAWINGS AND SPECIFICATIONS FOR CONDUIT REQUIREMENTS.
- G-10

 ALL CONDUIT SHALL BE CONCEALED WITHIN THE CEILING, SLAB OR WALLS. NO EXPOSED/SURFACE CONDUIT IS ACCEPTABLE, UNLESS OTHERWISE APPROVED. CONDUIT MAY BE EXPOSED IN THE TELECOM EQUIPMENT ROOMS ONLY.
- G-11 MOUNT ALL DEVICES IN HANDICAP AREAS IN ACCORDANCE WITH ADA STANDARDS. SEE NOTES A-1 & A-2.
- G-12 ALL COAXIAL CABLE HOME RUNS 150' OR LESS FROM ANY LOCATION TO ANY TELECOM ROOM SHALL BE RG6 COAXIAL CABLE.
- G-13 ALL COAXIAL CABLE HOME RUNS OVER 150' & BELOW 295' FROM ANY LOCATION TO ANY TELECOM ROOM SHALL BE RG11 COAXIAL CABLE.
- G-14 ALL CAT6 CABLE HOME RUNS FROM ANY LOCATION SHALL NOT EXCEED 295' TO ANY TELECOM ROOM.
- G-15 ANY CABLING ROUTED IN PLENUM SPACE SHALL BE PLENUM-RATED CABLE.
- G-16 TELECOM DEVICE OUTLETS SHALL NOT BE LOCATED "BACK TO BACK" IN WALLS DIVIDING ROOMS AND/OR UNITS.
- G-17 MOUNTING HEIGHTS SHOWN ARE TO THE CENTER OF THE OUTLET OR DEVICE, UNLESS OTHERWISE NOTED.
- G-18 ALL SYMBOLS INDICATED IN THE LEGEND MAY NOT NECESSARILY BE USED ON
- G-19 CONNECT POWER DIRECTLY TO THE EQUIPMENT DESIGNED TO RECEIVE DIRECT CONNECTION. PROVIDE RECEPTACLE COMPATIBLE WITH EQUIPMENT DESIGNED FOR PLUG-IN POWER CONNECTION.

EXISTING CONDITIONS NOTES:

- E-1 THE SECURITY CONTRACTOR SHALL BE RESPONSIBLE FOR EXACT DIMENSIONS OF ALL CONDUIT & WIRE FOR THE SECURITY WORK. THE SECURITY CONTRACTOR SHALL FIELD VERIFY ALL EXISTING CONDITIONS FOR ALL HOMERUNS TO THE NEW & EXISTING EQUIPMENT.
- E-2 THE CONTRACTOR SHALL BE RESPONSIBLE FOR LOCATING ALL EXISTING UTILITIES PRIOR TO THE INSTALLATION OF ANY UNDERGROUND CONDUITS. ANY DAMAGE TO THE EXISTING UTILITIES SHALL BE RESTORED TO THE ORIGINAL CONDITION AT NO COST TO THE OWNER.

REVISION NO. REVISION DATE REVISION DESCRIPTION 10/18/2024 ISSUED FOR PERMIT

16000 Memorial Drive Suite 100 Houston, Texas 77079

MEFKS 16000 Suite Suite

Ave, Denver, CO 802 Jevelopment of

GRANT STREET A
290 E. 17th Ave, Der
A Developr

JOB NO.: 22035

X NOT FOR CONSTRUCTION
ISSUED FOR PRICING

ISSUED FOR PERMIT

ISSUED FOR CONSTRUCTION
SHEET TITLE:

LEGENDS & NOTES
- TELECOM

DRAWING NO.


Jordan & Skala Engineers

555 17th Street, Suite 700 Denver, CO 80202
p. 303.586.2375

Project Number: 23080076 Drawn By: TP Checked By: BMT

SYSTEM NO. WL1001

F RATINGS- 1, 2, 3, AND 4 HR (SEE ITEMS 2 AND 3) T RATINGS - 0, 1, 2, 3, AND 4 HR (SEE ITEM 3) L RATING AT AMBIENT — LESS THAN 1 CFM/SQ. FT. L RATING AT 400 F - LESS THAN 1 CFM/ SQ. FT.

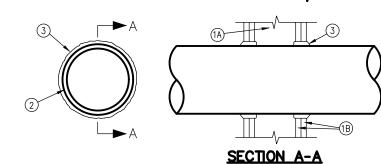


- WALL ASSEMBLY THE 1, 2, 3 OR 4 HR. FIRE-RATED GYPSUM WALLBOARD/STUD WALL ASSEMBLY SHALL BE CONSTRUCTED OF THE MATERIALS AND IN THE MANNER DESCRIBED IN THE INDIVIDUAL U300 OR U400 SERIES WALL OR PARTITION DESIGNS IN THE UL FIRE RESISTANCE DIRECTORY AND SHALL INCLUDE THE FOLLOWING CONSTRUCTION FEATURES:
- A. STUDS WALL FRAMING MAY CONSIST OF EITHER WOOD STUDS (MAX 2 HR. FIRE RATED ASSEMBLIES) OR STEEL CHANNEL STUDS. WOOD STUDS TO CONSIST OF NOM. 2 BY 4 IN. LUMBER SPACED 16 IN. OC WITH NOM. 2 BY 4 IN. LUMBER END PLATES AND CROSS BRACES STEEL STUDS TO BE MIN. 3-5/8 IN. WIDE BY 1-3/8 IN. DEEP CHANNELS SPACED MAX. 24
- B. WALLBOARD, GYPSUM* NOM 1/2 OR 5/8 IN. THICK, 4 FT. WIDE WITH SQUARE OR TAPERED EDGES. THE GYPSUM WALLBOARD TYPE, THICKNESS, NUMBER OF LAYERS, FASTENER TYPE AND SHEET ORIENTATION SHALL BE AS SPECIFIED IN THE INDIVIDUAL U300 OR U400 SERIES DESIGN IN THE UL FIRE RESISTANCE DIRECTORY. MAX. DIAM. OF OPENING IS 13-1/2 IN.
- CONDUIT 4 IN. DIAM. (OR SMALLER) MULTI-CONDUCTOR CABLE. CABLE TO BE INSTALLED NEAR CENTER OF STUD CAVITY WIDTH AND TO BE RIGIDLY SUPPORTED ON BOTH SIDES OF WALL ASSEMBLY.
- FILL, VOID OR CAVITY MATERIAL* CAULK CAULK FILL MATERIAL INSTALLED TO COMPLETELY FILL ANNULAR SPACE BETWEEN CABLE AND GYPSUM WALLBOARD AND WITH A MIN. 1/4 IN. DIAM. BEAD OF CAULK APPLIED TO CABLE AT ITS EGRESS FROM THE WALL. CAULK INSTALLED SYMMETRICALLY ON BOTH SIDES OF WALL ASSEMBLY. THE HOURLY F RATING OF THE FIRESTOP SYSTEM IS DEPENDENT UPON THE HOURLY FIRE RATING OF THE WALL ASSEMBLY IN WHICH IT IS INSTALLED, AS SHOWN IN THE FOLLOWING TABLE. THE HOURLY T RATING OF THE FIRESTOP SYSTEM IS DEPENDENT UPON THE TYPE OR SIZE OF THE CONDUIT AND THE HOURLY FIRE RATING OF THE WALL ASSEMBLY IN WHICH IT IS INSTALLED, AS TABULATED BELOW:

MAX. CABLE DIAM., IN.	ANNULAR SPACE, IN.	F RATING, HR.	T RATING, HR.
1	0 to 3/16	1 or 2	1 or 2
1	1/4 to 1/2	3 or 4	3 or 4
4	0 to 1/4	1 or 2	0
4	0 to 1-1/2	1 or 2	0

#0 TO 1-1/2 IN. ANNULAR SPACE APPLIES ONLY WHEN TYPE CP-25 WB+ CAULK IS USED AND ONLY WHEN THE MIN. THICKNESS OF THE GYPSUM WALLBOARD IS 5/8 IN. FOR 1 HR. RATED WALLS AND 1-1/4 IN. FOR 2 HR. RATED WALLS.


MINNESOTA MINING & MFG. CO. - CP 25WB+. *BEARING THE UL CLASSIFICATION

1 CABLE PENETRATION AT RATED WALL T0.01 SCALE: NONE

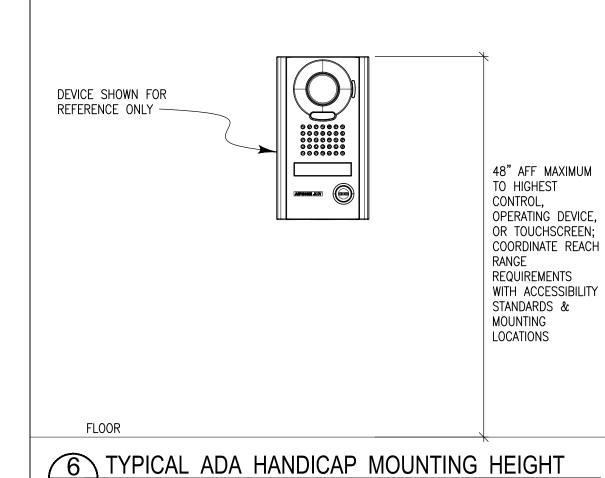


T0.01 SCALE: NONE


MAXIMUM 1/8" CLEARANCE FRONT FACE OF WALL ----BETWEEN BOX AND THE WALL BOARD (TYPICAL) ——— 1 OR 2 HOUR FIRE -MAXIMUM 1/8" RECESS RATED GYPSUM WALL DEPTH OF BOX FROM FACE BOARD ASSEMBLY ——— OF THE WALL STEEL OR WOOD WALL STUD ——— - RECTORSEAL METACAULK MOLDABLE PUTTY PAD OUTLET BOX

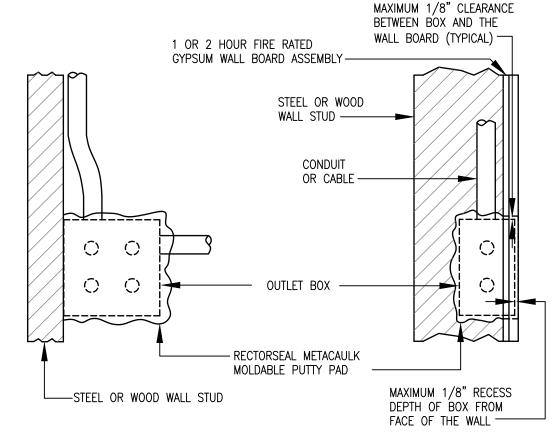


WALL OPENING PROTECTION SYSTEM FOR 4"x4" MAXIMUM SIZE OUTLET BOXES MOUNTED: ON OPPOSITE SIDES OF A WALL LESS THAN 24" APART, OR WHERE MORE THAN FIVE (5) OUTLET BOXES ARE INSTALLED PER 100 SQUARE FEET OF A WALL SURFACE ON THE SAME SIDE. BOXES SHALL NOT BE INSTALLED BACK TO BACK. 1 OR 2 HOUR RATING.

2 WALL OPENING PROTECTION -FIRE RATED WALL SCALE: NONE

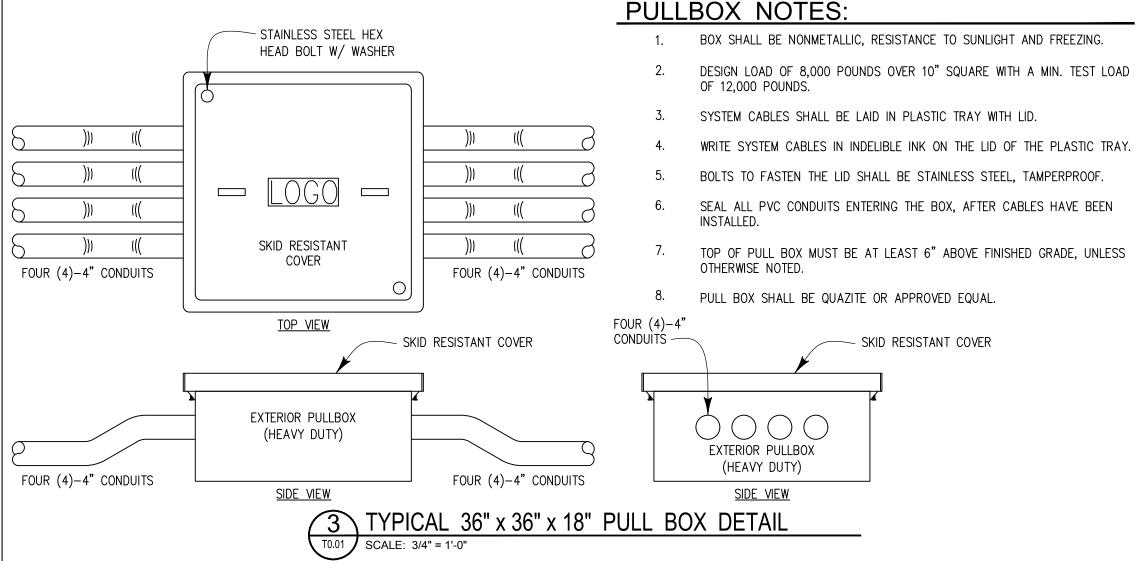

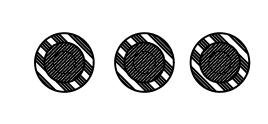

PLAN VIEW

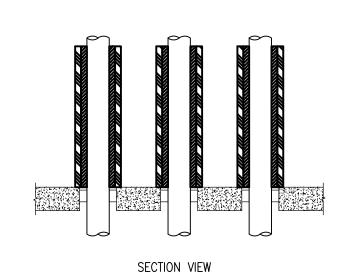


PENETRATIONS OF RATED FLOOR ASSEMBLIES SHALL COMPLY WITH IBC REQUIREMENTS FOR F-AND T-RATINGS. T-RATINGS ARE NOT REQUIRED FOR PENETRANTS CONCEALED WITHIN A WALL


THIS DRAWING INDICATES METHOD(S) FOR T-RATINGS OF METALLIC PENETRANTS, WHERE THE ROOM (OR AREA) ABOVE OR BELOW THE FLOOR DOES NOT HAVE WALLS AND CEILING WITH AN F-RATING THAT MEETS OR EXCEEDS THAT FOR THE FLOOR. LISTED FIRESTOPPING MATERIALS SHALL BE USED TO SATISFY F-RATING REQUIREMENTS.

WHERE DISTANCE BETWEEN METALLIC CONDUITS EXCEEDS 4", INSTALL FIRE PROTECTIVE WRAP AROUND CONDUIT GROUP TO A MINIMUM DISTANCE OF 48" ABOVE OR BELOW THE FLOOR ASSEMBLY. USE 2 LAYERS FOR 2-HOUR RATED FLOOR, 1 LAYER FOR 1-HOUR RATED FLOOR. WRAP SHALL BE THERMAL CERAMICS FIREMASTER FASTWRAP XL OR APPROVED EQUAL.

4 T-RATINGS OF METALLIC PENETRANTS CONDUIT WRAP SCALE: NONE

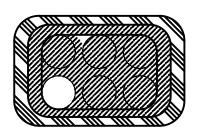

PLAN VIEW

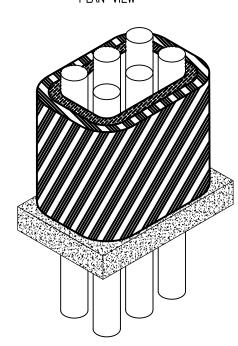

SECTION VIEW

PENETRATIONS OF RATED FLOOR ASSEMBLIES SHALL COMPLY WITH IBC REQUIREMENTS FOR F-AND T-RATINGS. T-RATINGS ARE NOT REQUIRED FOR PENETRANTS CONCEALED WITHIN A WALL

THIS DRAWING INDICATES METHOD(S) FOR T-RATINGS OF METALLIC PENETRANTS, WHERE THE ROOM (OR AREA) ABOVE OR BELOW THE FLOOR DOES NOT HAVE WALLS AND CEILING WITH AN F-RATING THAT MEETS OR EXCEEDS THAT FOR THE FLOOR. LISTED FIRESTOPPING MATERIALS SHALL BE USED TO SATISFY F-RATING REQUIREMENTS.

WHERE DISTANCE BETWEEN METALLIC CONDUITS IS 4" OR LESS, INSTALL FIRE PROTECTIVE WRAP AROUND CONDUIT GROUP TO A MINIMUM DISTANCE OF 48" ABOVE OR BELOW THE FLOOR ASSEMBLY. USE 2 LAYERS FOR 2-HOUR RATED FLOOR, 1 LAYER FOR 1-HOUR RATED FLOOR. WRAP SHALL BE THERMAL CERAMICS FIREMASTER FASTWRAP XL OR APPROVED EQUAL.

5 T-RATINGS OF METALLIC PENETRANTS GROUPED CONDUIT WRAP SCALE: NONE

Ш И L

M

GRANT STREET APARTMENTS 290 E. 17th Ave, Denver, CO 80203

NOT FOR CONSTRUCTION ISSUED FOR PRICING

ISSUED FOR PERMIT ISSUED FOR CONSTRUCTION SHEET TITLE:


COMMUNICATION

DRAWING NO.

Jordan & Skala Engineers DETAILS-TELECOM 555 17th Street, Suite 700 Denver, CO 80202 p. 303.586.2375 Checked By: BMT

Project Number: 23080076

Drawn By: TP

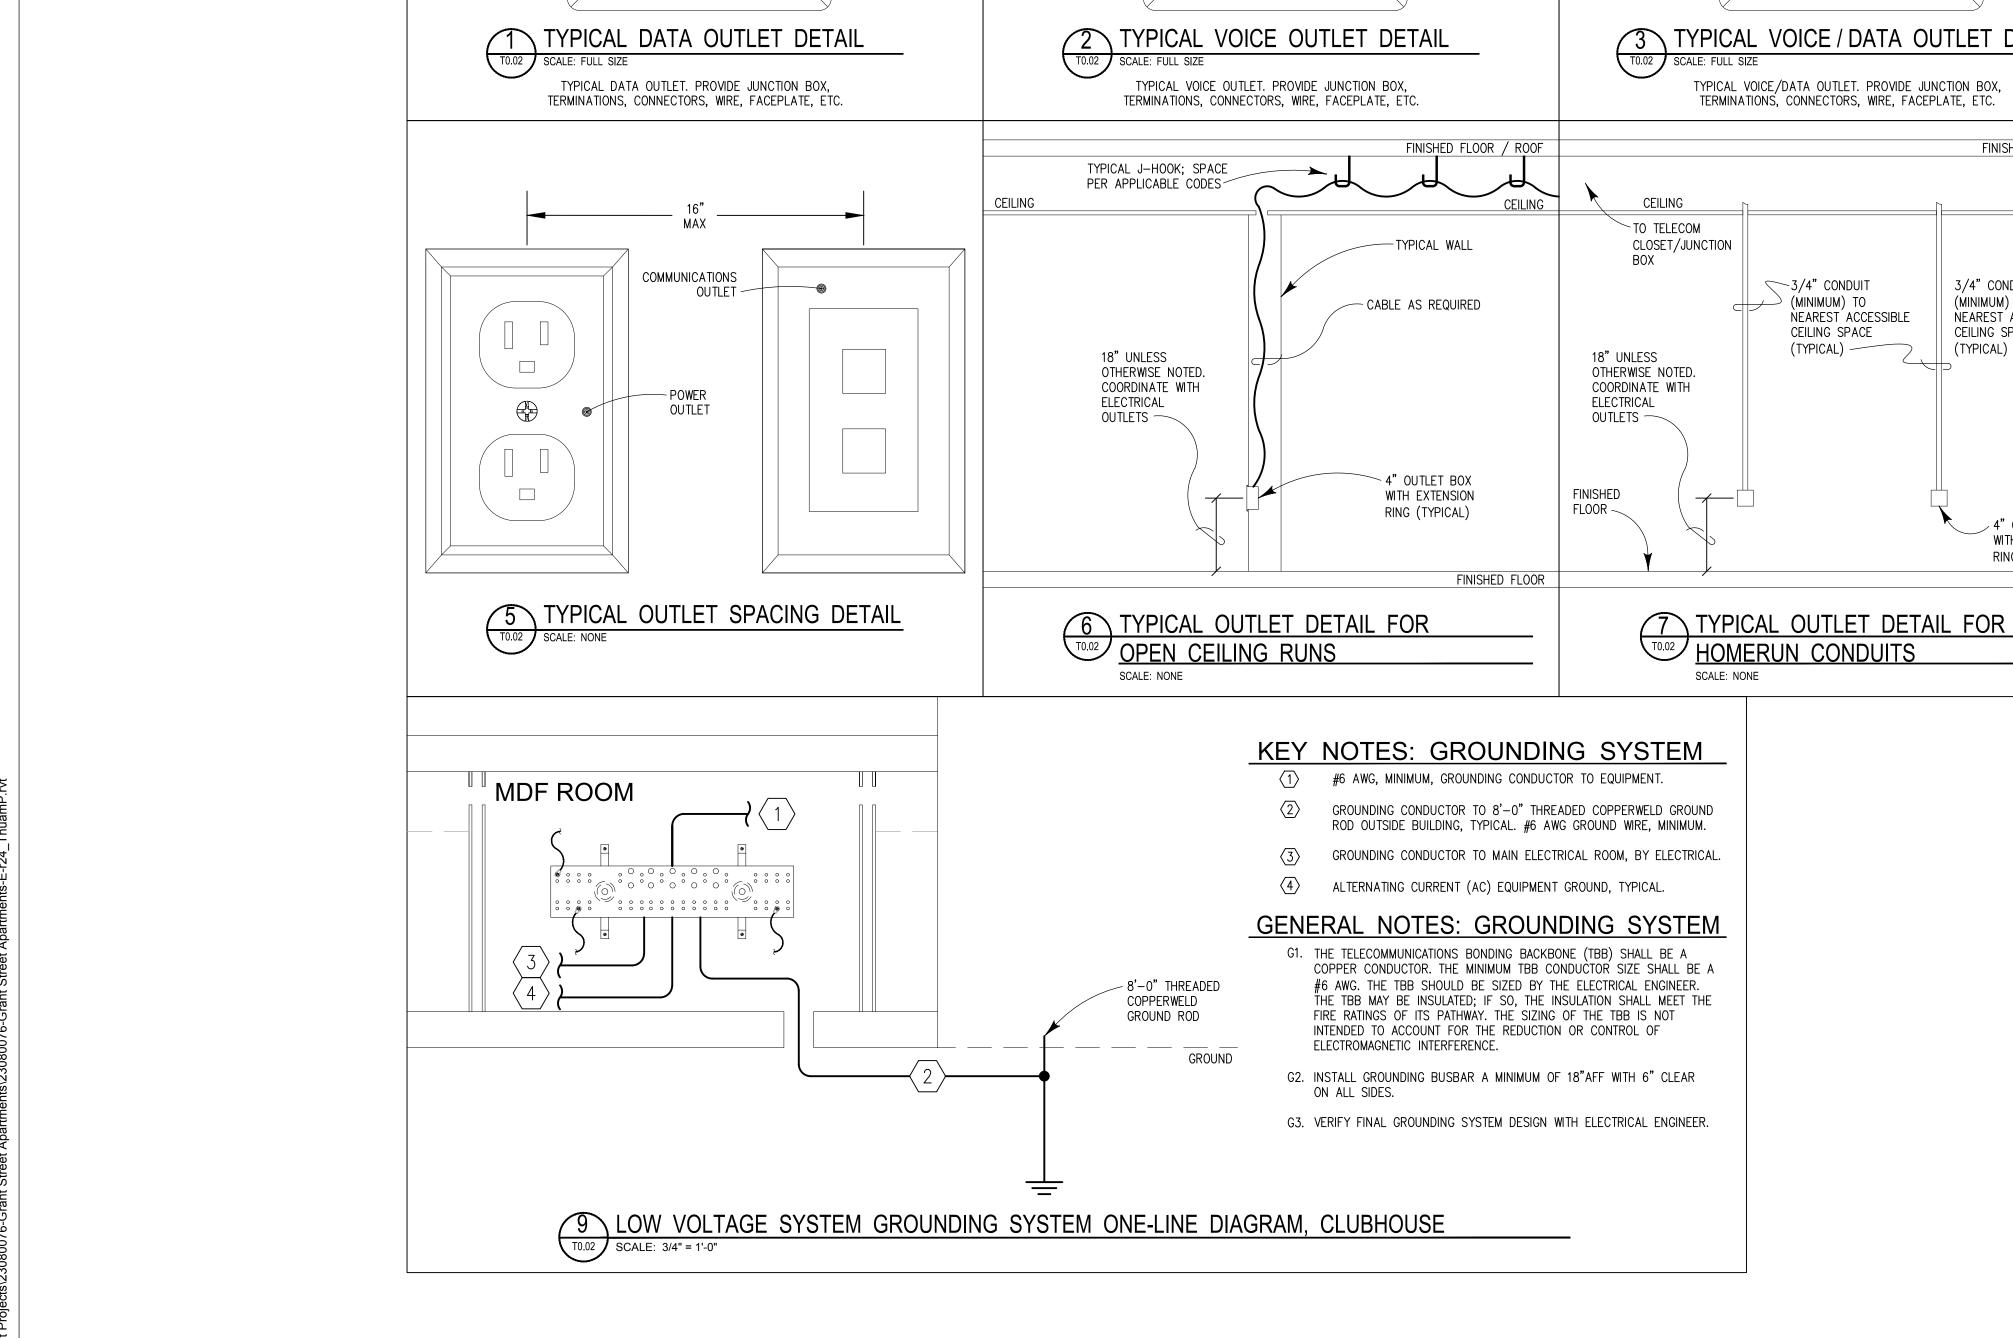

PHILLIPS HEAD

- FACEPLATE

COORDINATE

COLOR WITH

THE OWNER

1d V PLAN SYMBOL

SCREWS (TYPICAL)

TYPICAL COPPER

CONNECTOR

TERMINATION

LABEL WINDOW

& COVER (TYP) -

VOICE 3456

PHILLIPS HEAD

FACEPLATE

COORDINATE

COLOR WITH

THE OWNER

PLAN SYMBOL

SCREWS (TYPICAL) -

TYPICAL COPPER

TYPICAL COPPER CONNECTOR

TERMINATION ~

LABEL WINDOW

& COVER (TYP) -

CONNECTOR

TERMINATION

DATA

VOICE

VOICE 3456

3/4" CONDUIT

(MINIMUM) TO

(TYPICAL) —

NEAREST ACCESSIBLE CEILING SPACE

PHILLIPS HEAD

SCREWS (TYPICAL) -

TYPICAL COPPER


CONNECTOR

TERMINATION

LABEL WINDOW

& COVER (TYP) -

DATA 3456

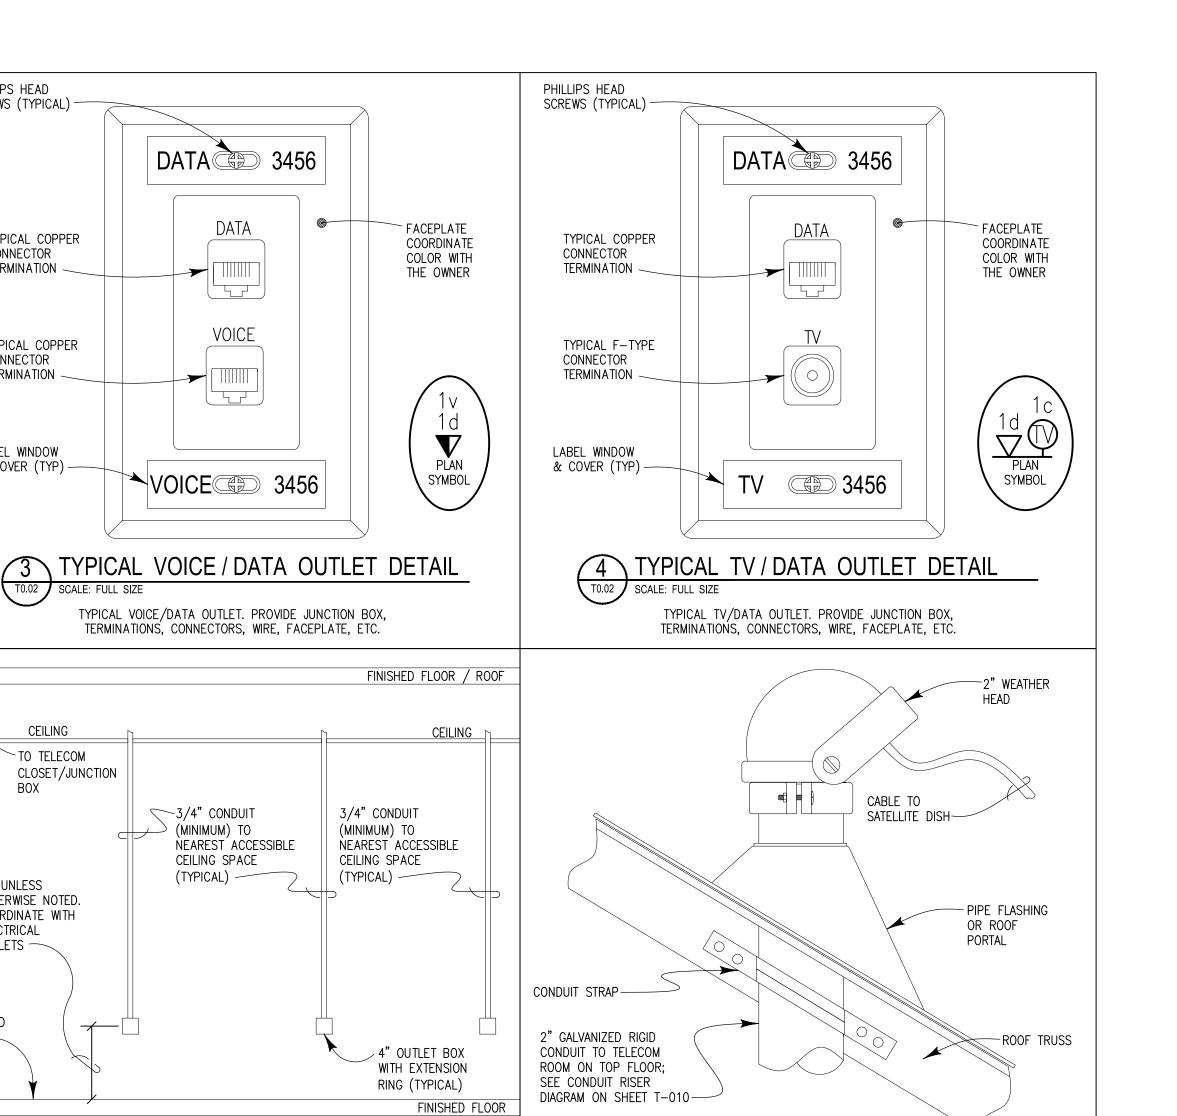

8 ROOFTOP SATELLITE DISH WEATHERHEAD

PARTNER MEEK.

> GRANT STREET APARTMENTS 290 E. 17th Ave, Denver, CO 80203 A Development of Abacus Capital Group

NOT FOR CONSTRUCTION

ISSUED FOR PRICING ISSUED FOR PERMIT ISSUED FOR CONSTRUCTION

SHEET TITLE:


COMMUNICATION DETAILS - TELECOM DRAWING NO.


Checked By: BMT


Drawn By: TP

Jordan & Skala Engineers 555 17th Street, Suite 700 Denver, CO 80202 p. 303.586.2375


Project Number: 23080076

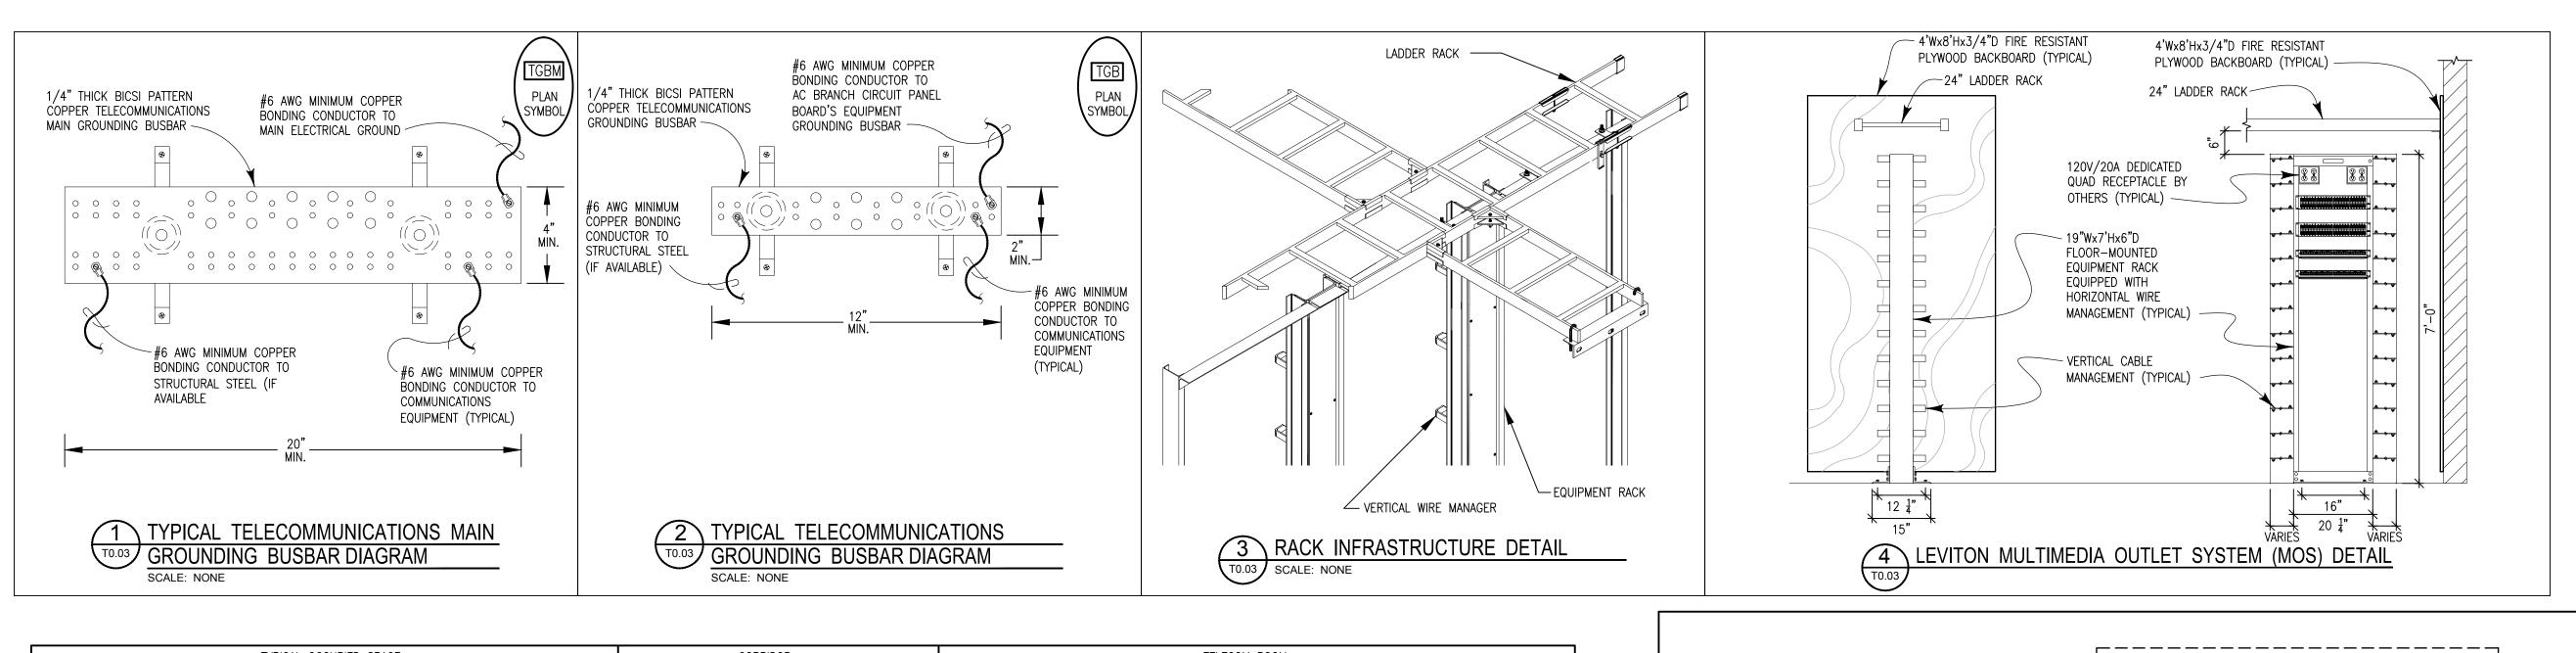

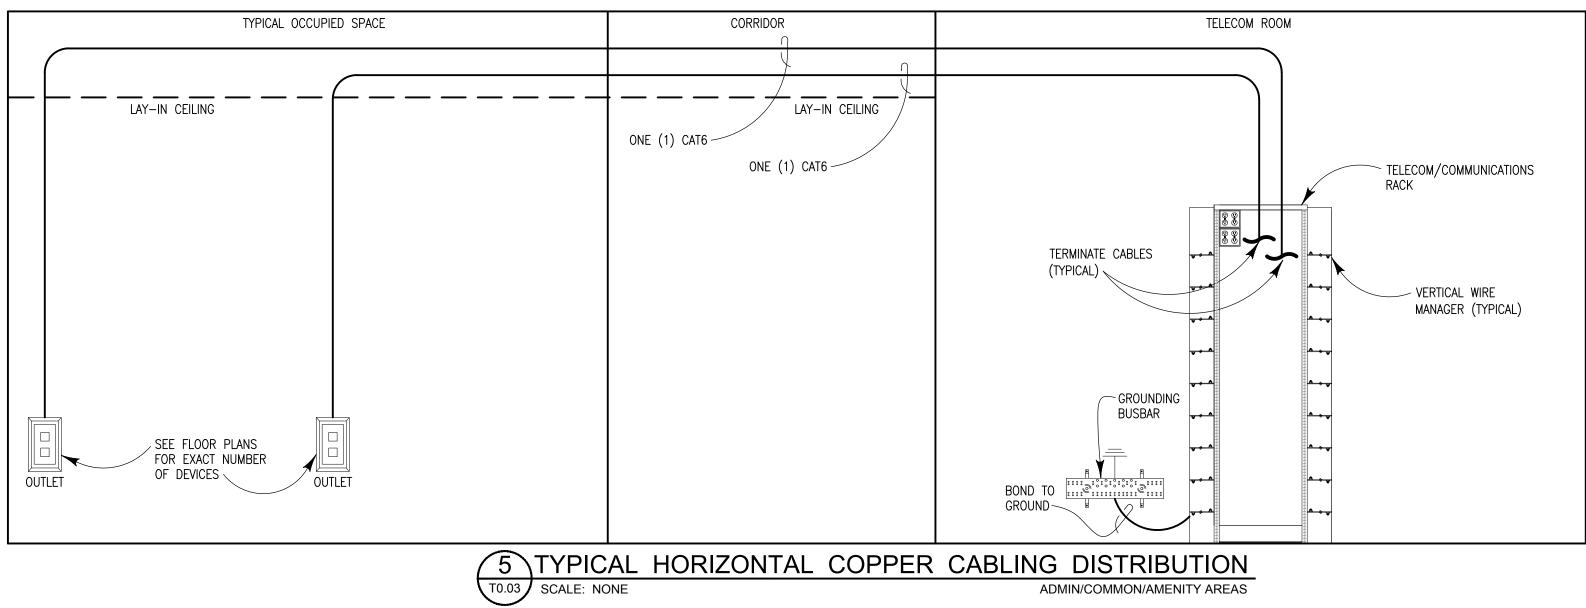

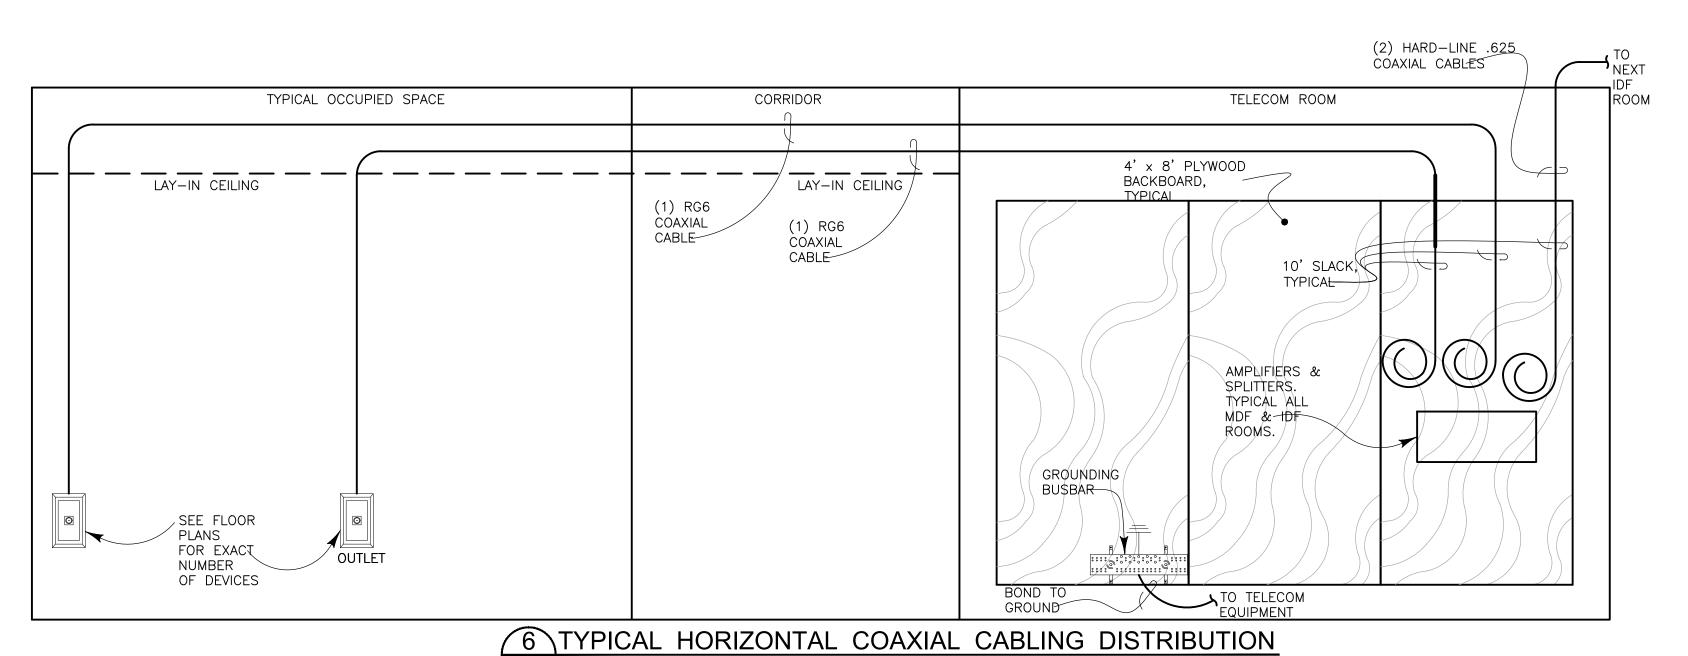

ADMIN/COMMON/AMENITY AREAS

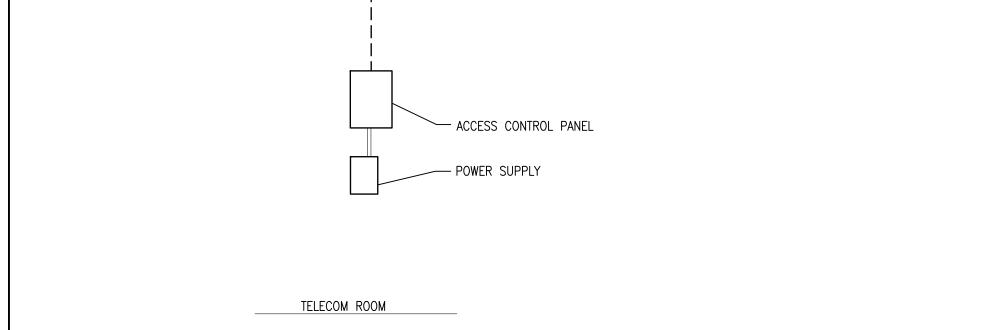

ACCESS CONTROL

COMPOSITE CABLE

7 ACCESS CONTROL COMPOSITE CABLE ONE-LINE DIAGRAM

T0.03 SCALE: 1/2"=1'-0"

· — — — — — — — — — — ACCESS CONTROL COMPOSITE CABLE(S) ROUTED FROM ACCESS CONTROLLED CEILING LOCATIONS; SEE DETAIL 7 THIS 8 ACCESS CONTROL TYPICAL TELECOM ROOM EQUIPMENT T0.03 SCALE: 1/2"=1'-0"

Jordan & Skala Engineers

555 17th Street, Suite 700 Denver, CO 80202
p. 303.586.2375

COMMUNICATION DETAILS - TELECOM

DRAWING NO.

- ONE (1) CAT6 AND ONE (1) 2-CONDUCTOR (FOR POWER) 18AWG FOR RUNS < 100' 16AWG FOR RUNS < 200'

22 AWG x 3 TWISTED PAIRS

∠ 18 AWG x 4 CONDUCTORS

_ 22 AWG x 4 CONDUCTORS

22 AWG x 2 CONDUCTORS

22 AWG x 4 CONDUCTORS

MAG OR E

TYPICAL ACCESS CONTROLLED DOOR

MEEKS NOT FOR CONSTRUCTION ISSUED FOR PRICING ISSUED FOR PERMIT ISSUED FOR CONSTRUCTION SHEET TITLE: COMMUNICATION

Checked By: BMT Drawn By: TP

GENERAL NOTES:

- REFER TO ARCHITECTURAL DOOR SCHEDULE FOR DEVICES
 AND REQUIREMENTS FOR EACH DOOR.
- 2. ELECTRICAL CONTRACTOR TO PROVIDE ADDITIONAL CONDUIT
- WHERE INDICATED ON PLAN DRAWINGS.


 3. INTERFACE DOOR LOCKING DEVICES WITH AUTO DOOR
 - OPENERS, DOOR HOLD OPEN MAGNETS, AND HANDICAP ASSIST DOOR OPENERS ON SECURITY DOORS.
- 4. ALL MAGNETIC LOCKS SHALL BE MOUNTED ON THE SECURE SIDE OF THE DOOR, UNLESS OTHERWISE INDICATED.5. EMERGENCY DOOR RELEASE PULL STATIONS AND

PUSH-TO-EXIT BUTTONS MUST BE MOUNTED WITHIN 40" OF

6. FOR STOREFRONT TYPE DOORS, STUB CONDUIT OR FLEX INTO FRAME STRUCTURE AND FISH CABLE TO DEVICE.


KEY NOTES:


- DOUBLE GANG BACKBOX WITH SINGLE GANG PLASTER RING SUPPLIED AND INSTALLED BY ELECTRICAL CONTRACTOR.
- 12"x12"x6" NEMA 12 HOFFMAN BOX WITH HINGED COVER SUPPLIED AND INSTALLED BY ELECTRICAL CONTRACTOR. MOUNT ABOVE ACCESSIBLE CEILING ON SECURE SIDE OF DOOR.
- (3) MORTAR GUARD SUPPLIED AND INSTALLED BY LV CONTRACTOR.
- PROVIDE ADAPTER PLATE FOR MOUNTING MOTION SENSOR TO BACKBOX.
- AT SHEETROCK WALLS, STUB CONDUIT INTO WALL TO 4"
 BELOW CEILING. FISH WIRE TO SURFACE—MOUNTED MOTION
- (6) PIR INSTALLED IN CEILING ON SECURE SIDE OF DOOR.

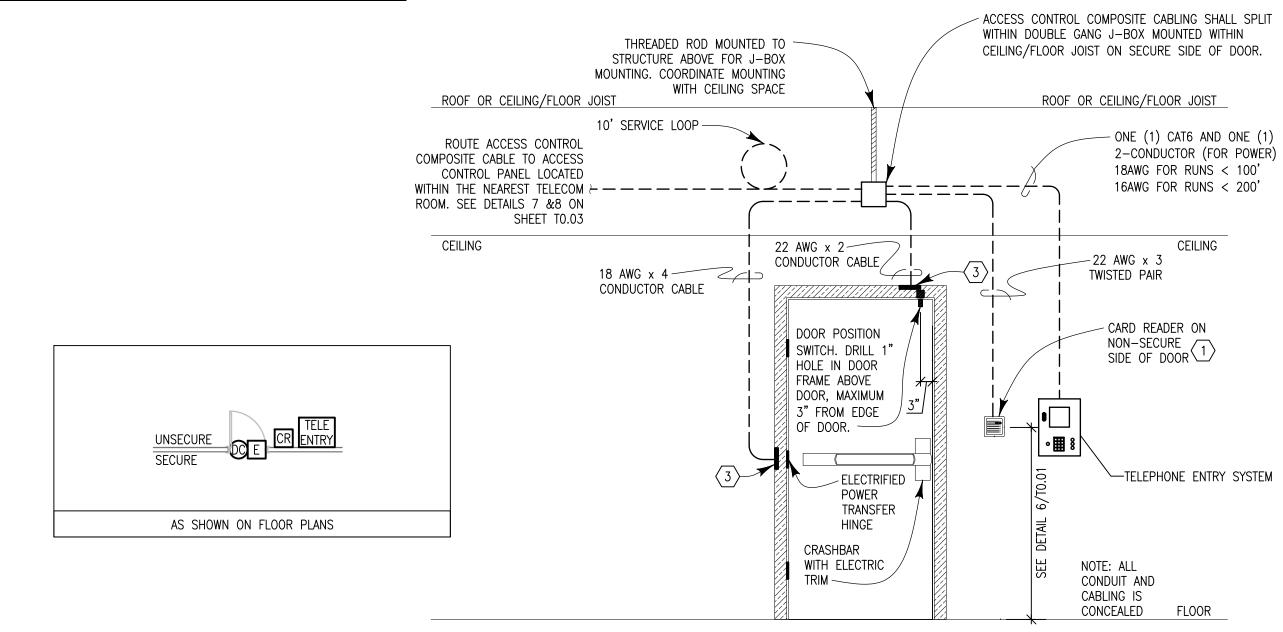


SINGLE DOOR WITH CARD READER & ELECTRIC CRASH BAR

SCALE: 1/2"=1'-0"

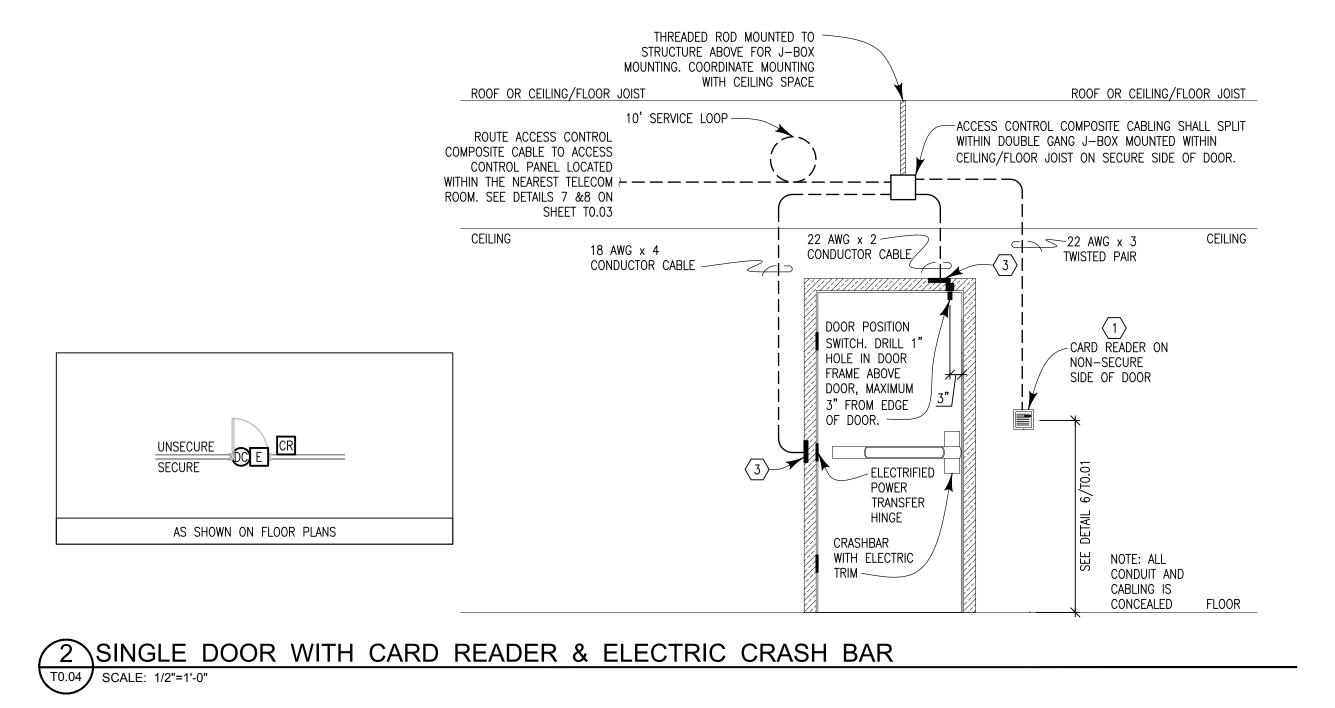

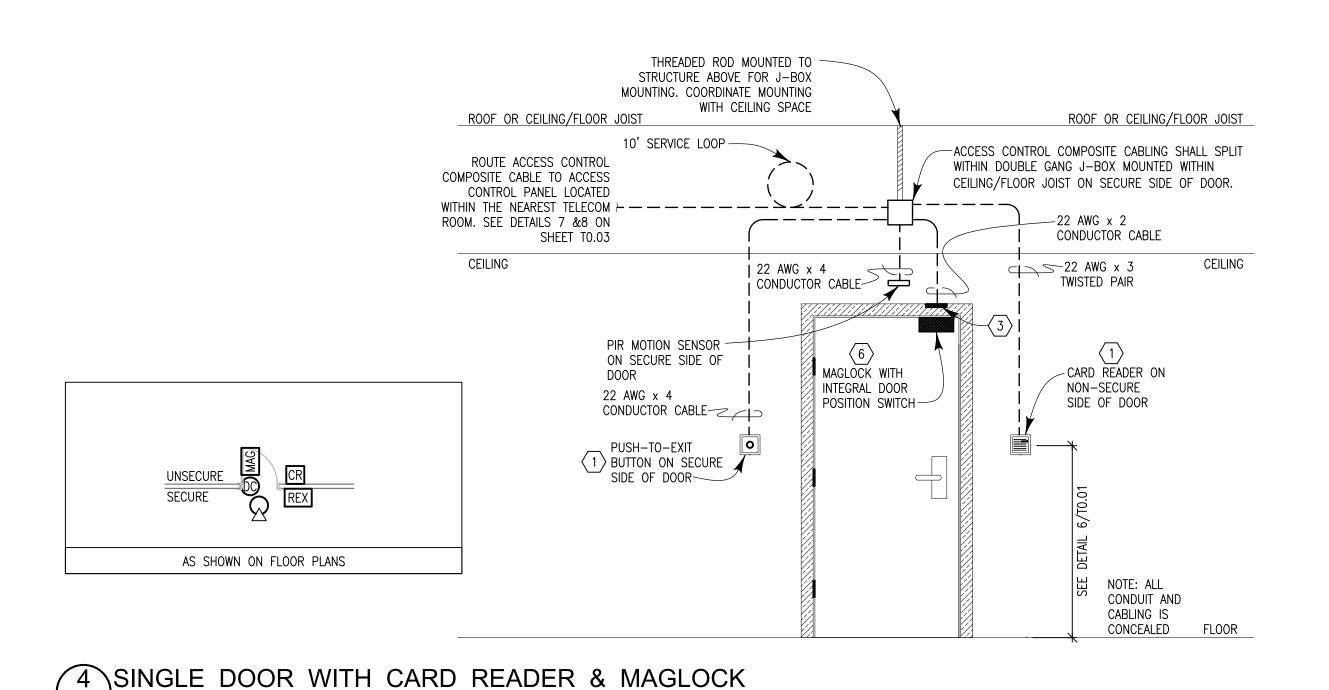

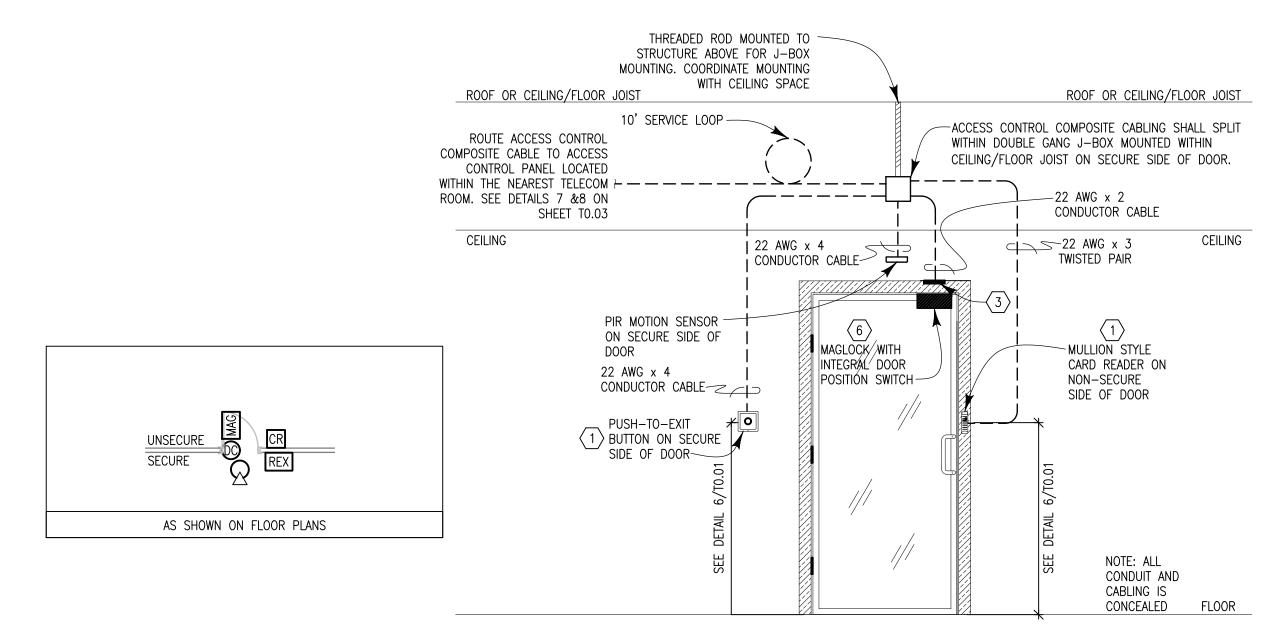

6 SINGLE STOREFRONT DOOR WITH CARD READER & MAGLOCK
T0.04 SCALE: 1/2"=1'-0"

Jordan & Skala Engineers

555 17th Street, Suite 700 Denver, CO 80202
p. 303.586.2375

Project Number: 23080076 Drawn By: TP Checked By: BMT

SECURITY DETAILS -

TELECOM

DRAWING NO.

 \overline{Z}

:4 8:58:33 AM Projects\23080076-Grant Street Apartments\23080076-Grant Street A

T0.04 SCALE: 1/2"=1'-0"


GENERAL NOTES:

- REFER TO ARCHITECTURAL DOOR SCHEDULE FOR DEVICES
 AND REQUIREMENTS FOR EACH DOOR.
- 2. ELECTRICAL CONTRACTOR TO PROVIDE ADDITIONAL CONDUIT WHERE INDICATED ON PLAN DRAWINGS.
- 3. INTERFACE DOOR LOCKING DEVICES WITH AUTO DOOR OPENERS, DOOR HOLD OPEN MAGNETS, AND HANDICAP
- ASSIST DOOR OPENERS ON SECURITY DOORS.

 4. ALL MAGNETIC LOCKS SHALL BE MOUNTED ON THE SECURE SIDE OF THE DOOR, UNLESS OTHERWISE INDICATED.
- 5. EMERGENCY DOOR RELEASE PULL STATIONS AND PUSH-TO-EXIT BUTTONS MUST BE MOUNTED WITHIN 40" OF DOOR.
- 6. FOR STOREFRONT TYPE DOORS, STUB CONDUIT OR FLEX INTO FRAME STRUCTURE AND FISH CABLE TO DEVICE.

KEY NOTES:

- DOUBLE GANG BACKBOX WITH SINGLE GANG PLASTER RING SUPPLIED AND INSTALLED BY ELECTRICAL CONTRACTOR.
- 2 12"x12"x6" NEMA 12 HOFFMAN BOX WITH HINGED COVER SUPPLIED AND INSTALLED BY ELECTRICAL CONTRACTOR. MOUNT ABOVE ACCESSIBLE CEILING ON SECURE SIDE OF DOOR.
- (3) MORTAR GUARD SUPPLIED AND INSTALLED BY LV CONTRACTOR.
- PROVIDE ADAPTER PLATE FOR MOUNTING MOTION SENSOR TO BACKBOX.
- AT SHEETROCK WALLS, STUB CONDUIT INTO WALL TO 4" BELOW CEILING. FISH WIRE TO SURFACE-MOUNTED MOTION
- (6) PIR INSTALLED IN CEILING ON SECURE SIDE OF DOOR.

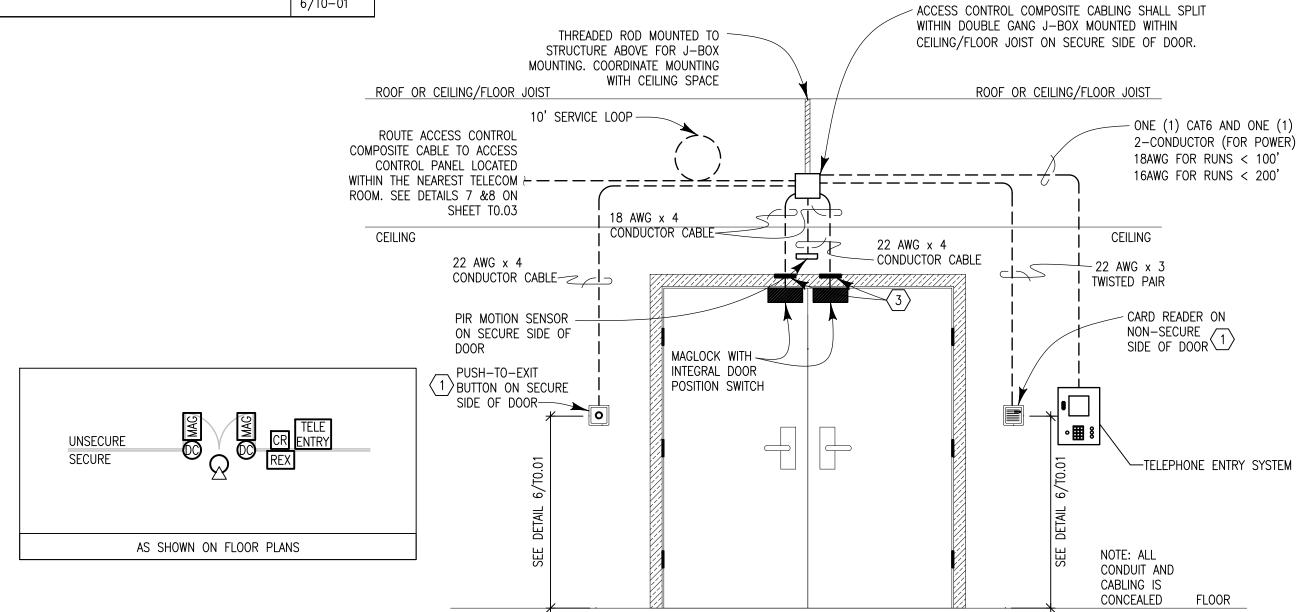

ROOF OR CEILING/FLOOR JOIST

______22 AWG x 3

TWISTED PAIR

CARD READER ON

NON-SECURE

SIDE OF DOOR

CEILING

NOTE: ALL

CONDUIT AND

CONCEALED

CABLING IS

-ACCESS CONTROL COMPOSITE CABLING SHALL SPLIT

WITHIN DOUBLE GANG J-BOX MOUNTED WITHIN

18 AWG x 4

151 CONDUCTOR CABLE

ELECTRIFIED

TRANSFER-

→CRASHBAR WITH


CONCEALED VERTICAL ROD ELECTRIFIED

PANIC

POWER

CEILING/FLOOR JOIST ON SECURE SIDE OF DOOR.

3 DOUBLE DOOR WITH CARD READER & MAGLOCKS
T0.05 SCALE: 1/2"=1'-0"

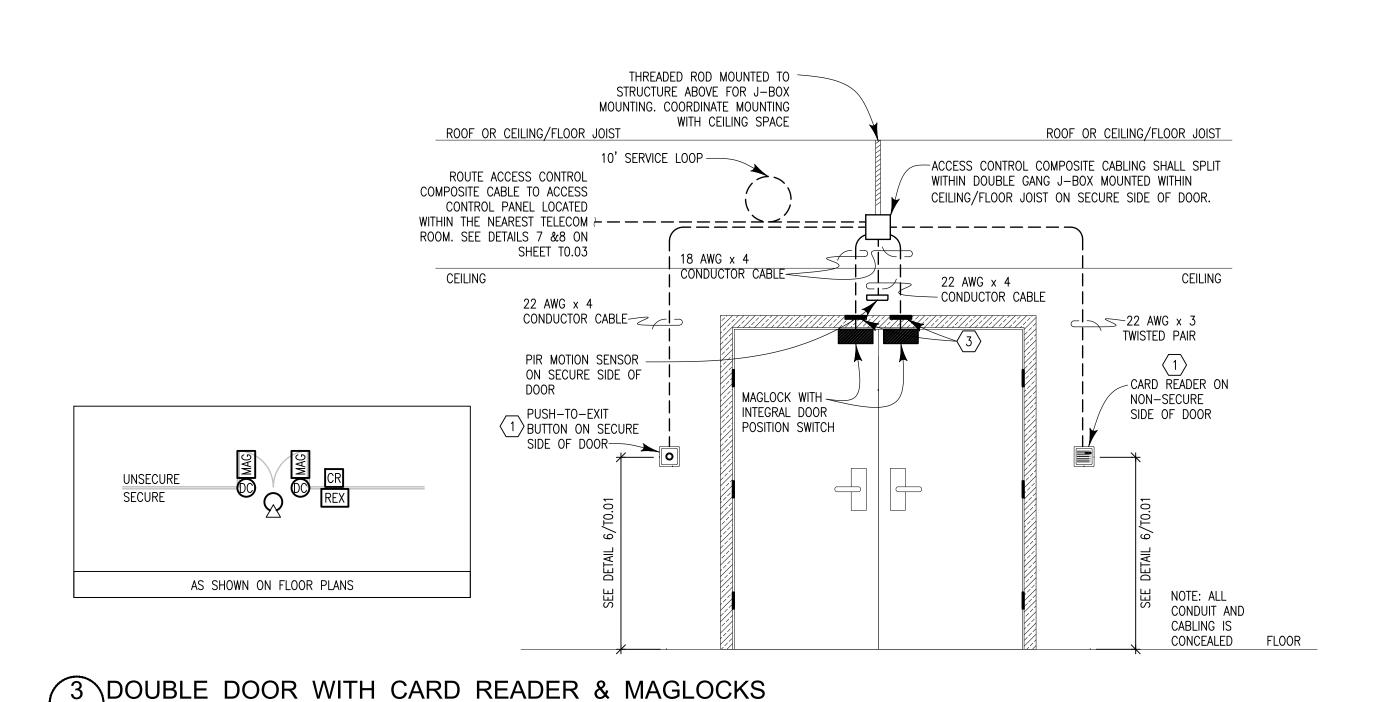

THREADED ROD MOUNTED TO -

WITH CEILING SPACE

. _ _ _ _ _ _ _ _ _ _ _ _ _ _ _

22 AWG x 2 —

CONDUCTOR CABLE

DOOR POSITION

FRAME ABOVE

DOOR, MAXIMUM

3" FROM EDGE

OF DOOR.

-ELECTRIFIED

TRANSFER

POWER

SWITCH. DRILL 1" HOLE IN DOOR

STRUCTURE ABOVE FOR J-BOX

MOUNTING. COORDINATE MOUNTING

10' SERVICE LOOP —

CONDUCTOR CABLE

ROOF OR CEILING/FLOOR JOIST

SHEET TO.03

ROUTE ACCESS CONTROL

CONTROL PANEL LOCATED

WITHIN THE NEAREST TELECOM ←

ROOM. SEE DETAILS 7 &8 ON

1 DOUBLE DOOR WITH CARD READER & ELECTRIC CRASH BARS


CEILING

AS SHOWN ON FLOOR PLANS

T0.05 | SCALE: 1/2"=1'-0"

T0.05 SCALE: 1/2"=1'-0"

COMPOSITE CABLE TO ACCESS

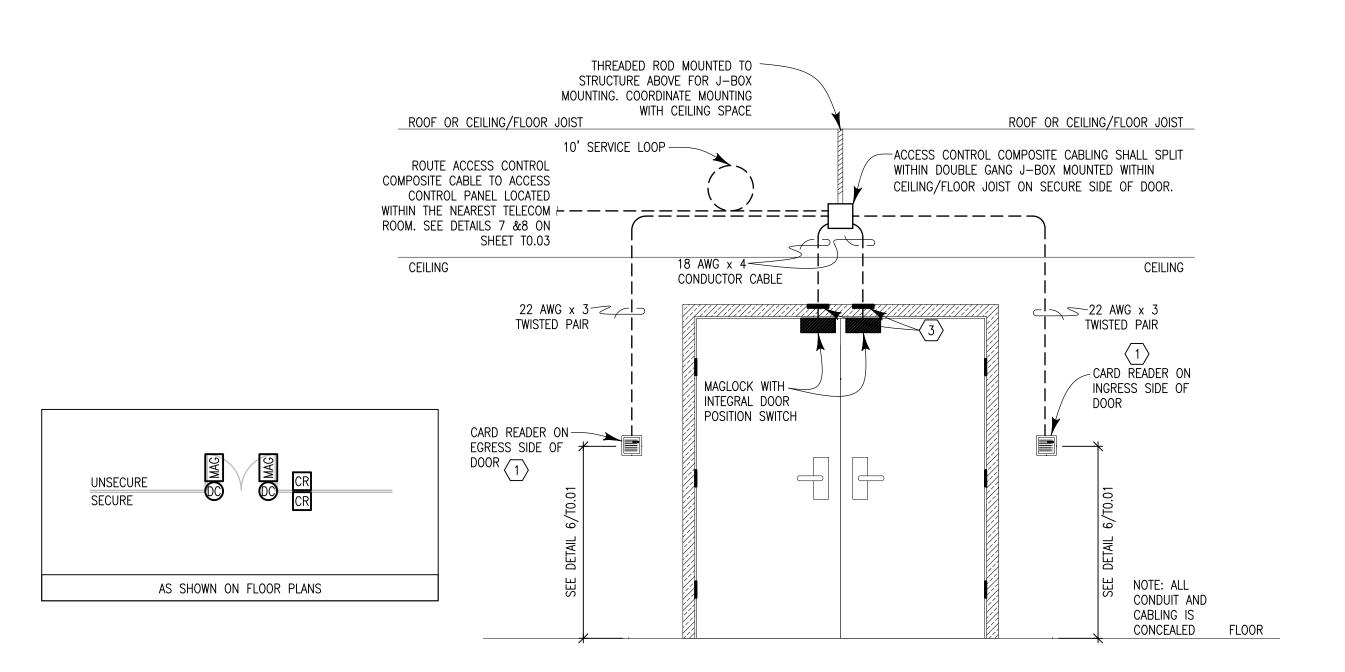

3 DOUBLE DOOR WITH IN/OUT CARD READER & MAGLOCKS
T0.05 SCALE: 1/2"=1'-0"

Jordan & Skala Engineers

555 17th Street, Suite 700 Denver, CO 80202
p. 303.586.2375

CRANT STR

GRANT STR

GRANT STR

SON BOL

SON E. 17th Av

SON E. 17th Av

SON E. 17th Av

A De

CRANT STR

A De

A De

CRANT STR

A De

A De

CONTRICTION

CONTRINA

CONTRICTION

CONTRICTION

CONTRICTION

CONTRICTION

CONTRICTI

Capital Group

PARTNE


M

Grant Street Apartments\23080076-Grant Street Apartments

Drawn By: TP Checked By: BMT


ONE (1) 1" CONDUIT —

TELEPHONE ENTRY SYSTEM ONE-LINE DIAGRAM
T0.06 SCALE: NONE

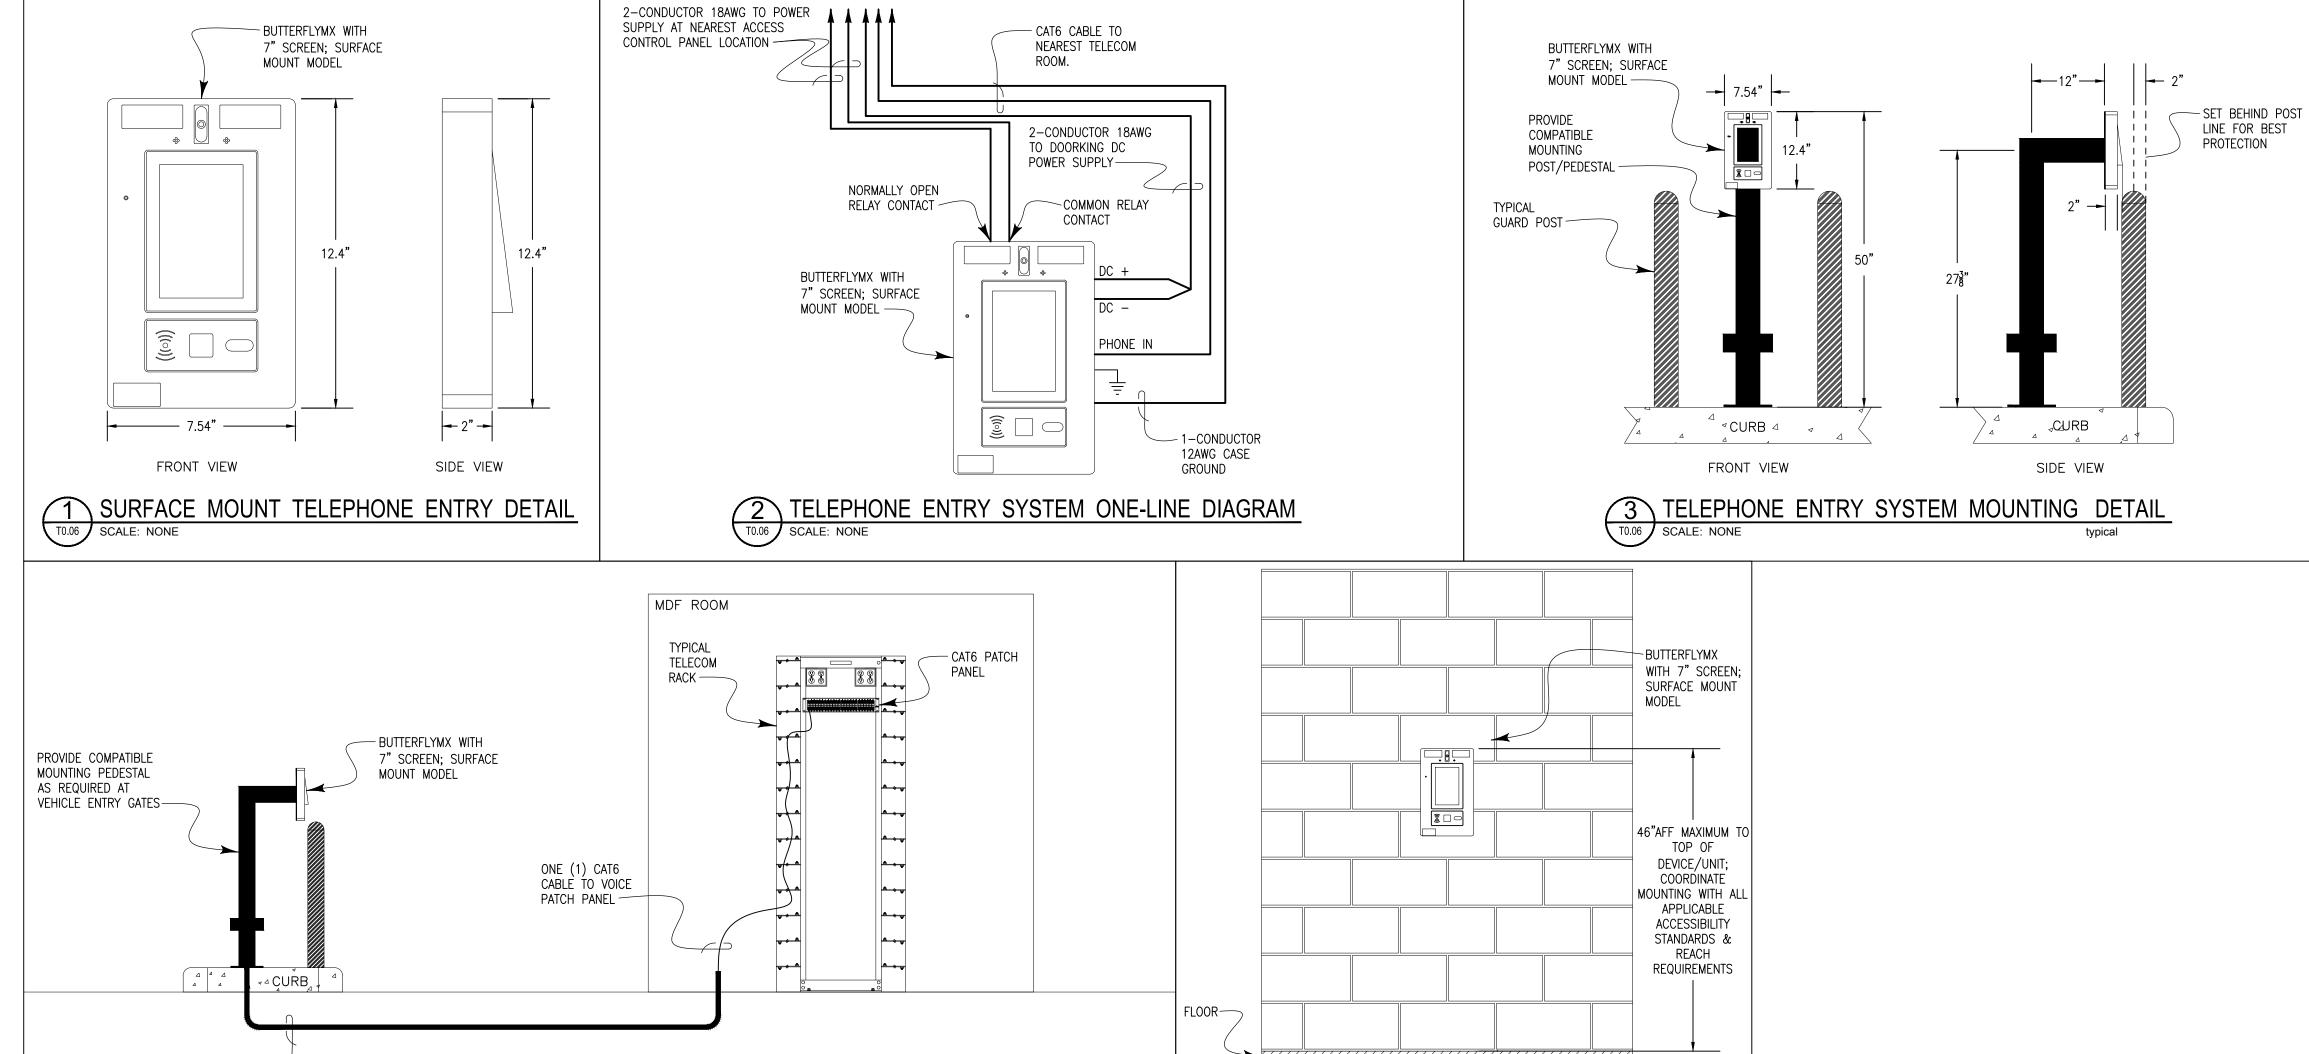

5 TELEPHONE ENTRY WALL-MOUNT DETAIL

TO.06 SCALE: NONE

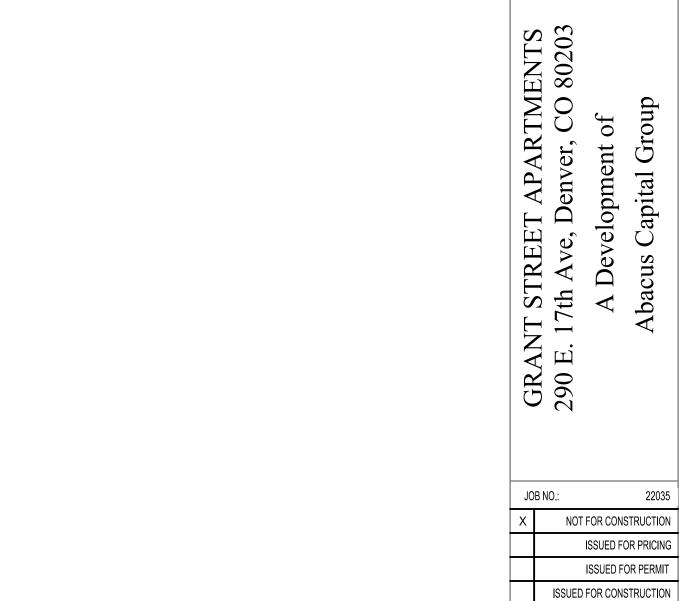

Jordan & Skala Engineers

555 17th Street, Suite 700 Denver, CO 80202
p. 303.586.2375


TELE-ENTRY
DETAILS - TELECOM


DRAWING NO. Drawn By: TP Checked By: BMT

SHEET TITLE: T0.06

PARTNER

MEEKS

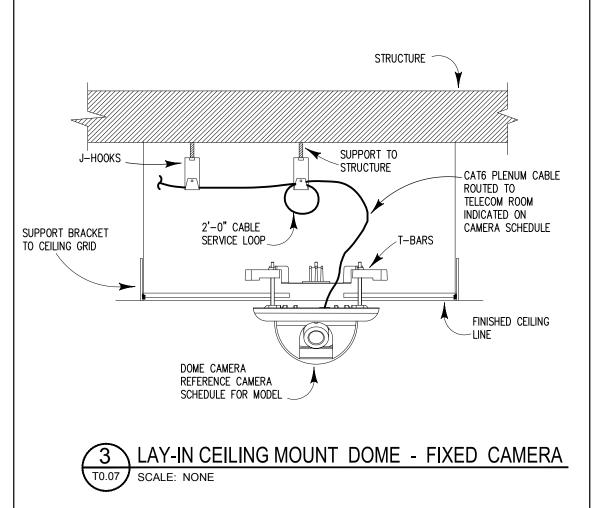

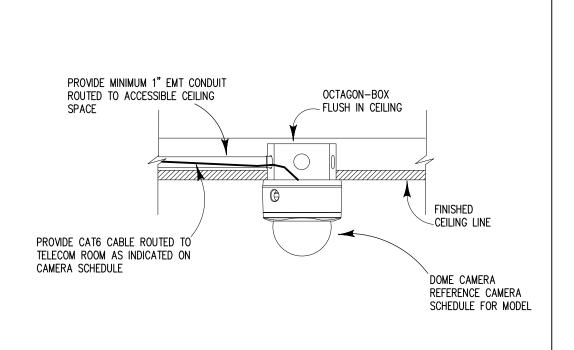

SURFACE - MOUNT DOME - FIXED CAMERA
TO.07 SCALE: NONE

CAMERA GENERAL NOTES:

- 1. ROOMS AND EQUIPMENT DO NOT REFLECT ACTUAL SIZES.
- 2. SEE ENLARGED FLOOR PLANS FOR ACTUAL QUANTITIES AND LOCATIONS OF CAMERAS.
- 3. COORDINATE WITH SECURITY CONTRACTOR & SERVICE PROVIDER FOR EXACT EQUIPMENT REQUIREMENTS.

4 SENSOR 360 CAMERA COT	DIAGRAMMATIC ONLY; SEE FLOOR PLANS FOR EXACT NUMBER & LOCATIONS OF CAMERAS, EACH TO BE HOME RUN TO THE NEAREST TELECOM ROOM CV6 CV6 CV6 CV6 POE SWITCH: 4-PORT
CLIENT COMPUTER FOR IP SURVEILLANCE MONITORING STATION; SYSTEM SHALL ALSO BE CAPABLE OF CLOUD-BASED MONITORING; SHALL BE ON EMERGENCY POWER, BY ELECTRICAL	MANAGER'S OFFICE

IP CAMERA SYSTEM LEGEND		
SYMBOL	DESCRIPTION	HEIGHT
▶ C1	FIXED IP CAMERA; ONE (1) CAT 6 CABLE DROP ONLY FOR FUTURE CAMERA LOCATION; CAMERAS & ASSOCIATED HARDWARE ARE TO BE PROVIDED & INSTALLED BY OWNER.	
∇ C1 △	270° MULTISENSOR IP CAMERA; ONE (1) CAT 6 CABLE DROP ONLY FOR FUTURE CAMERA LOCATION; CAMERAS & ASSOCIATED HARDWARE ARE TO BE PROVIDED & INSTALLED BY OWNER.	
	360° MULTISENSOR IP CAMERA; ONE (1) CAT 6 CABLE DROP ONLY FOR FUTURE CAMERA LOCATION; CAMERAS & ASSOCIATED HARDWARE ARE TO BE PROVIDED & INSTALLED BY OWNER.	
	DUAL SENSOR FIXED IP CAMERA; ONE (1) CAT 6 CABLE DROP ONLY FOR FUTURE CAMERA LOCATION; CAMERAS & ASSOCIATED HARDWARE ARE TO BE PROVIDED & INSTALLED BY OWNER.	

KEY NOTES: IP SURVEILLANCE

- 1 NVR SHALL PROVIDE 30-DAYS OF STORAGE, MINIMUM, PER DIVISION 28 SPECIFICATIONS.
- 2 IP SURVEILLANCE SYSTEM BACKBONE SHALL BE DEDICATED FOR THE CAMERA SYSTEM & BE SEPARATE FROM ANY SERVICE PROVIDER/TELECOM NETWORK BACKBONE.

5 IP SURVEILLANCE SYSTEM ONE-LINE DIAGRAM
TO.07 SCALE: NONE




ISSUED FOR CONSTRUCTION SHEET TITLE: Jordan & Skala Engineers

555 17th Street, Suite 700 Denver, CO 80202
p. 303.586.2375 **CAMERA DETAILS -TELECOM** DRAWING NO. Checked By: BMT Project Number: 23080076 Drawn By: TP


PARTNERS

MEEKS

NOT FOR CONSTRUCTION ISSUED FOR PRICING ISSUED FOR PERMIT

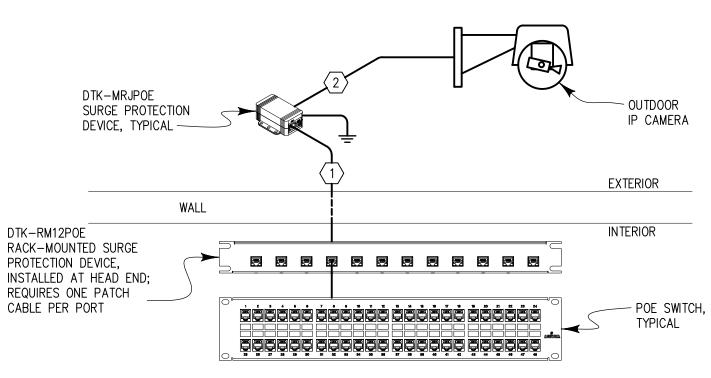


2 TYPICAL IP CAMERA SURGE PROTECTION ONE-LINE DIAGRAM

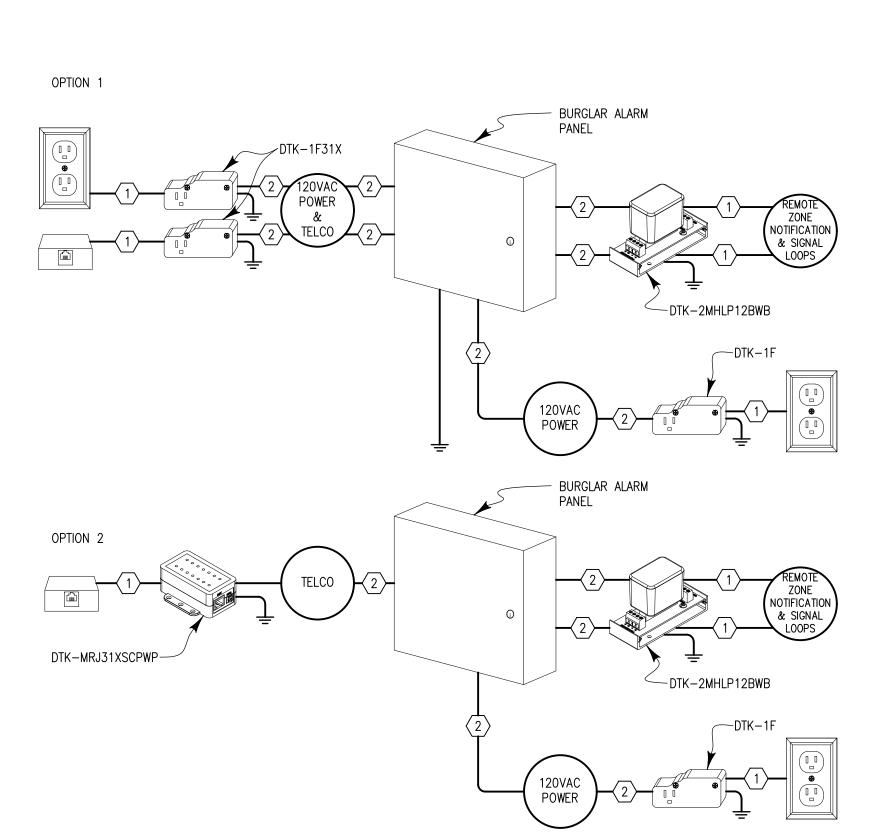

INTRUSION CONTROL SURGE PROTECTION ONE-LINE DIAGRAM

TO.08 SCALE: NONE

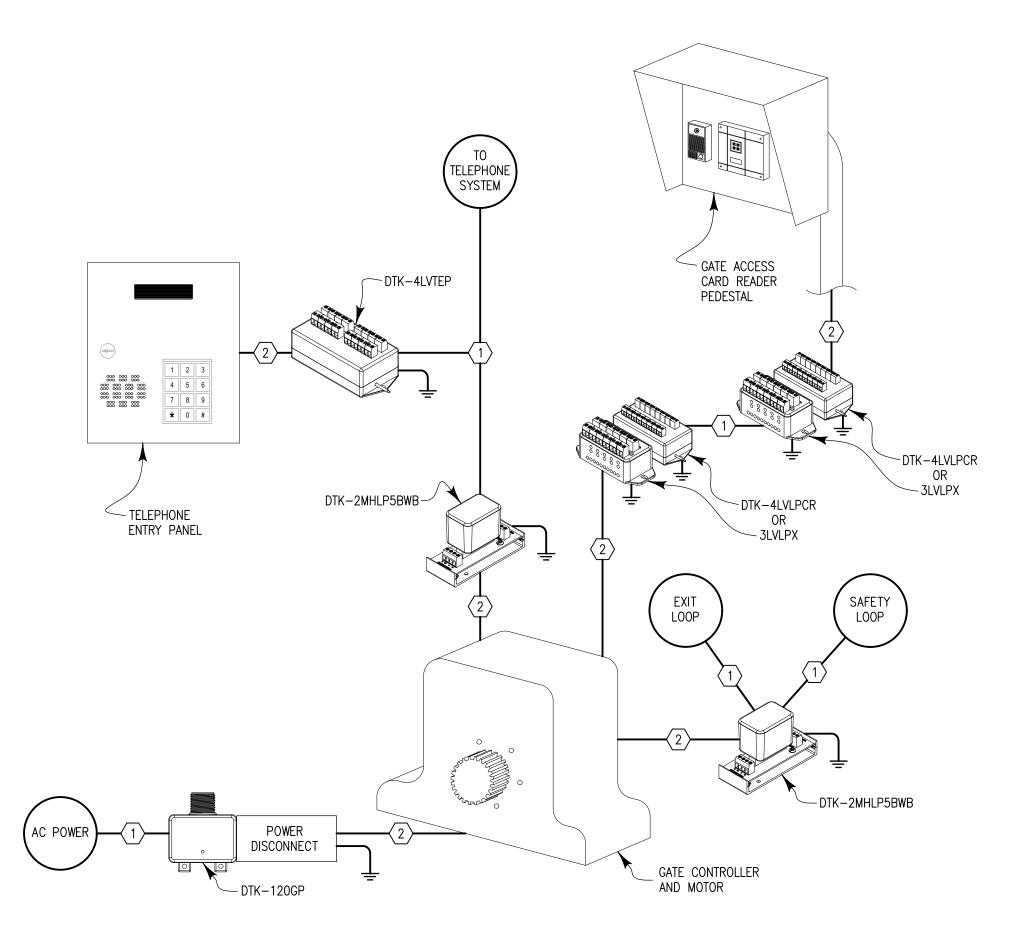

GATE ACCESS SURGE PROTECTION ONE-LINE DIAGRAM
TO.08 SCALE: NONE

NETWORK SURGE PROTECTION NOTES:

- TO KEEP SURGES FROM ENTERING THE BUILDING AND NETWORK, IT IS RECOMMENDED TO PROVIDE A LAYER OF SURGE PROTECTION. THIS HEAD END PROTECTION POINT IS THE ONLY WAY TO REDUCE THE RISKS ASSOCIATED WITH METALLIC CONDUCTORS CONNECTING EXTERNAL DEVICES TO INTERNAL NETWORK
- IT IS RECOMMENDED TO PROTECT EACH EXTERNALLY—MOUNTED DEVICE FROM SURGES THAT ARE INTRODUCED ON THE METALLIC CONDUCTORS.
- FAILURE TO INSTALL SURGE PROTECTION DEVICES PLACES ALL INTERNAL NETWORK CONNECTED EQUIPMENT AT RISK.
- 4. MUST BE GROUNDED AND INSTALLED PER MANUFACTURERS INSTALLATION

KEY NOTES:

- 1) HIGH SURGE RISK CONNECTION, TYPICAL
- PROTECTED COPPER CONNECTION, TYPICAL

PARTNER MEEKS

NOT FOR CONSTRUCTION


ISSUED FOR PRICING ISSUED FOR PERMIT ISSUED FOR CONSTRUCTION

SHEET TITLE:

SURGE PROTECTION DETAILS - TELECOM DRAWING NO. T0.08

Jordan & Skala Engineers

555 17th Street, Suite 700 Denver, CO 80202
p. 303.586.2375

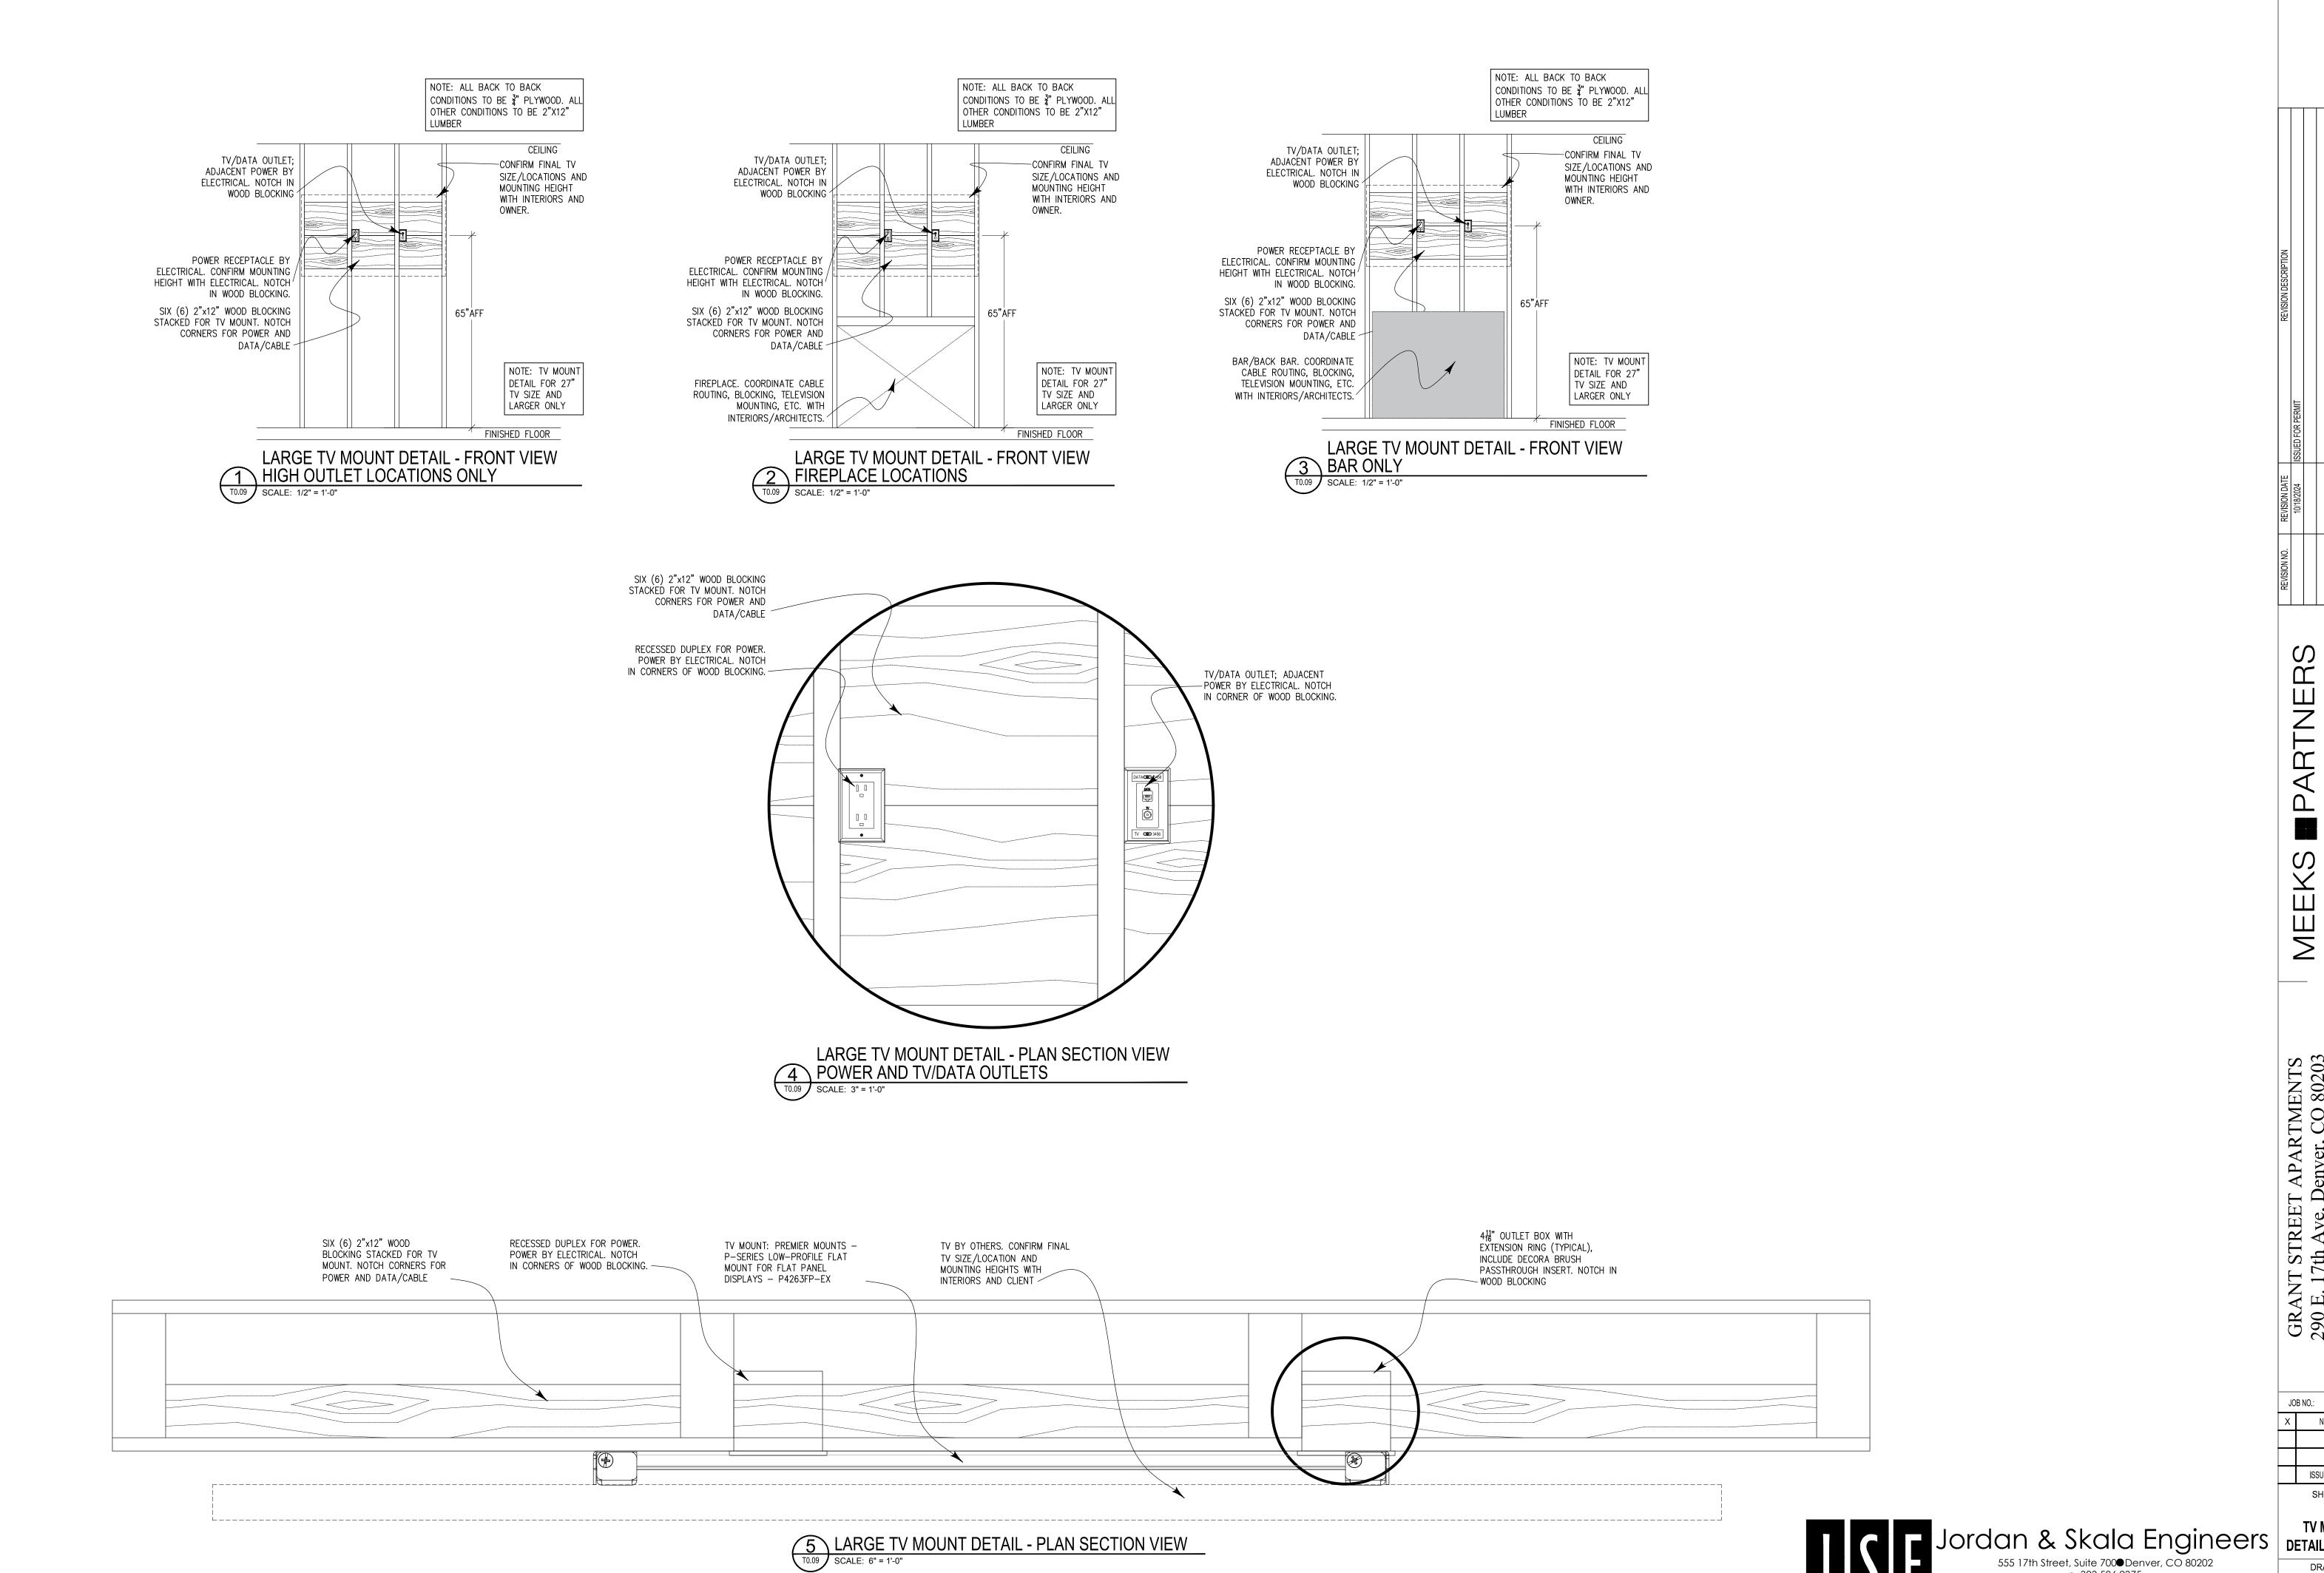

Jordan & Skala Engineers

555 17th Street, Suite 700 Denver, CO 80202
p. 303.586.2375

TV MOUNTING
DETAILS - TELECOM
DRAWING NO.

Drawn By: TP

Checked By: BMT

TV MOUNTING

NOT FOR CONSTRUCTION ISSUED FOR PRICING

ISSUED FOR CONSTRUCTION


SHEET TITLE:

ISSUED FOR PERMIT

- G1. REFERENCE THE LOCAL JURISDICTION'S ADOPTED VERSIONS OF SECTION 510 OF THE INTERNATIONAL FIRE CODE, NFPA 72, & NFPA 1221 REGARDING REQUIREMENTS FOR EMERGENCY RESPONDER RADIO COVERAGE/PUBLIC SAFETY DISTRIBUTED ANTENNA SYSTEMS.
- G2. ERRC SYSTEM SHALL BE PROVIDED WITH A MINIMUM OF 24 HOURS OF BATTERY BACKUP; WHERE AN EMERGENCY GENERATOR IS USED, PROVIDE A MINIMUM OF 2 HOURS.
- G3. ALL BACKBONE CABLING USED FOR THE ERRC SYSTEM SHALL MAINTAIN 2—HOUR SURVIVABILITY, TYPICALLY VIA WRAPPING, & BE PLENUM RATED AS REQUIRED BY THE AUTHORITY HAVING JURISDICTION (AHJ). COORDINATE EXACT LABELING REQUIREMENTS WITH THE AHJ.
- G4. ERRC SYSTEM SHALL BE UL2524 LISTED & BE INSTALLED BY A GROL CERTIFIED INSTALLER.
- G5. PROVIDE ONE (1) 1½" CONDUIT, MINIMUM, BETWEEN EACH DAISY-CHAINED ANTENNA JUNCTION BOX LOCATION THEN HOME RUN ONE (1) 1½" CONDUIT FROM THE FINAL ANTENNA LOCATION IN THE CHAIN TO THE NEAREST TELECOM ROOM FOR FUTURE INSTALLATIONS; WHERE ERRC SYSTEMS ARE BEING INSTALLED PRIOR TO CEILINGS GOING UP, OPEN CABLING MAY BE USED, AS DEEMED APPROPRIATE BY THE AHJ & ERRC SYSTEM INTEGRATOR. PROVIDE TWO (2) DEDICATED 2" CONDUITS/SLEEVES BETWEEN ANY TELECOM ROOMS SERVING ERRC SYSTEM CABLING BETWEEN FLOORS; SEE THE CONDUIT RISER DIAGRAM ON SHEET TO-20 & FLOOR PLANS FOR CONDUIT ROUTING & LOCATIONS.

KEY NOTES: ERRC

- COAXIAL SPLITTER; CONFIRM EXACT SPLITTER SIZES REQUIRED WITH THE ERRC OR DAS SYSTEM INTEGRATOR OR INSTALLER.
- (2) ERRC REPEATER ANTENNA; PROVIDE 18"x18"x6" JUNCTION BOX AT EACH LOCATION, TYPICAL. JUNCTION BOX SHALL HOUSE ANY REQUIRED SPLITTER(S), PER KEY NOTE 1.
- BI-DIRECTIONAL AMPLIFIER (BDA) WITHIN RED, NEMA-4, ALUMINUM ENCLOSURE, OF TYPICAL DIMENSIONS 20.55"W x 24"H x 8.32"D; UNIT DIMENSIONS MAY INCREASE TO 23.23"W x 26.22"H UPON ADDITION OF HEATSINKS & MOUTING TABS, RESPECTIVELY. BDA SHALL INCLUDE OSCILLATION PREVENTION MECHANISMS. FREQUENCIES SERVED (VHF, UHF, 700MHz, 800MHz, OR MULTIBAND) SHALL BE CONFIRMED WITH THE AHJ. ALSO SEE NOTES G1 & G5.
- BATTERY BACKUP WITHIN RED, NEMA-3R, STEEL, VENTED ENCLOSURE, OF TYPICAL DIMENSIONS 23"W x 13"H x 8.3"D. ALSO SEE NOTE G2.
- DEDICATED & MONITORED ANNUNCIATOR PANEL IS REQUIRED AS SPECIFIED IN NFPA 72 & NFPA 1221. PANEL SHALL BE INDEPENDENT OF THE FIRE ALARM SYSTEM & POWERED BY THE BDA POWER SUPPLY & ASSOCIATED BATTERY BACKUP. PANEL SHALL BE MOUNTED ON A STANDARD 2-GANG ELECTRICAL BOX, SUPPLIED & INSTALLED BY THE ELECTRICAL CONTRACTOR. COORDINATE WITH AHJ FOR PREFERRED MOUNTING LOCATION.
- PROVIDE CONNECTION TO FIRE ALARM CONTROL PANEL (FACP)
 FOR REQUIRED MONITORING BY THE BUILDING'S FIRE ALARM
 SYSTEM. SUPERVISORY SIGNALS TYPICALLY INCLUDE DONOR
 ANTENNA MALFUNCTION, BDA FAILURE, LOW BATTERY CAPACITY,
 LOSS OF NORMAL AC POWER, & FAILURE OF BATTERY
 CHARGER.

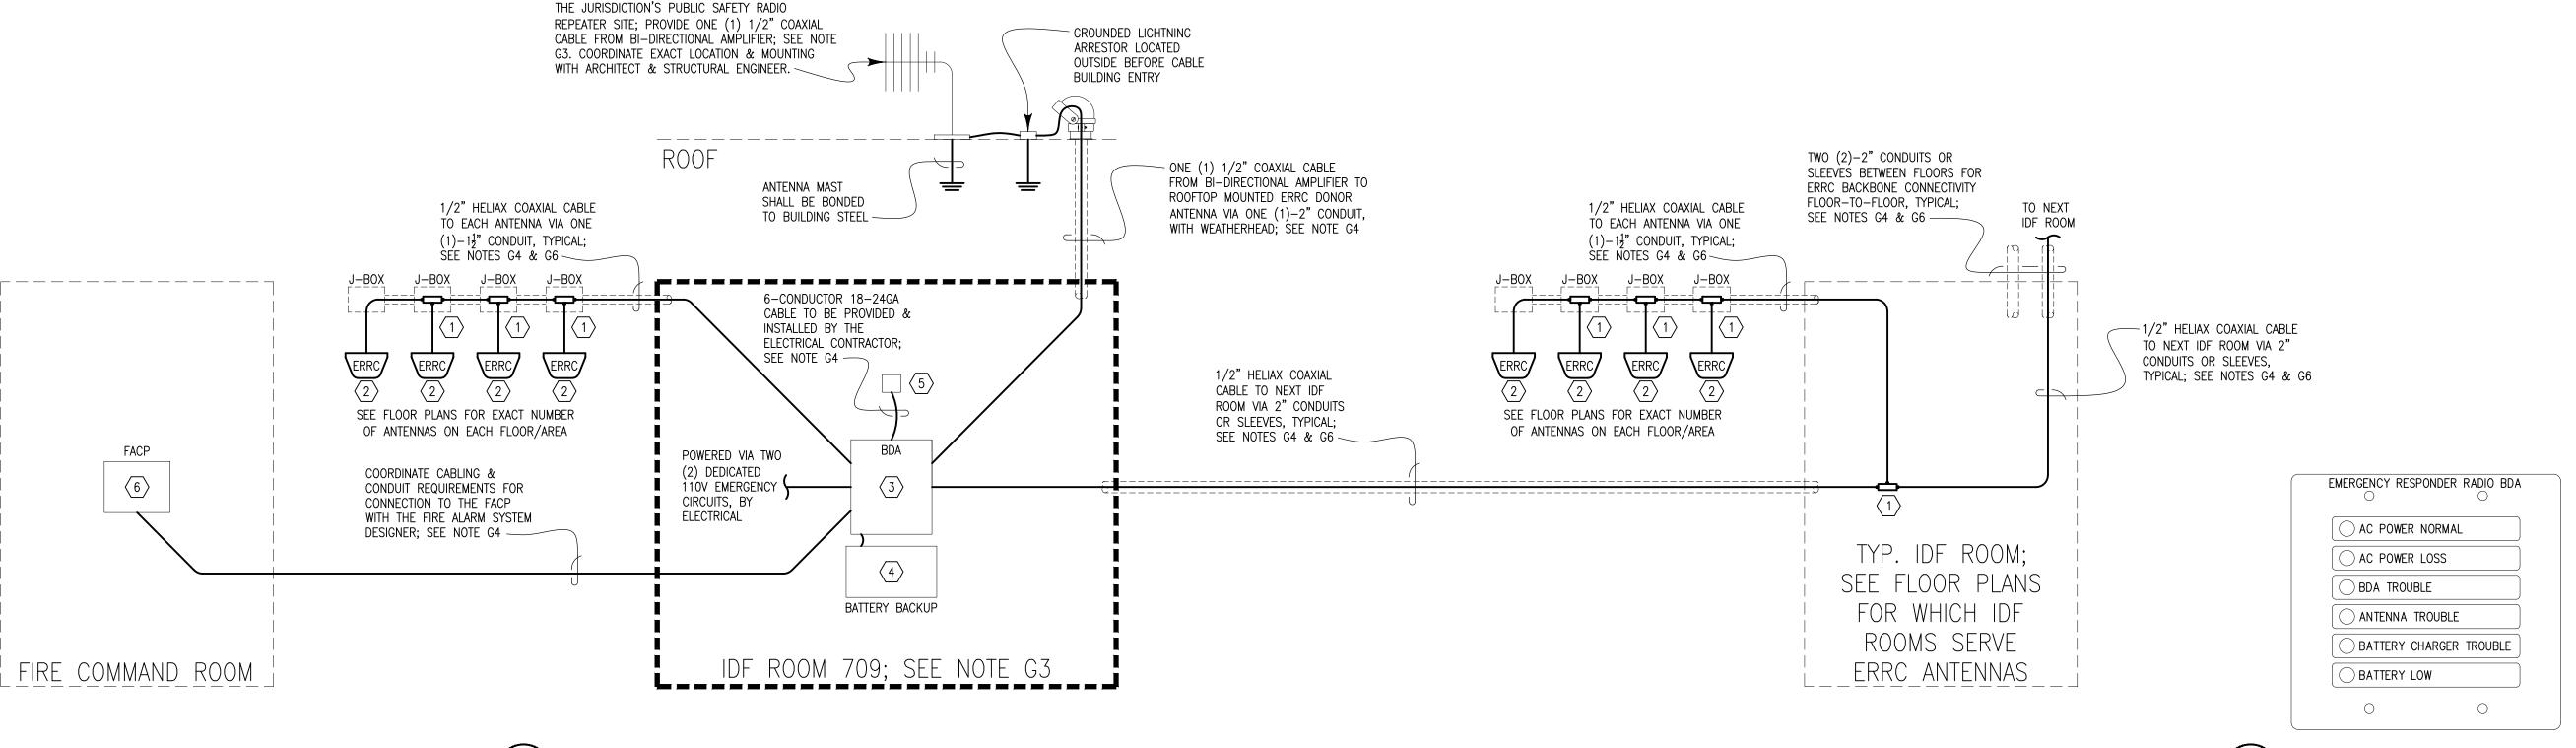

1 EMERGENCY RESPONDER RADIO COVERAGE SYSTEM (ERRC) ONE-LINE DIAGRAM
T0.10 SCALE: NONE

ERRC SYSTEM DONOR ANTENNA, AIMED TOWARDS

2 BDA ANNUNCIATOR PANEL
T0-10 SCALE: NONE

REVISION NO. REVISION DATE REVISION DESCRIPTION 10/18/2024 ISSUED FOR PERMIT

EKS PARTNERS

16000 Memorial Drive
Suite 100
Houston, Texas 77079
281.558.8787

TS MEEKS

7th Ave, Denver, CO 80
A Development of

GRANT STREET 290 E. 17th Ave, D A Develoj

IO.: 22035

NOT FOR CONSTRUCTION

ISSUED FOR PRICING

ISSUED FOR PRICING
ISSUED FOR PERMIT
ISSUED FOR CONSTRUCTION


SHEET TITLE:


DETAILS - TELECOM

DRAWING NO.

Checked By: BMT

Drawn By: TP

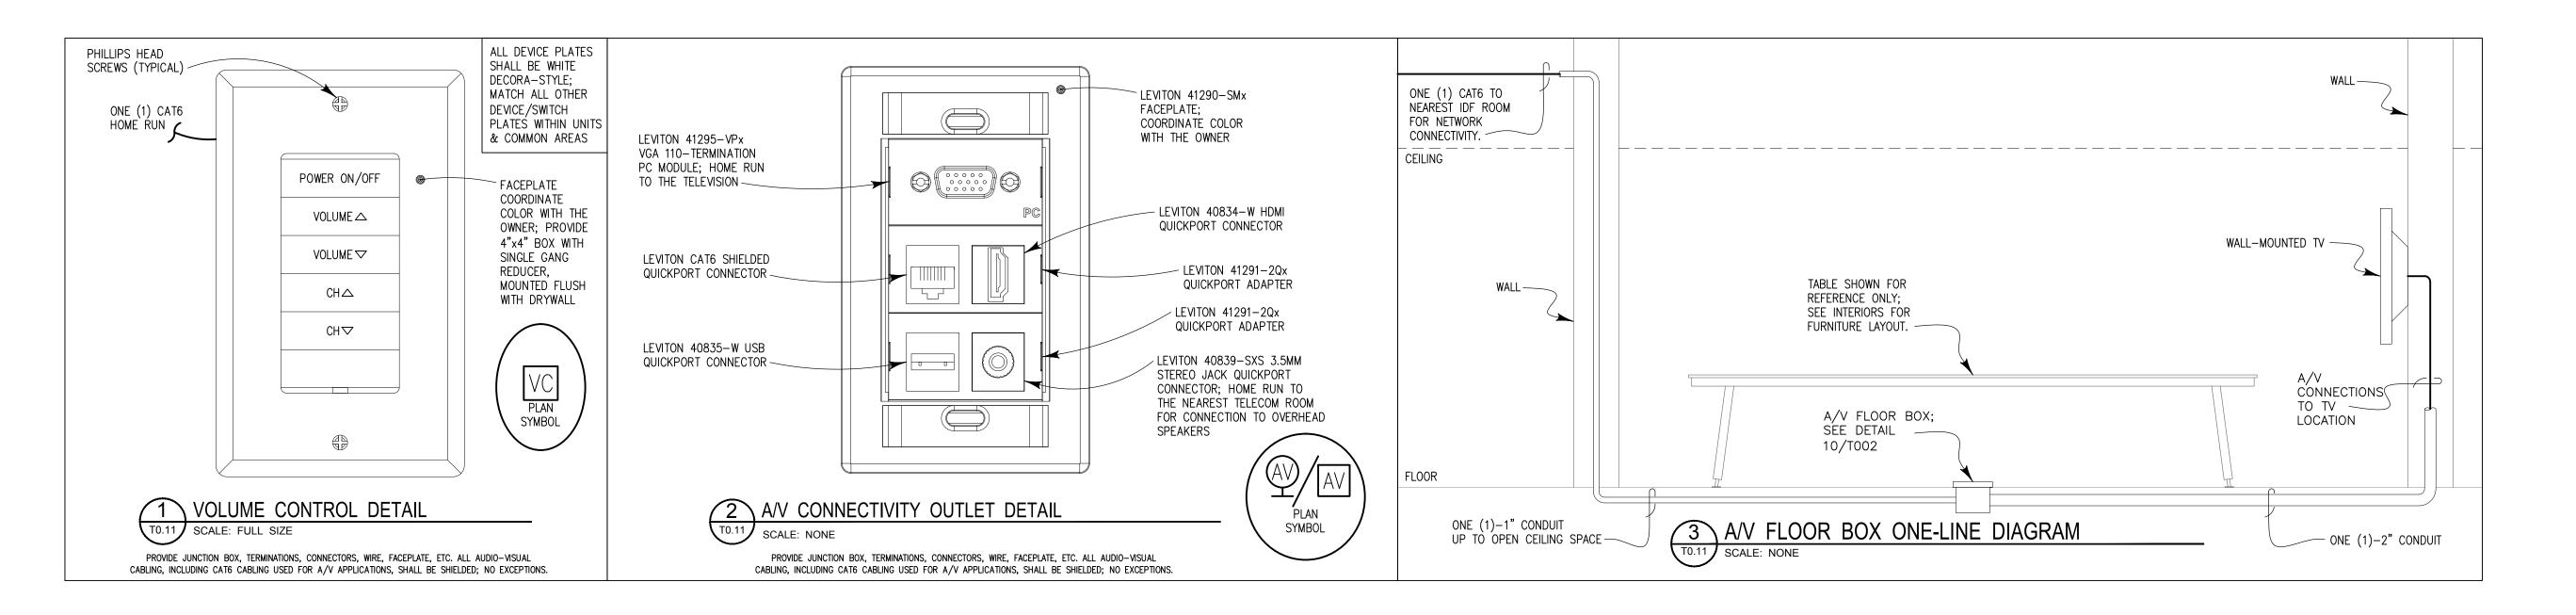

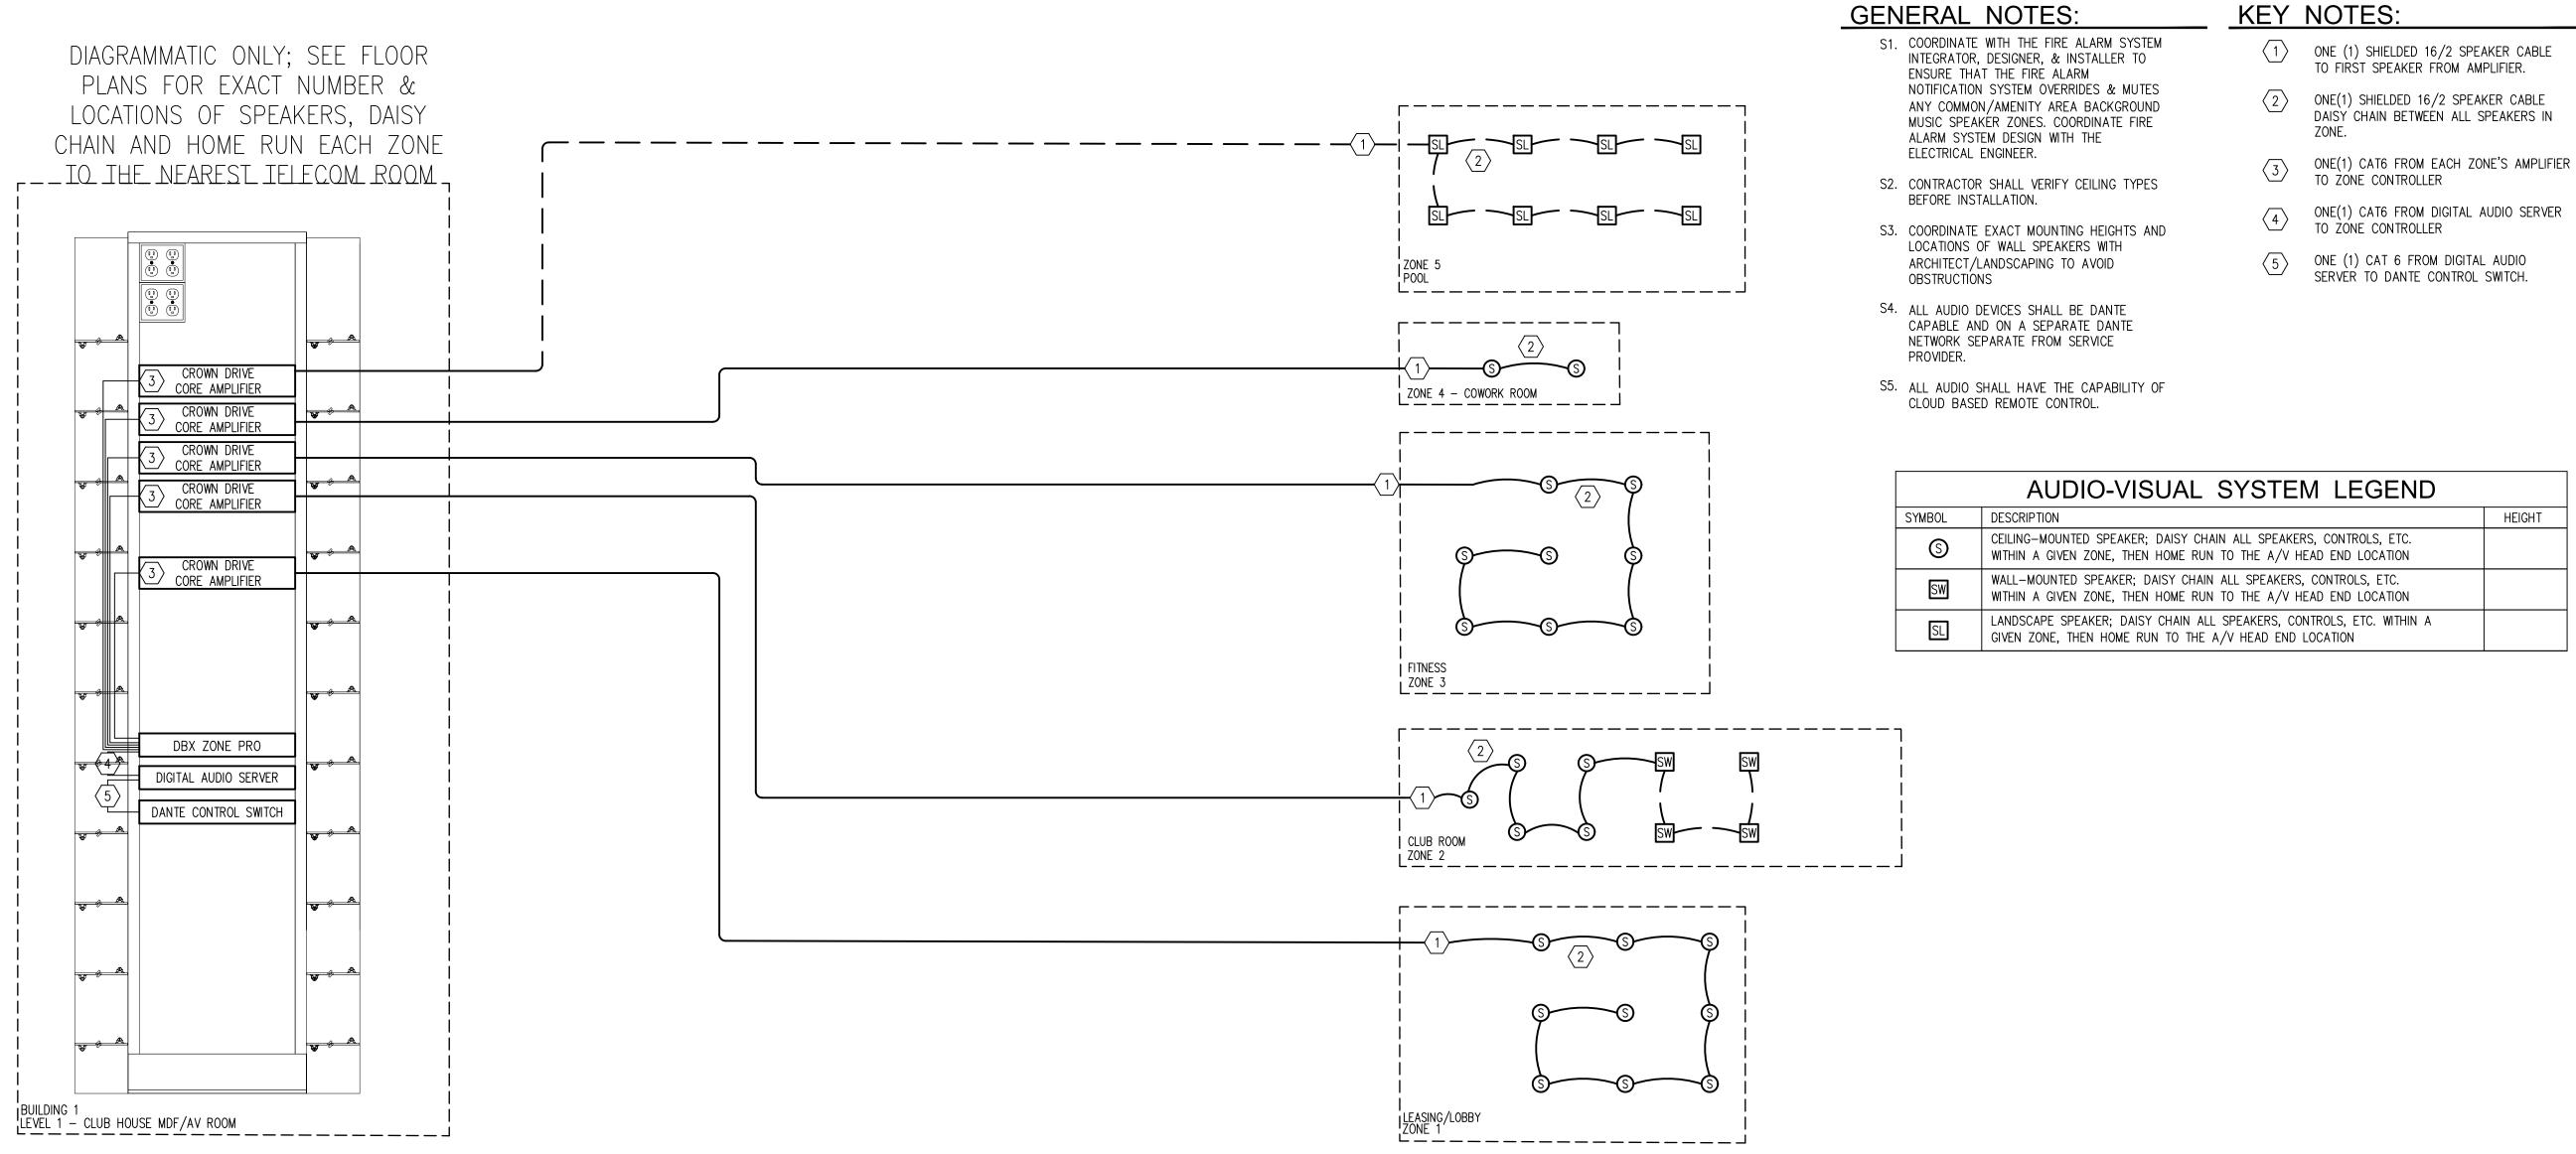

4 AUDIO SYSTEM ONE LINE DIAGRAM

T0.11 SCALE: NONE

JOB NO.: NOT FOR CONSTRUCTION ISSUED FOR PRICING ISSUED FOR PERMIT ISSUED FOR CONSTRUCTION

SHEET TITLE:

PARTNE

MEE


AV SYSTEM DETAILS Jordan & Skala Engineers 555 17th Street, Suite 700● Denver, CO 80202

p. 303.586.2375

Checked By: BMT Drawn By: TP

Project Number: 23080076

- TELECOM DRAWING NO.

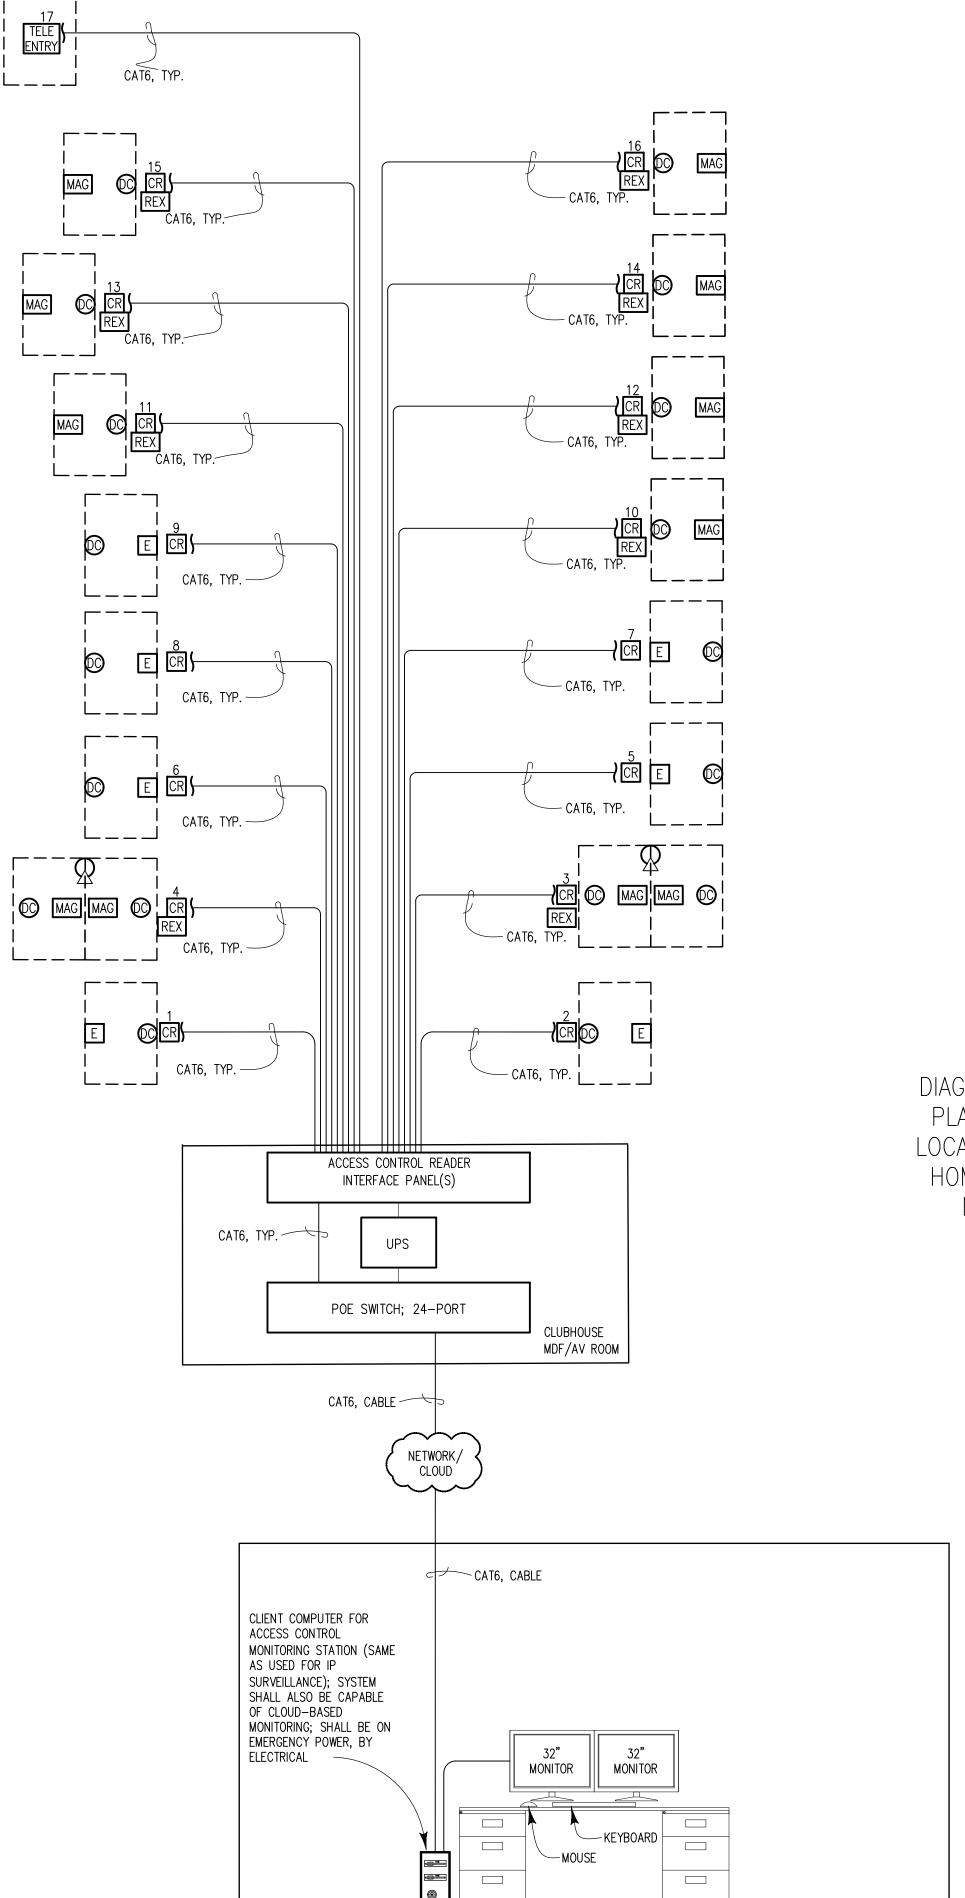

GENERAL NOTES:

- REFER TO ARCHITECTURAL DOOR SCHEDULE FOR DEVICES AND REQUIREMENTS FOR EACH DOOR.
- 2. ELECTRICAL CONTRACTOR TO PROVIDE ADDITIONAL CONDUIT WHERE INDICATED ON PLAN DRAWINGS.
- 3. DETAILS ARE SHOWN FOR GENERAL LAYOUT. FIELD VERIFY EXACT CONDITIONS WITH ARCHITECT. COORDINATE WITH DOOR HARDWARE CONSULTANT FOR EQUIPMENT REQUIREMENTS.
- 4. ROOMS AND EQUIPMENT DO NOT REFLECT ACTUAL SIZES.
- 5. SEE ENLARGED FLOOR PLANS FOR ACTUAL QUANTITIES AND LOCATIONS OF ACCESS CONTROL DEVICES.

POE ACCESS CONTROL SYSTEM LEGEND			
SYMBOL	DESCRIPTION	HEIGHT	
CR #	RFID PROXIMITY CARD READER	48"AFF TO OPERATOR	
©	DOOR CONTACT		
E	ELECTRIC STRIKE OR DOOR LOCK; COORDINATE EXACT REQUIREMENTS AT EACH DOOR WITH THE DOOR HARDWARE CONSULTANT	48"AFF TO OPERATOR	
\boxtimes	PASSIVE INFRARED SENSOR (PIR)		
REX	REQUEST-TO-EXIT	48"AFF TO OPERATOR	
MAG	MAGNETIC DOOR LOCK; COORDINATE EXACT EQUIPMENT WITH DOOR HARDWARE CONSULTANT		
TELE ENTRY	TELEPHONE—ENTRY STATION, BUTTERFLYMX (OR EQUAL); PROVIDE COMPATIBLE PEDESTAL WHERE REQUIRED	48"AFF TO OPERATOR	
FOB	RFID FOB RECEIVER FOR VEHICLE ENTRY		

DIAGRAMMATIC ONLY; SEE FLOOR PLANS FOR EXACT NUMBER & LOCATIONS OF ACCESS CONTROL, HOME RUN EACH ONE TO THE NEAREST TELECOM ROOM

MANAGER'S OFFICE

1 ACCESS CONTROL SYSTEM ONE-LINE DIAGRAM

Project Number: 23080076

ACCESS CONTROL

Checked By: BMT

Drawn By: TP

A Development of Abacus Capital Group

NOT FOR CONSTRUCTION ISSUED FOR PRICING

ISSUED FOR PERMIT

ISSUED FOR CONSTRUCTION

SHEET TITLE:

PARTNER

MEEKS

Jordan & Skala Engineers

555 17th Street, Suite 700 Denver, CO 80202
p. 303.586.2375

ACCESS CONTROL
ONE LINE - TELECOM
DRAWING NO.




KEY NOTES: CONDUIT RISER

- FOUR (4)—3" CONDUITS. COORDINATE LOCATIONS WITH THE STRUCTURAL & ARCHITECTURAL DRAWINGS; RELOCATE IF NECESSARY. PROVIDE SHOP DRAWINGS REFLECTING THE FINAL LAYOUT OF ALL CONDUITS FOR APPROVAL. SEE OVERALL FLOOR PLANS ON SHEET T3.00 FOR EXACT NUMBER & ROUTING OF CONDUITS BETWEEN LEVEL 1 MDF ROOM AND IDF ROOM STACKS STARTING ON LEVEL 3, AS WELL AS THE AV ROOM ON LEVEL 2.
- (2) PROVIDE FOUR (4)-3" CONDUIT SLEEVES BETWEEN FLOORS FOR STACKED IDF ROOMS.
- (3) CEILING.
- ONE (1)-2" CONDUIT TO ROOF FOR FUTURE SATELLITE SERVICE. PROVIDE ONE (1)-2" WEATHER HEAD. SATELLITE, IF APPLICABLE, BY SERVICE PROVIDER.
- FOUR (4)-4" CONDUITS, ROUTED UNDERGROUND, TO PROPERTY LINE.

 COORDINATE EXACT LOCATION WITH SERVICE PROVIDER(S) & CIVIL ENGINEER.

 SEE OVERALL FLOOR PLAN ON SHEET T3.00 FOR EXACT ROUTING.
- PULL BOX , SIZED PER N.E.C MOUNTED TO GARAGE CEILING. COORDINATE EXACT MOUNTING LOCATION WITH GARAGE CEILING STRUCTURE TO AVOID OBSTRUCTION.
- $\overline{7}$ ONE (1)-2" CONDUIT TO ROOF FOR ERRC BACKBONE CABLING.
- STUB ONE (1)—1" CONDUIT INTO EACH TOWNHOME STYLE UNITS CEILING SPACE FOR SMC PANEL HOME RUN TO LEVEL 3 IDF ROOM A. CONDUITS SHALL BE ROUTED OVERHEAD FROM EACH UNIT INTO LEVEL 2 GARAGE CEILING SPACE THEN STUBBING UP INTO LEVEL 3 IDF ROOM A; SEE OVERALL FLOOR PLAN ON SHEET T3.00 FOR EXACT NUMBER AND ROUTING OF CONDUITS.
- STUB ONE (1)—3" CONDUIT INTO CORRIDOR CEILING SPACE FOR UNIT SMC PANEL HOME RUN TO LEVEL 3 IDF ROOM A. CONDUIT SHALL ROUTE OVERHEAD FROM CORRIDOR CEILING INTO LEVEL 2 GARAGE CEILING SPACE THEN STUBBING UP INTO LEVEL 3 IDF ROOM A; SEE SHEET T3.00 FOR EXACT CONDUIT ROUTING.

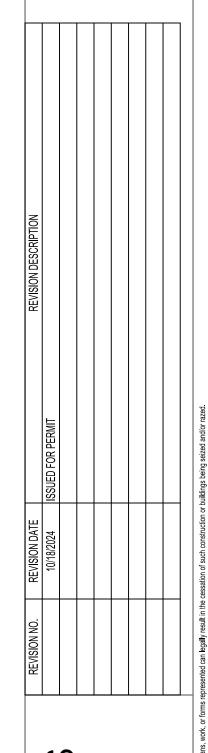

EKS PARTNER
16000 Memorial Drive
Suite 100
Houston, Texas 77079

O 80203

A Development of bacus Capital Group

OB NO.: 22035

NOT FOR CONSTRUCTION

ISSUED FOR PRICING

ISSUED FOR PERMIT

ISSUED FOR CONSTRUCTION

SHEET TITLE:

CONDUIT RISER -TELECOM

TELECOM DRAWING NO.

Jordan & Skala Engineers

555 17th Street, Suite 700 Denver, CO 80202
p. 303.586.2375

KEY NOTES: GROUNDING RISER

#6 AWG, MINIMUM, GROUNDING CONDUCTOR TO EQUIPMENT.

 $\langle \overline{2} \rangle$ GROUNDING CONDUCTORS (TBB).

GROUNDING CONDUCTOR TO MAIN ELECTRICAL ROOM, BY ELECTRICAL.

(4) CONNECTIONS TO TELECOM EQUIPMENT.

(5) CONNECTION TO BUILDING STEEL, IF APPLICABLE.

(6) ALTERNATING CURRENT (AC) EQUIPMENT GROUND.

(7) CEILING.

GENERAL NOTES: GROUNDING RISER

G1. THE TELECOMMUNICATIONS BONDING BACKBONE (TBB) SHALL BE A COPPER CONDUCTOR. THE MINIMUM TBB CONDUCTOR SIZE SHALL BE A #6 AWG. THE TBB SHOULD BE SIZED BY THE ELECTRICAL ENGINEER. THE TBB MAY BE INSULATED; IF SO, THE INSULATION SHALL MEET THE FIRE RATINGS OF ITS PATHWAY. THE SIZING OF THE TBB IS NOT INTENDED TO ACCOUNT FOR THE REDUCTION OR CONTROL OF ELECTROMAGNETIC INTERFERENCE.

G2. INSTALL GROUNDING BUSBAR A MINIMUM OF 18"AFF WITH 6" CLEAR ON ALL SIDES.

G3. ALL GROUNDING BUSBARS IN ALL TELECOM ROOMS SHALL BE CONNECTED TO THE BUILDING STEEL.

G4. VERIFY FINAL GROUNDING SYSTEM DESIGN WITH ELECTRICAL ENGINEER.

TBB SIZING			
LINEAR LENGTH (FT.)	SIZE (AWG)		
LESS THAN 26'	4		
27' – 33'	2		
34' – 41'	1		
42' – 52'	1/0		
53' – 66'	2/0		
GREATER THAN 66'	3/0		

GROUNDING RISER

SCALE: NONE



REVISION NO. REVISION DATE ISSUED FOR PERMIT 10/18/2024 ISSUED FOR PERMIT ISSUED FOR

MEEKS PARTHOUSTON, Texas 77

e, Denver, CO 80203
velopment of

290 E. 17th Ave, I
A Develo
Abacus Ca

JOB NO.: 22035

NOT FOR CONSTRUCTION
ISSUED FOR PRICING
ISSUED FOR PERMIT
ISSUED FOR CONSTRUCTION

SHEET TITLE:

GROUNDING RISER -


TELECOM

DRAWING NO.

T0.16

KEY NOTES: FIBER CABLE RISER

- ONE (1) 96-PORT RACK-MOUNTED FIBER ENCLOSURES IN MDF
- ONE (1) 12-PORT RACK-MOUNTED FIBER ENCLOSURE PER IDF ROOM, TYPICAL.
- (3) CEILIN
- ROUTE TWELVE (12) STRANDS OF SINGLEMODE FIBER OPTIC CABLE TO EACH IDF ROOM INDIVIDUALLY; CABLING SHALL BE HOME RUN FROM FIRST FOOR IDF/ERRC ROOM OF THE BUILDING TO EACH IDF ROOM IN A TRUE STAR CONFIGURATION. TERMINATE SIX (6), LEAVE OTHER SIX (6) DARK, TYPICAL.
- ROUTE TWELVE (12) STRANDS OF SINGLE MODE FIBER OPTIC CABLE BETWEEN FIRST FLOOR IDF ROOMS OF EACH BUILDING. TERMINATE SIX (6), LEAVE THE OTHER SIX (6) DARK, TYPICAL. SEE SITE PLAN SHEET T1-01 FOR ROUTING BETWEEN BUILDINGS

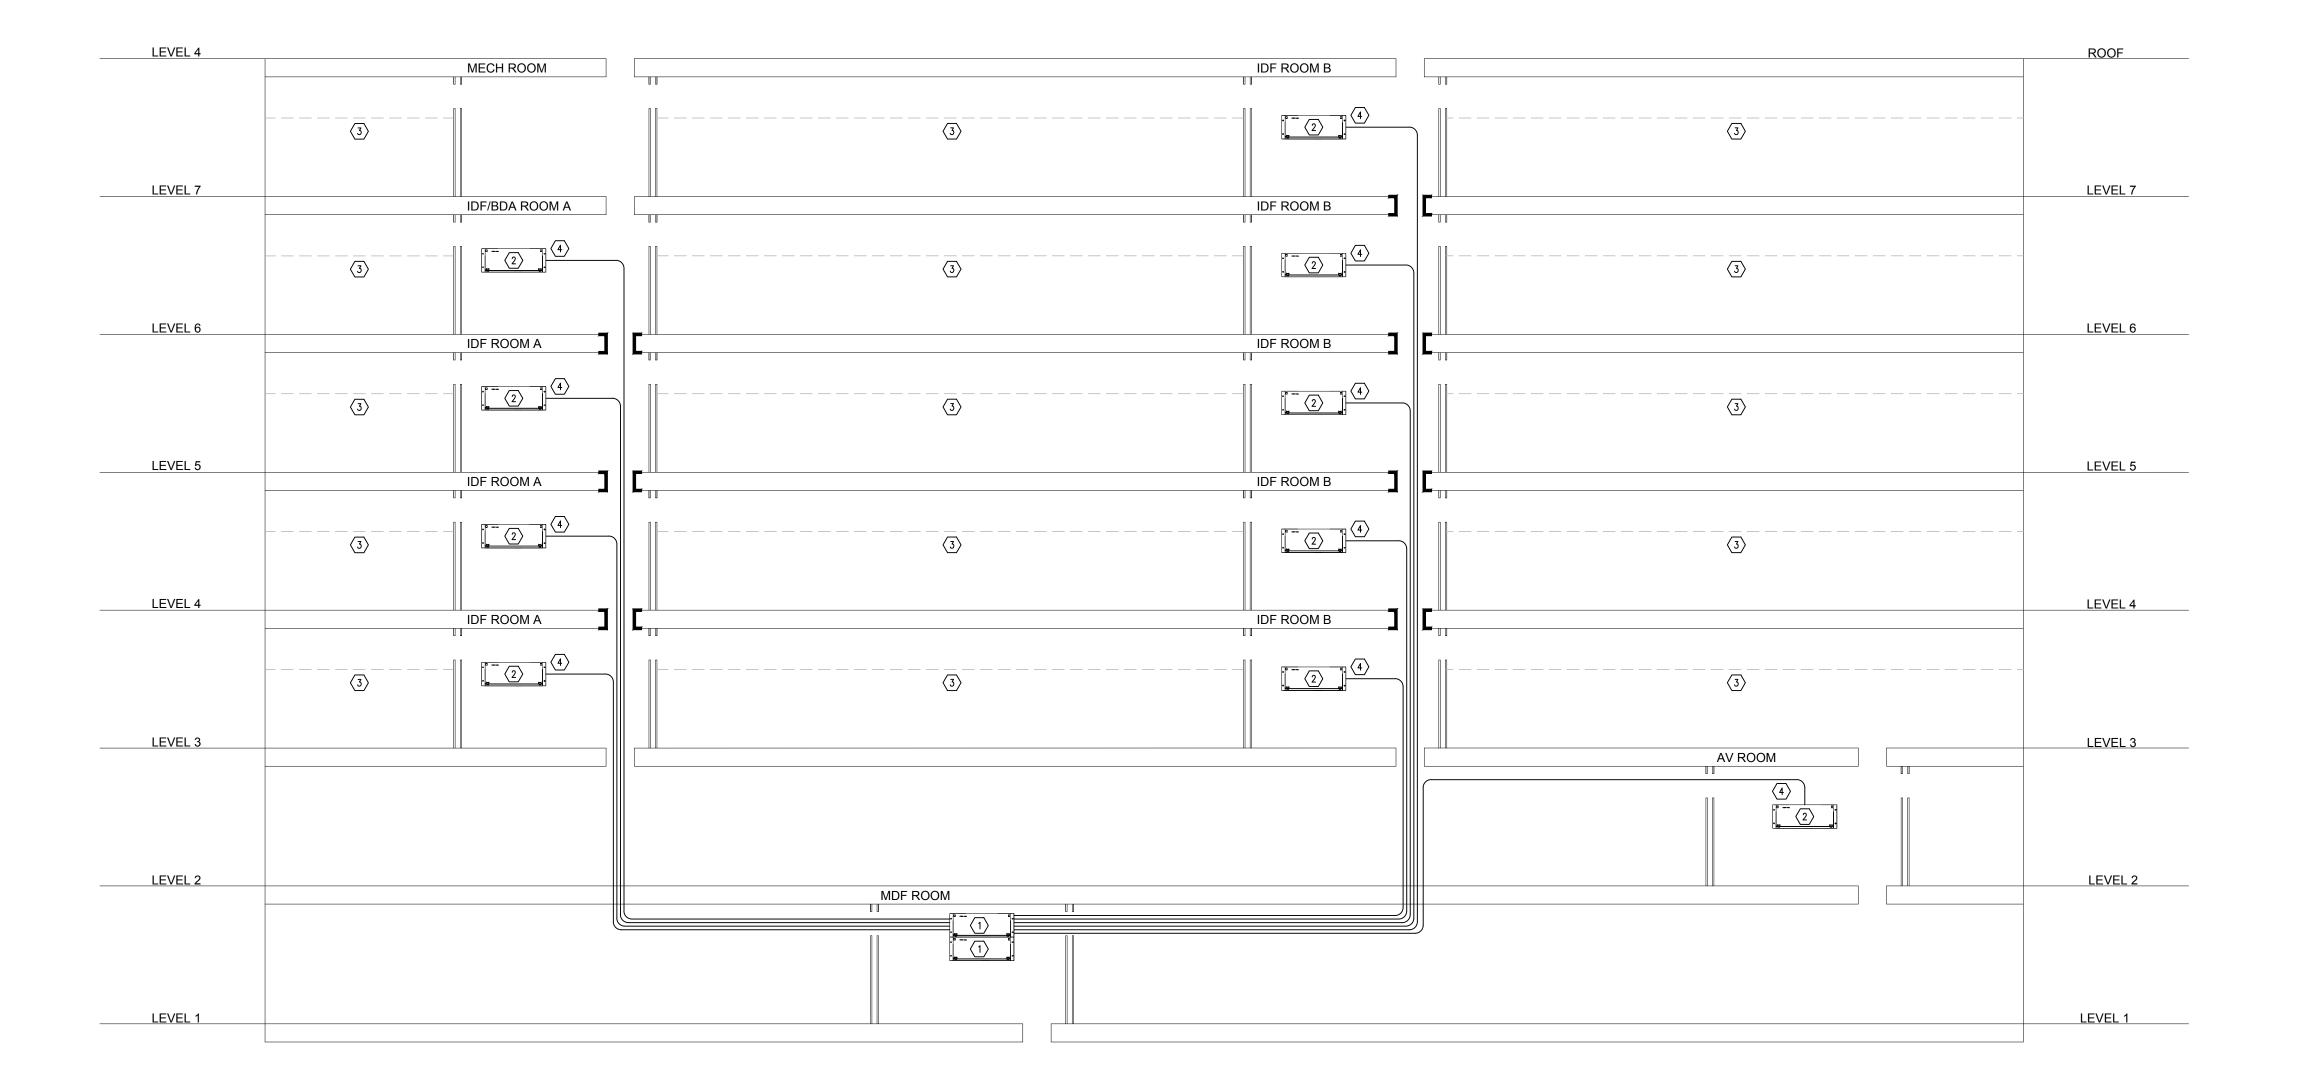






PARTNER MEEKS NOT FOR CONSTRUCTION ISSUED FOR PRICING ISSUED FOR PERMIT ISSUED FOR CONSTRUCTION SHEET TITLE: FIBER RISER -**TELECOM** DRAWING NO.

KEY NOTES: COAXIAL CABLE RISER

- COAXIAL CABLE TO SMC PANELS OR COMMON AREA OUTLETS. SEE FLOOR PLANS FOR EXACT DEVICE LOCATIONS & QUANTITIES. FOR REFERENCE, COPPER CAT6 CABLING HOME RUNS TO RESIDENTIAL UNITS & COMMON AREA OUTLETS SHALL FOLLOW THE SAME PATHWAYS & SETS OF STANDARDS.
- PLASTIC J-HOOKS ABOVE CEILING FOR COAXIAL CABLING. PROVIDE SPACING PER BICSI STANDARDS.
- TWO (2) HARD-LINE 0.625 COAXIAL CABLES
- WALL/BACKBOARD-MOUNTED TELEVISION HEAD END EQUIPMENT OR SPLITTERS. PROVIDE QUANTITY AS REQUIRED TO SERVE ALL HOME RUNS TO UNIT SMC PANELS & COMMON AREA TELEVISION (COAXIAL)

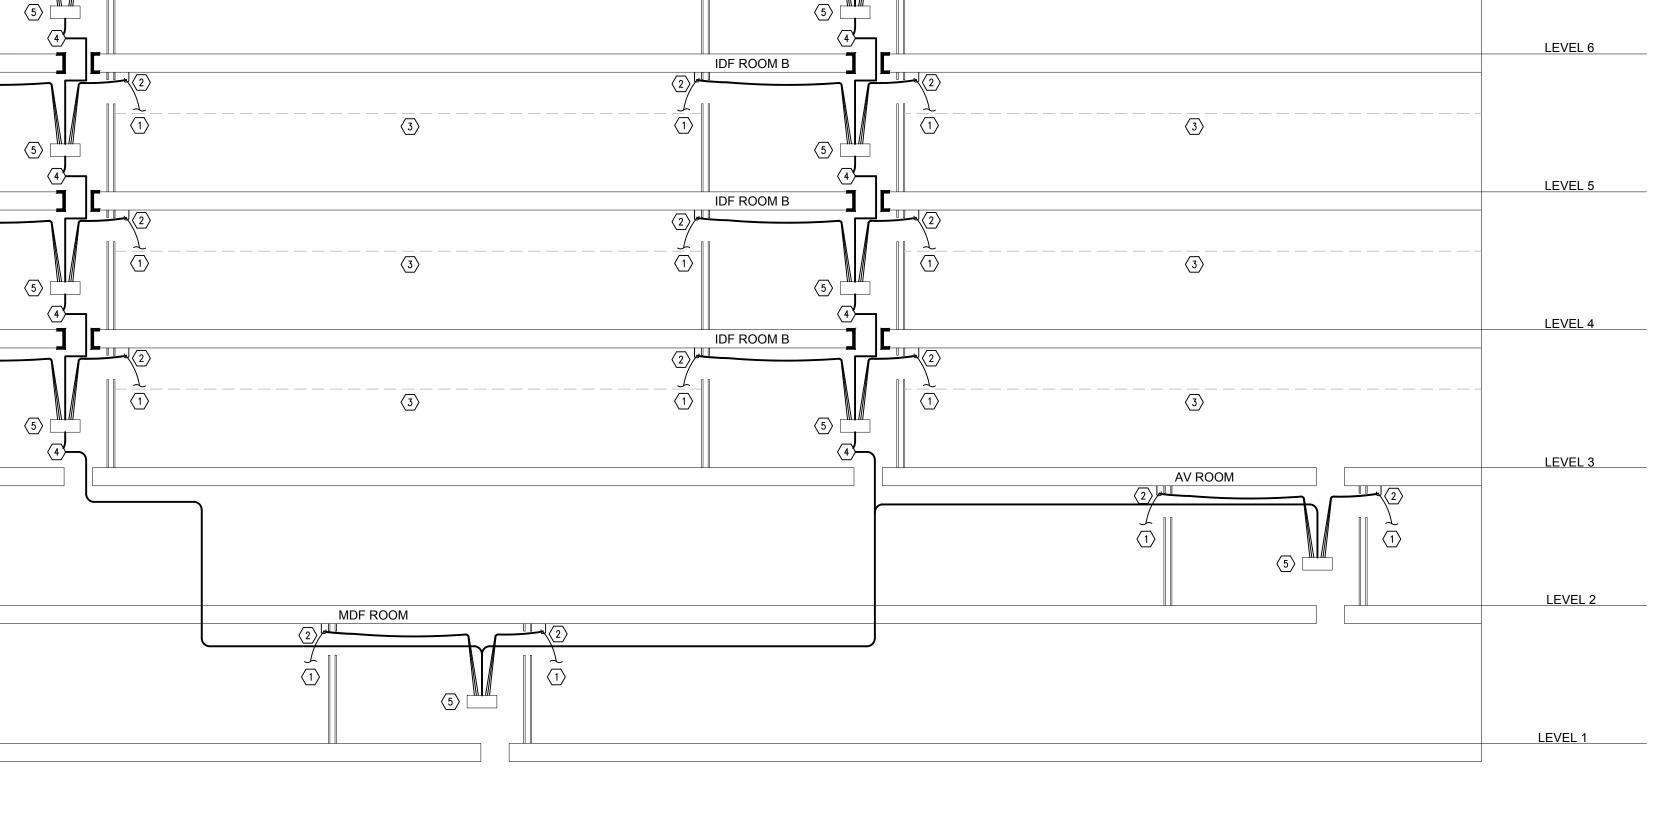

COAXIAL RISER DIAGRAM
SCALE: NONE



Drawn By: TP

Checked By: BMT

MEEKS

NOT FOR CONSTRUCTION ISSUED FOR PRICING ISSUED FOR PERMIT ISSUED FOR CONSTRUCTION

SHEET TITLE: **COAXIAL RISER -**

TELECOM DRAWING NO. IDF ROOM B

____LEVEL 4

MECH ROOM

KEY NOTES: COPPER CABLE RISER

CAT6 CABLE TO SMC PANELS OR COMMON AREA OUTLETS. SEE FLOOR PLANS FOR EXACT DEVICE LOCATIONS & QUANTITIES.

PLASTIC J-HOOKS ABOVE CEILING FOR COAXIAL CABLING. PROVIDE SPACING PER BICSI STANDARDS.

CEILING.

ROOF

RACK-MOUNTED CAT6 PATCH PANEL. PROVIDE QUANTITY AS REQUIRED TO SERVE ALL HOME RUNS TO UNIT SMC PANELS & COMMON AREA VOICE/DATA OUTLETS. CAMERAS, WIRELESS ACCESS POINTS, & ACCESS CONTROL POWER SUPPLIES SHALL BE HOME RUN TO POWER-OVER-ETHERNET (PoE) CAPABLE CAT6 PATCH PANELS. SEE FIBER RISER DIAGRAM ON SHEET TO-12 FOR DATA CONNECTIVITY BETWEEN TELECOM ROOMS.

NOT FOR CONSTRUCTION ISSUED FOR PRICING ISSUED FOR PERMIT ISSUED FOR CONSTRUCTION SHEET TITLE:

MEEKS


COPPER RISER -TELECOM DRAWING NO.

Checked By: BMT


Jordan & Skala Engineers

555 17th Street, Suite 700 Denver, CO 80202
p. 303.586.2375 Drawn By: TP

COPPER RISER DIAGRAM
SCALE: NONE

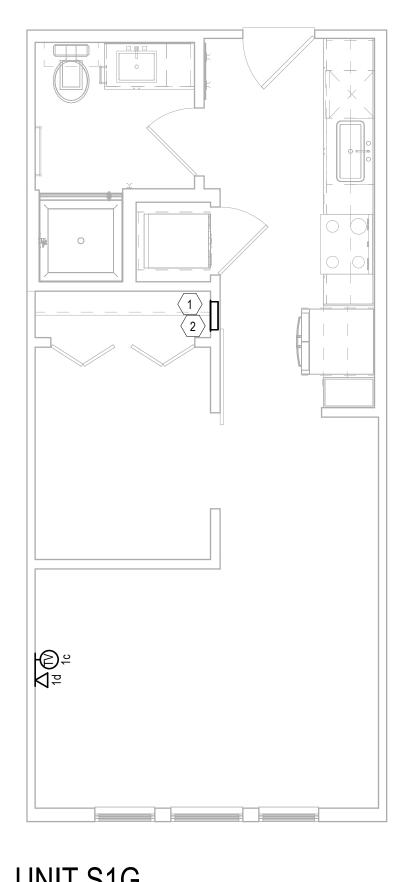



Scale: 1/4" = 1'-0"

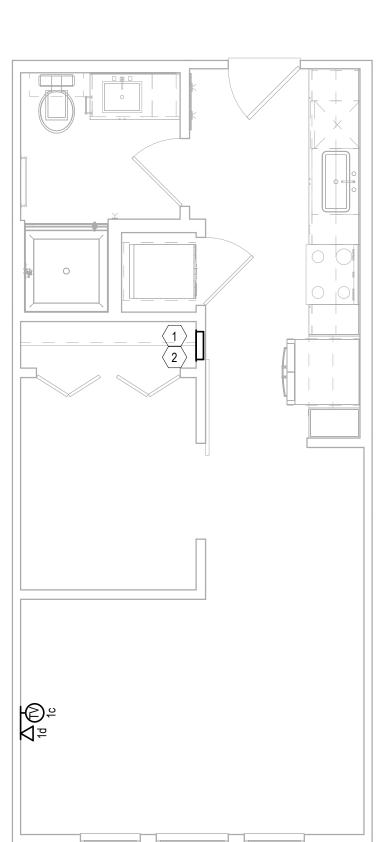


Scale: 1/4" = 1'-0"

UNIT S1B

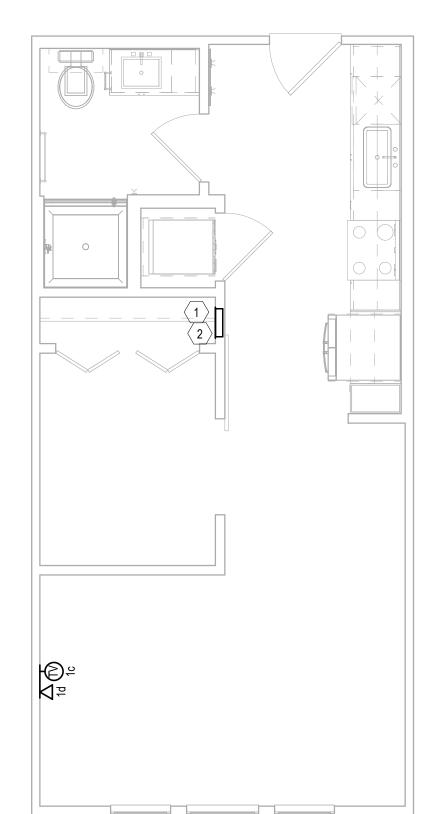

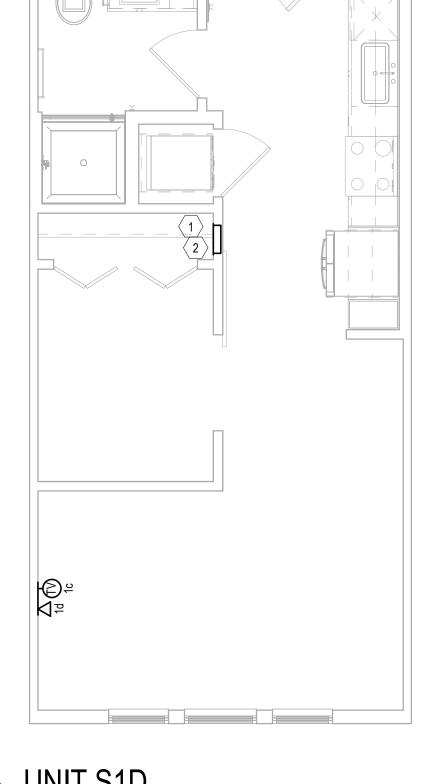

UNIT S1D

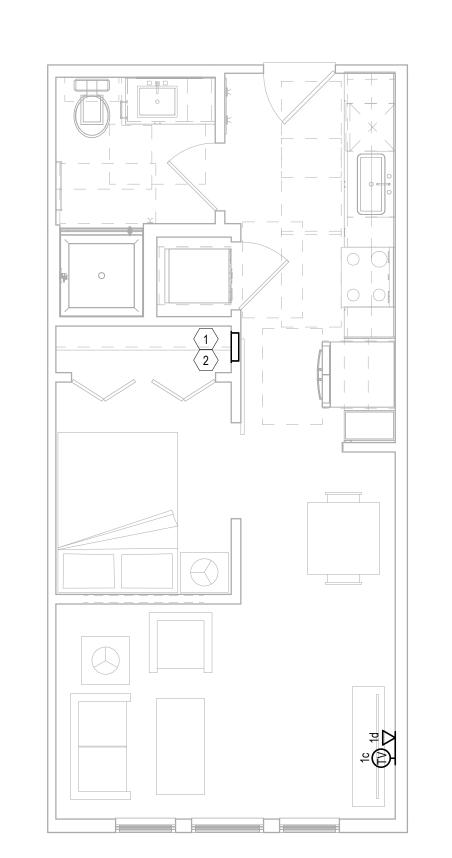



KEY NOTES: UNIT PLANS

- STRUCTURED MEDIA ENCLOSURE. ROUTE AND TERMINATE ALL VOICE, DATA, & TELEVISION CABLES WITHIN THE RESPECTIVE UNIT HERE (TYPICAL). SEE DETAIL B ON SHEET T2.00.
- HOME RUN ALL COAXIAL CABLES AND CAT6 CABLES TO NEAREST TELECOM ROOM. SEE DETAIL A ON SHEET T2.00.
- HOME RUN ALL COAXIAL CABLES AND CAT6 CABLES TO NEAREST TELECOM ROOM VIA ONE (1)-1" CONDUIT TO THE NEAREST TELECOM ROOM. SEE DETAIL A ON SHEET T2.00 & SHEET T3.00 FOR EXACT CONDUIT ROUTING.

GENERAL NOTES: UNIT PLANS

- G-1. ALL VOICE, DATA, & COAXIAL CABLES SHALL BE HOME RUN FROM EACH OUTLET TO THE STRUCTURED MEDIA CENTER WITHOUT SPLICES.
- G-2. MOUNT DEVICES AT THE SAME HEIGHT AS ELECTRICAL DEVICES (UNLESS OTHERWISE NOTED), ALIGN COVER PLATES. COORDINATE WITH ELECTRICAL.
- G-3. ALL VOICE & DATA CABLING SHALL BE CAT6.

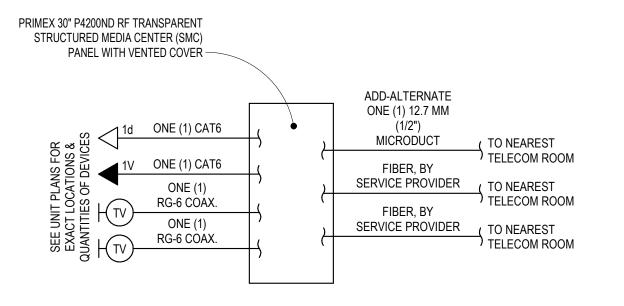

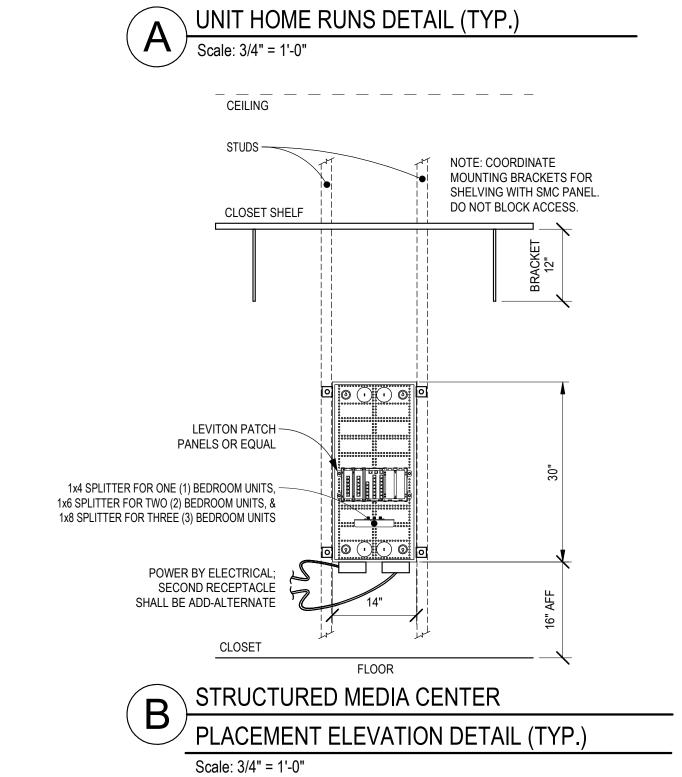




UNIT PLANS


DRAWING NO. T2.00


NOT FOR CONSTRUCTION

ISSUED FOR CONSTRUCTION

ISSUED FOR PRICING ISSUED FOR PERMIT

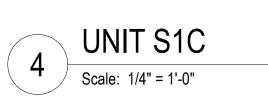


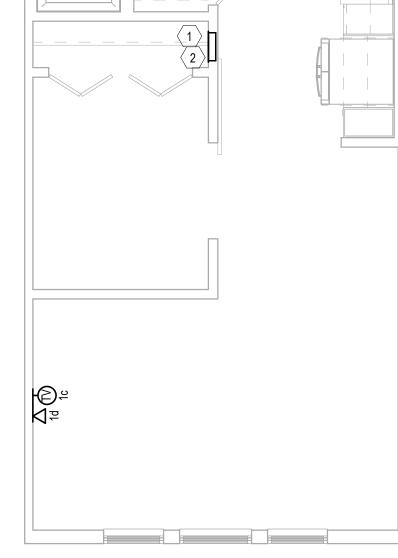

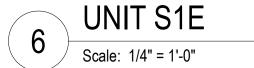

UNIT S1A


Scale: 1/4" = 1'-0"

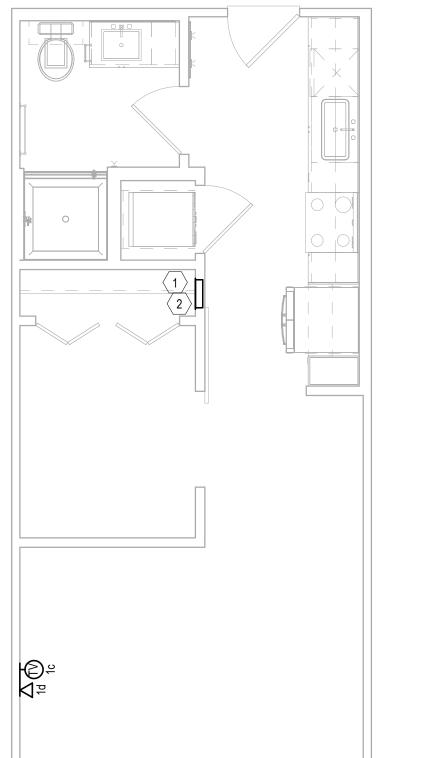

2 UNIT A0Y
Scale: 1/4" = 1'-0"

UNIT A0Z

Scale: 1/4" = 1'-0"

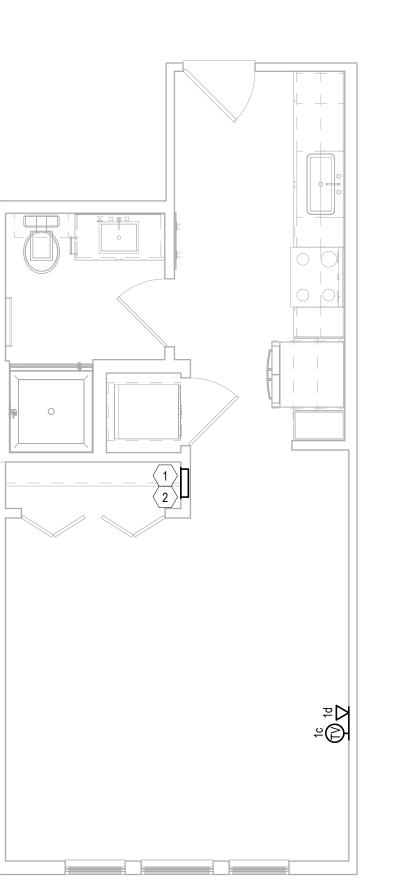

1 UNIT S1H
Scale: 1/4" = 1'-0"

KEY NOTES: UNIT PLANS

STRUCTURED MEDIA ENCLOSURE. ROUTE AND TERMINATE ALL VOICE, DATA, & TELEVISION CABLES WITHIN THE RESPECTIVE UNIT HERE (TYPICAL). SEE DETAIL B ON SHEET T2.00.

HOME RUN ALL COAXIAL CABLES AND CAT6 CABLES TO NEAREST TELECOM ROOM. SEE DETAIL A ON SHEET T2.00.

HOME RUN ALL COAXIAL CABLES AND CAT6 CABLES TO NEAREST TELECOM ROOM VIA ONE (1)-1" CONDUIT TO THE NEAREST TELECOM ROOM. SEE DETAIL A ON SHEET T2.00 & SHEET T3.00 FOR EXACT CONDUIT ROUTING.

GENERAL NOTES: UNIT PLANS

G-1. ALL VOICE, DATA, & COAXIAL CABLES SHALL BE HOME RUN FROM EACH OUTLET TO THE STRUCTURED MEDIA CENTER WITHOUT SPLICES.

G-2. MOUNT DEVICES AT THE SAME HEIGHT AS ELECTRICAL DEVICES (UNLESS OTHERWISE NOTED), ALIGN COVER PLATES. COORDINATE WITH ELECTRICAL.

G-3. ALL VOICE & DATA CABLING SHALL BE CAT6.

NOT FOR CONSTRUCTION ISSUED FOR PRICING

ISSUED FOR PERMIT

ISSUED FOR CONSTRUCTION


UNIT PLANS

DRAWING NO. T2.01


Checked By: BMT

Jordan & Skala Engineers

555 17th Street, Suite 700 • Denver, CO 80202
p. 303.586.2375

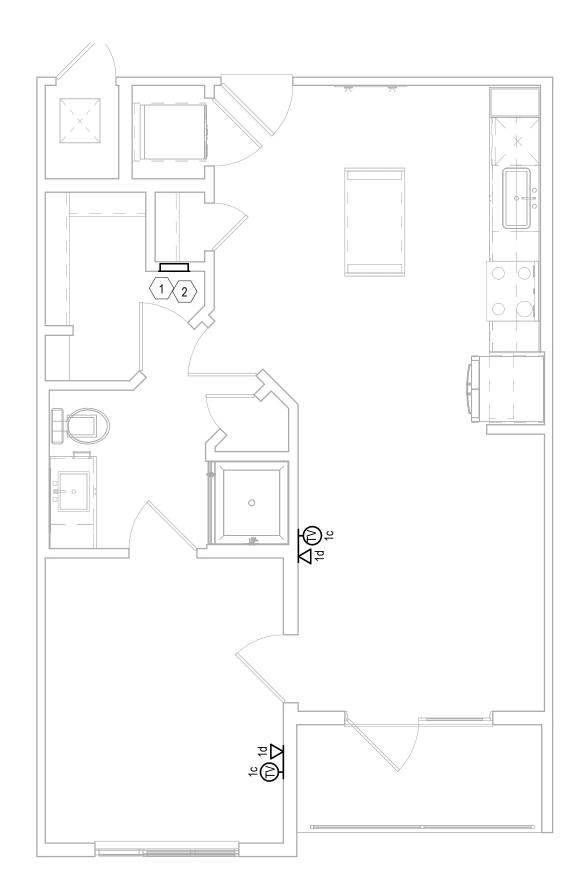

UNIT A2A Scale: 1/4" = 1'-0"

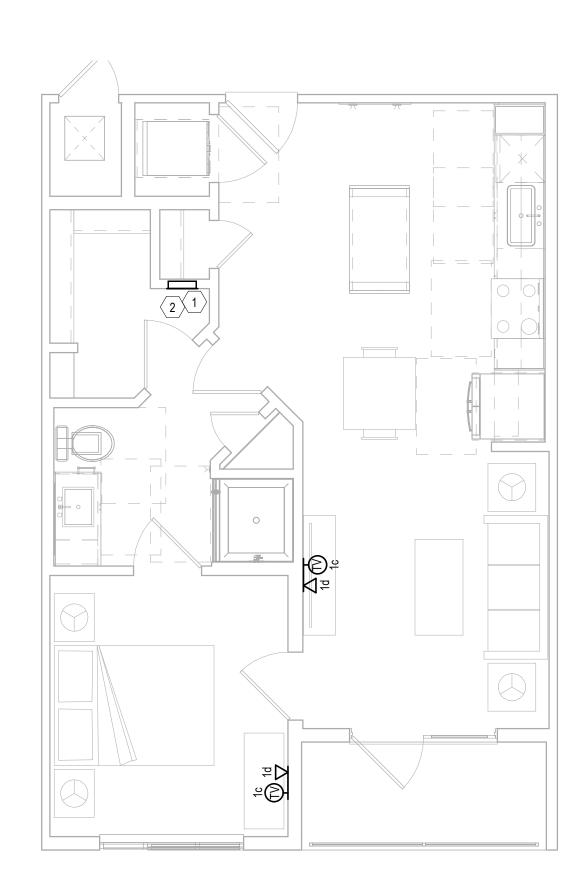

2 UNIT A2
Scale: 1/4" = 1'-0"



KEY NOTES: UNIT PLANS

STRUCTURED MEDIA ENCLOSURE. ROUTE AND TERMINATE ALL VOICE, DATA, & TELEVISION CABLES WITHIN THE RESPECTIVE UNIT HERE (TYPICAL). SEE DETAIL B ON SHEET T2.00.

HOME RUN ALL COAXIAL CABLES AND CAT6 CABLES TO NEAREST TELECOM ROOM. SEE DETAIL A ON SHEET T2.00.


HOME RUN ALL COAXIAL CABLES AND CAT6 CABLES TO NEAREST TELECOM ROOM VIA ONE (1)-1" CONDUIT TO THE NEAREST TELECOM ROOM. SEE DETAIL A ON SHEET T2.00 & SHEET T3.00 FOR EXACT CONDUIT ROUTING.

GENERAL NOTES: UNIT PLANS

G-1. ALL VOICE, DATA, & COAXIAL CABLES SHALL BE HOME RUN FROM EACH OUTLET TO THE STRUCTURED MEDIA CENTER WITHOUT SPLICES.

G-2. MOUNT DEVICES AT THE SAME HEIGHT AS ELECTRICAL DEVICES (UNLESS OTHERWISE NOTED), ALIGN COVER PLATES. COORDINATE WITH ELECTRICAL.

G-3. ALL VOICE & DATA CABLING SHALL BE CAT6.

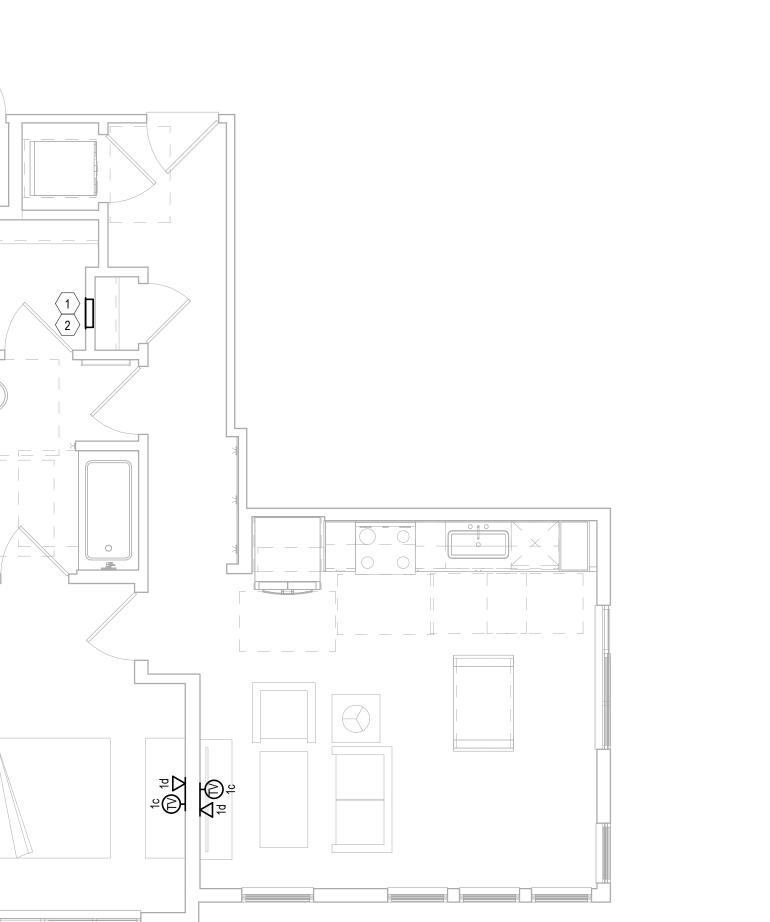


Jordan & Skala Engineers
555 17th Street, Suite 700 • Denver, CO 80202
p. 303.586.2375

UNIT PLAN


DRAWING NO. T2.02

NOT FOR CONSTRUCTION ISSUED FOR PRICING ISSUED FOR PERMIT


ISSUED FOR CONSTRUCTION

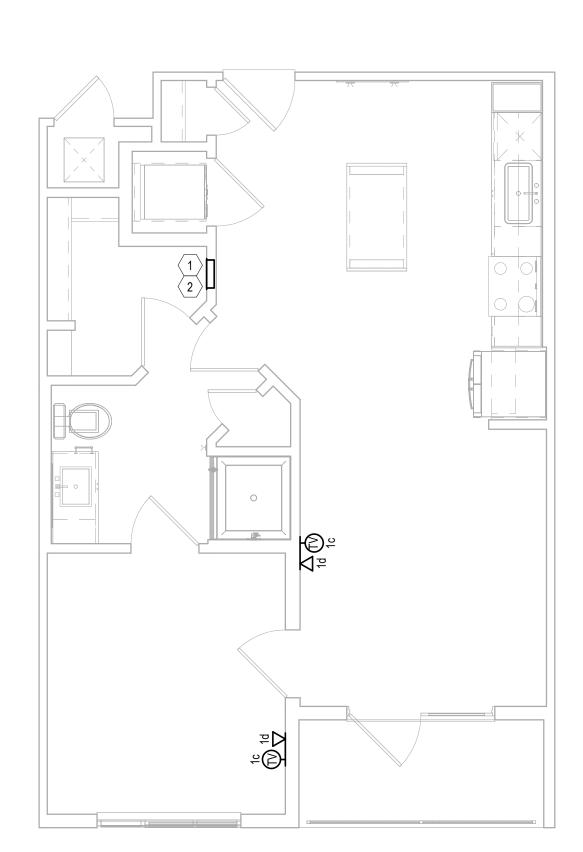

2 UNIT A2C
Scale: 1/4" = 1'-0"

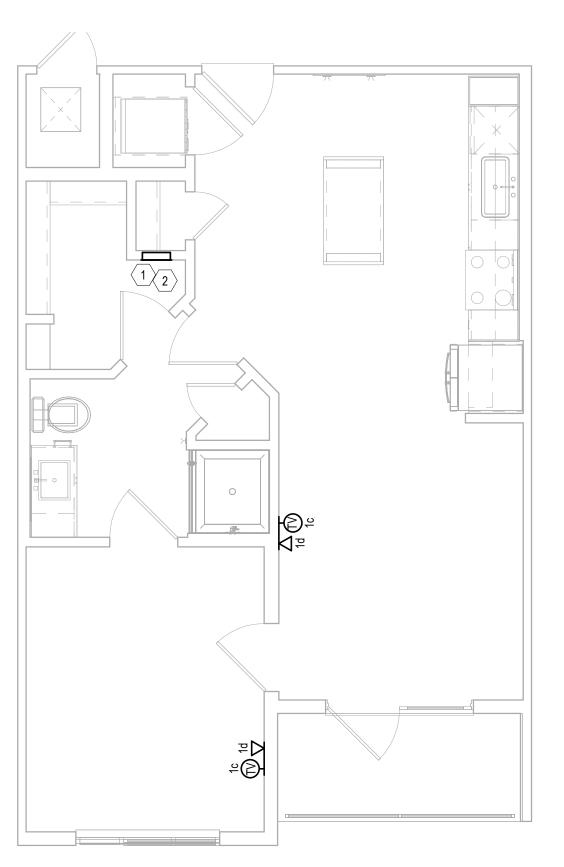

4 UNIT A2E

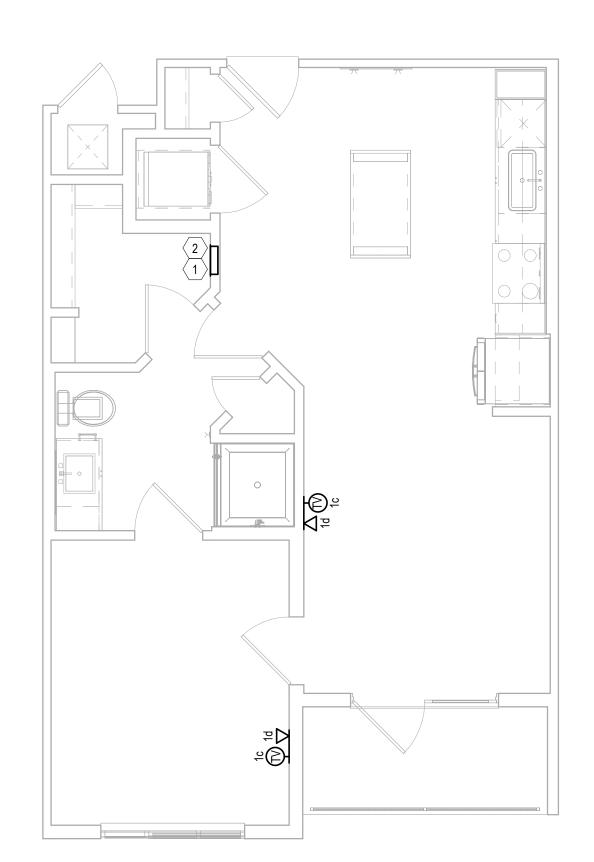

1 UNIT A2B
Scale: 1/4" = 1'-0"

KEY NOTES: UNIT PLANS

- STRUCTURED MEDIA ENCLOSURE. ROUTE AND TERMINATE ALL VOICE, DATA, & TELEVISION CABLES WITHIN THE RESPECTIVE UNIT HERE (TYPICAL). SEE DETAIL B ON SHEET T2.00.
- HOME RUN ALL COAXIAL CABLES AND CAT6 CABLES TO NEAREST TELECOM ROOM. SEE DETAIL A ON SHEET T2.00.
- HOME RUN ALL COAXIAL CABLES AND CAT6 CABLES TO NEAREST TELECOM ROOM VIA ONE (1)-1" CONDUIT TO THE NEAREST TELECOM ROOM. SEE DETAIL A ON SHEET T2.00 & SHEET T3.00 FOR EXACT CONDUIT ROUTING.

GENERAL NOTES: UNIT PLANS

- G-1. ALL VOICE, DATA, & COAXIAL CABLES SHALL BE HOME RUN FROM EACH OUTLET TO THE STRUCTURED MEDIA CENTER WITHOUT SPLICES.
- G-2. MOUNT DEVICES AT THE SAME HEIGHT AS ELECTRICAL DEVICES (UNLESS OTHERWISE NOTED), ALIGN COVER PLATES. COORDINATE WITH ELECTRICAL.
- G-3. ALL VOICE & DATA CABLING SHALL BE CAT6.

10/18/2024 ISSUED FOR PERMIT REVISION DESCRIPTION

FKS PARTNERS
16000 Memorial Drive
Suite 100
Houston, Texas 77079

ARTMENTS er, CO 80203

17th Ave, Denver, CO 8
A Development of

DB NO.: 22035

NOT FOR CONSTRUCTION

ISSUED FOR PRICING

ISSUED FOR PERMIT

ISSUED FOR CONSTRUCTION


UNIT PLAN


 $\begin{array}{c} \text{DRAWING NO.} \\ T2.03 \end{array}$


Jordan & Skala Engineers


555 17th Street, Suite 700 • Denver, CO 80202
p. 303.586.2375

Project Number: 23080076 Drawn By: Author Checked By: Checker

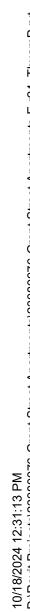


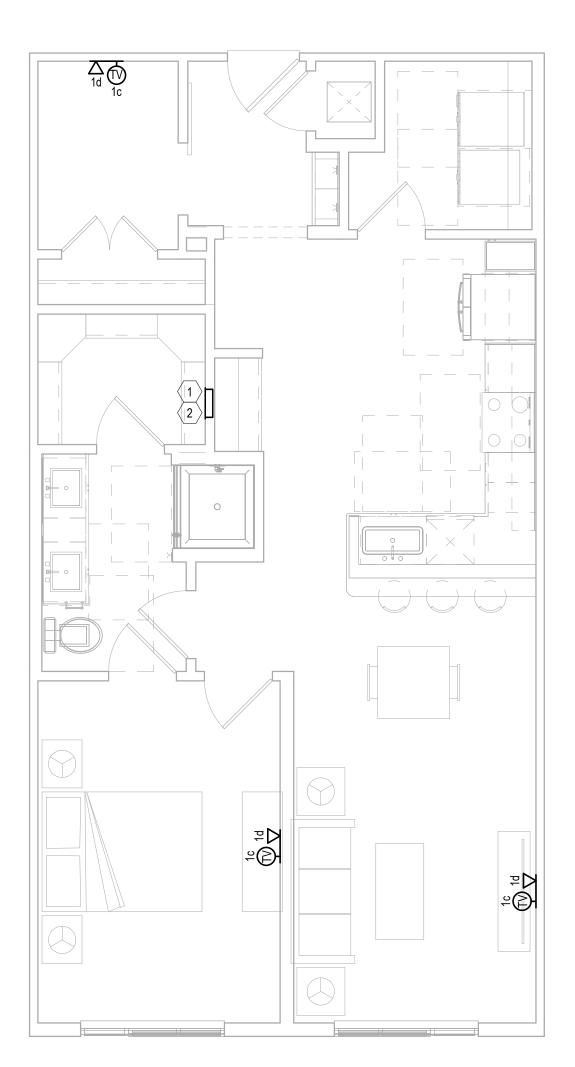

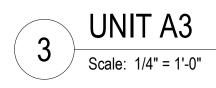


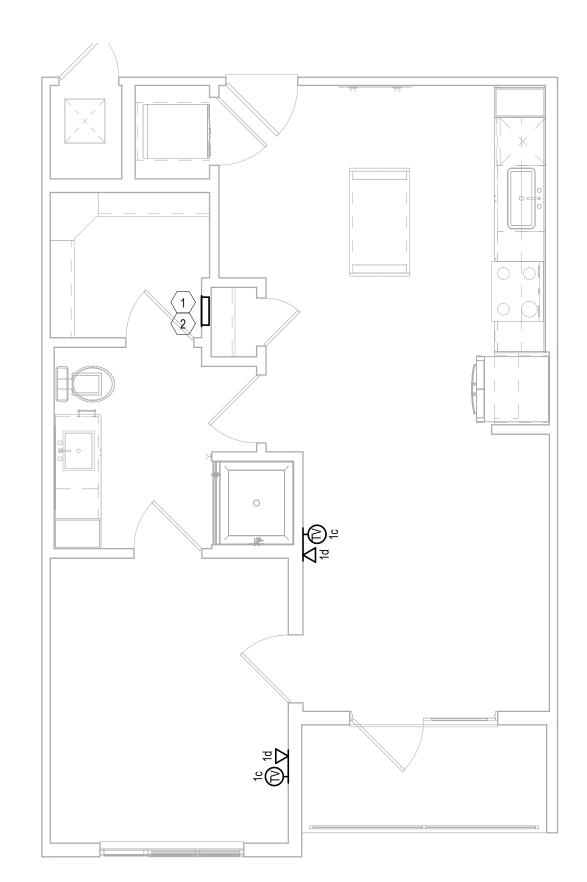

UNIT A2G 2 Scale: 1/4" = 1'-0"

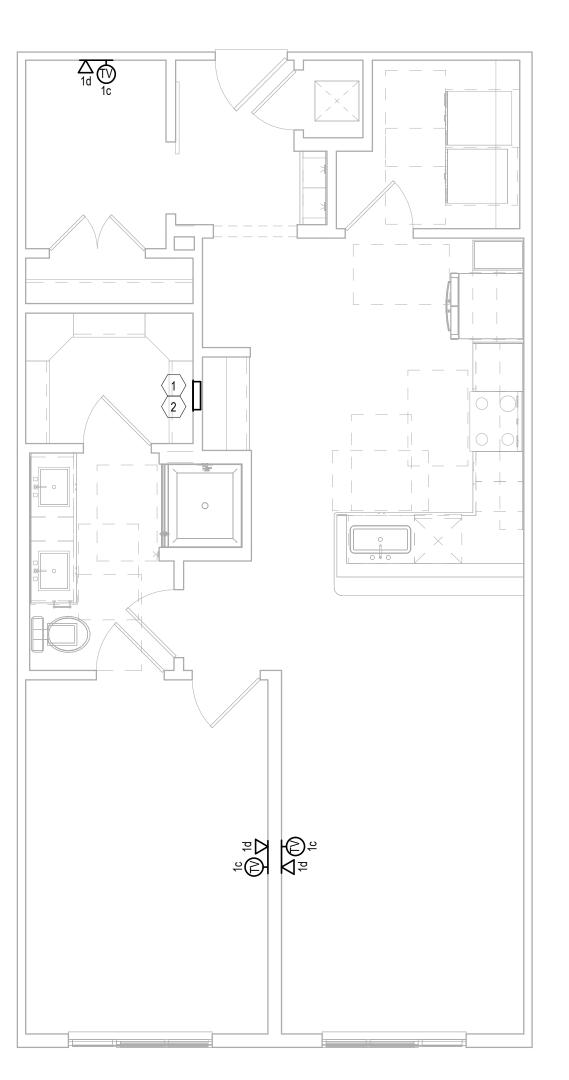

4 UNIT A3A
Scale: 1/4" = 1'-0"

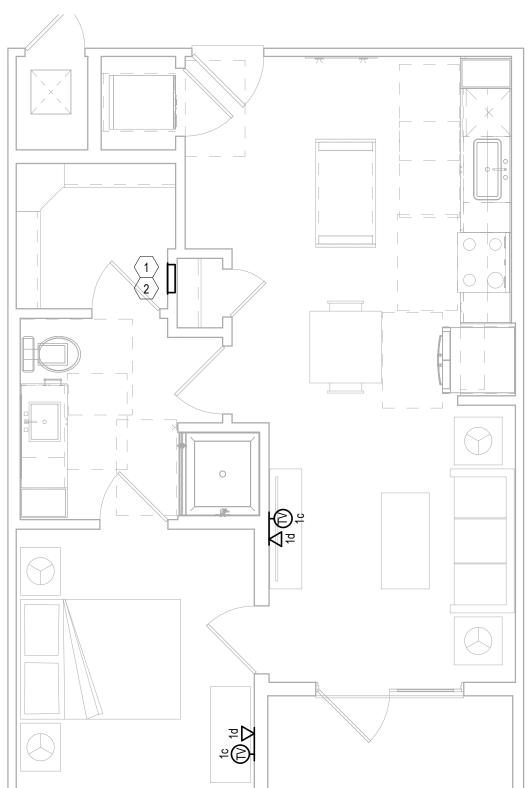

UNIT A2F


Scale: 1/4" = 1'-0"

KEY NOTES: UNIT PLANS

- STRUCTURED MEDIA ENCLOSURE. ROUTE AND TERMINATE ALL VOICE, DATA, & TELEVISION CABLES WITHIN THE RESPECTIVE UNIT HERE (TYPICAL). SEE DETAIL B ON SHEET T2.00.
- HOME RUN ALL COAXIAL CABLES AND CAT6 CABLES TO NEAREST TELECOM ROOM. SEE DETAIL A ON SHEET T2.00.
- HOME RUN ALL COAXIAL CABLES AND CAT6 CABLES TO NEAREST TELECOM ROOM VIA ONE (1)-1" CONDUIT TO THE NEAREST TELECOM ROOM. SEE DETAIL A ON SHEET T2.00 & SHEET

GENERAL NOTES: UNIT PLANS

- G-1. ALL VOICE, DATA, & COAXIAL CABLES SHALL BE HOME RUN FROM EACH OUTLET TO THE STRUCTURED MEDIA CENTER WITHOUT SPLICES.
- G-2. MOUNT DEVICES AT THE SAME HEIGHT AS ELECTRICAL DEVICES (UNLESS OTHERWISE NOTED), ALIGN COVER PLATES. COORDINATE WITH ELECTRICAL.
- G-3. ALL VOICE & DATA CABLING SHALL BE CAT6.

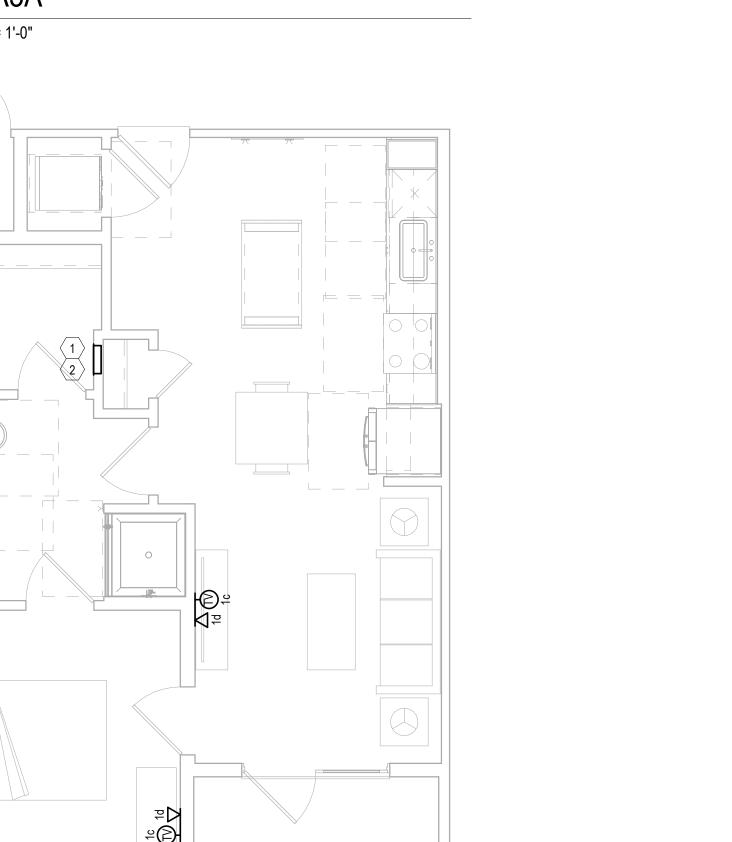



Jordan & Skala Engineers
555 17th Street, Suite 700 • Denver, CO 80202
p. 303.586.2375 Checked By: Checker



UNIT PLAN

NOT FOR CONSTRUCTION ISSUED FOR PRICING ISSUED FOR PERMIT


ISSUED FOR CONSTRUCTION


GRANT STREET APARTMENTS
290 E. 17th Ave, Denver, CO 80203
A Development of
Abacus Capital Group


- STRUCTURED MEDIA ENCLOSURE. ROUTE AND TERMINATE ALL VOICE, DATA, & TELEVISION CABLES WITHIN THE RESPECTIVE UNIT HERE (TYPICAL). SEE DETAIL B ON SHEET T2.00.
- HOME RUN ALL COAXIAL CABLES AND CAT6 CABLES TO NEAREST TELECOM ROOM. SEE DETAIL A ON SHEET T2.00.
- HOME RUN ALL COAXIAL CABLES AND CAT6 CABLES TO NEAREST TELECOM ROOM VIA ONE (1)-1" CONDUIT TO THE NEAREST TELECOM ROOM. SEE DETAIL A ON SHEET T2.00 & SHEET T3.00 FOR EXACT CONDUIT ROUTING.

GENERAL NOTES: UNIT PLANS


- G-1. ALL VOICE, DATA, & COAXIAL CABLES SHALL BE HOME RUN FROM EACH OUTLET TO THE STRUCTURED MEDIA CENTER WITHOUT SPLICES.
- G-2. MOUNT DEVICES AT THE SAME HEIGHT AS ELECTRICAL DEVICES (UNLESS OTHERWISE NOTED), ALIGN COVER PLATES. COORDINATE WITH ELECTRICAL.
- G-3. ALL VOICE & DATA CABLING SHALL BE CAT6.

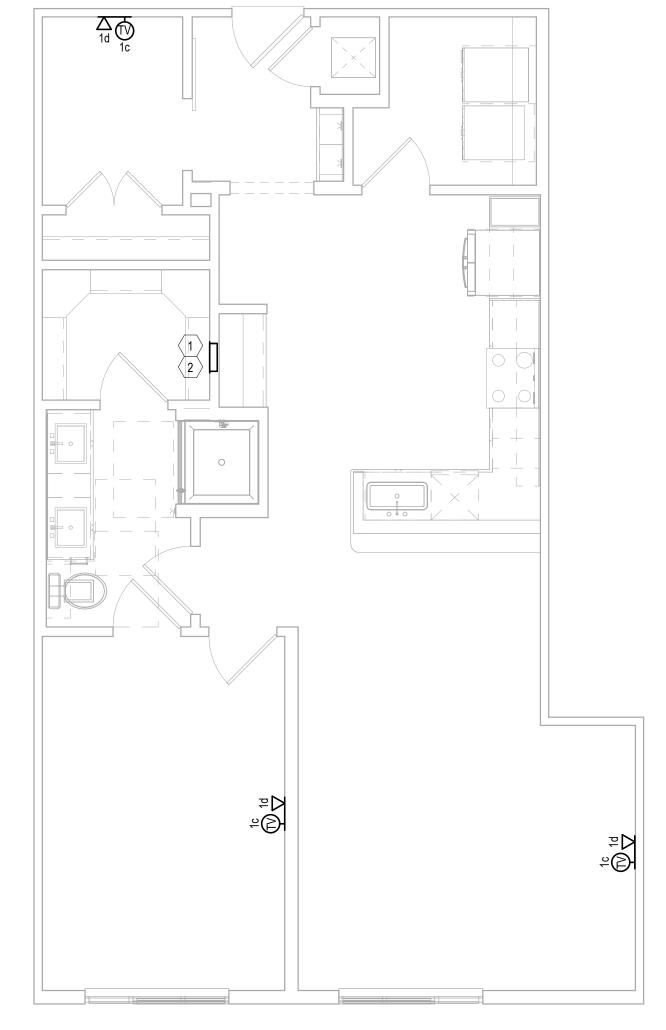

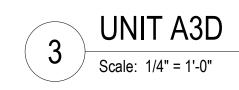

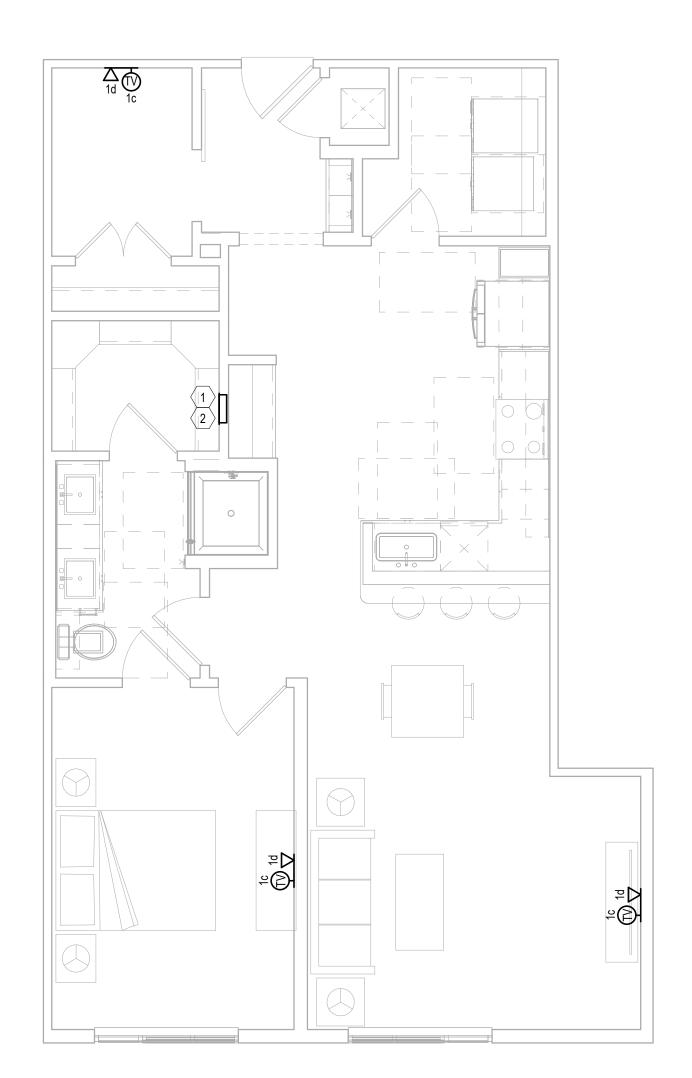

UNIT A3C

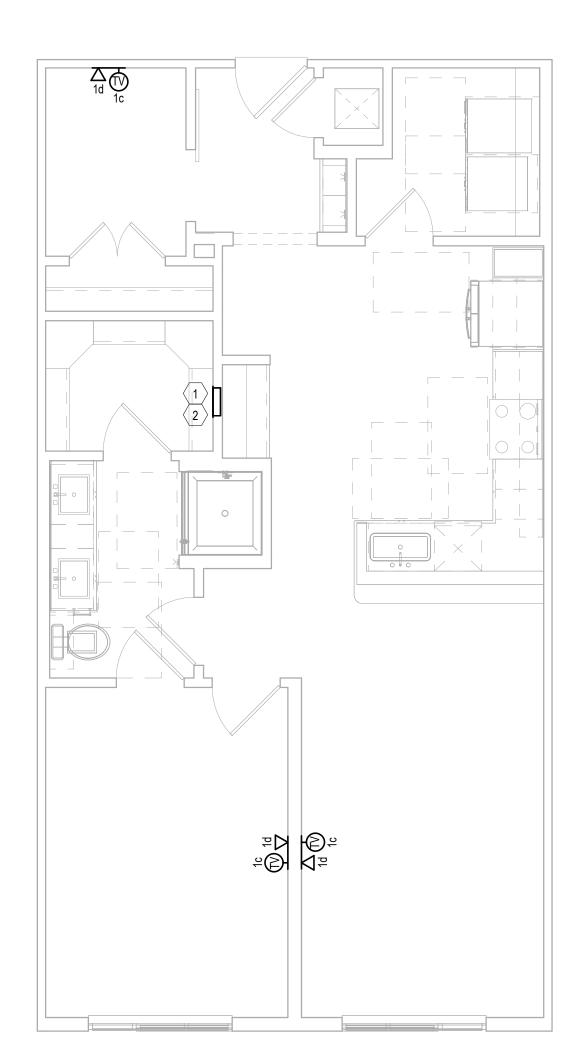

UNIT A3B Scale: 1/4" = 1'-0"


Jordan & Skala Engineers
555 17th Street, Suite 700 • Denver, CO 80202
p. 303.586.2375

DRAWING NO. T2.05


UNIT PLAN

NOT FOR CONSTRUCTION ISSUED FOR PRICING ISSUED FOR PERMIT

ISSUED FOR CONSTRUCTION

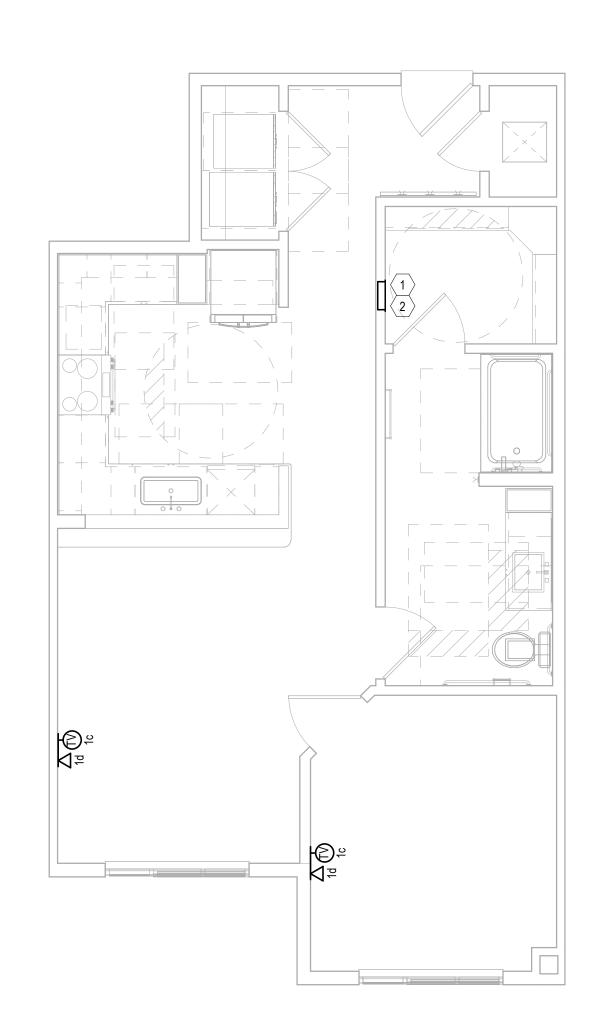

2 UNIT A4-TA
Scale: 1/4" = 1'-0"

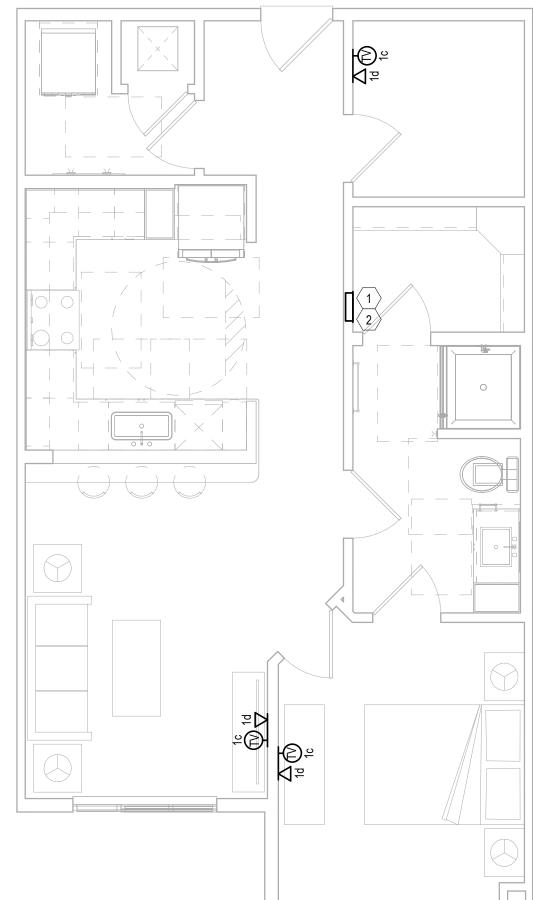

UNIT A4

Scale: 1/4" = 1'-0"

Jordan & Skala Engineers
555 17th Street, Suite 700 • Denver, CO 80202
p. 303.586.2375

STRUCTURED MEDIA ENCLOSURE. ROUTE AND TERMINATE ALL VOICE, DATA, & TELEVISION CABLES WITHIN THE RESPECTIVE UNIT HERE (TYPICAL). SEE DETAIL B ON SHEET T2.00.

HOME RUN ALL COAXIAL CABLES AND CAT6 CABLES TO NEAREST TELECOM ROOM. SEE

HOME RUN ALL COAXIAL CABLES AND CAT6 CABLES TO NEAREST TELECOM ROOM VIA ONE (1)-1" CONDUIT TO THE NEAREST TELECOM ROOM. SEE DETAIL A ON SHEET T2.00 & SHEET

KEY NOTES: UNIT PLANS

DETAIL A ON SHEET T2.00.

T3.00 FOR EXACT CONDUIT ROUTING.

GENERAL NOTES: UNIT PLANS

NOT FOR CONSTRUCTION ISSUED FOR PRICING ISSUED FOR PERMIT ISSUED FOR CONSTRUCTION

UNIT PLAN


DRAWING NO. T2.06

KEY NOTES: UNIT PLANS


- STRUCTURED MEDIA ENCLOSURE. ROUTE AND TERMINATE ALL VOICE, DATA, & TELEVISION CABLES WITHIN THE RESPECTIVE UNIT HERE (TYPICAL). SEE DETAIL B ON SHEET T2.00.
- HOME RUN ALL COAXIAL CABLES AND CAT6 CABLES TO NEAREST TELECOM ROOM. SEE DETAIL A ON SHEET T2.00.
- HOME RUN ALL COAXIAL CABLES AND CAT6 CABLES TO NEAREST TELECOM ROOM VIA ONE (1)-1" CONDUIT TO THE NEAREST TELECOM ROOM. SEE DETAIL A ON SHEET T2.00 & SHEET T3.00 FOR EXACT CONDUIT ROUTING.

GENERAL NOTES: UNIT PLANS

- G-1. ALL VOICE, DATA, & COAXIAL CABLES SHALL BE HOME RUN FROM EACH OUTLET TO THE STRUCTURED MEDIA CENTER WITHOUT SPLICES.
- G-2. MOUNT DEVICES AT THE SAME HEIGHT AS ELECTRICAL DEVICES (UNLESS OTHERWISE NOTED), ALIGN COVER PLATES. COORDINATE WITH ELECTRICAL.
- G-3. ALL VOICE & DATA CABLING SHALL BE CAT6.

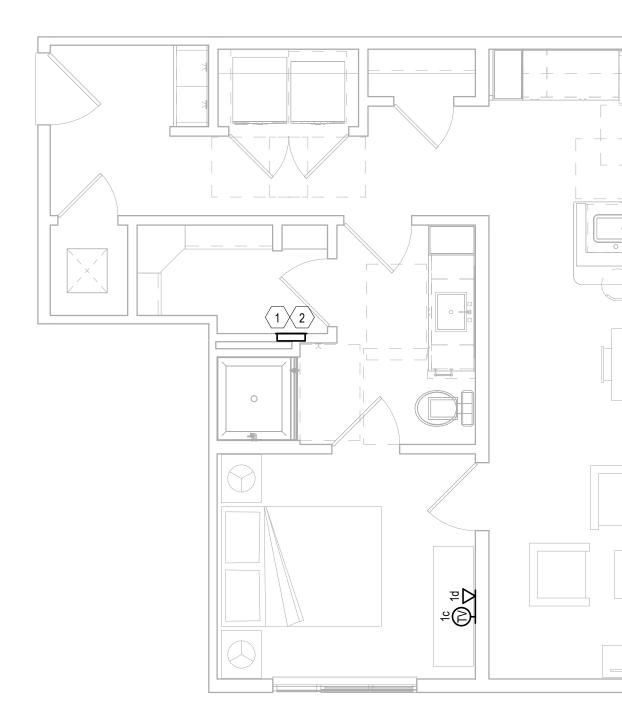



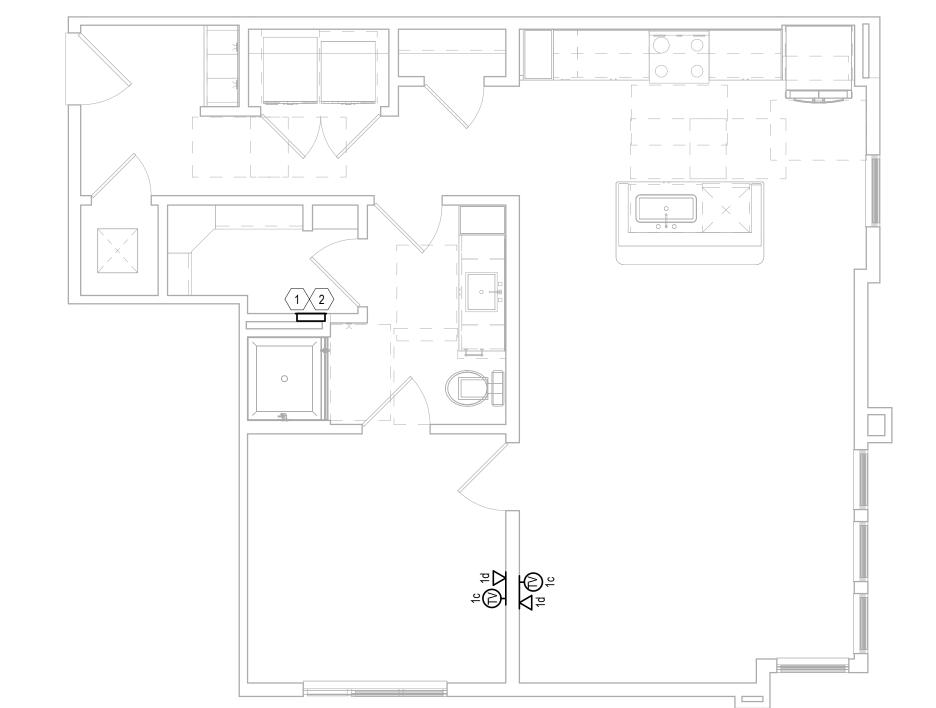

UNIT A5A 2 UNII A5A
Scale: 1/4" = 1'-0"

Jordan & Skala Engineers

555 17th Street, Suite 700 • Denver, CO 80202
p. 303.586.2375

DRAWING NO. T2.07

UNIT PLAN


NOT FOR CONSTRUCTION ISSUED FOR PRICING ISSUED FOR PERMIT


ISSUED FOR CONSTRUCTION



UNIT A5

Scale: 1/4" = 1'-0"

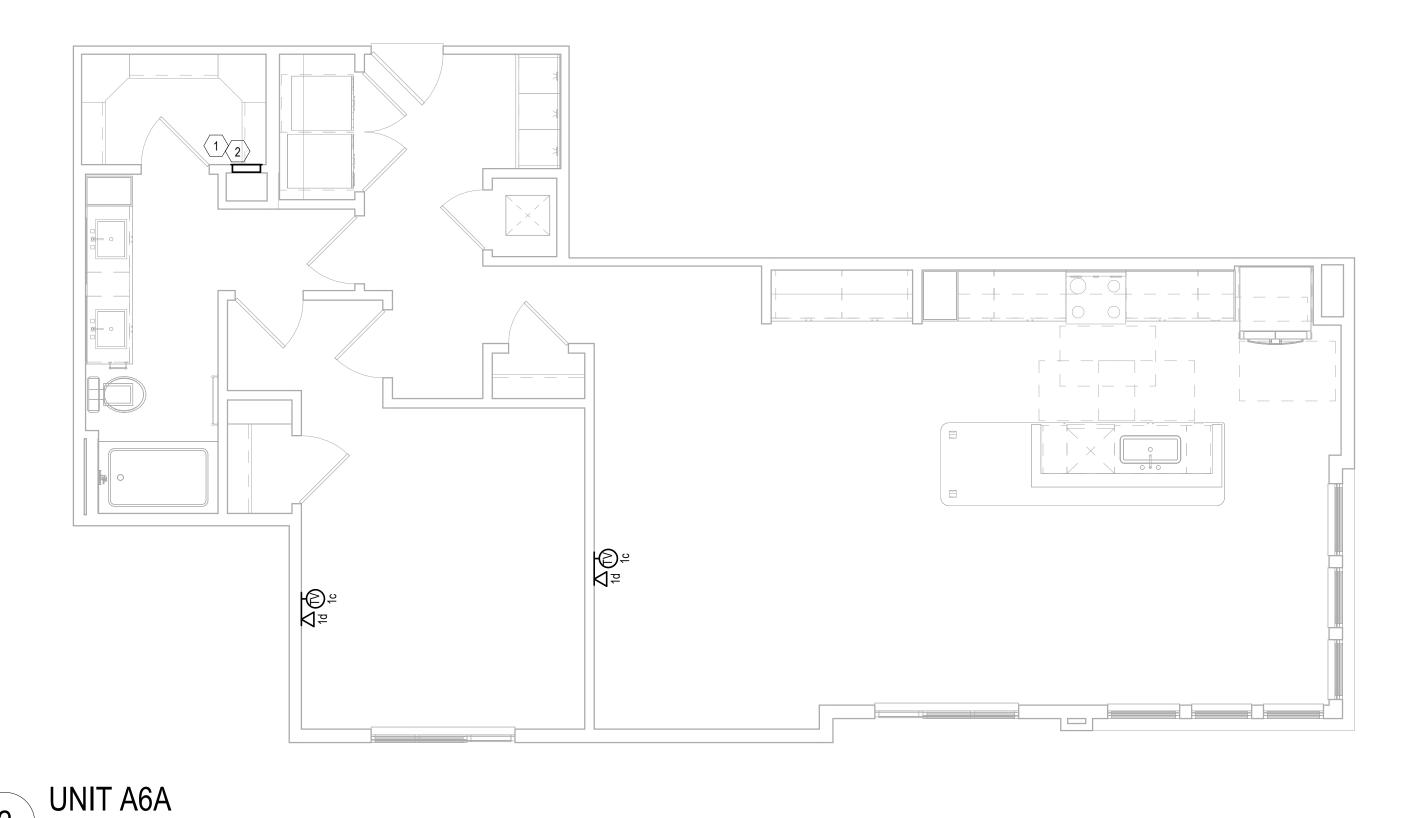

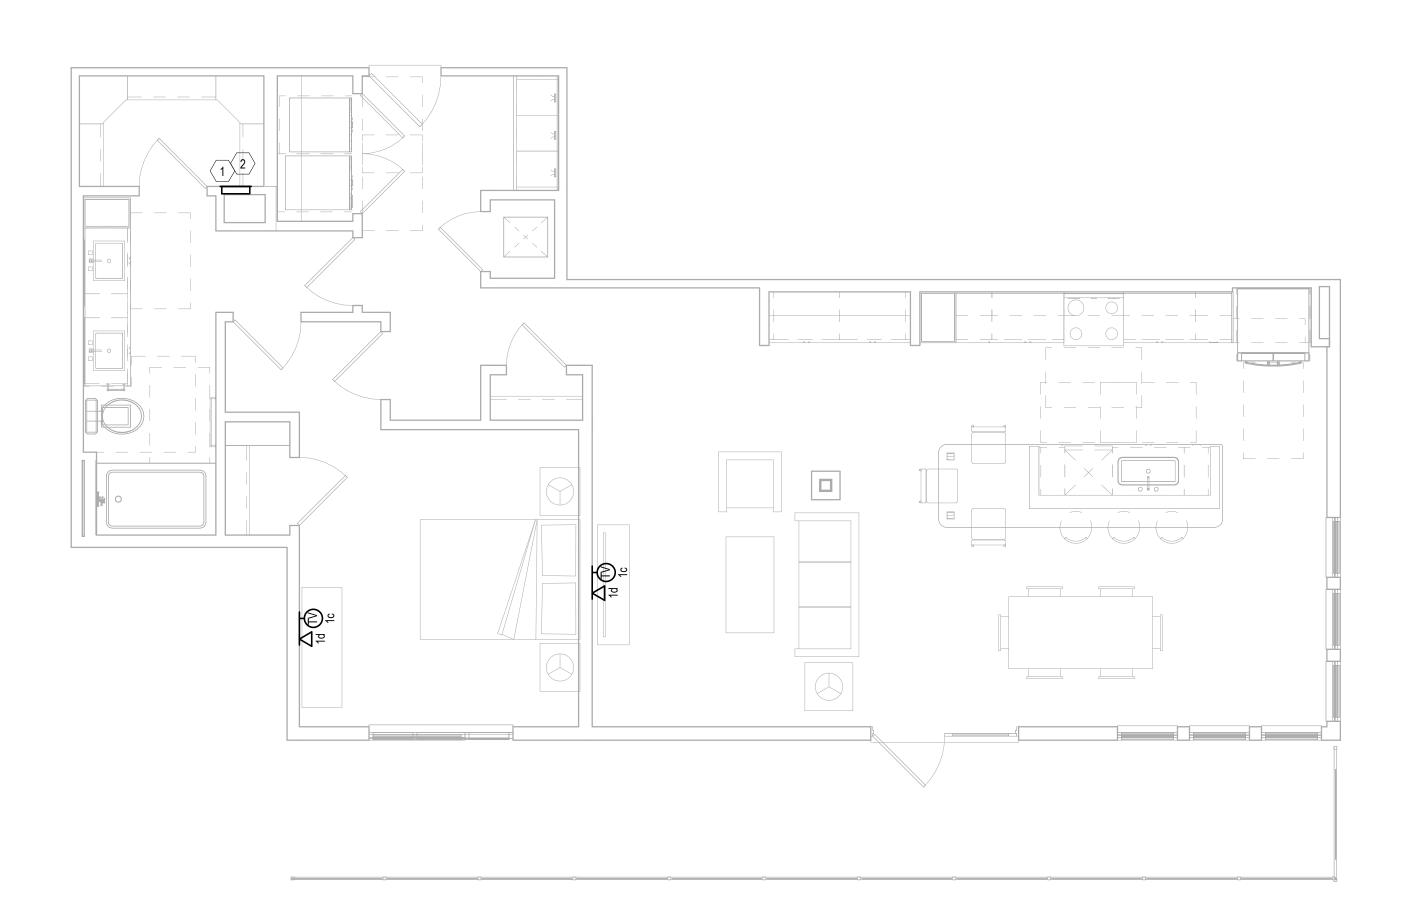

UNIT A6

Scale: 1/4" = 1'-0"


Scale: 1/4" = 1'-0"

KEY NOTES: UNIT PLANS

- STRUCTURED MEDIA ENCLOSURE. ROUTE AND TERMINATE ALL VOICE, DATA, & TELEVISION CABLES WITHIN THE RESPECTIVE UNIT HERE (TYPICAL). SEE DETAIL B ON SHEET T2.00.
- HOME RUN ALL COAXIAL CABLES AND CAT6 CABLES TO NEAREST TELECOM ROOM. SEE DETAIL A ON SHEET T2.00.
- HOME RUN ALL COAXIAL CABLES AND CAT6 CABLES TO NEAREST TELECOM ROOM VIA ONE (1)-1" CONDUIT TO THE NEAREST TELECOM ROOM. SEE DETAIL A ON SHEET T2.00 & SHEET

GENERAL NOTES: UNIT PLANS

- G-1. ALL VOICE, DATA, & COAXIAL CABLES SHALL BE HOME RUN FROM EACH OUTLET TO THE STRUCTURED MEDIA CENTER WITHOUT SPLICES.
- G-2. MOUNT DEVICES AT THE SAME HEIGHT AS ELECTRICAL DEVICES (UNLESS OTHERWISE NOTED), ALIGN COVER PLATES. COORDINATE WITH ELECTRICAL.
- G-3. ALL VOICE & DATA CABLING SHALL BE CAT6.

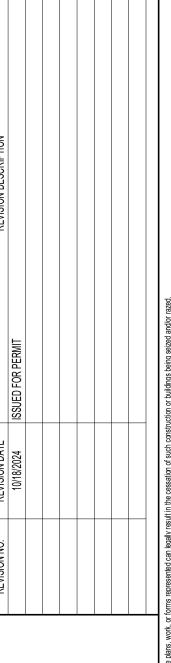


GRANT STREET APARTMENTS
290 E. 17th Ave, Denver, CO 80203
A Development of
Abacus Capital Group


NOT FOR CONSTRUCTION ISSUED FOR PRICING ISSUED FOR PERMIT ISSUED FOR CONSTRUCTION


UNIT PLAN

DRAWING NO. T2.08


Jordan & Skala Engineers
555 17th Street, Suite 700 • Denver, CO 80202
p. 303.586.2375 Checked By: Checker Drawn By: Author

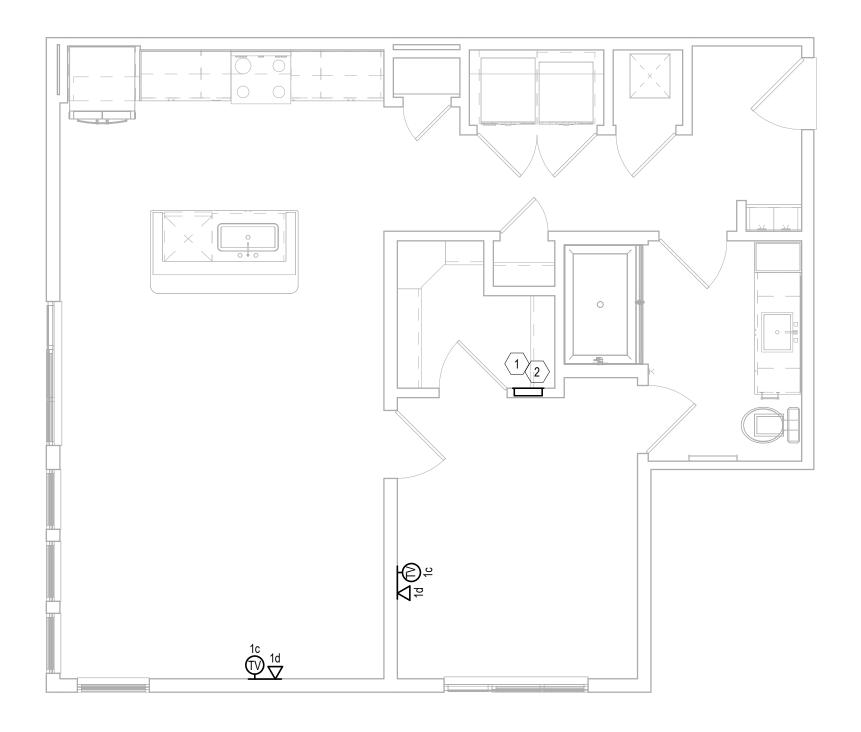

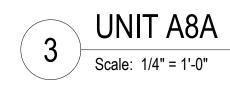

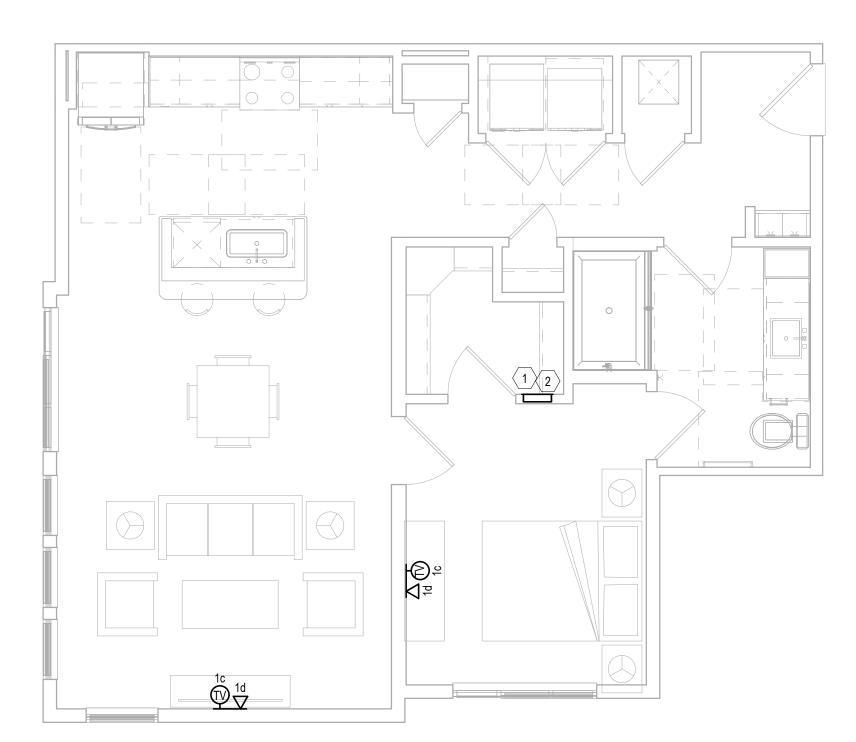



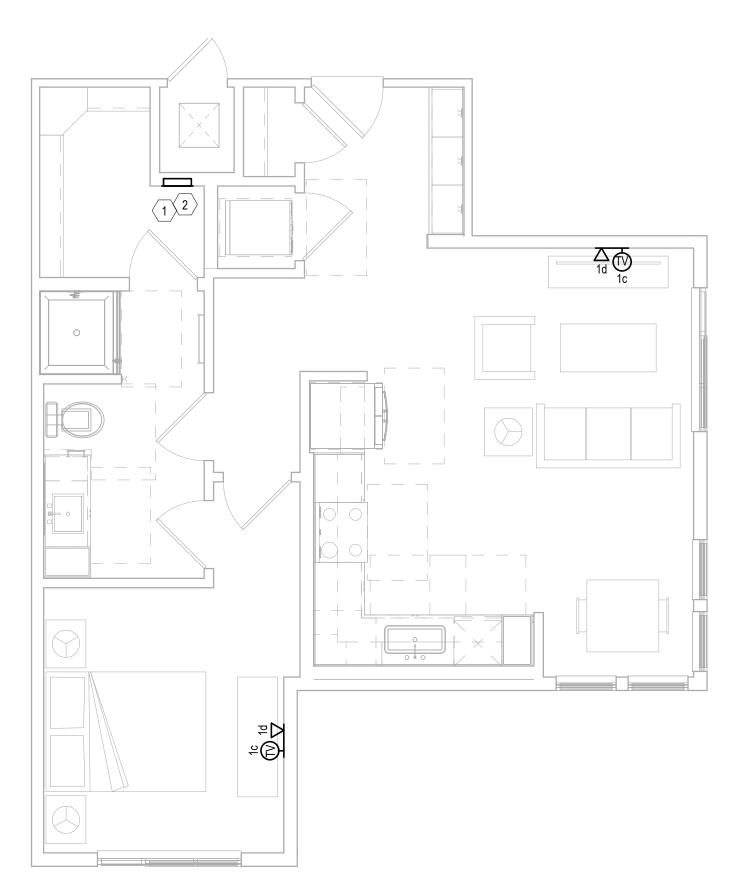


1 UNIT A7
Scale: 1/4" = 1'-0"

KEY NOTES: UNIT PLANS

- STRUCTURED MEDIA ENCLOSURE. ROUTE AND TERMINATE ALL VOICE, DATA, & TELEVISION CABLES WITHIN THE RESPECTIVE UNIT HERE (TYPICAL). SEE DETAIL B ON SHEET T2.00.
- HOME RUN ALL COAXIAL CABLES AND CAT6 CABLES TO NEAREST TELECOM ROOM. SEE DETAIL A ON SHEET T2.00.
- HOME RUN ALL COAXIAL CABLES AND CAT6 CABLES TO NEAREST TELECOM ROOM VIA ONE (1)-1" CONDUIT TO THE NEAREST TELECOM ROOM. SEE DETAIL A ON SHEET T2.00 & SHEET T3.00 FOR EXACT CONDUIT ROUTING.

GENERAL NOTES: UNIT PLANS

- G-1. ALL VOICE, DATA, & COAXIAL CABLES SHALL BE HOME RUN FROM EACH OUTLET TO THE STRUCTURED MEDIA CENTER WITHOUT SPLICES.
- G-2. MOUNT DEVICES AT THE SAME HEIGHT AS ELECTRICAL DEVICES (UNLESS OTHERWISE NOTED), ALIGN COVER PLATES. COORDINATE WITH ELECTRICAL.
- G-3. ALL VOICE & DATA CABLING SHALL BE CAT6.

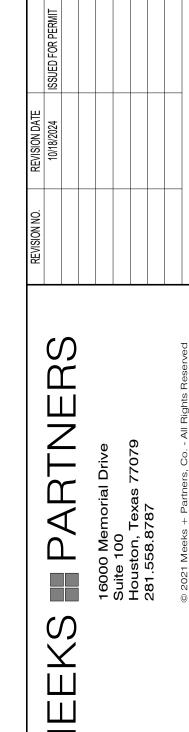

GRANT STREET APARTMENTS
290 E. 17th Ave, Denver, CO 80203
A Development of
Abacus Capital Group

JOB NO.: 22035

X NOT FOR CONSTRUCTION

ISSUED FOR PRICING
ISSUED FOR PERMIT
ISSUED FOR CONSTRUCTION


SHEET TITLE:

UNIT PLAN

T2.09

Checked By: Checker

Drawn By: Author

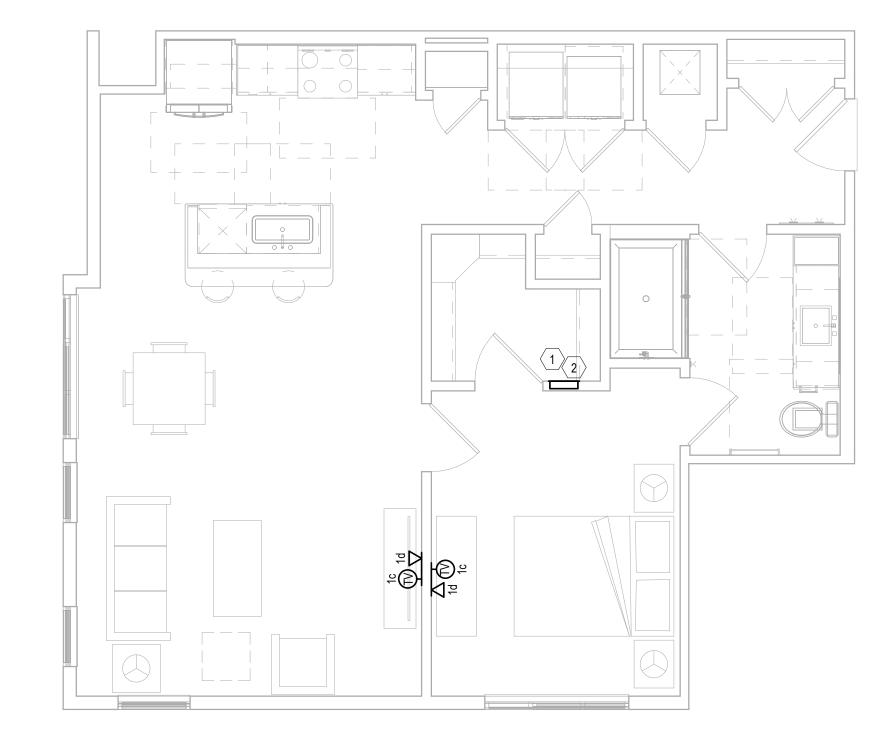



KEY NOTES: UNIT PLANS

STRUCTURED MEDIA ENCLOSURE. ROUTE AND TERMINATE ALL VOICE, DATA, & TELEVISION CABLES WITHIN THE RESPECTIVE UNIT HERE (TYPICAL). SEE DETAIL B ON SHEET T2.00.

HOME RUN ALL COAXIAL CABLES AND CAT6 CABLES TO NEAREST TELECOM ROOM. SEE DETAIL A ON SHEET T2.00.

HOME RUN ALL COAXIAL CABLES AND CAT6 CABLES TO NEAREST TELECOM ROOM VIA ONE (1)-1" CONDUIT TO THE NEAREST TELECOM ROOM. SEE DETAIL A ON SHEET T2.00 & SHEET T3.00 FOR EXACT CONDUIT ROUTING.

GENERAL NOTES: UNIT PLANS

G-1. ALL VOICE, DATA, & COAXIAL CABLES SHALL BE HOME RUN FROM EACH OUTLET TO THE STRUCTURED MEDIA CENTER WITHOUT SPLICES.

G-2. MOUNT DEVICES AT THE SAME HEIGHT AS ELECTRICAL DEVICES (UNLESS OTHERWISE NOTED), ALIGN COVER PLATES. COORDINATE WITH ELECTRICAL.

G-3. ALL VOICE & DATA CABLING SHALL BE CAT6.

MEEKS

GRANT STREET APARTMENTS
290 E. 17th Ave, Denver, CO 80203
A Development of
Abacus Capital Group

NOT FOR CONSTRUCTION


ISSUED FOR PRICING ISSUED FOR PERMIT ISSUED FOR CONSTRUCTION

UNIT PLAN


DRAWING NO. T2.10

Checked By: Checker


Jordan & Skala Engineers
555 17th Street, Suite 700 • Denver, CO 80202
p. 303.586.2375 Drawn By: Author

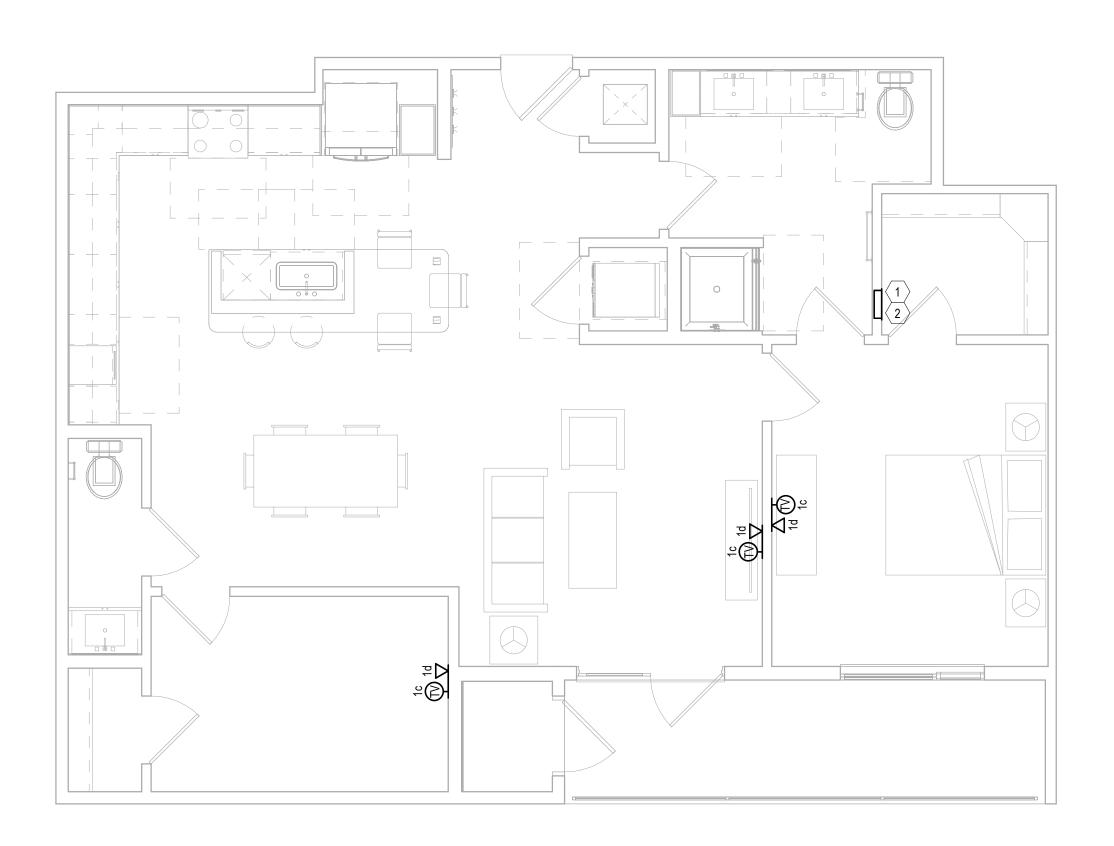


UNIT A10A Scale: 1/4" = 1'-0"

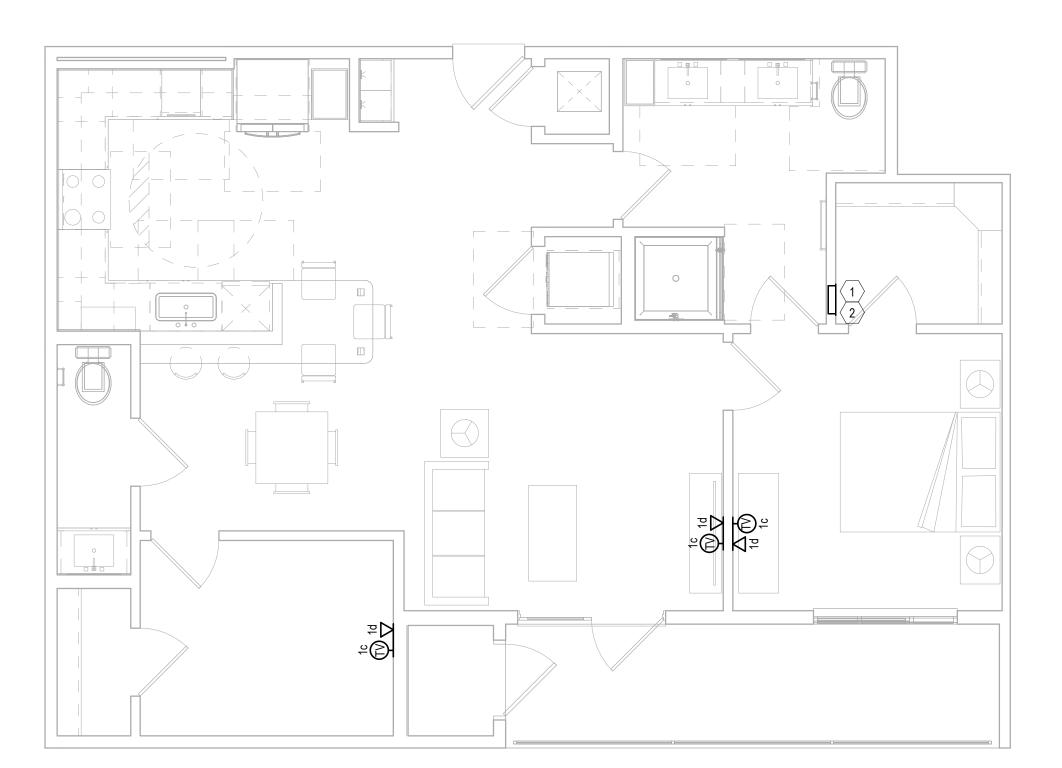


UNIT A10 Scale: 1/4" = 1'-0"

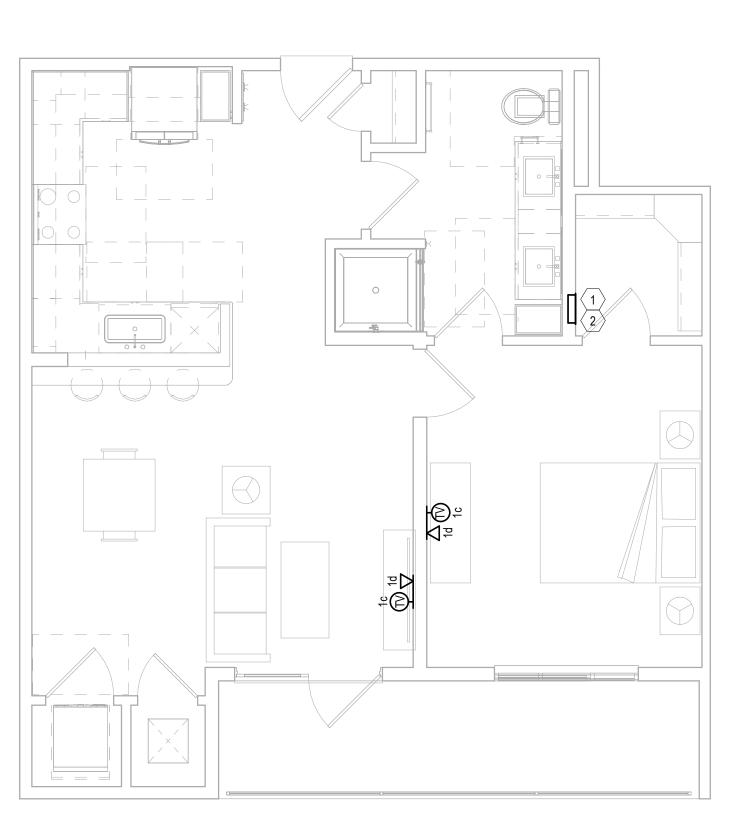

UNIT A11 Scale: 1/4" = 1'-0"

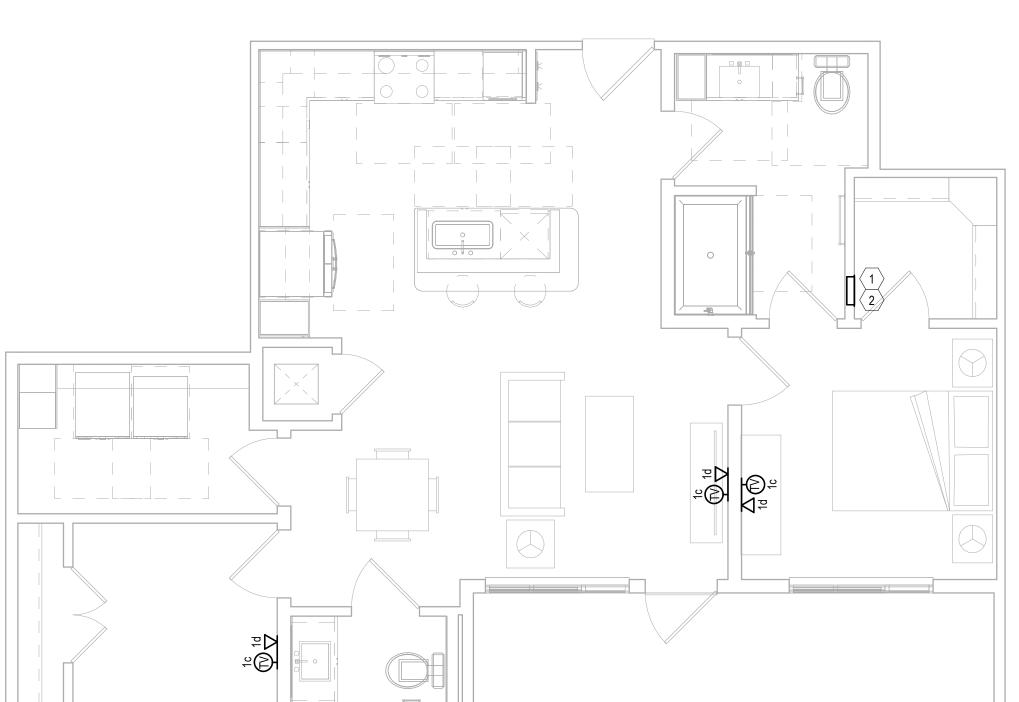


UNIT A9

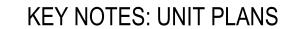

- STRUCTURED MEDIA ENCLOSURE. ROUTE AND TERMINATE ALL VOICE, DATA, & TELEVISION CABLES WITHIN THE RESPECTIVE UNIT HERE (TYPICAL). SEE DETAIL B ON SHEET T2.00.
- HOME RUN ALL COAXIAL CABLES AND CAT6 CABLES TO NEAREST TELECOM ROOM. SEE DETAIL A ON SHEET T2.00.
- HOME RUN ALL COAXIAL CABLES AND CAT6 CABLES TO NEAREST TELECOM ROOM VIA ONE (1)-1" CONDUIT TO THE NEAREST TELECOM ROOM. SEE DETAIL A ON SHEET T2.00 & SHEET T3.00 FOR EXACT CONDUIT ROUTING.

GENERAL NOTES: UNIT PLANS

- G-1. ALL VOICE, DATA, & COAXIAL CABLES SHALL BE HOME RUN FROM EACH OUTLET TO THE STRUCTURED MEDIA CENTER WITHOUT SPLICES.
- G-2. MOUNT DEVICES AT THE SAME HEIGHT AS ELECTRICAL DEVICES (UNLESS OTHERWISE NOTED), ALIGN COVER PLATES. COORDINATE WITH ELECTRICAL.
- G-3. ALL VOICE & DATA CABLING SHALL BE CAT6.

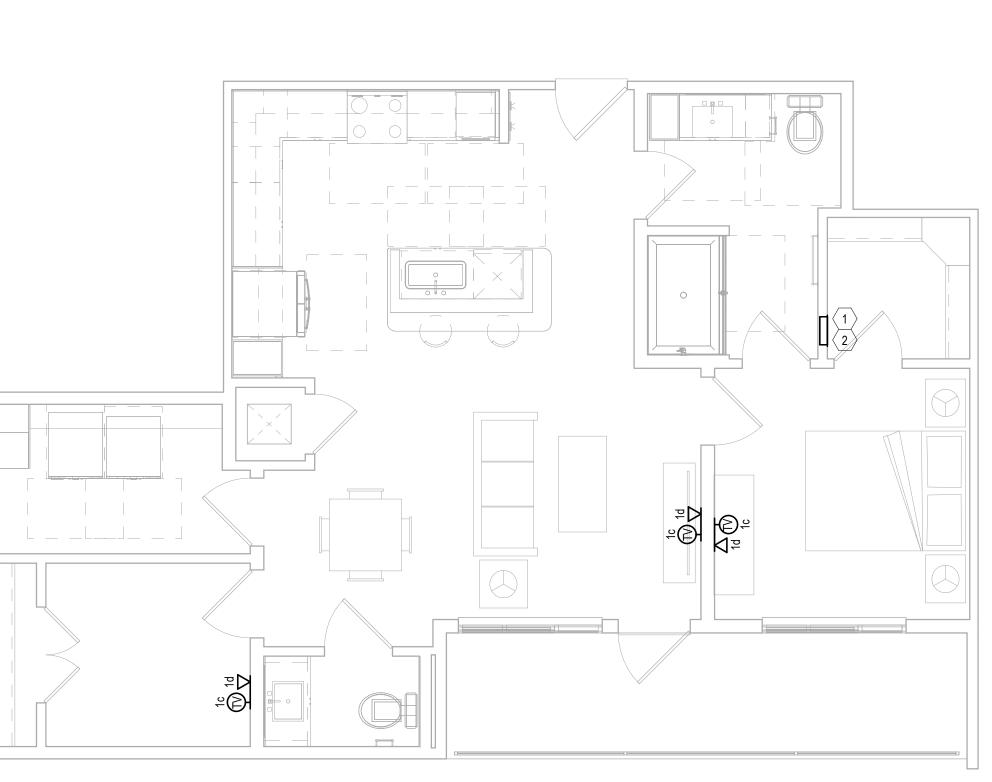

Jordan & Skala Engineers
555 17th Street, Suite 700 • Denver, CO 80202
p. 303.586.2375

DRAWING NO.


NOT FOR CONSTRUCTION ISSUED FOR PRICING ISSUED FOR PERMIT ISSUED FOR CONSTRUCTION

UNIT PLAN

Scale: 1/4" = 1'-0"



UNIT B1 Scale: 1/4" = 1'-0"

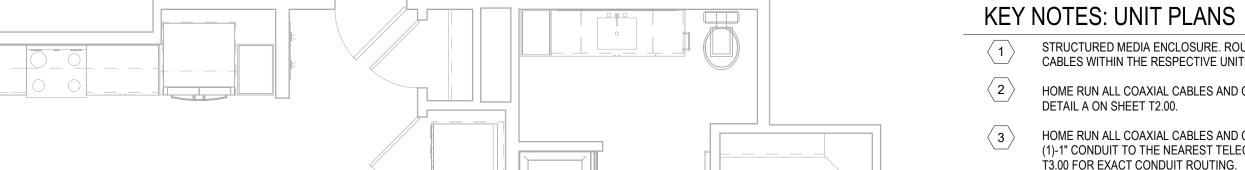

UNIT B2B

1 2

HOME RUN ALL COAXIAL CABLES AND CAT6 CABLES TO NEAREST TELECOM ROOM. SEE DETAIL A ON SHEET T2.00. HOME RUN ALL COAXIAL CABLES AND CAT6 CABLES TO NEAREST TELECOM ROOM VIA ONE (1)-1" CONDUIT TO THE NEAREST TELECOM ROOM. SEE DETAIL A ON SHEET T2.00 & SHEET T3.00 FOR EXACT CONDUIT ROUTING.

GENERAL NOTES: UNIT PLANS

- G-1. ALL VOICE, DATA, & COAXIAL CABLES SHALL BE HOME RUN FROM EACH OUTLET TO THE STRUCTURED MEDIA CENTER WITHOUT SPLICES.
- G-2. MOUNT DEVICES AT THE SAME HEIGHT AS ELECTRICAL DEVICES (UNLESS OTHERWISE NOTED), ALIGN COVER PLATES. COORDINATE WITH ELECTRICAL.

STRUCTURED MEDIA ENCLOSURE. ROUTE AND TERMINATE ALL VOICE, DATA, & TELEVISION CABLES WITHIN THE RESPECTIVE UNIT HERE (TYPICAL). SEE DETAIL B ON SHEET T2.00.

G-3. ALL VOICE & DATA CABLING SHALL BE CAT6.

NOT FOR CONSTRUCTION ISSUED FOR PRICING ISSUED FOR PERMIT ISSUED FOR CONSTRUCTION

UNIT PLAN

DRAWING NO.

UNIT B2 Scale: 1/4" = 1'-0"

Jordan & Skala Engineers
555 17th Street, Suite 700 • Denver, CO 80202
p. 303.586.2375 Checked By: Checker

1 UNIT B2A-TA
Scale: 1/4" = 1'-0"

KEY NOTES: UNIT PLANS

- STRUCTURED MEDIA ENCLOSURE. ROUTE AND TERMINATE ALL VOICE, DATA, & TELEVISION CABLES WITHIN THE RESPECTIVE UNIT HERE (TYPICAL). SEE DETAIL B ON SHEET T2.00.
- HOME RUN ALL COAXIAL CABLES AND CAT6 CABLES TO NEAREST TELECOM ROOM. SEE DETAIL A ON SHEET T2.00.
- HOME RUN ALL COAXIAL CABLES AND CAT6 CABLES TO NEAREST TELECOM ROOM VIA ONE (1)-1" CONDUIT TO THE NEAREST TELECOM ROOM. SEE DETAIL A ON SHEET T2.00 & SHEET T3.00 FOR EXACT CONDUIT ROUTING.

GENERAL NOTES: UNIT PLANS

- G-1. ALL VOICE, DATA, & COAXIAL CABLES SHALL BE HOME RUN FROM EACH OUTLET TO THE STRUCTURED MEDIA CENTER WITHOUT SPLICES.
- G-2. MOUNT DEVICES AT THE SAME HEIGHT AS ELECTRICAL DEVICES (UNLESS OTHERWISE NOTED), ALIGN COVER PLATES. COORDINATE WITH ELECTRICAL.
- G-3. ALL VOICE & DATA CABLING SHALL BE CAT6.



VERSION NO. REVISION DATE REVISION DESCRIPTION 10/18/2024 ISSUED FOR PERMIT REVISION DESCRIPTION All Rights Reserved

MEEKS PARTNE
16000 Memorial Drive
Suite 100
Houston, Texas 77079
281.558.8787

GRANT STREET APARTMENTS
290 E. 17th Ave, Denver, CO 80203
A Development of
Abacus Capital Group

JOB NO.: 22035

X NOT FOR CONSTRUCTION

ISSUED FOR PRICING


ISSUED FOR PERMIT

ISSUED FOR CONSTRUCTION

UNIT PLAN

 $\begin{array}{c} \text{DRAWING NO.} \\ \textbf{T2.13} \end{array}$

Scale: 1/4" = 1'-0"

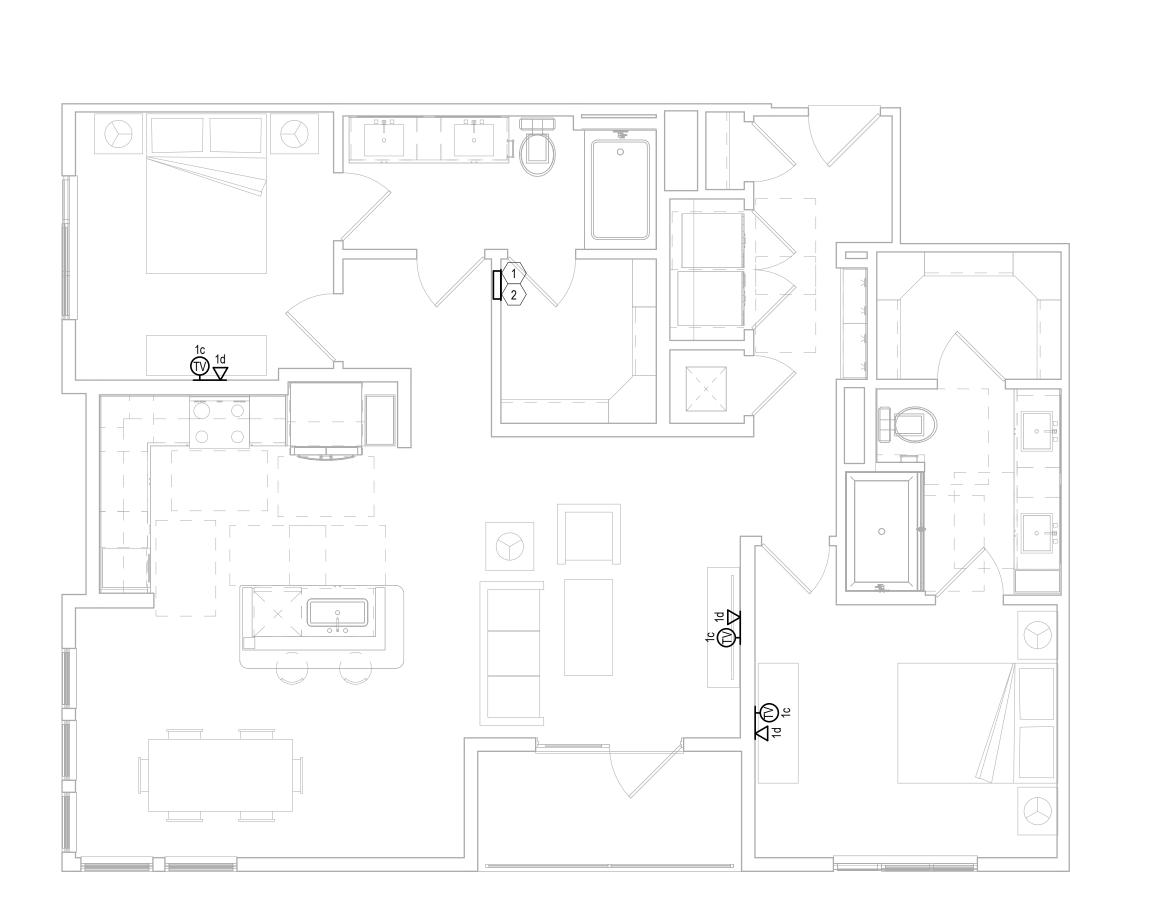

UNIT B3

Scale: 1/4" = 1'-0"

Jordan & Skala Engineers

555 17th Street, Suite 700 • Denver, CO 80202
p. 303.586.2375

KEY NOTES: UNIT PLANS

STRUCTURED MEDIA ENCLOSURE. ROUTE AND TERMINATE ALL VOICE, DATA, & TELEVISION CABLES WITHIN THE RESPECTIVE LIMIT HERE (TYPICAL). SEE DETAIL BON SHEET TO 00 CABLES WITHIN THE RESPECTIVE UNIT HERE (TYPICAL). SEE DETAIL B ON SHEET T2.00.

HOME RUN ALL COAXIAL CABLES AND CAT6 CABLES TO NEAREST TELECOM ROOM. SEE DETAIL A ON SHEET T2.00.

HOME RUN ALL COAXIAL CABLES AND CAT6 CABLES TO NEAREST TELECOM ROOM VIA ONE (1)-1" CONDUIT TO THE NEAREST TELECOM ROOM. SEE DETAIL A ON SHEET T2.00 & SHEET T3.00 FOR EXACT CONDUIT ROUTING.

GENERAL NOTES: UNIT PLANS

G-1. ALL VOICE, DATA, & COAXIAL CABLES SHALL BE HOME RUN FROM EACH OUTLET TO THE STRUCTURED MEDIA CENTER WITHOUT SPLICES.

G-2. MOUNT DEVICES AT THE SAME HEIGHT AS ELECTRICAL DEVICES (UNLESS OTHERWISE NOTED), ALIGN COVER PLATES. COORDINATE WITH ELECTRICAL.

G-3. ALL VOICE & DATA CABLING SHALL BE CAT6.

NOT FOR CONSTRUCTION

ISSUED FOR PRICING ISSUED FOR PERMIT ISSUED FOR CONSTRUCTION

UNIT PLAN

DRAWING NO.

- STRUCTURED MEDIA ENCLOSURE. ROUTE AND TERMINATE ALL VOICE, DATA, & TELEVISION CABLES WITHIN THE RESPECTIVE UNIT HERE (TYPICAL). SEE DETAIL B ON SHEET T2.00.
- HOME RUN ALL COAXIAL CABLES AND CAT6 CABLES TO NEAREST TELECOM ROOM. SEE DETAIL A ON SHEET T2.00.
- HOME RUN ALL COAXIAL CABLES AND CAT6 CABLES TO NEAREST TELECOM ROOM VIA ONE (1)-1" CONDUIT TO THE NEAREST TELECOM ROOM. SEE DETAIL A ON SHEET T2.00 & SHEET T3.00 FOR EXACT CONDUIT ROUTING.

GENERAL NOTES: UNIT PLANS

- G-1. ALL VOICE, DATA, & COAXIAL CABLES SHALL BE HOME RUN FROM EACH OUTLET TO THE STRUCTURED MEDIA CENTER WITHOUT SPLICES.
- G-2. MOUNT DEVICES AT THE SAME HEIGHT AS ELECTRICAL DEVICES (UNLESS OTHERWISE NOTED), ALIGN COVER PLATES. COORDINATE WITH ELECTRICAL.
- G-3. ALL VOICE & DATA CABLING SHALL BE CAT6.

NOT FOR CONSTRUCTION


ISSUED FOR PRICING ISSUED FOR PERMIT ISSUED FOR CONSTRUCTION

UNIT PLAN


DRAWING NO.


UNIT B3C

UNIT B3B

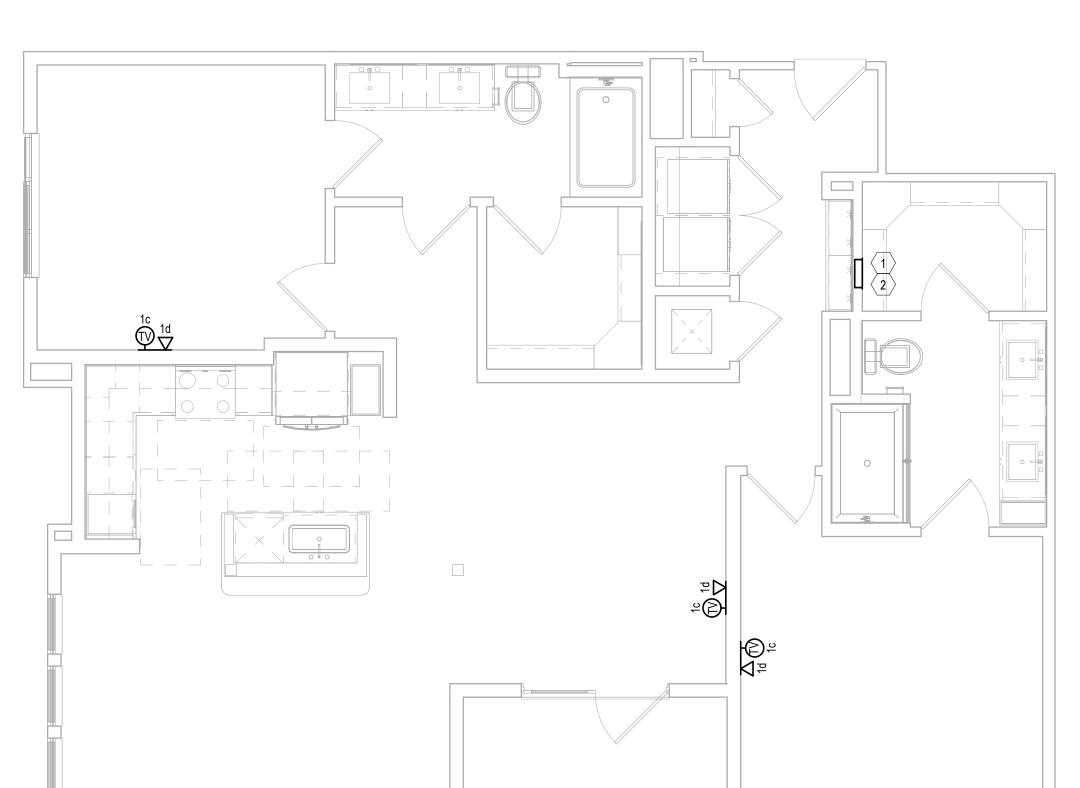

Jordan & Skala Engineers
555 17th Street, Suite 700 • Denver, CO 80202
p. 303.586.2375

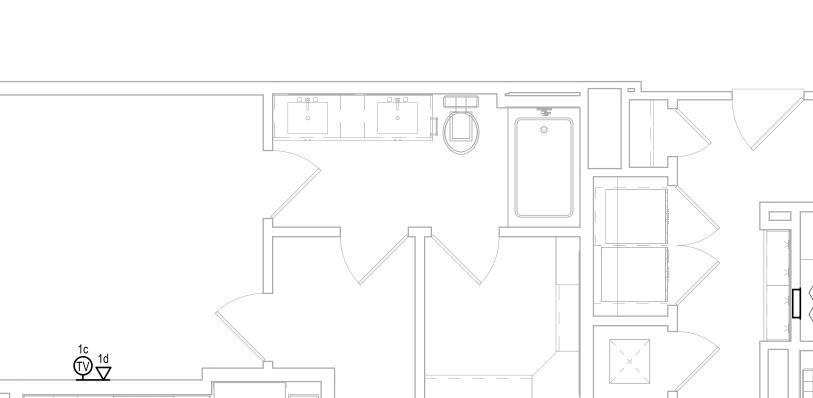

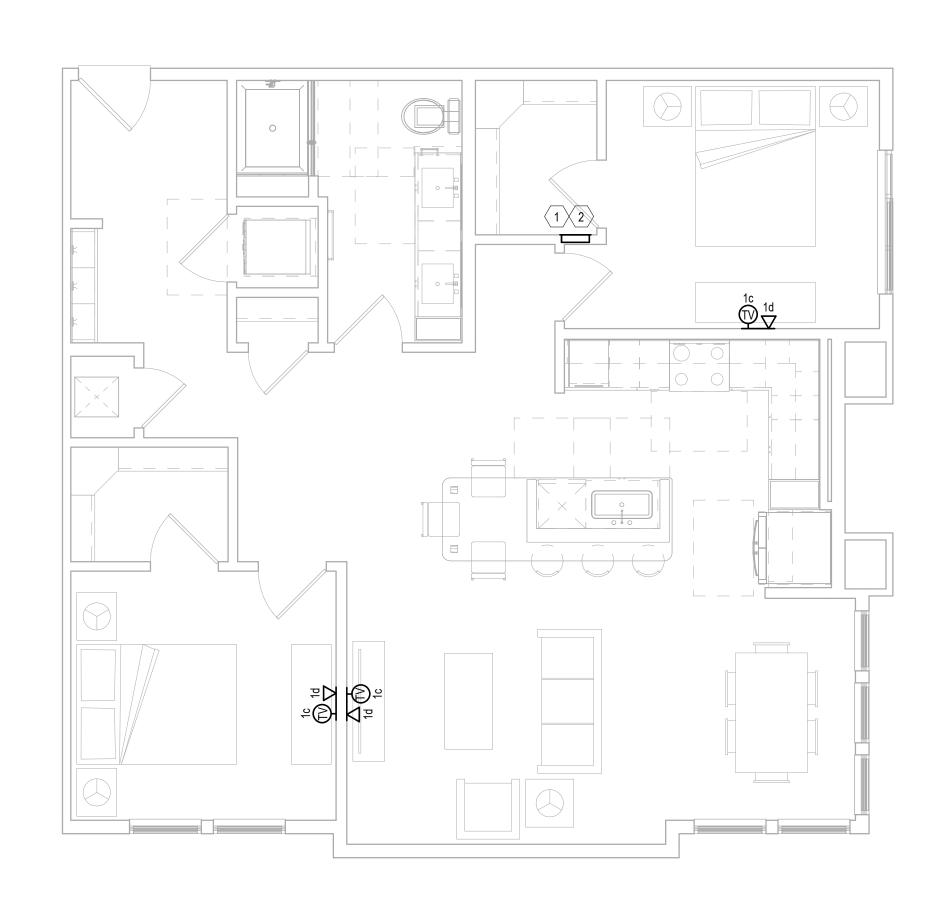

Units-T - B7




Scale: 1/4" = 1'-0"



Units-T - B6

Scale: 1/4" = 1'-0"

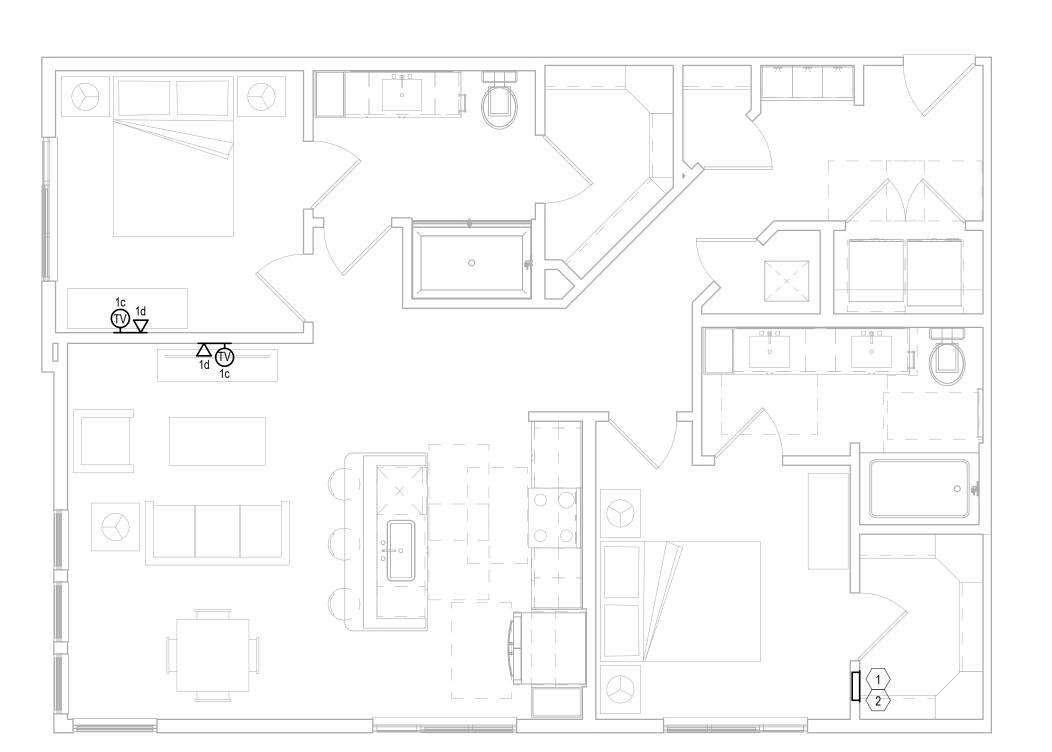


Units-T - B5

KEY NOTES: UNIT PLANS

- STRUCTURED MEDIA ENCLOSURE. ROUTE AND TERMINATE ALL VOICE, DATA, & TELEVISION CABLES WITHIN THE RESPECTIVE UNIT HERE (TYPICAL). SEE DETAIL B ON SHEET T2.00.
- HOME RUN ALL COAXIAL CABLES AND CAT6 CABLES TO NEAREST TELECOM ROOM. SEE DETAIL A ON SHEET T2.00.
- HOME RUN ALL COAXIAL CABLES AND CAT6 CABLES TO NEAREST TELECOM ROOM VIA ONE (1)-1" CONDUIT TO THE NEAREST TELECOM ROOM. SEE DETAIL A ON SHEET T2.00 & SHEET T3.00 FOR EXACT CONDUIT ROUTING.

GENERAL NOTES: UNIT PLANS

- G-1. ALL VOICE, DATA, & COAXIAL CABLES SHALL BE HOME RUN FROM EACH OUTLET TO THE STRUCTURED MEDIA CENTER WITHOUT SPLICES.
- G-2. MOUNT DEVICES AT THE SAME HEIGHT AS ELECTRICAL DEVICES (UNLESS OTHERWISE NOTED), ALIGN COVER PLATES. COORDINATE WITH ELECTRICAL.
- G-3. ALL VOICE & DATA CABLING SHALL BE CAT6.

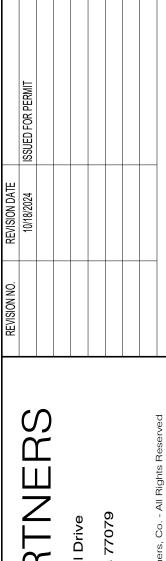


NOT FOR CONSTRUCTION ISSUED FOR PRICING ISSUED FOR PERMIT ISSUED FOR CONSTRUCTION

UNIT PLAN

Jordan & Skala Engineers

555 17th Street, Suite 700 • Denver, CO 80202
p. 303.586.2375 DRAWING NO. T2.16

1c 1d V

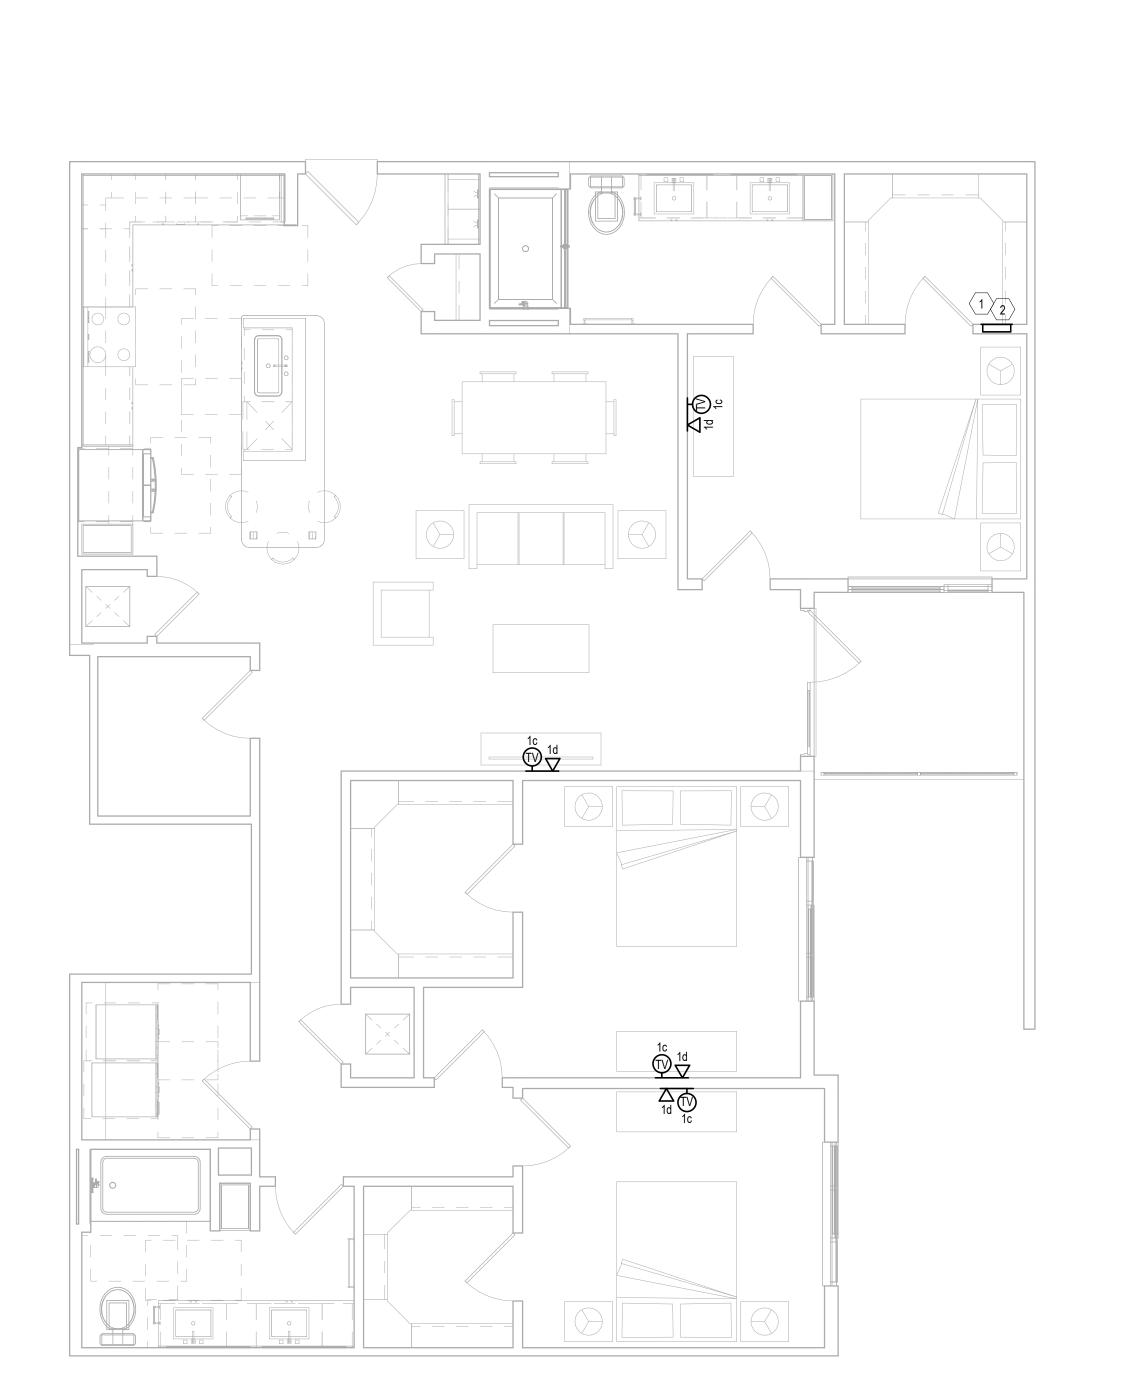

Units-T - C1
Scale: 1/4" = 1'-0"

KEY NOTES: UNIT PLANS

STRUCTURED MEDIA ENCLOSURE. ROUTE AND TERMINATE ALL VOICE, DATA, & TELEVISION CABLES WITHIN THE RESPECTIVE UNIT HERE (TYPICAL). SEE DETAIL B ON SHEET T2.00.

HOME RUN ALL COAXIAL CABLES AND CAT6 CABLES TO NEAREST TELECOM ROOM. SEE DETAIL A ON SHEET T2.00.

HOME RUN ALL COAXIAL CABLES AND CAT6 CABLES TO NEAREST TELECOM ROOM VIA ONE (1)-1" CONDUIT TO THE NEAREST TELECOM ROOM. SEE DETAIL A ON SHEET T2.00 & SHEET T3.00 FOR EXACT CONDUIT ROUTING.

GENERAL NOTES: UNIT PLANS

G-1. ALL VOICE, DATA, & COAXIAL CABLES SHALL BE HOME RUN FROM EACH OUTLET TO THE STRUCTURED MEDIA CENTER WITHOUT SPLICES.

G-2. MOUNT DEVICES AT THE SAME HEIGHT AS ELECTRICAL DEVICES (UNLESS OTHERWISE NOTED), ALIGN COVER PLATES. COORDINATE WITH ELECTRICAL.

G-3. ALL VOICE & DATA CABLING SHALL BE CAT6.

Jordan & Skala Engineers

555 17th Street, Suite 700 • Denver, CO 80202
p. 303.586.2375

DRAWING NO.


UNIT PLAN


NOT FOR CONSTRUCTION ISSUED FOR PRICING ISSUED FOR PERMIT

ISSUED FOR CONSTRUCTION


GRANT STREET APARTMENTS
290 E. 17th Ave, Denver, CO 80203
A Development of
Abacus Capital Group

Checked By: Checker

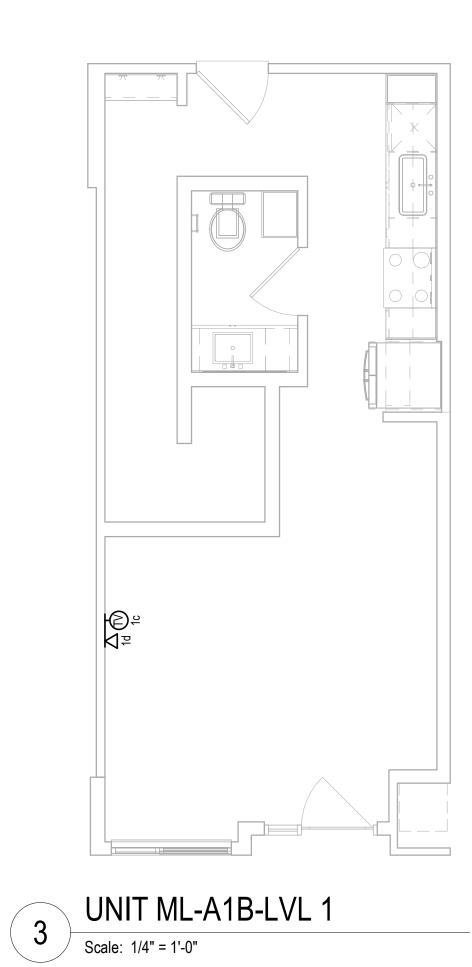


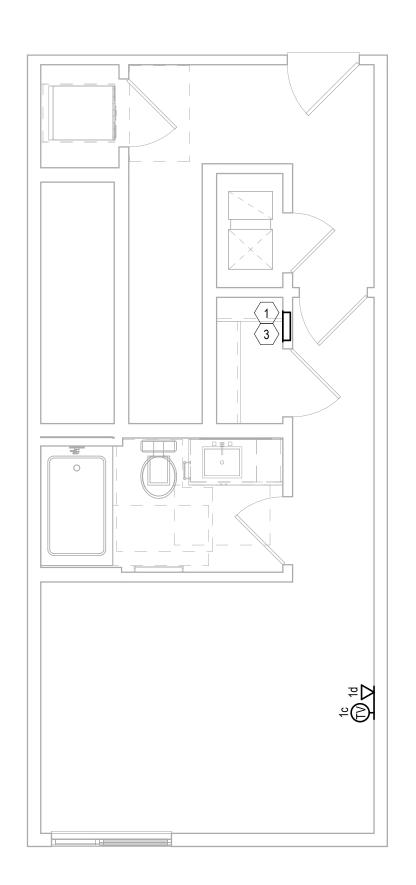


UNIT ML-A1A-LVL 2 Scale: 1/4" = 1'-0"

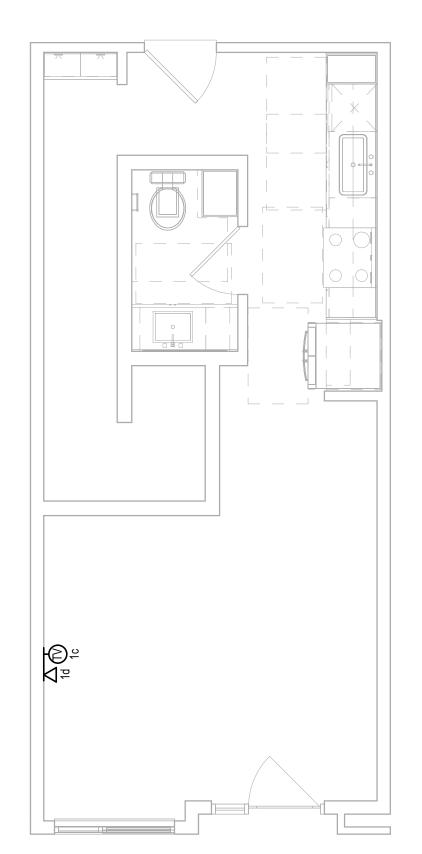

UNIT ML-A1A-LVL 1 Scale: 1/4" = 1'-0"

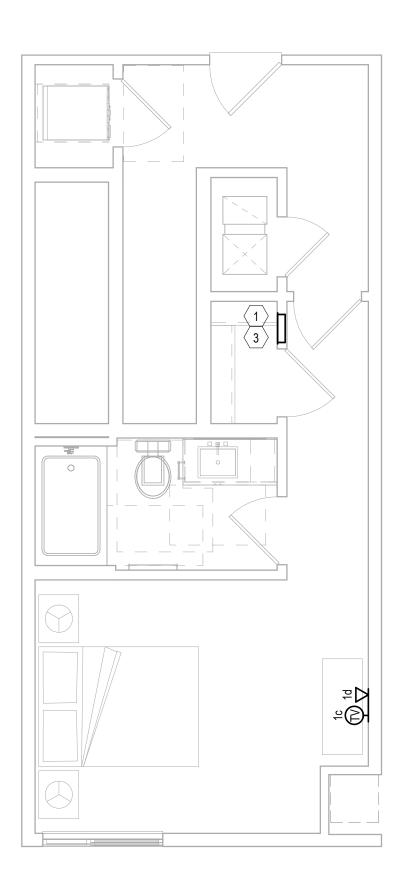

UNIT ML-A1-LVL 2 Scale: 1/4" = 1'-0"

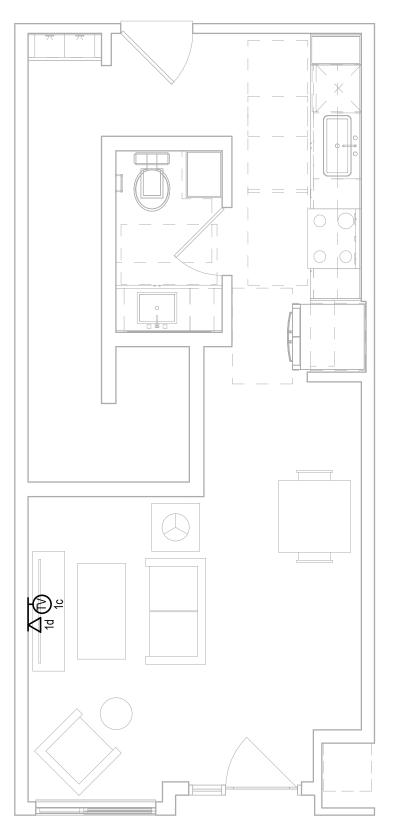

UNIT ML-A1-LVL 1 Scale: 1/4" = 1'-0"

KEY NOTES: UNIT PLANS

- STRUCTURED MEDIA ENCLOSURE. ROUTE AND TERMINATE ALL VOICE, DATA, & TELEVISION CABLES WITHIN THE RESPECTIVE UNIT HERE (TYPICAL). SEE DETAIL B ON SHEET T2.00.
- HOME RUN ALL COAXIAL CABLES AND CAT6 CABLES TO NEAREST TELECOM ROOM. SEE DETAIL A ON SHEET T2.00.
- HOME RUN ALL COAXIAL CABLES AND CAT6 CABLES TO NEAREST TELECOM ROOM VIA ONE (1)-1" CONDUIT TO THE NEAREST TELECOM ROOM. SEE DETAIL A ON SHEET T2.00 & SHEET T3.00 FOR EXACT CONDUIT ROUTING.

GENERAL NOTES: UNIT PLANS

- G-1. ALL VOICE, DATA, & COAXIAL CABLES SHALL BE HOME RUN FROM EACH OUTLET TO THE STRUCTURED MEDIA CENTER WITHOUT SPLICES.
- G-2. MOUNT DEVICES AT THE SAME HEIGHT AS ELECTRICAL DEVICES (UNLESS OTHERWISE NOTED), ALIGN COVER PLATES. COORDINATE WITH ELECTRICAL.
- G-3. ALL VOICE & DATA CABLING SHALL BE CAT6.




NOT FOR CONSTRUCTION ISSUED FOR PRICING ISSUED FOR PERMIT ISSUED FOR CONSTRUCTION

UNIT PLAN


DRAWING NO. T2.18


UNIT ML-A2A-LVL 2

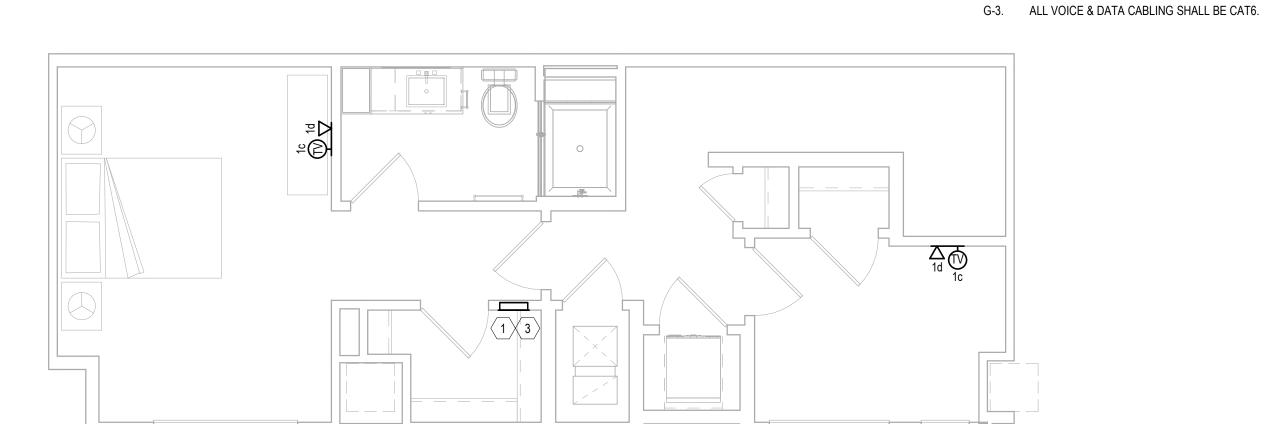

UNIT ML-A2-LVL 2

Scale: 1/4" = 1'-0"

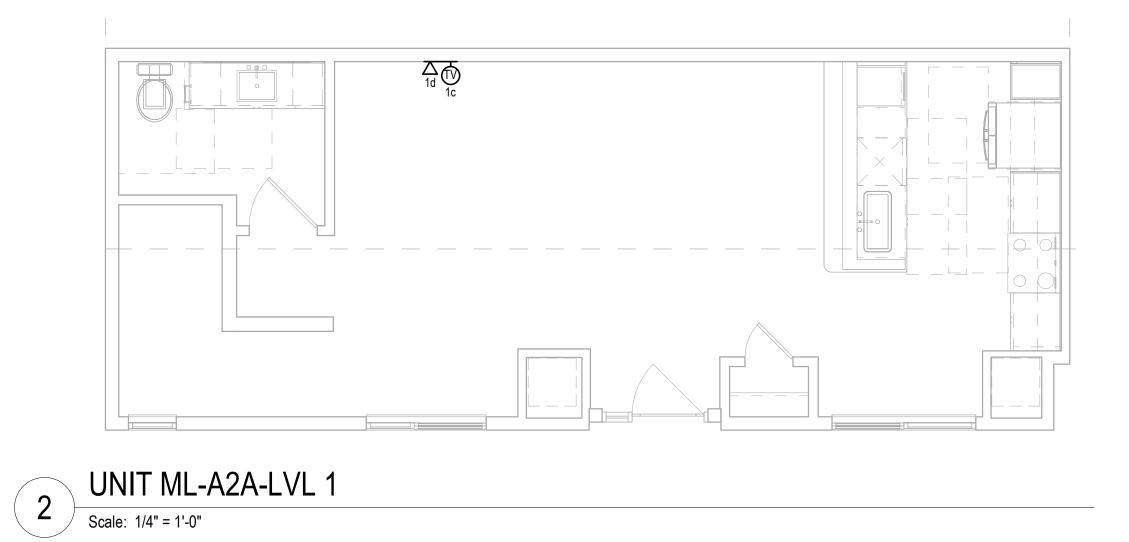

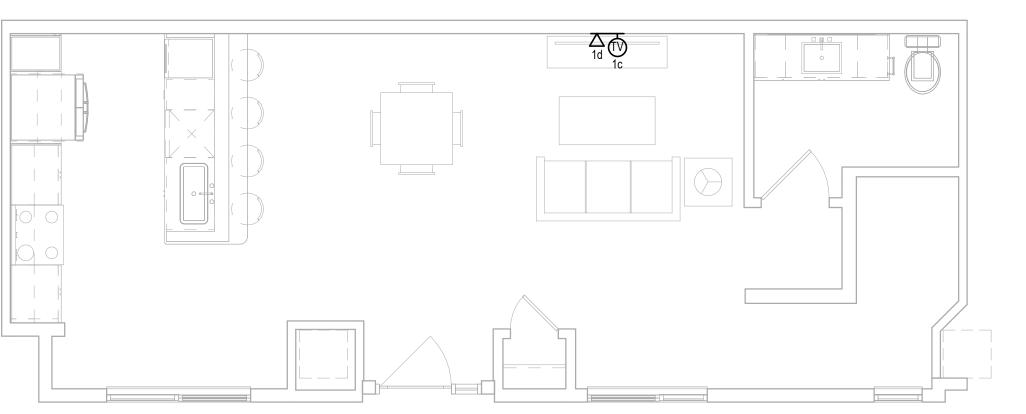

UNIT ML-A2-LVL 1 Scale: 1/4" = 1'-0"

Jordan & Skala Engineers

555 17th Street, Suite 700 • Denver, CO 80202
p. 303.586.2375

KEY NOTES: UNIT PLANS

GENERAL NOTES: UNIT PLANS

STRUCTURED MEDIA ENCLOSURE. ROUTE AND TERMINATE ALL VOICE, DATA, & TELEVISION CABLES WITHIN THE RESPECTIVE UNIT HERE (TYPICAL). SEE DETAIL B ON SHEET T2.00.

HOME RUN ALL COAXIAL CABLES AND CAT6 CABLES TO NEAREST TELECOM ROOM. SEE DETAIL A ON SHEET T2.00.

HOME RUN ALL COAXIAL CABLES AND CAT6 CABLES TO NEAREST TELECOM ROOM VIA ONE (1)-1" CONDUIT TO THE NEAREST TELECOM ROOM. SEE DETAIL A ON SHEET T2.00 & SHEET T3.00 FOR EXACT CONDUIT ROUTING.


G-1. ALL VOICE, DATA, & COAXIAL CABLES SHALL BE HOME RUN FROM EACH OUTLET TO THE STRUCTURED MEDIA CENTER WITHOUT SPLICES.

G-2. MOUNT DEVICES AT THE SAME HEIGHT AS ELECTRICAL DEVICES (UNLESS OTHERWISE NOTED), ALIGN COVER PLATES. COORDINATE WITH ELECTRICAL.


NOT FOR CONSTRUCTION ISSUED FOR PRICING ISSUED FOR PERMIT ISSUED FOR CONSTRUCTION

UNIT PLAN


DRAWING NO.

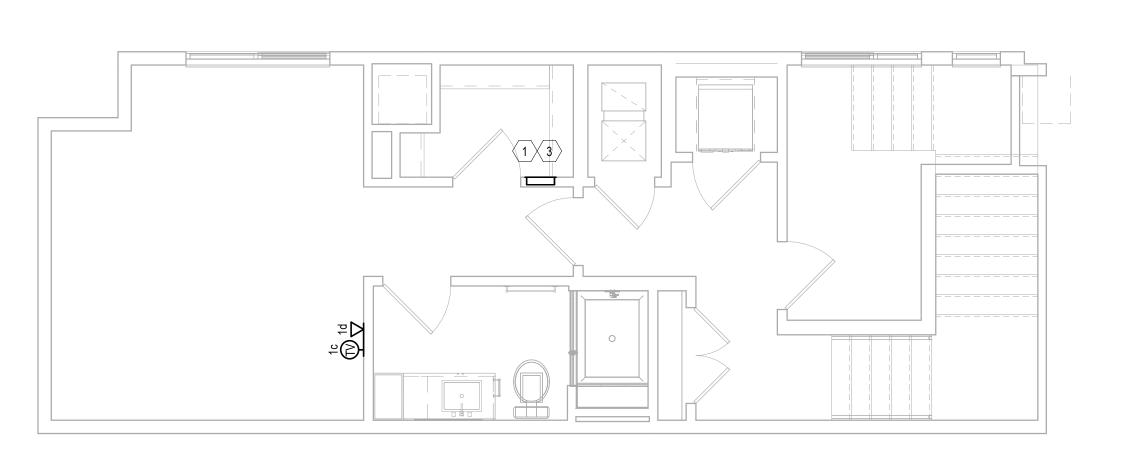


UNIT ML-A2D-LVL 2

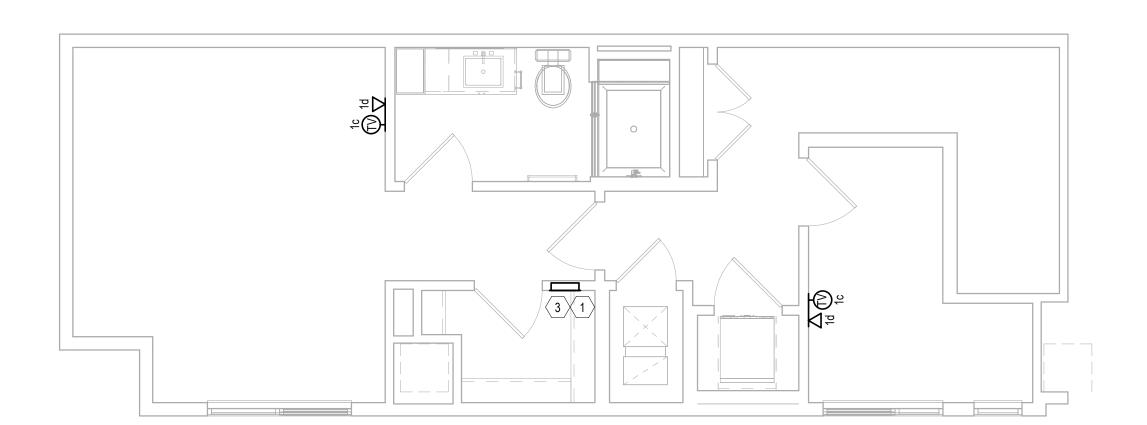


4 UNIT ML-A2C-LVL 2
Scale: 1/4" = 1'-0"

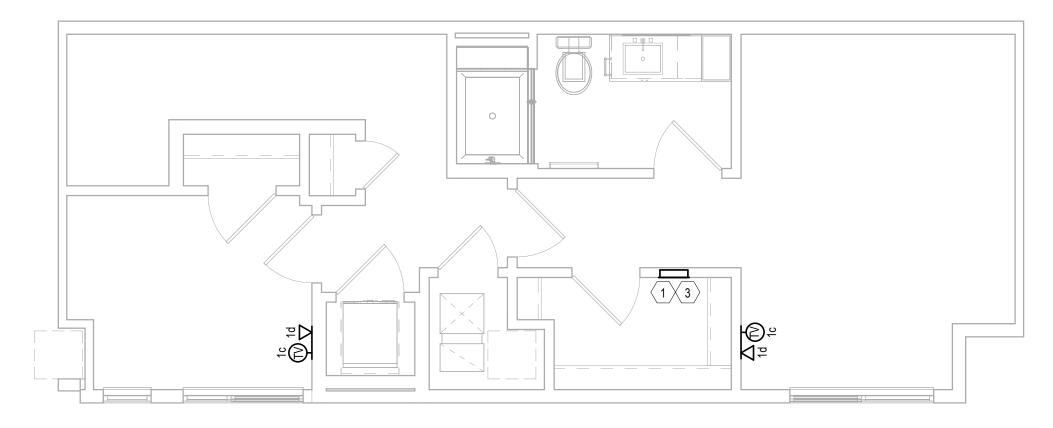


2 UNIT ML-A2B-LVL 2

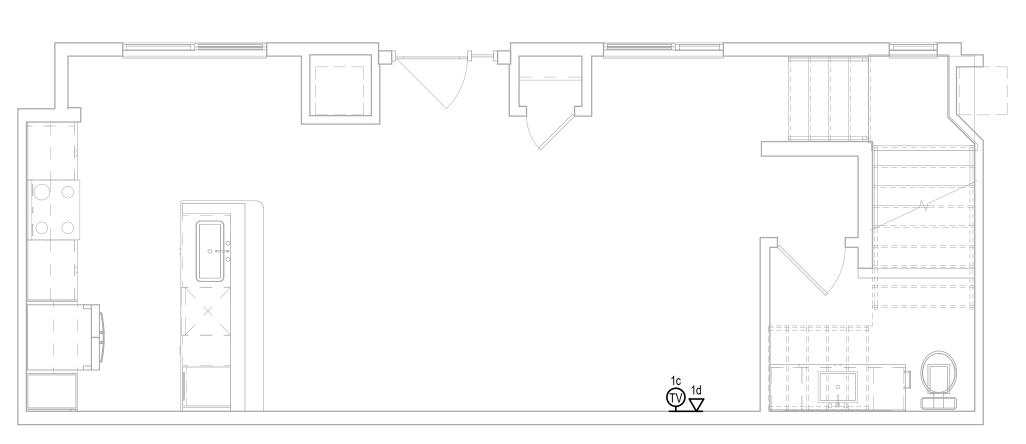

6 UNIT ML-A2D-LVL 1

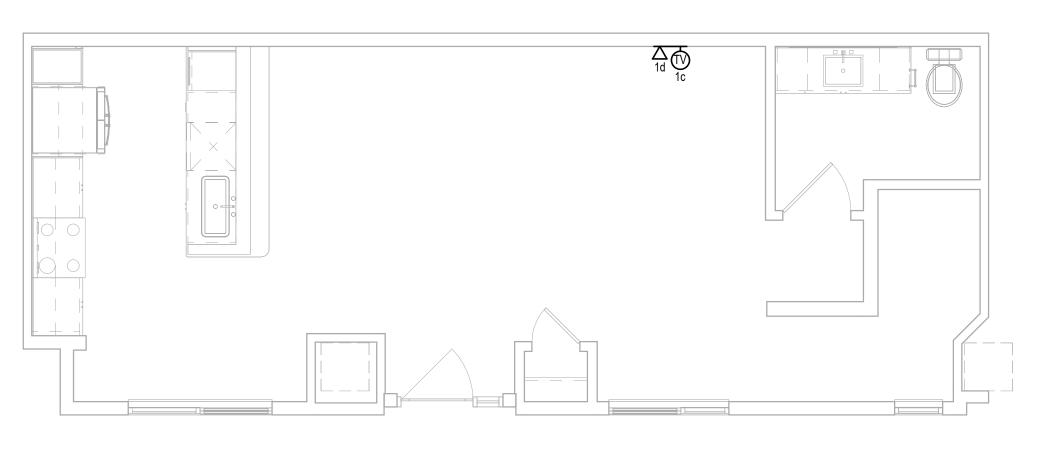

3 UNIT ML-A2C-LVL 1
Scale: 1/4" = 1'-0"

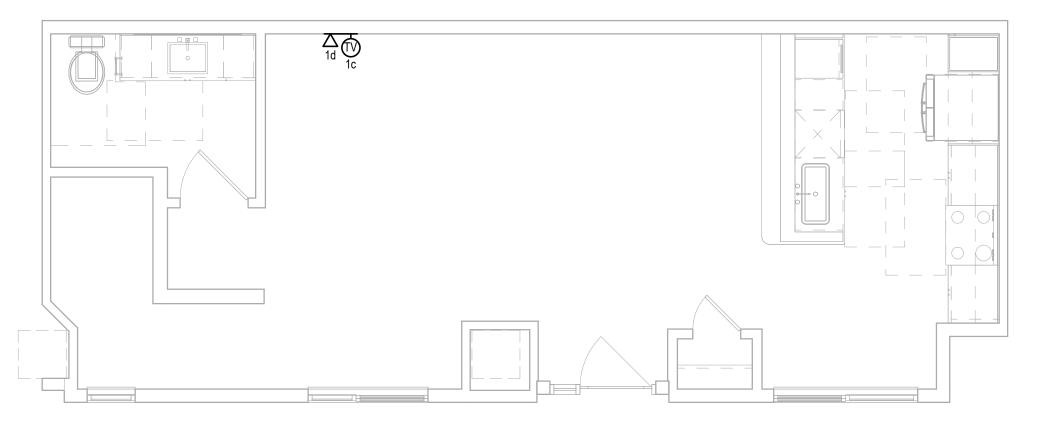

1 UNIT ML-A2B-LVL 1
Scale: 1/4" = 1'-0"

KEY NOTES: UNIT PLANS

- STRUCTURED MEDIA ENCLOSURE. ROUTE AND TERMINATE ALL VOICE, DATA, & TELEVISION CABLES WITHIN THE RESPECTIVE UNIT HERE (TYPICAL). SEE DETAIL B ON SHEET T2.00.
- HOME RUN ALL COAXIAL CABLES AND CAT6 CABLES TO NEAREST TELECOM ROOM. SEE DETAIL A ON SHEET T2.00.
- HOME RUN ALL COAXIAL CABLES AND CAT6 CABLES TO NEAREST TELECOM ROOM VIA ONE (1)-1" CONDUIT TO THE NEAREST TELECOM ROOM. SEE DETAIL A ON SHEET T2.00 & SHEET T3.00 FOR EXACT CONDUIT ROUTING.

GENERAL NOTES: UNIT PLANS

- G-1. ALL VOICE, DATA, & COAXIAL CABLES SHALL BE HOME RUN FROM EACH OUTLET TO THE STRUCTURED MEDIA CENTER WITHOUT SPLICES.
- G-2. MOUNT DEVICES AT THE SAME HEIGHT AS ELECTRICAL DEVICES (UNLESS OTHERWISE NOTED), ALIGN COVER PLATES. COORDINATE WITH ELECTRICAL.
- G-3. ALL VOICE & DATA CABLING SHALL BE CAT6.

REVISION NO. REVISION DATE 10/18/2024 ISSUED FOR PERMIT

IEEKS PARTNERS
16000 Memorial Drive
Suite 100
Houston, Texas 77079
281.558.8787

STREET APARTMENTS
th Ave, Denver, CO 80203

GRANT STREET A
290 E. 17th Ave, Der
A Developn

JOB NO.: 22035

X NOT FOR CONSTRUCTION

ISSUED FOR PRICING
ISSUED FOR PERMIT
ISSUED FOR CONSTRUCTION


UNIT PLAN


T2.20


Jordan & Skala Engineers

555 17th Street, Suite 700 • Denver, CO 80202
p. 303.586.2375

Project Number: 23080076 Drawn By: Author Checked By: Checker

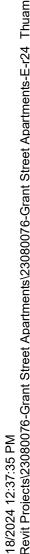

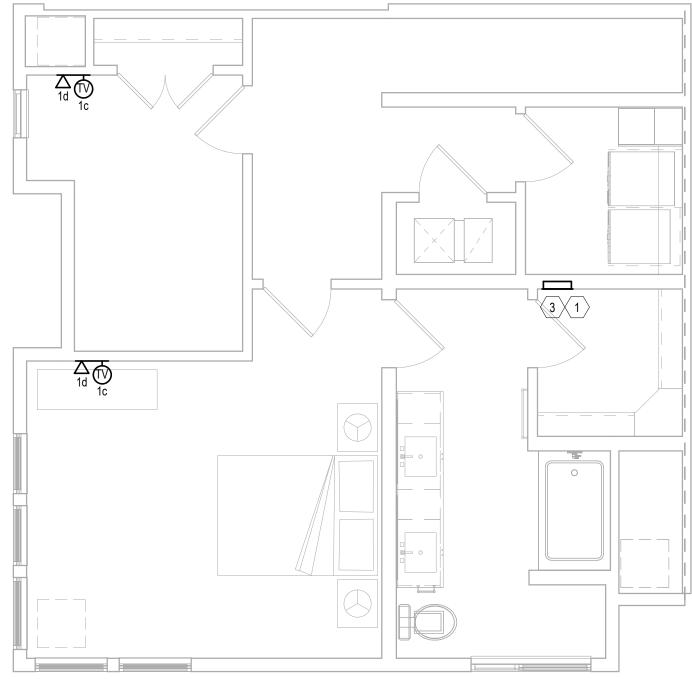

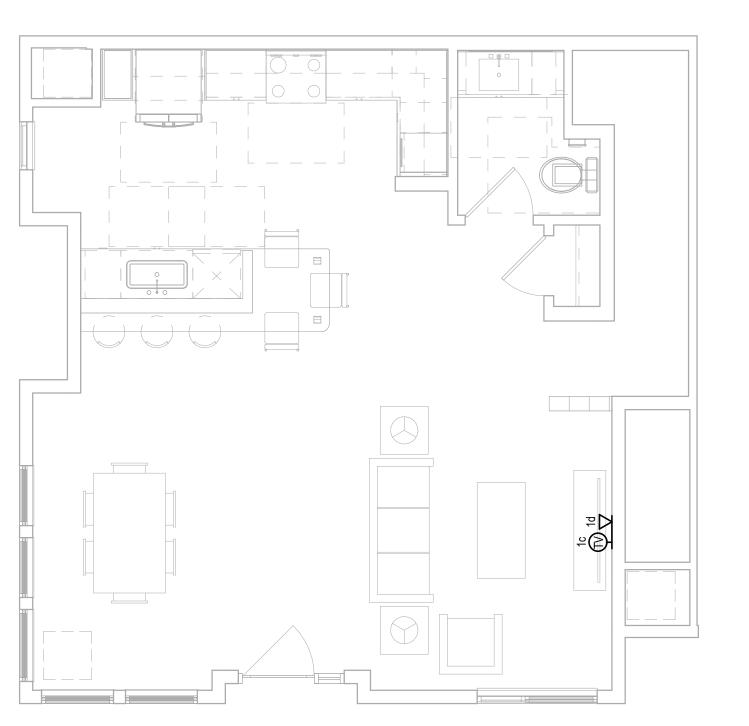

UNIT ML-A3-LVL 1
Scale: 1/4" = 1'-0"

KEY NOTES: UNIT PLANS

STRUCTURED MEDIA ENCLOSURE. ROUTE AND TERMINATE ALL VOICE, DATA, & TELEVISION CABLES WITHIN THE RESPECTIVE UNIT HERE (TYPICAL). SEE DETAIL B ON SHEET 12.00 CABLES WITHIN THE RESPECTIVE UNIT HERE (TYPICAL). SEE DETAIL B ON SHEET T2.00.

HOME RUN ALL COAXIAL CABLES AND CAT6 CABLES TO NEAREST TELECOM ROOM. SEE DETAIL A ON SHEET T2.00.

HOME RUN ALL COAXIAL CABLES AND CAT6 CABLES TO NEAREST TELECOM ROOM VIA ONE (1)-1" CONDUIT TO THE NEAREST TELECOM ROOM. SEE DETAIL A ON SHEET T2.00 & SHEET T3.00 FOR EXACT CONDUIT ROUTING.

GENERAL NOTES: UNIT PLANS

G-1. ALL VOICE, DATA, & COAXIAL CABLES SHALL BE HOME RUN FROM EACH OUTLET TO THE STRUCTURED MEDIA CENTER WITHOUT SPLICES.

G-2. MOUNT DEVICES AT THE SAME HEIGHT AS ELECTRICAL DEVICES (UNLESS OTHERWISE NOTED), ALIGN COVER PLATES. COORDINATE WITH ELECTRICAL.

G-3. ALL VOICE & DATA CABLING SHALL BE CAT6.

GRANT STREET APARTMENTS
290 E. 17th Ave, Denver, CO 80203
A Development of
Abacus Capital Group

NOT FOR CONSTRUCTION ISSUED FOR PRICING ISSUED FOR PERMIT ISSUED FOR CONSTRUCTION


UNIT PLAN

DRAWING NO.

Jordan & Skala Engineers
555 17th Street, Suite 700 • Denver, CO 80202
p. 303.586.2375 Checked By: Checker

Drawn By: Author

2 UNIT ML-B1-LVL 2
Scale: 1/4" = 1'-0"

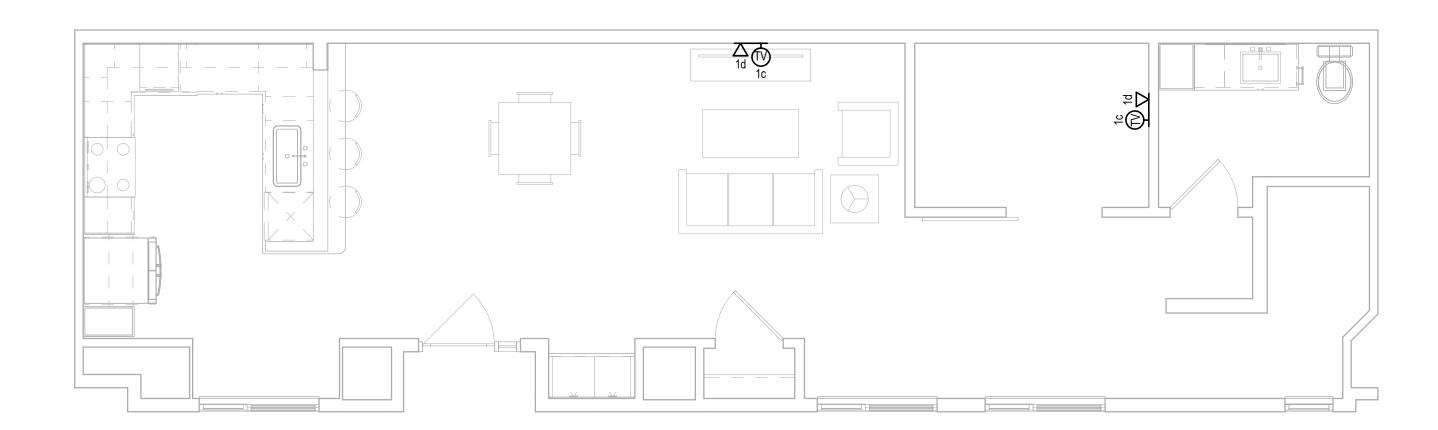

UNIT ML-B1-LVL 1 Scale: 1/4" = 1'-0"

KEY NOTES: UNIT PLANS

STRUCTURED MEDIA ENCLOSURE. ROUTE AND TERMINATE ALL VOICE, DATA, & TELEVISION CABLES WITHIN THE RESPECTIVE UNIT HERE (TYPICAL). SEE DETAIL B ON SHEET T2.00.

HOME RUN ALL COAXIAL CABLES AND CAT6 CABLES TO NEAREST TELECOM ROOM. SEE DETAIL A ON SHEET T2.00.

HOME RUN ALL COAXIAL CABLES AND CAT6 CABLES TO NEAREST TELECOM ROOM VIA ONE (1)-1" CONDUIT TO THE NEAREST TELECOM ROOM. SEE DETAIL A ON SHEET T2.00 & SHEET T3.00 FOR EXACT CONDUIT ROUTING.

GENERAL NOTES: UNIT PLANS

G-1. ALL VOICE, DATA, & COAXIAL CABLES SHALL BE HOME RUN FROM EACH OUTLET TO THE STRUCTURED MEDIA CENTER WITHOUT SPLICES.

G-2. MOUNT DEVICES AT THE SAME HEIGHT AS ELECTRICAL DEVICES (UNLESS OTHERWISE NOTED), ALIGN COVER PLATES. COORDINATE WITH ELECTRICAL.

G-3. ALL VOICE & DATA CABLING SHALL BE CAT6.


GRANT STREET APARTMENTS
290 E. 17th Ave, Denver, CO 80203
A Development of
Abacus Capital Group

NOT FOR CONSTRUCTION ISSUED FOR PRICING ISSUED FOR PERMIT ISSUED FOR CONSTRUCTION

UNIT PLAN

DRAWING NO.

Jordan & Skala Engineers
555 17th Street, Suite 700 • Denver, CO 80202
p. 303.586.2375 Checked By: Checker

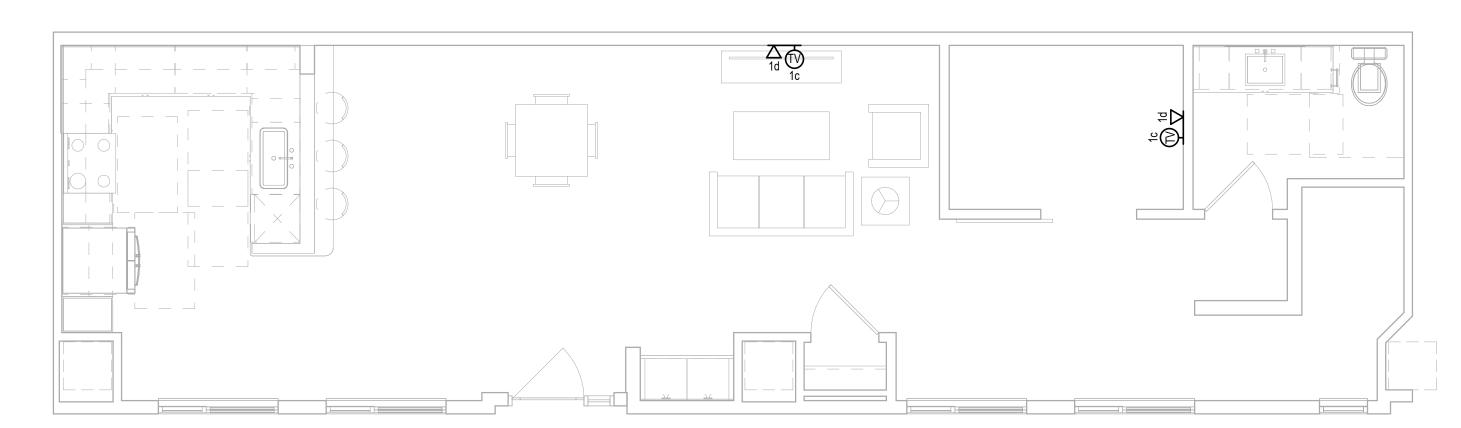

UNIT ML-B2-LVL 1 Scale: 1/4" = 1'-0"

KEY NOTES: UNIT PLANS

STRUCTURED MEDIA ENCLOSURE. ROUTE AND TERMINATE ALL VOICE, DATA, & TELEVISION CABLES WITHIN THE RESPECTIVE UNIT HERE (TYPICAL). SEE DETAIL B ON SHEET T2.00.

HOME RUN ALL COAXIAL CABLES AND CAT6 CABLES TO NEAREST TELECOM ROOM. SEE DETAIL A ON SHEET T2.00.

HOME RUN ALL COAXIAL CABLES AND CAT6 CABLES TO NEAREST TELECOM ROOM VIA ONE (1)-1" CONDUIT TO THE NEAREST TELECOM ROOM. SEE DETAIL A ON SHEET T2.00 & SHEET T3.00 FOR EXACT CONDUIT ROUTING.

GENERAL NOTES: UNIT PLANS

G-1. ALL VOICE, DATA, & COAXIAL CABLES SHALL BE HOME RUN FROM EACH OUTLET TO THE STRUCTURED MEDIA CENTER WITHOUT SPLICES.

G-2. MOUNT DEVICES AT THE SAME HEIGHT AS ELECTRICAL DEVICES (UNLESS OTHERWISE NOTED), ALIGN COVER PLATES. COORDINATE WITH ELECTRICAL.

G-3. ALL VOICE & DATA CABLING SHALL BE CAT6.

GRANT STREET APARTMENTS
290 E. 17th Ave, Denver, CO 80203
A Development of
Abacus Capital Group


NOT FOR CONSTRUCTION ISSUED FOR PRICING ISSUED FOR PERMIT

ISSUED FOR CONSTRUCTION

UNIT PLAN

DRAWING NO.

Jordan & Skala Engineers
555 17th Street, Suite 700 • Denver, CO 80202
p. 303.586.2375 Checked By: Checker

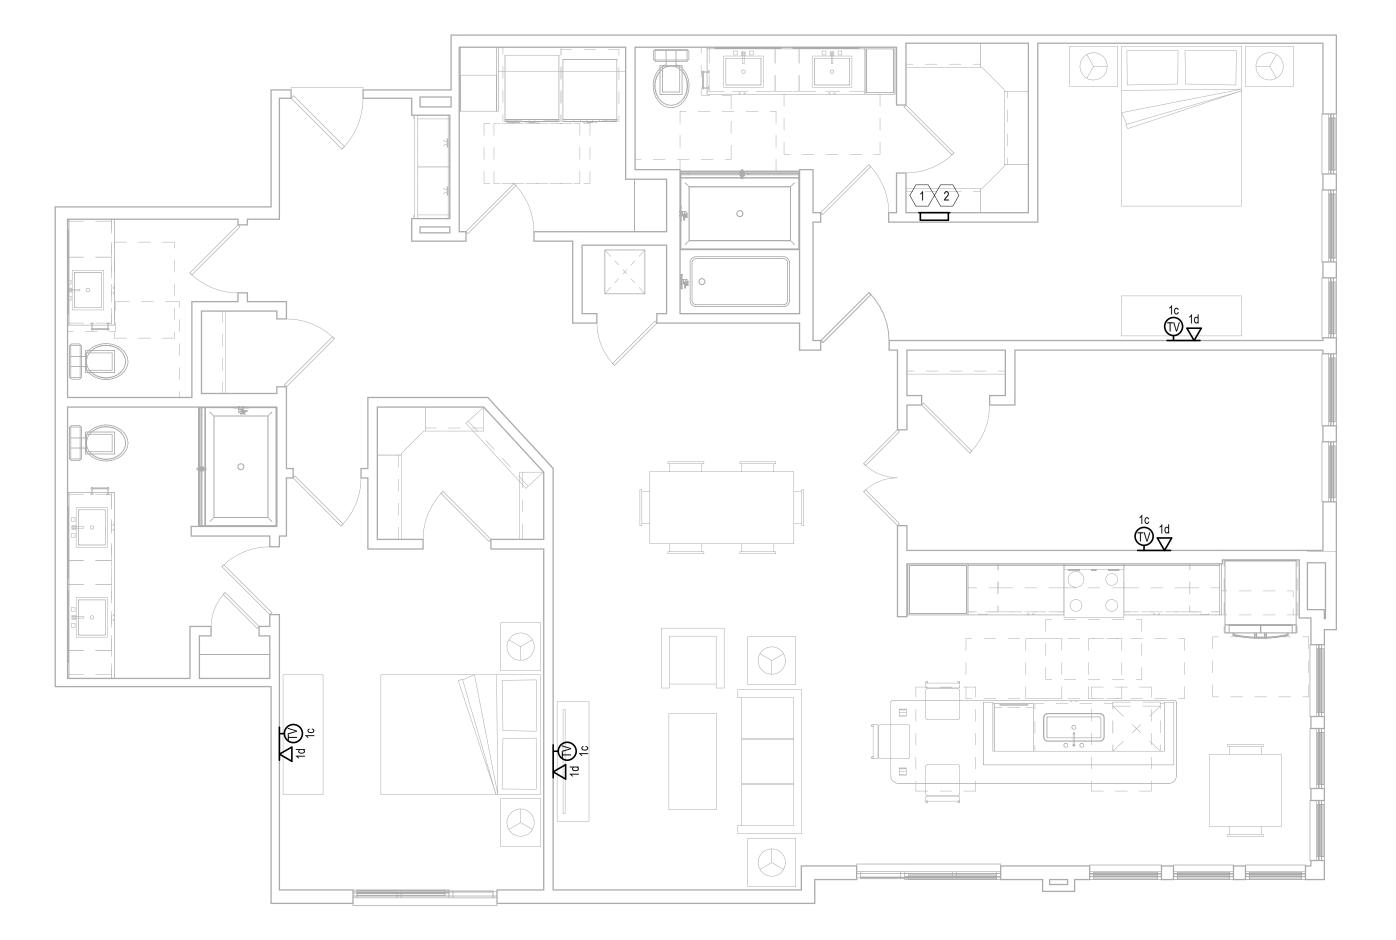


KEY NOTES: UNIT PLANS

- STRUCTURED MEDIA ENCLOSURE. ROUTE AND TERMINATE ALL VOICE, DATA, & TELEVISION CABLES WITHIN THE RESPECTIVE UNIT HERE (TYPICAL). SEE DETAIL B ON SHEET T2.00.
- HOME RUN ALL COAXIAL CABLES AND CAT6 CABLES TO NEAREST TELECOM ROOM. SEE DETAIL A ON SHEET T2.00.
- HOME RUN ALL COAXIAL CABLES AND CAT6 CABLES TO NEAREST TELECOM ROOM VIA ONE (1)-1" CONDUIT TO THE NEAREST TELECOM ROOM. SEE DETAIL A ON SHEET T2.00 & SHEET T3.00 FOR EXACT CONDUIT ROUTING.

GENERAL NOTES: UNIT PLANS

- G-1. ALL VOICE, DATA, & COAXIAL CABLES SHALL BE HOME RUN FROM EACH OUTLET TO THE STRUCTURED MEDIA CENTER WITHOUT SPLICES.
- G-2. MOUNT DEVICES AT THE SAME HEIGHT AS ELECTRICAL DEVICES (UNLESS OTHERWISE NOTED), ALIGN COVER PLATES. COORDINATE WITH ELECTRICAL.
- G-3. ALL VOICE & DATA CABLING SHALL BE CAT6.

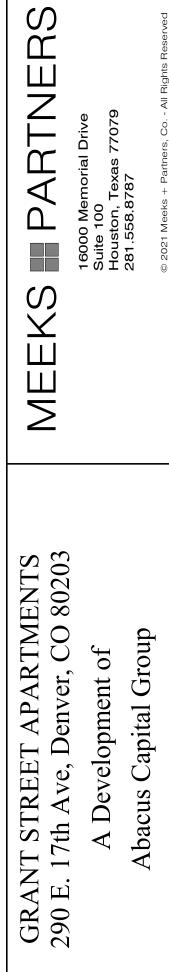

ISSUED FOR CONSTRUCTION
SHEET TITLE:
UNIT PLAN

B0202
DRAWING NO.

NOT FOR CONSTRUCTION

ISSUED FOR PRICING


ISSUED FOR PERMIT


Jordan & Skala Engineers

555 17th Street, Suite 700 • Denver, CO 80202
p. 303.586.2375

DRAWING NO. 0. 303.586.2375

Drawn By: Author Checked By: Checker

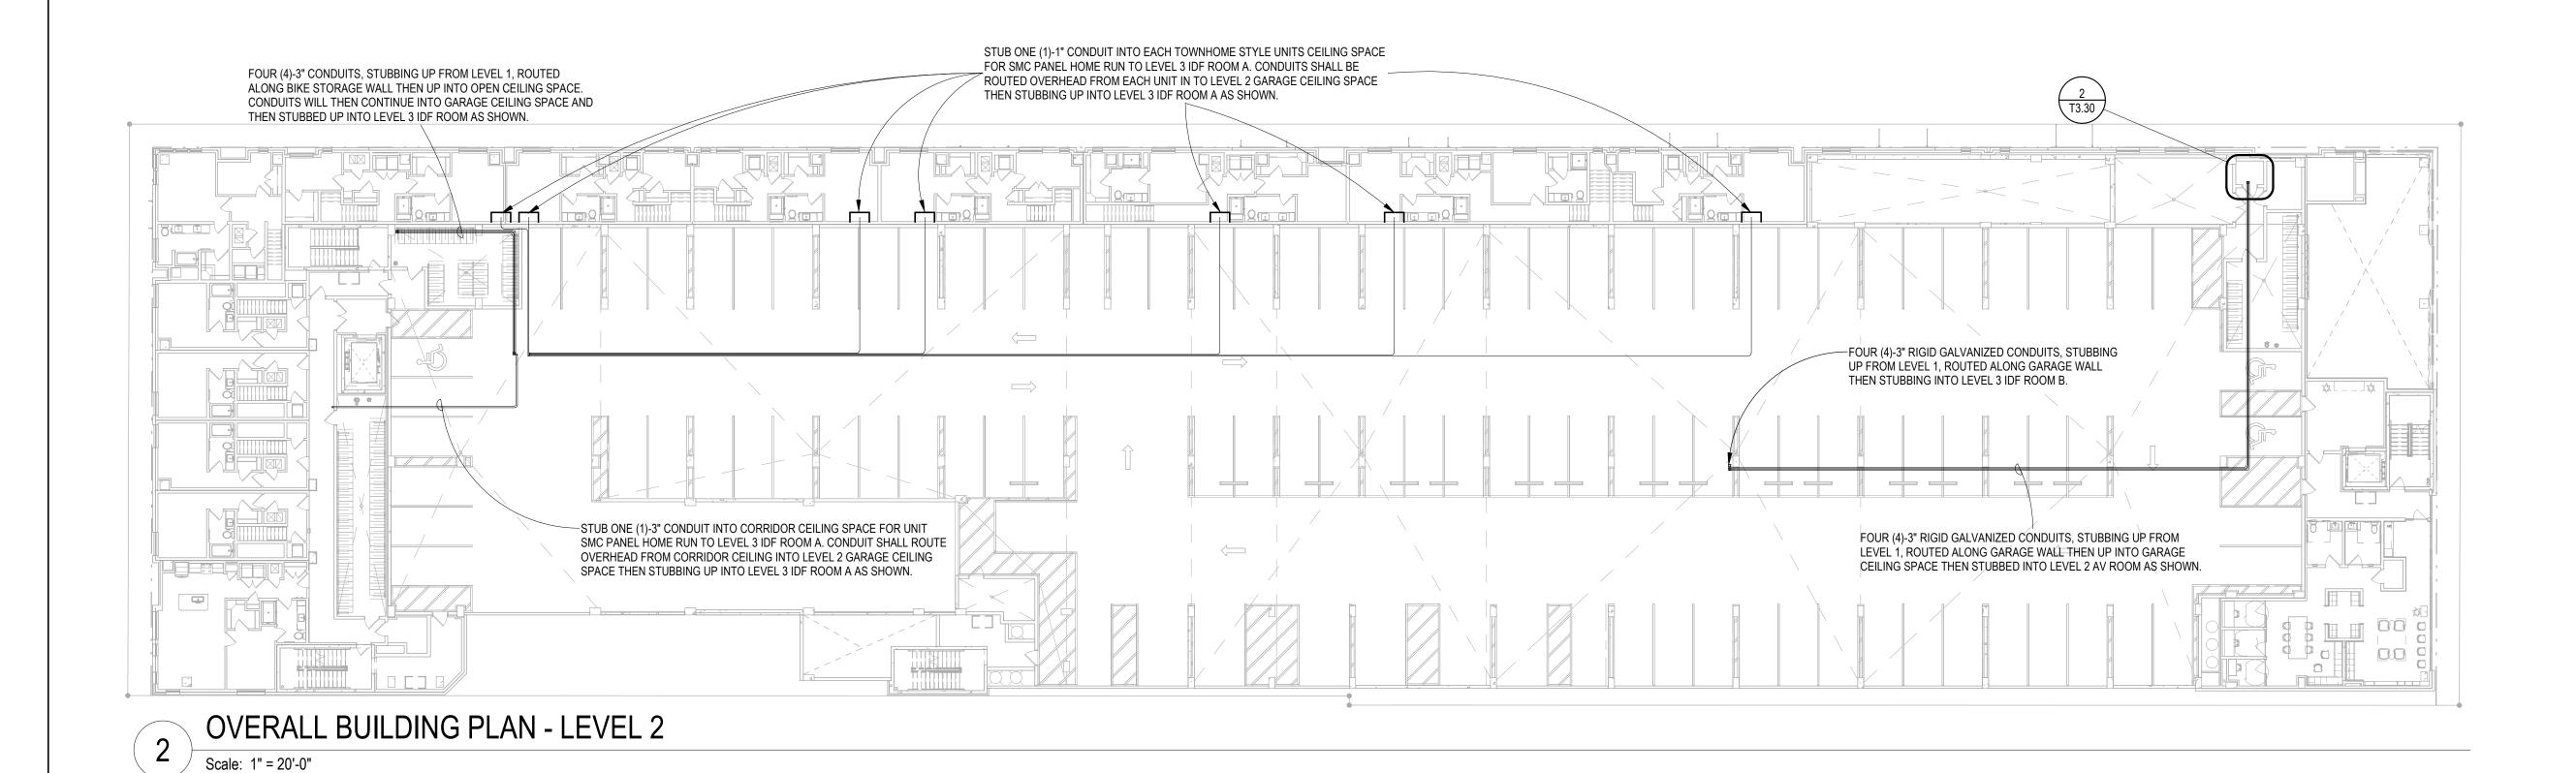

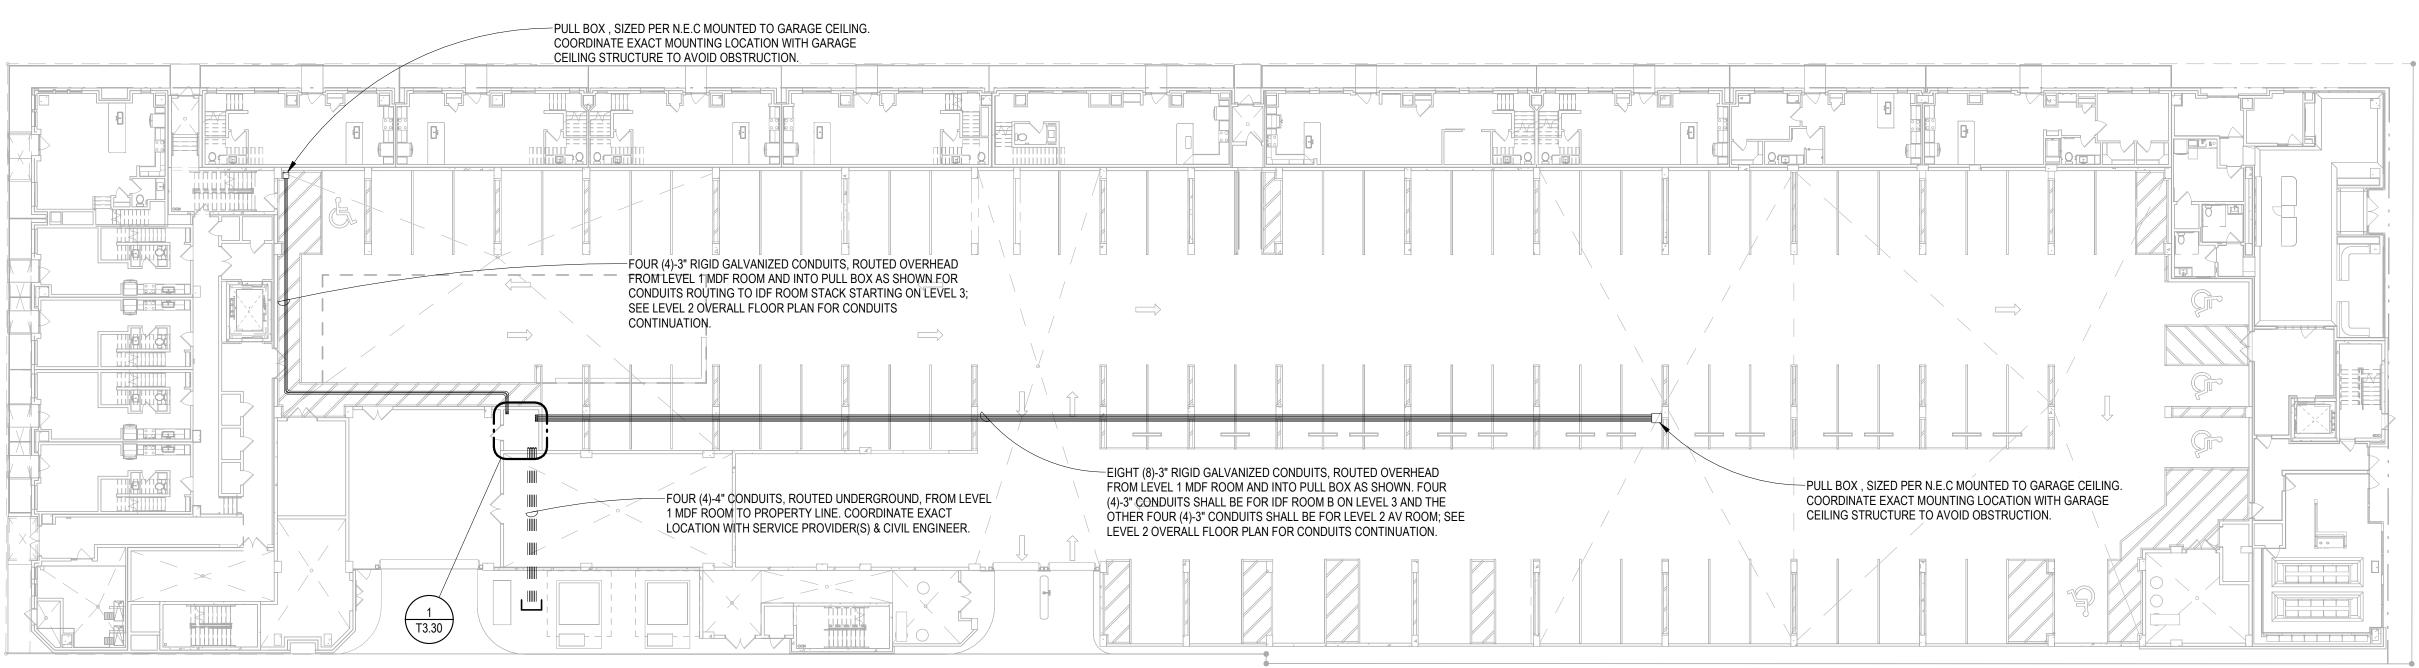

OVERALL BUILDING PLAN - LEVEL 1

DRAWING NO.

Drawn By: Author

T3.00 Checked By: Checker

MEEKS

GRANT STREET APARTMENTS 290 E. 17th Ave, Denver, CO 80203


A Development of Abacus Capital Group

NOT FOR CONSTRUCTION ISSUED FOR PRICING


ISSUED FOR PERMIT

ISSUED FOR CONSTRUCTION

OVERALL BUILDING PLAN - LEVEL 1 & 2

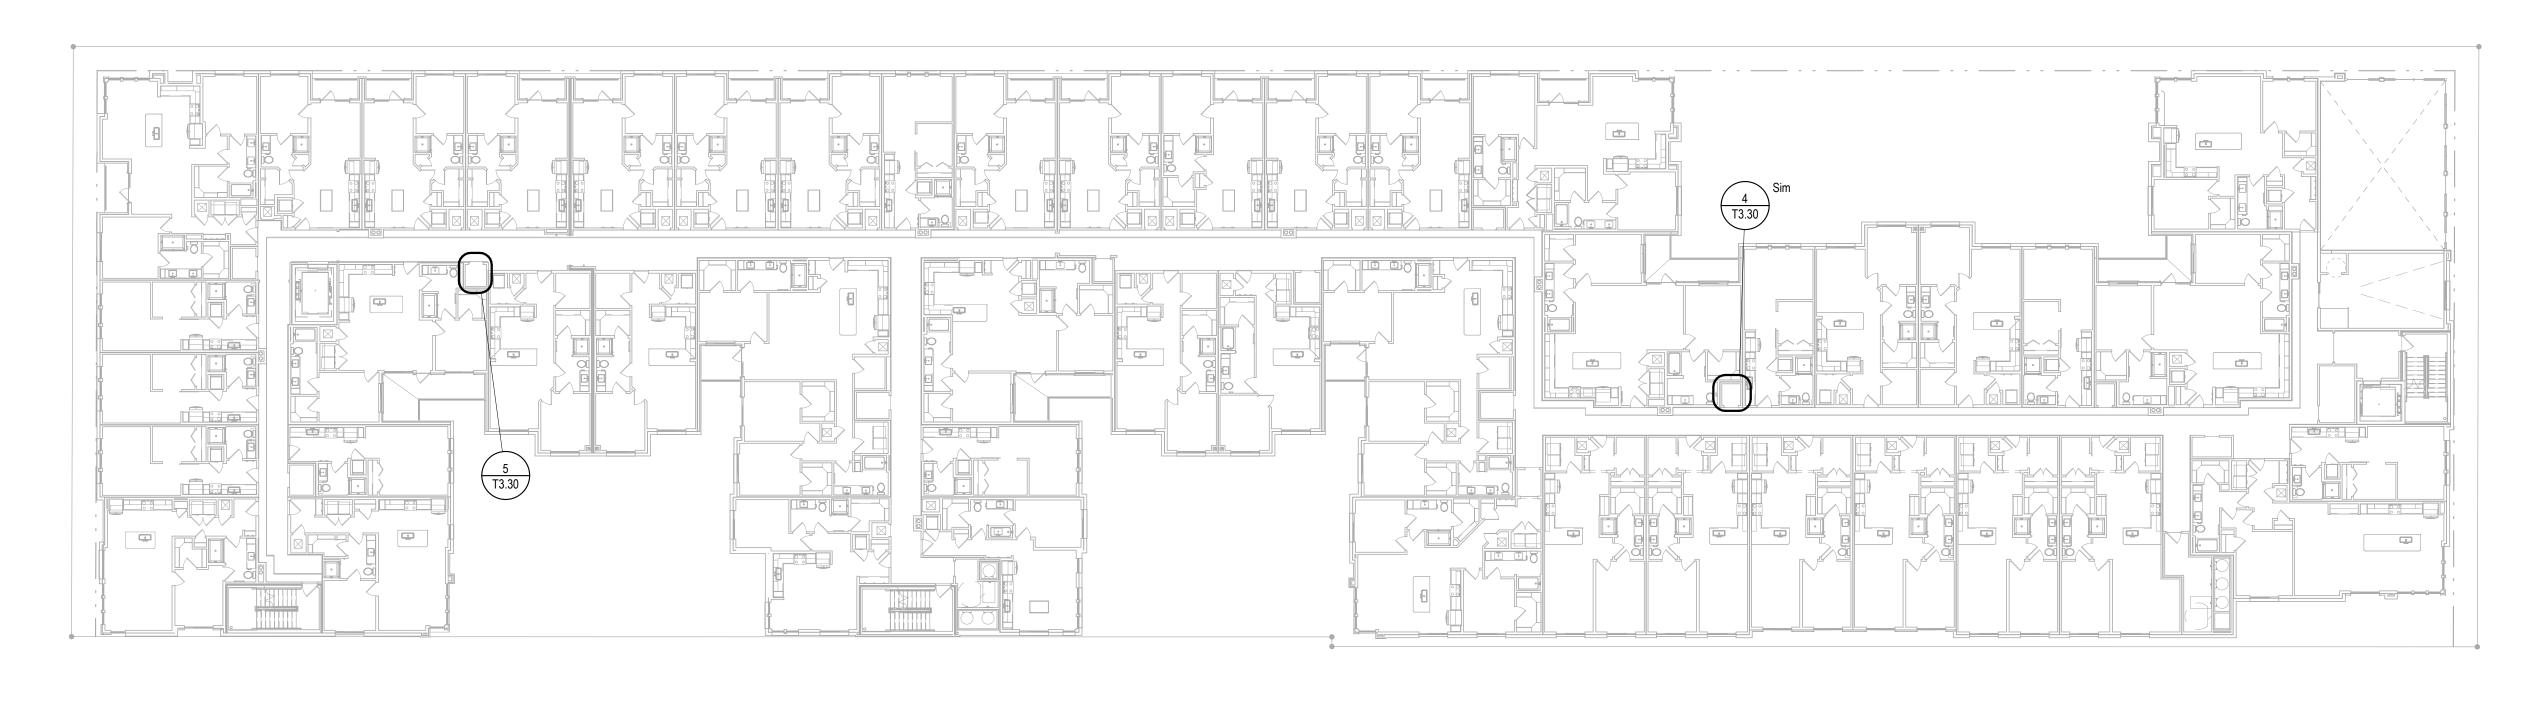

OVERALL BUILDING PLAN - LEVEL 4 2 Scale: 1" = 20'-0"

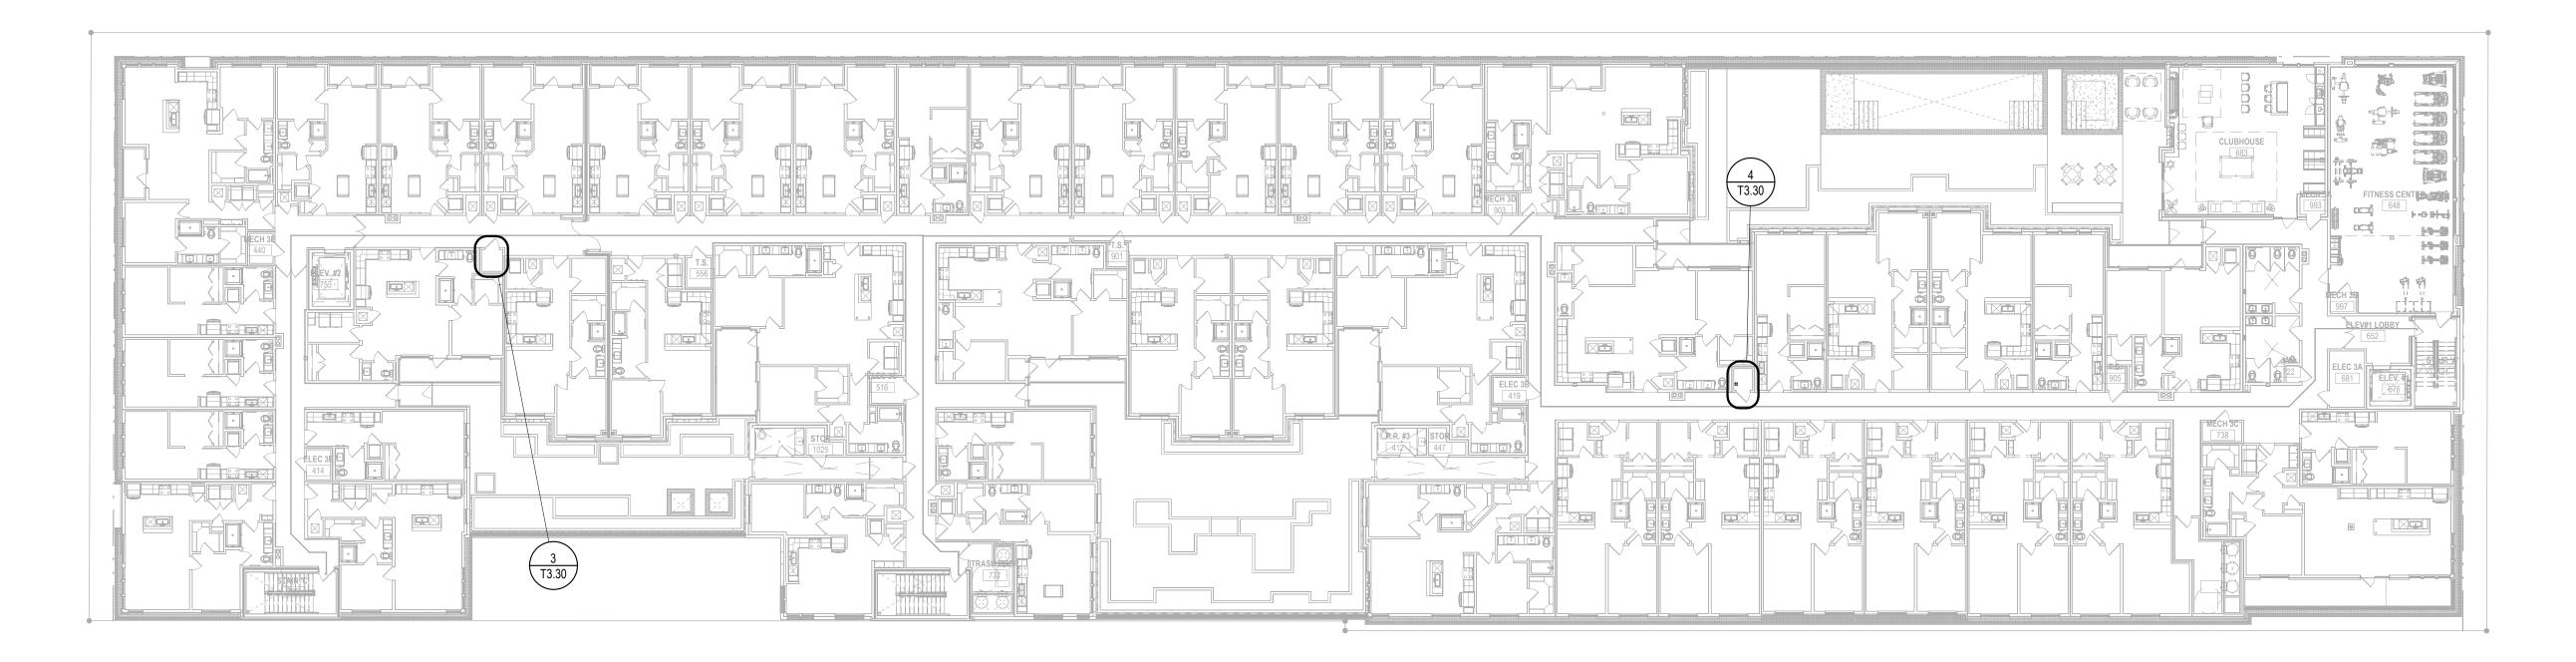


OVERALL BUILDING PLAN - LEVEL 3 Scale: 1" = 20'-0"

Jordan & Skala Engineers
555 17th Street, Suite 700 • Denver, CO 80202
p. 303.586.2375

NOT FOR CONSTRUCTION ISSUED FOR PRICING ISSUED FOR PERMIT ISSUED FOR CONSTRUCTION OVERALL BUILDING PLAN - LEVEL 3 & 4

DRAWING NO. T3.01

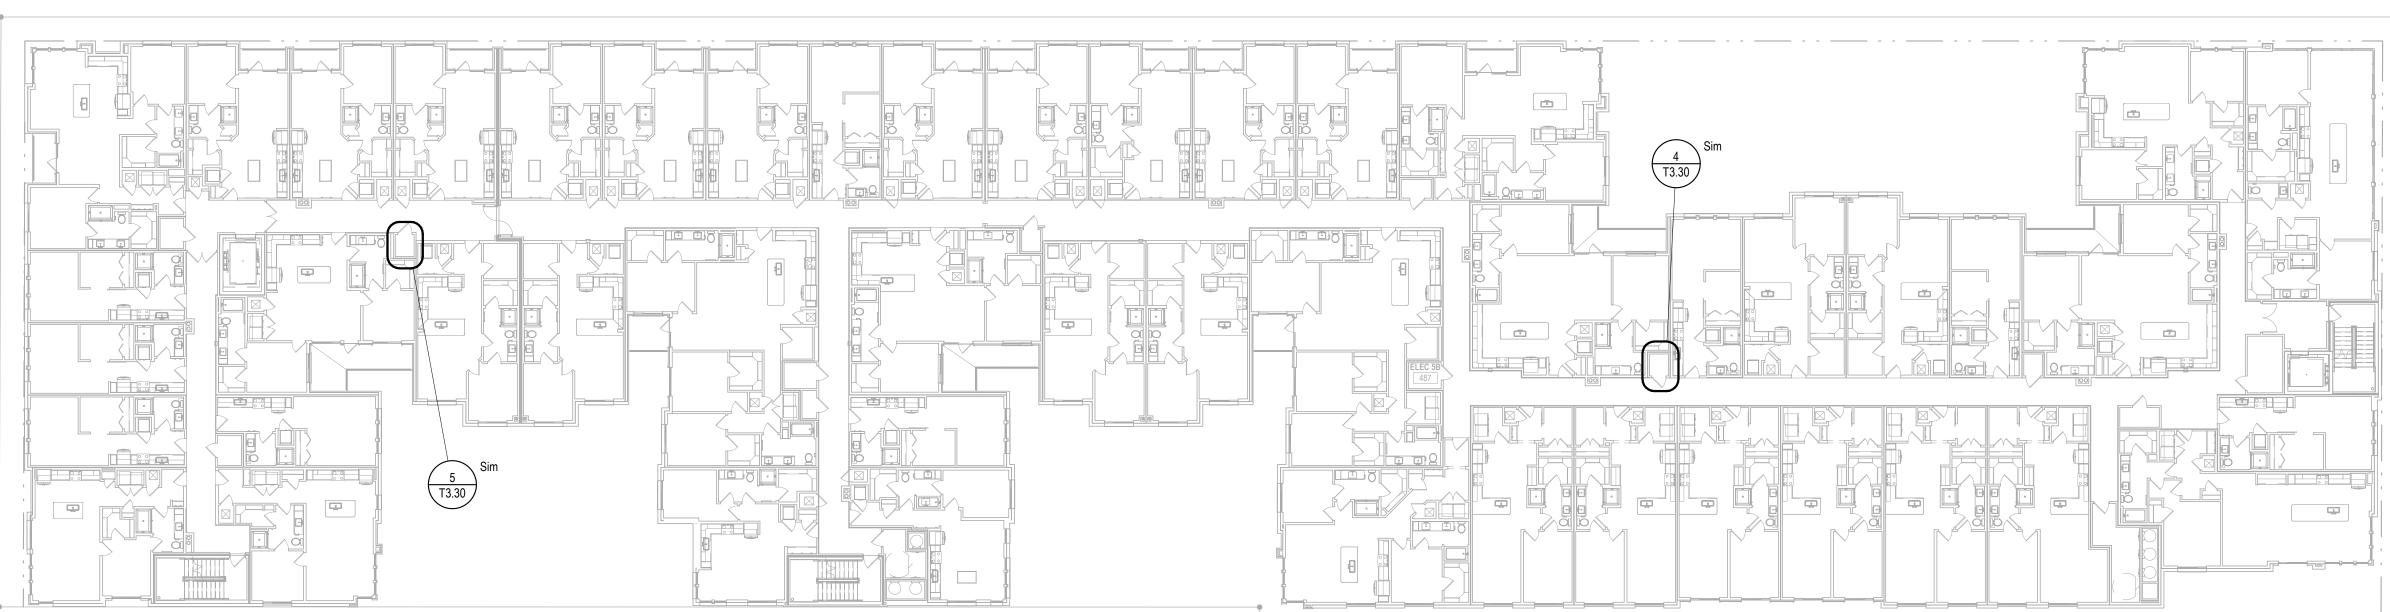


OVERALL POWER PLAN - LEVEL 5 Scale: 1" = 20'-0"

OVERALL BUILDING PLAN - LEVEL 5 & 6 DRAWING NO. T3.02

NOT FOR CONSTRUCTION ISSUED FOR PRICING ISSUED FOR PERMIT


ISSUED FOR CONSTRUCTION

Jordan & Skala Engineers
555 17th Street, Suite 700 • Denver, CO 80202
p. 303.586.2375 Drawn By: Author Checked By: Checker

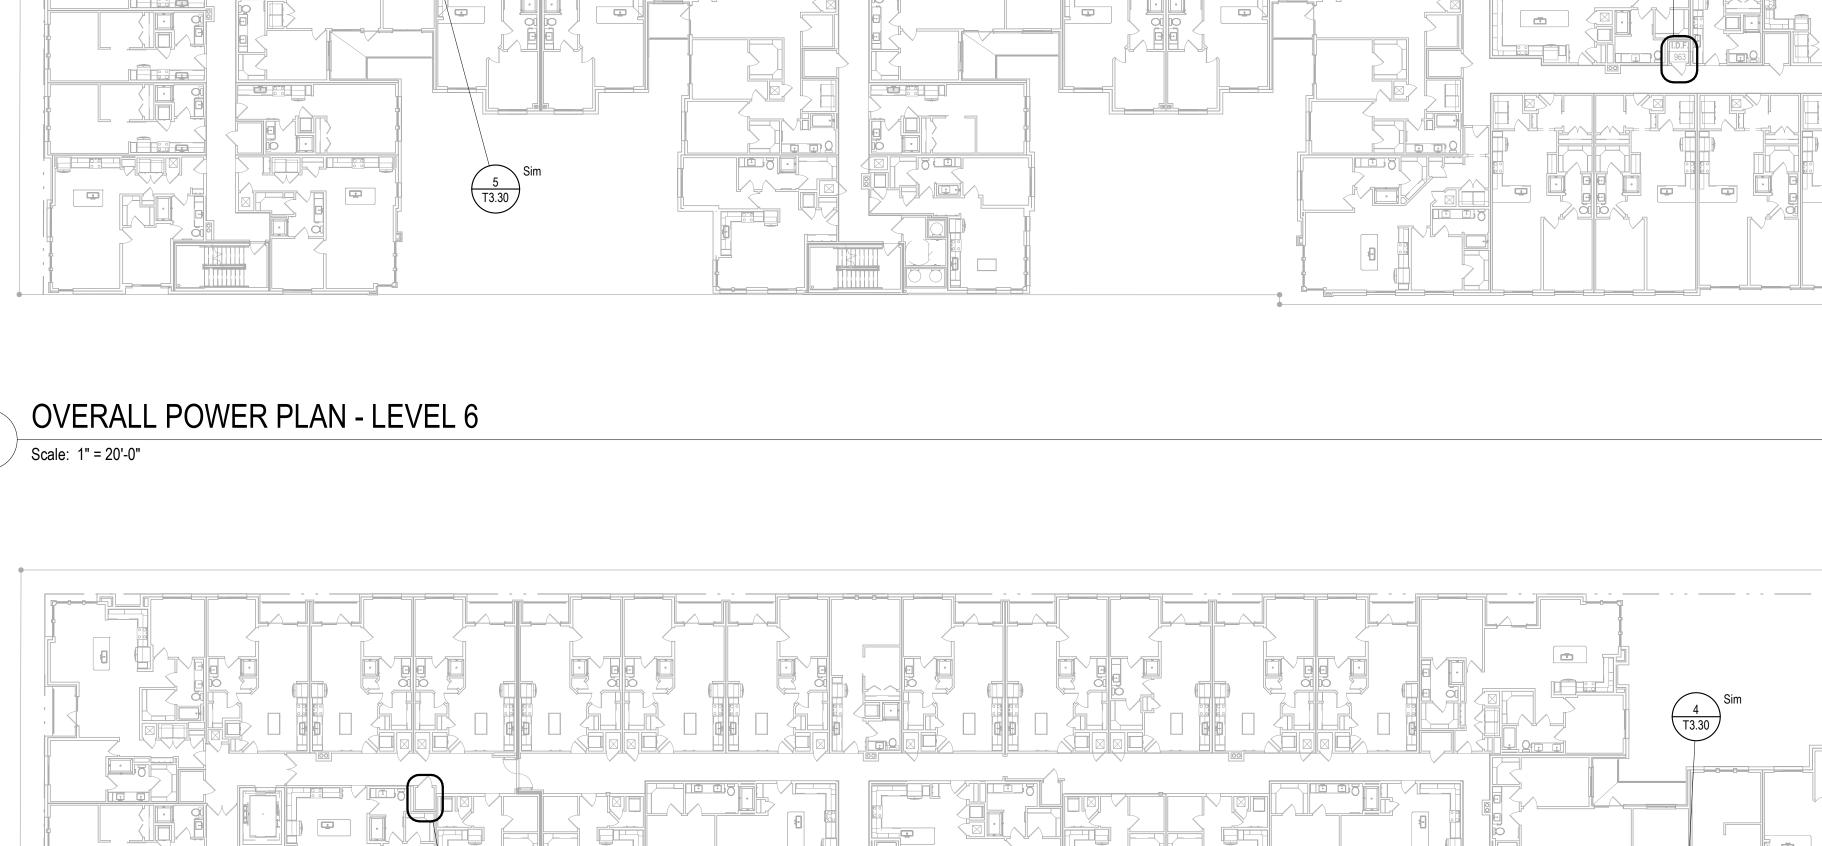

PROVIDE ONE (1)-2" CONDUIT FROM LEVEL 6 IDF ROOM A , STUBBING PASS LEVEL 7 MECHANICAL ROOM TO ROOF FOR ERRC BACKBONE CABLING.

OVERALL BUILDING PLAN - ROOF

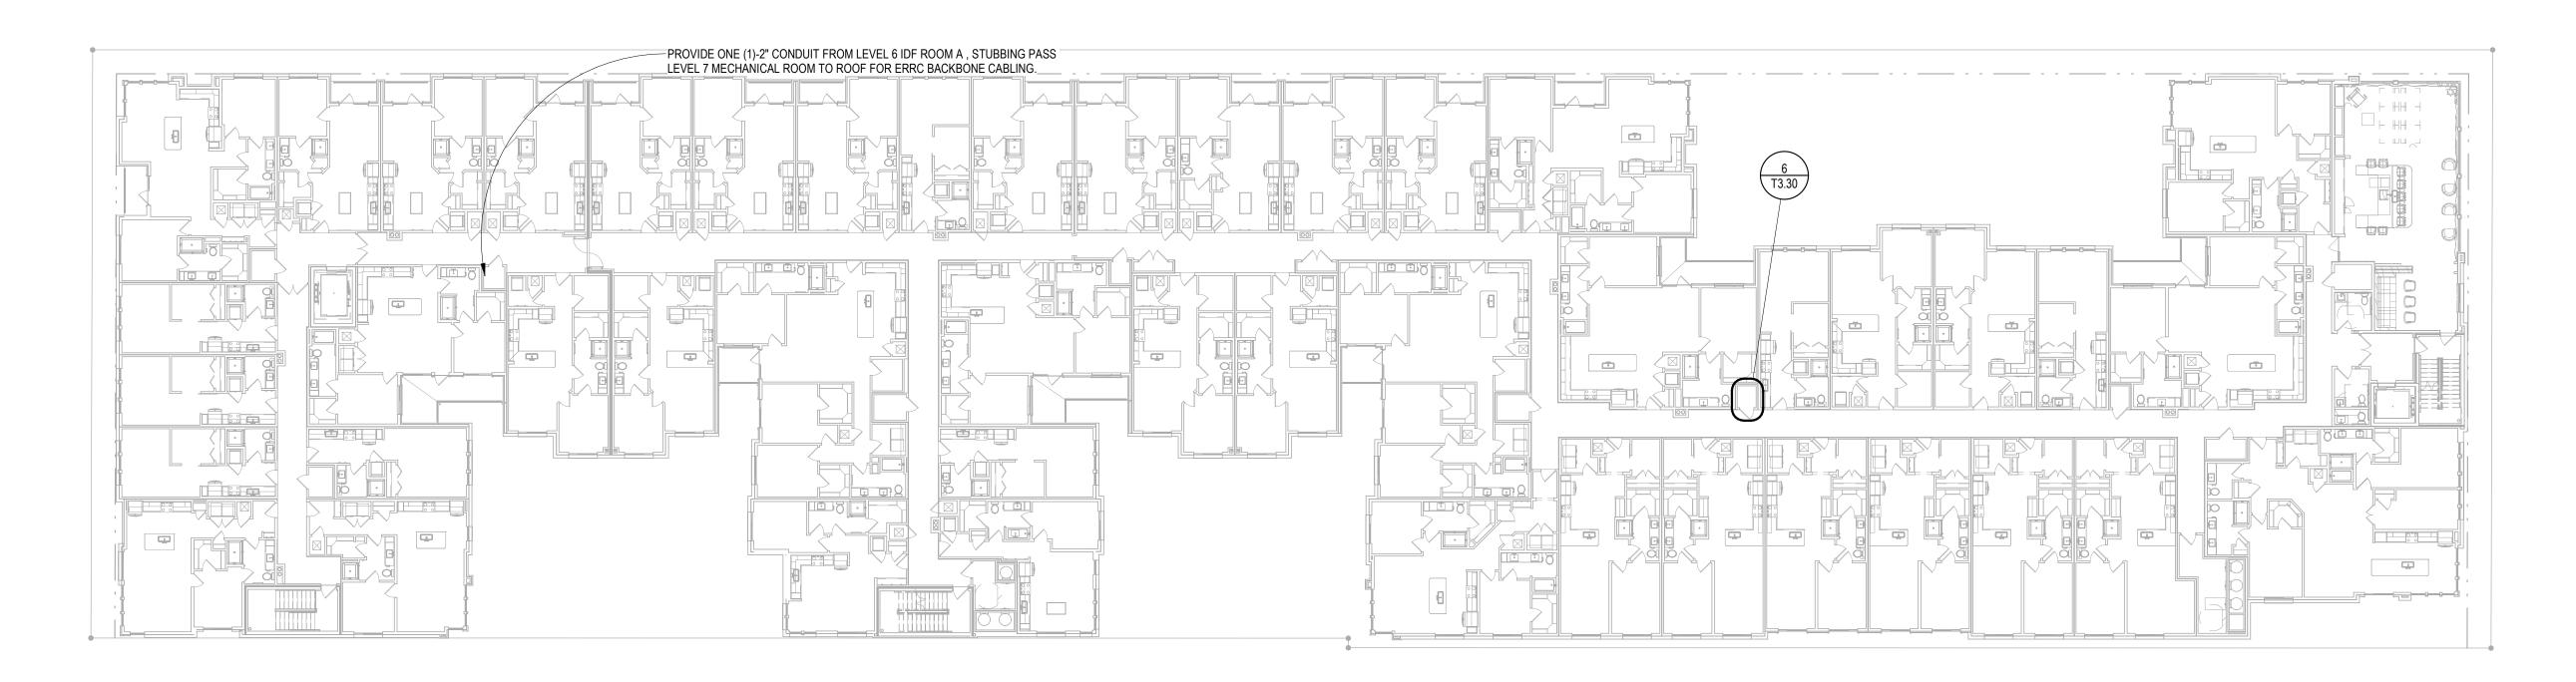

OVERALL BUILDING PLAN - LEVEL 7 Scale: 1" = 20'-0"

Jordan & Skala Engineers
555 17th Street, Suite 700 • Denver, CO 80202
p. 303.586.2375 Checked By: Checker Drawn By: Author

NOT FOR CONSTRUCTION ISSUED FOR PRICING ISSUED FOR PERMIT

ISSUED FOR CONSTRUCTION

SHEET TITLE:
OVERALL BUILDING
PLAN - LEVEL 7 &
ROOF

DRAWING NO. T3.03

NT STREET APARTMENTS
. 17th Ave, Denver, CO 80203
A Development of

JOB NO.: 2203

X NOT FOR CONSTRUCTION

ISSUED FOR PRICE

X NOT FOR CONSTRUCTION

ISSUED FOR PRICING
ISSUED FOR PERMIT
ISSUED FOR CONSTRUCTION


SHEET TITLE:

SHEET TITLE:
ENLARGED
BUILDING PLAN BLDG. #1A - LVL. 1

Jordan & Skala Engineers


555 17th Street, Suite 700 • Denver, CO 80202
p. 303.586.2375

BUILDING PLAN-BLDG. #1A - LVL. 1

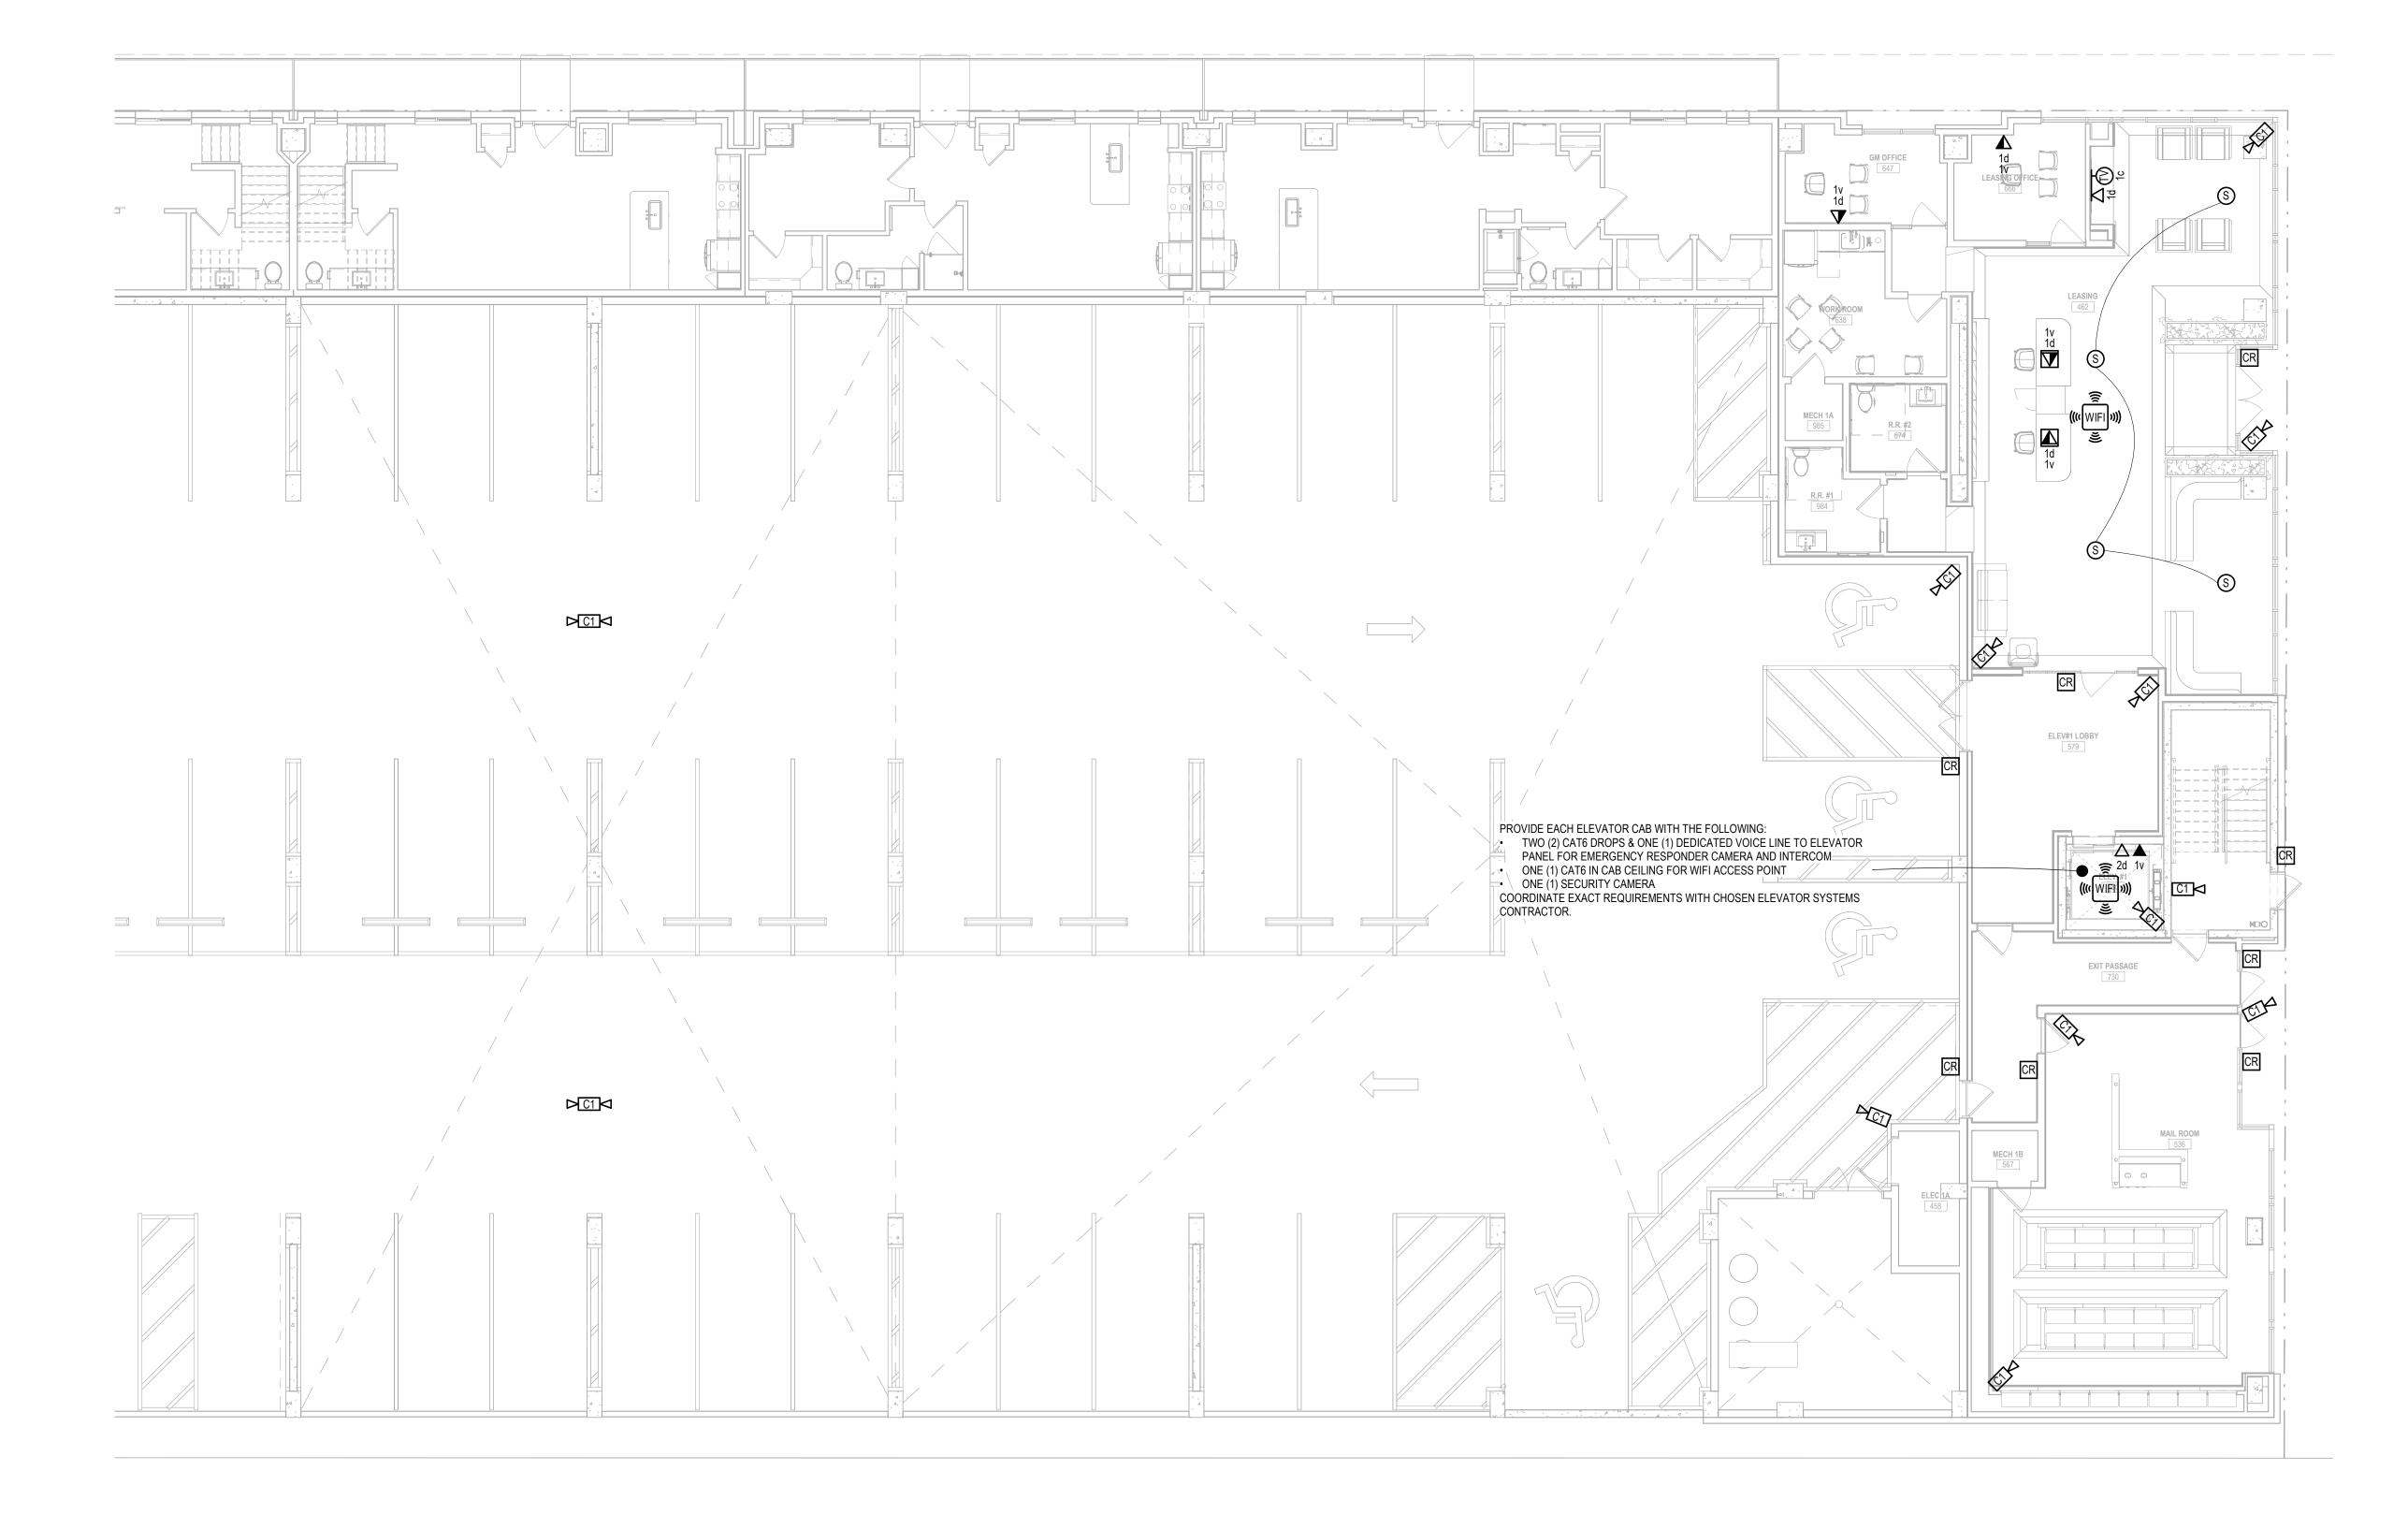

ENLARGED TELECOM PLAN - BUILDING #1A - LEVEL 1

Scale: 1/8" = 1'-0"

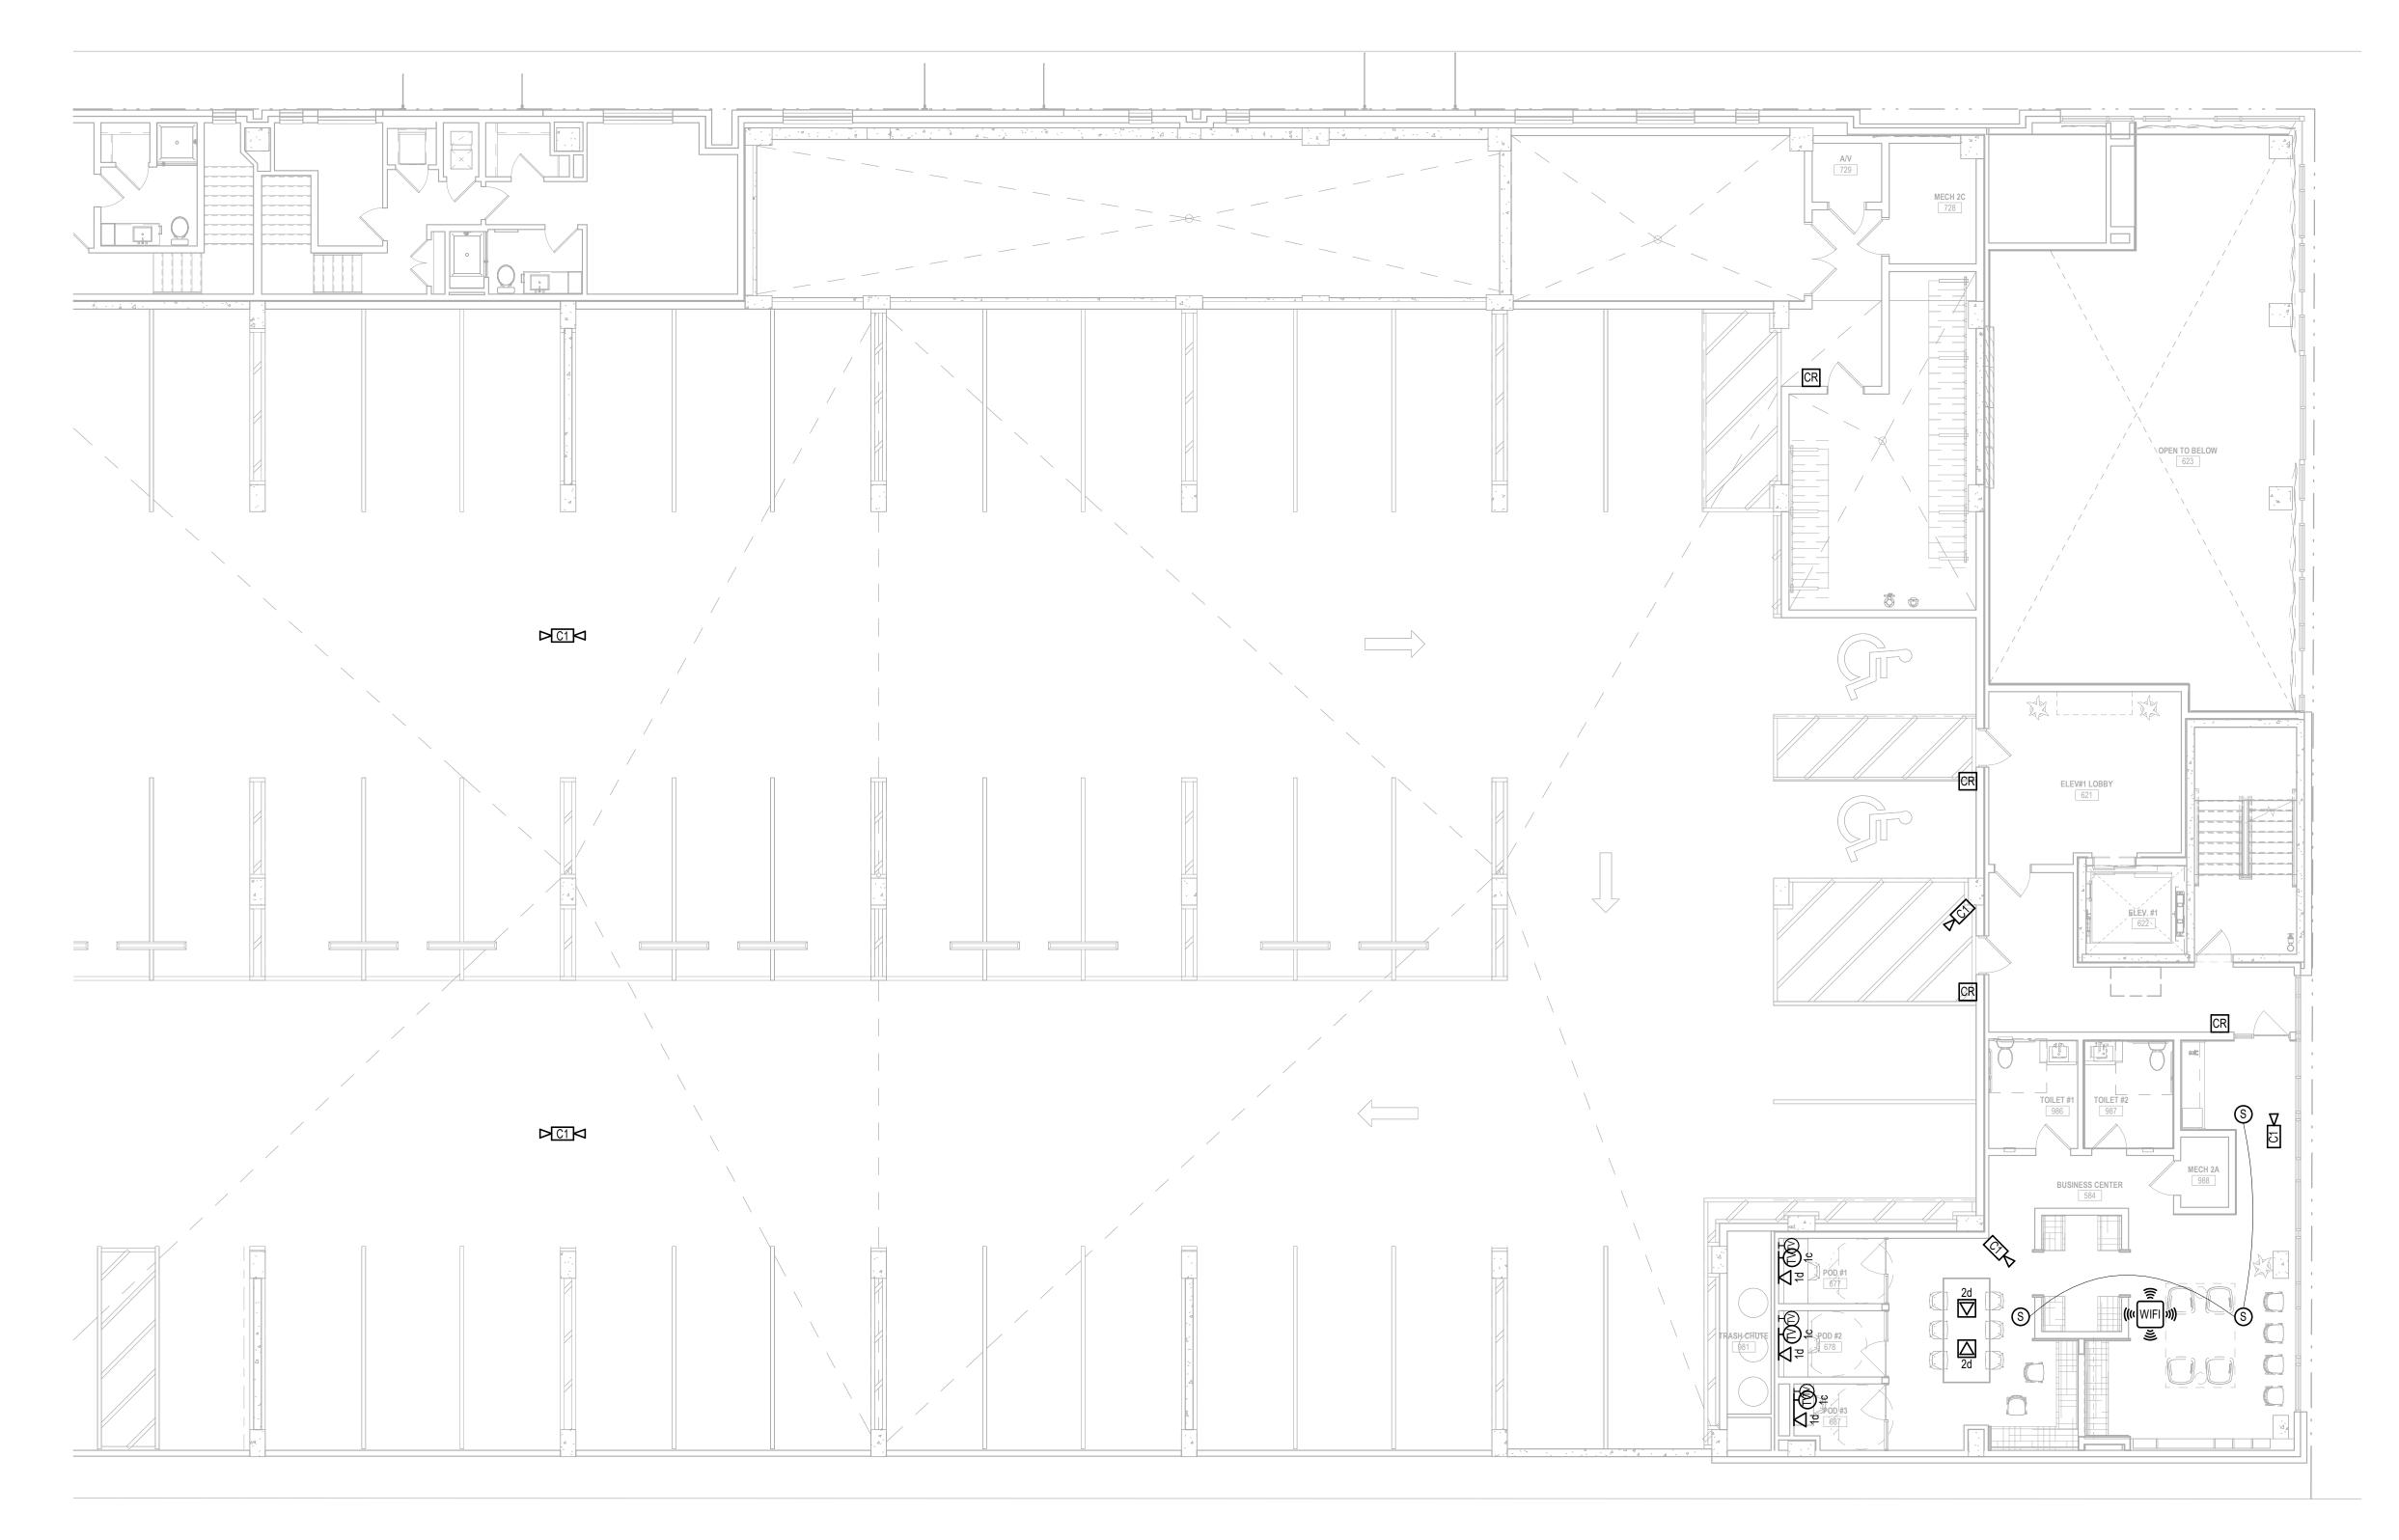

1 ENLARGED TELECOM PLAN - BUILDING #1A - LEVEL 2

Scale: 1/8" = 1'-0"

J G E Jordan & Skala Engineers

555 17th Street, Suite 700 • Denver, CO 80202
p. 303.586.2375

JOB NO.: 22035

X NOT FOR CONSTRUCTION

ISSUED FOR PERMIT
ISSUED FOR CONSTRUCTION

SHEET TITLE:
ENLARGED
BUILDING PLAN BLDG. #1A - LVL. 2


ENLARGED
BUILDING PLAN BLDG. #1A - LVL. 2

DRAWING NO.

T3.05

ENLARGED TELECOM PLAN - BUILDING #1A - LEVEL 3

Scale: 1/8" = 1'-0"

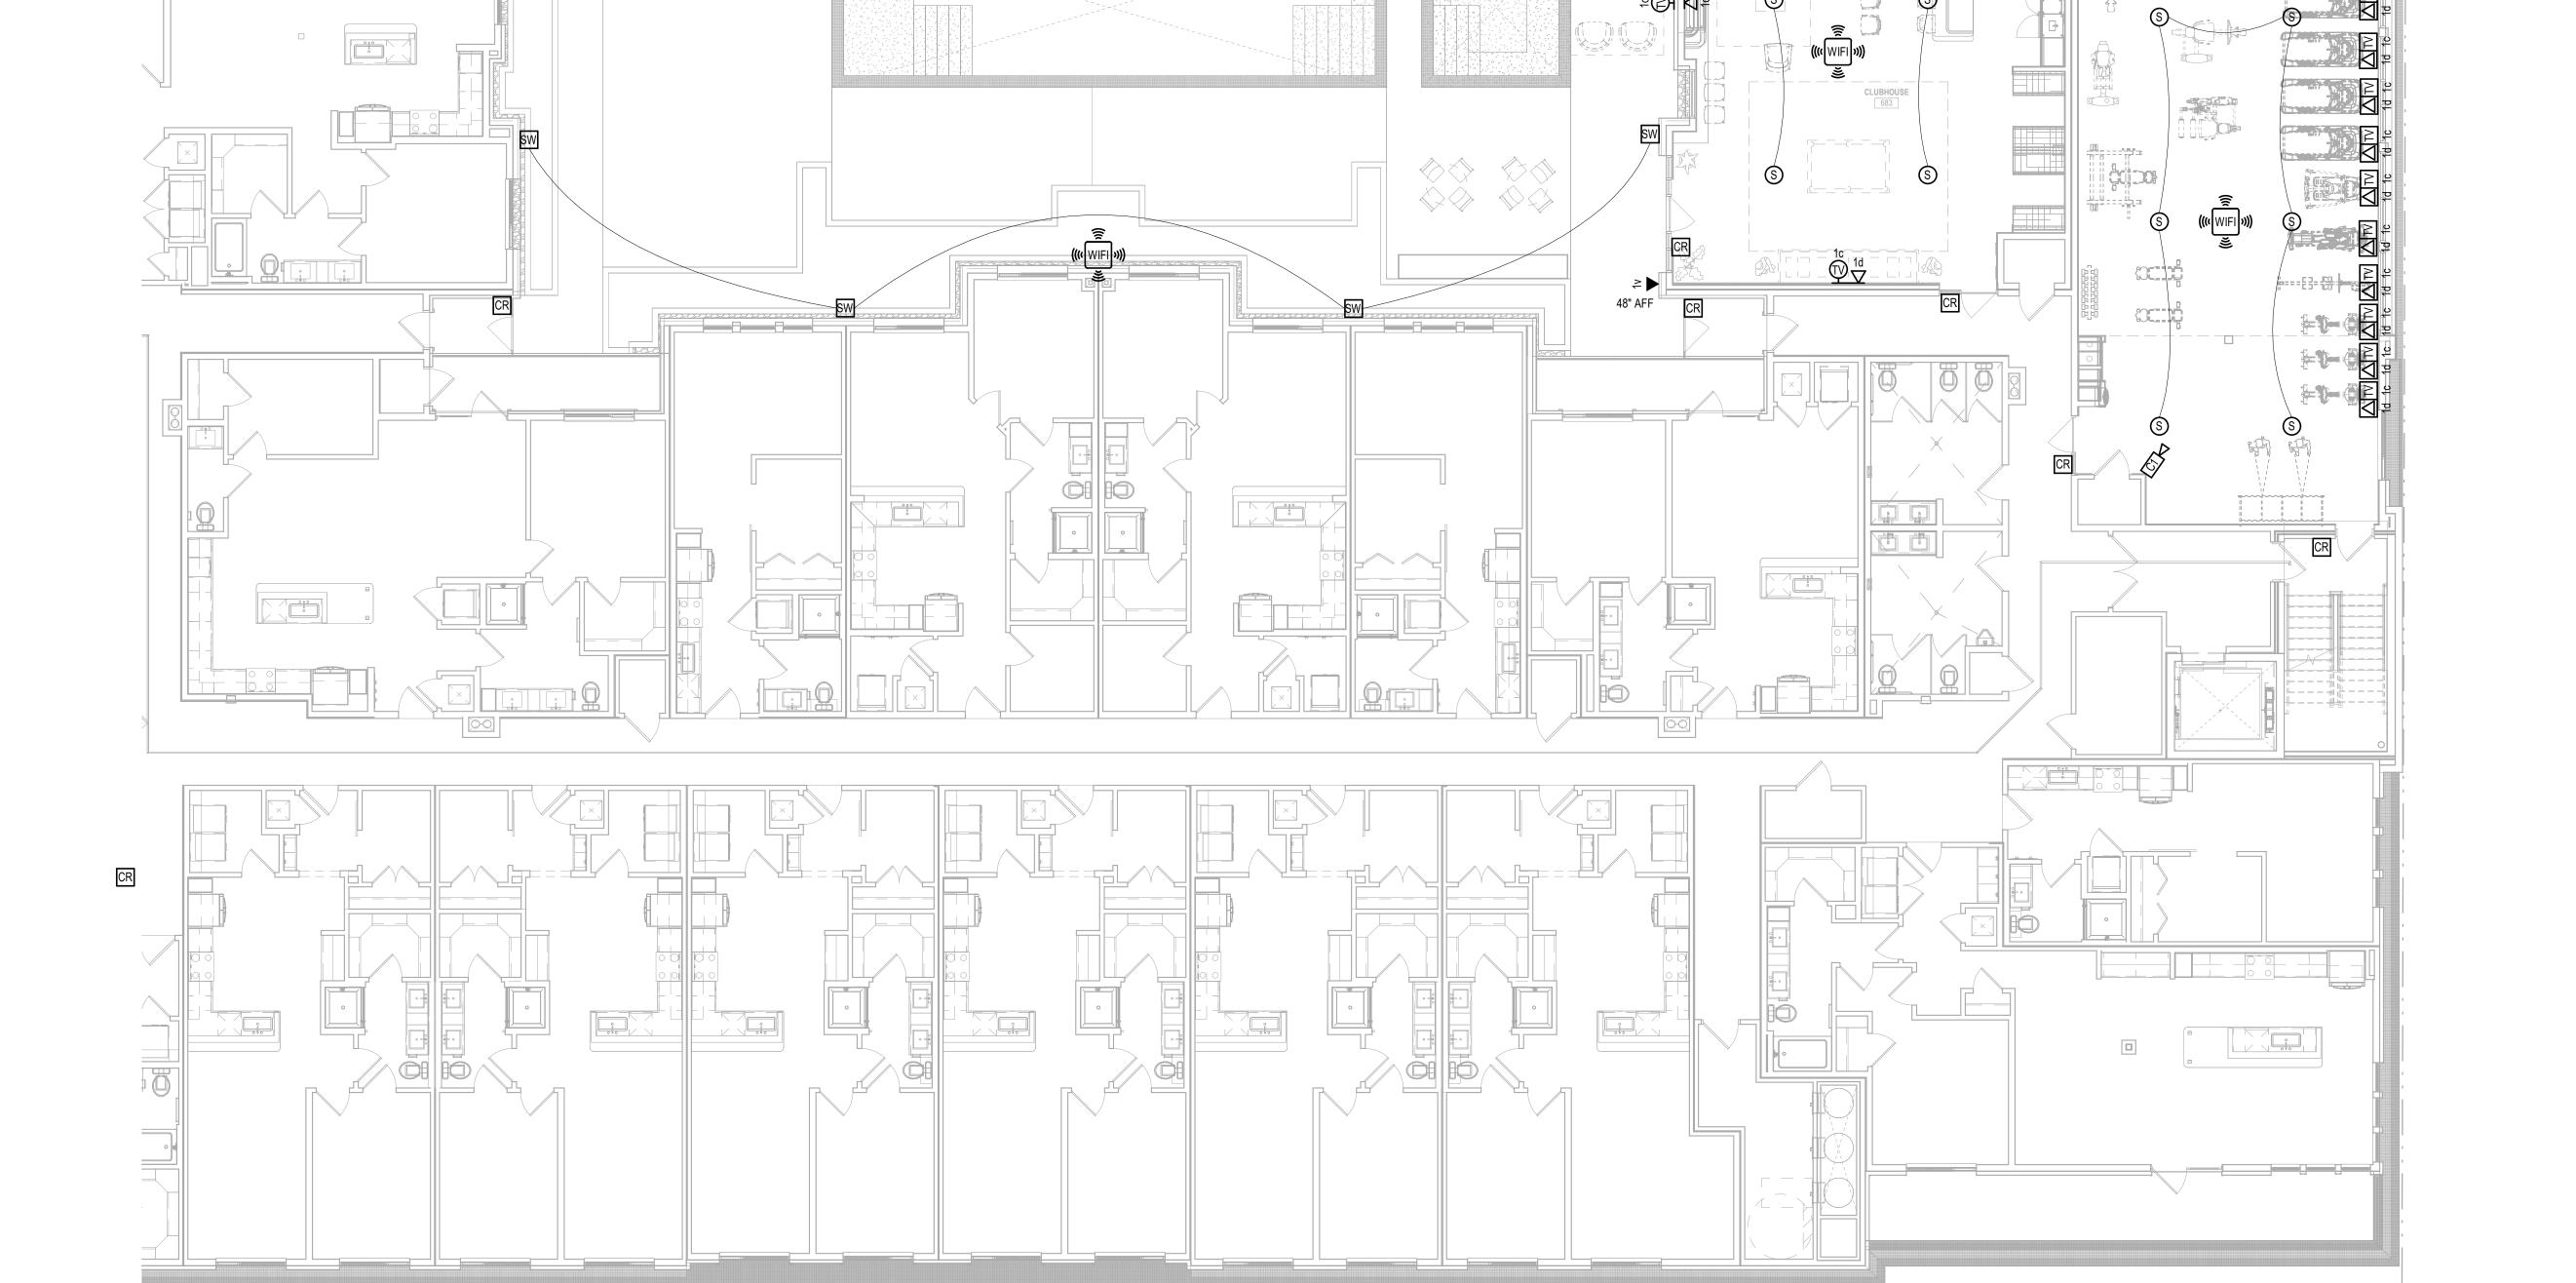

NOT FOR CONSTRUCTION ISSUED FOR PRICING ISSUED FOR PERMIT


ISSUED FOR CONSTRUCTION

SHEET TITLE:
ENLARGED
BUILDING PLAN BLDG. #1A - LVL. 3

DRAWING NO. T3.06

ENLARGED TELECOM PLAN - BUILDING #1A - LEVEL 4


Scale: 1/8" = 1'-0"

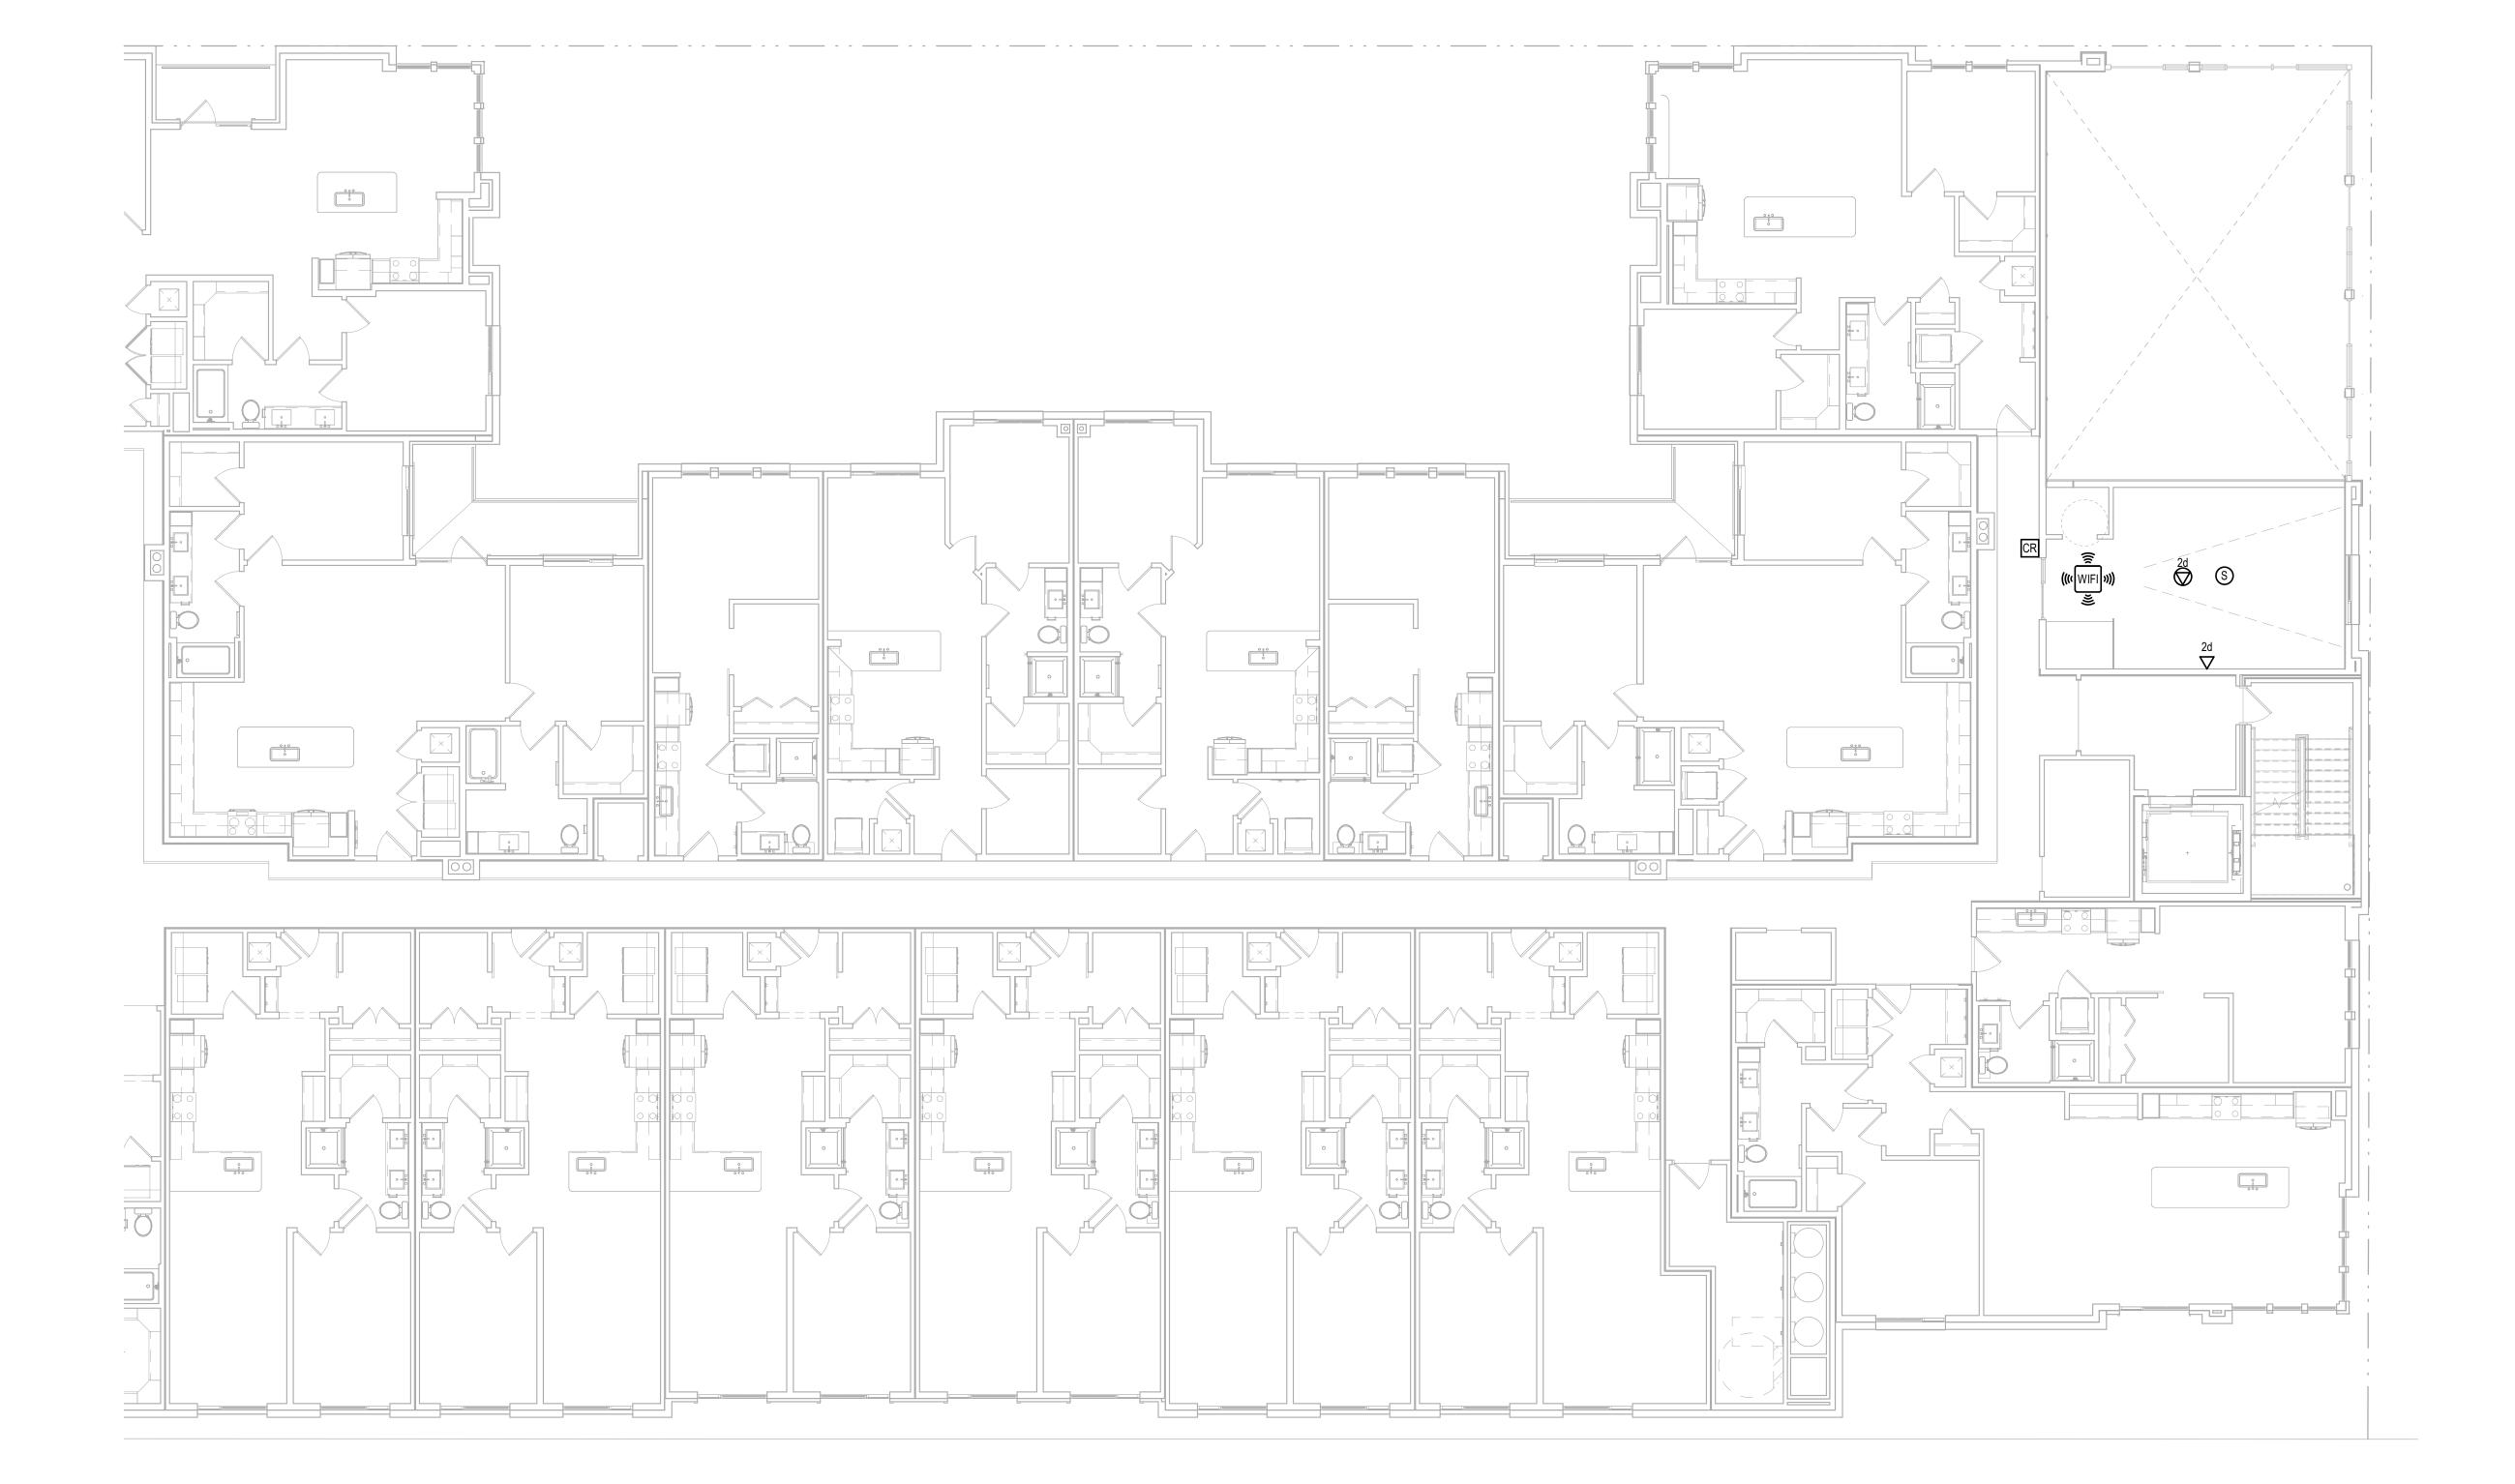

NOT FOR CONSTRUCTION ISSUED FOR PRICING ISSUED FOR PERMIT

ISSUED FOR CONSTRUCTION SHEET TITLE:
ENLARGED
BUILDING PLAN BLDG. #1A - LVL. 4

DRAWING NO. T3.07

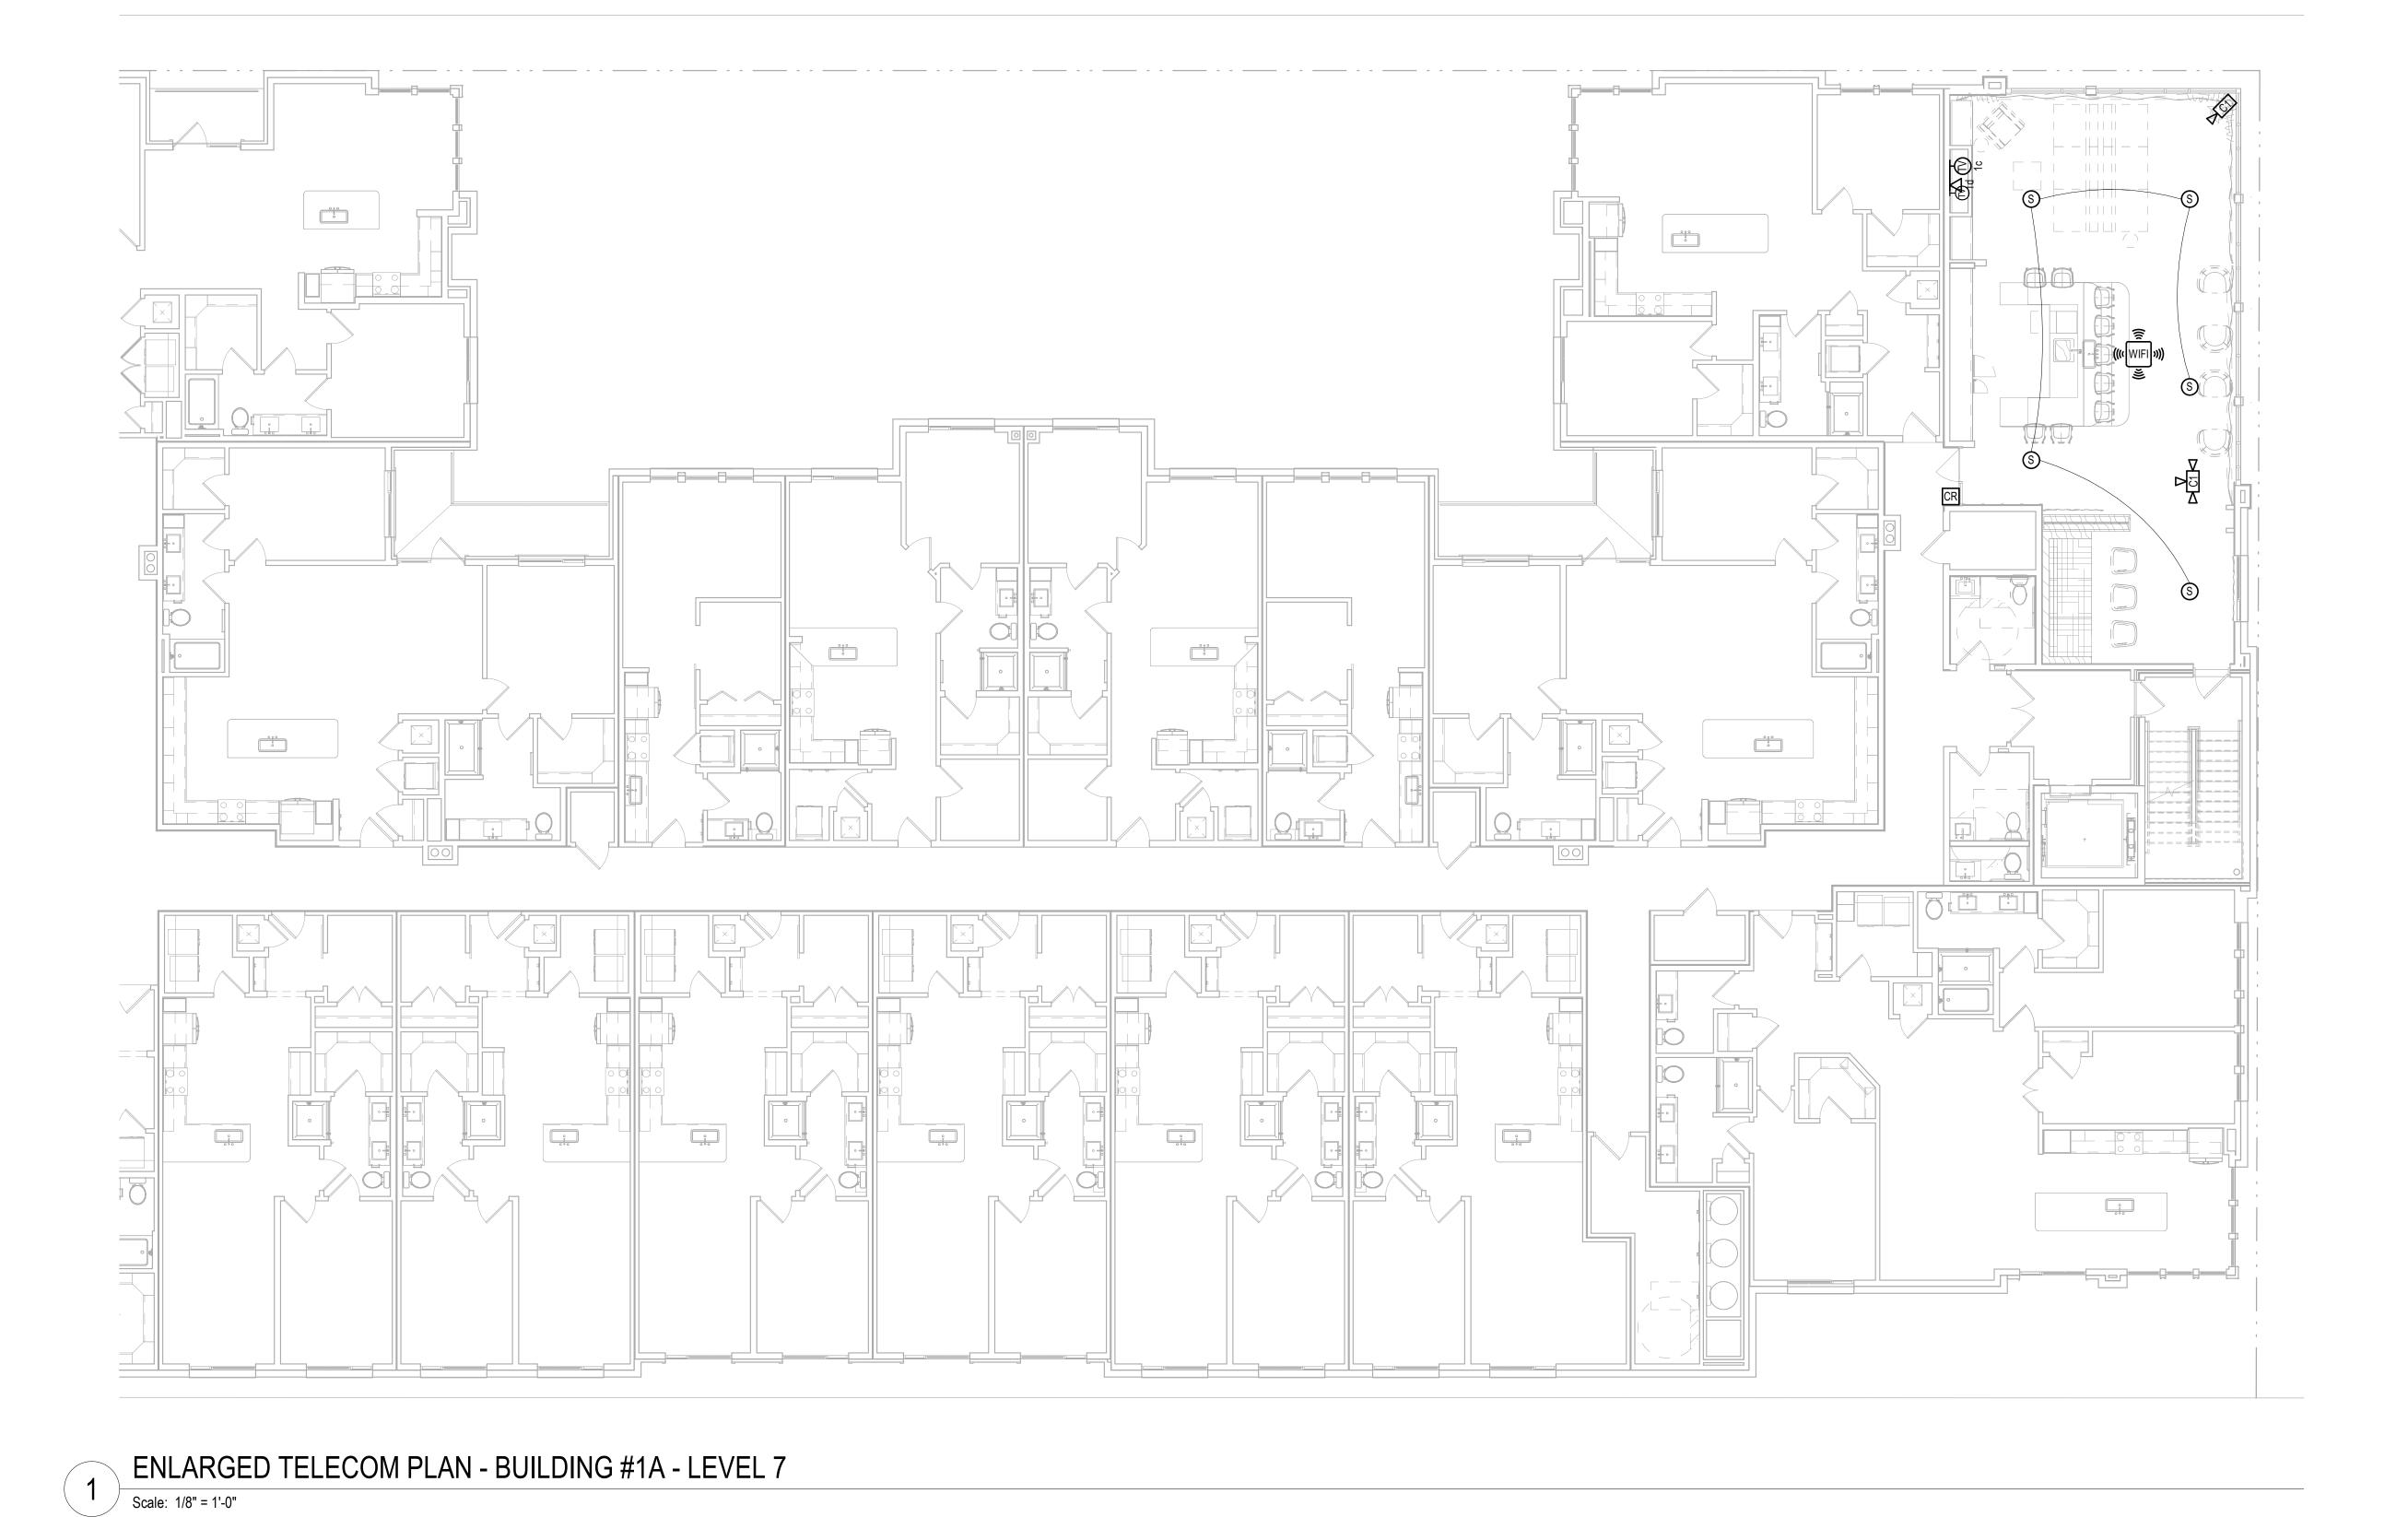

NOT FOR CONSTRUCTION ISSUED FOR PRICING

ISSUED FOR PERMIT ISSUED FOR CONSTRUCTION

SHEET TITLE:
ENLARGED
BUILDING PLAN BLDG. #1A - LVL. 7

DRAWING NO.

T3.10

ENLARGED TELECOM PLAN - BUILDING #1B - LEVEL 1 Scale: 1/8" = 1'-0"



Jordan & Skala Engineers
555 17th Street, Suite 700 • Denver, CO 80202
p. 303.586.2375

SHEET TITLE:
ENLARGED
BUILDING PLAN BLDG. #1B - LVL. 1 DRAWING NO.

NOT FOR CONSTRUCTION ISSUED FOR PRICING ISSUED FOR PERMIT

ISSUED FOR CONSTRUCTION

0/18/2024 12:42:17 PM

ENLARGED TELECOM PLAN - BUILDING #1B - LEVEL 2

Scale: 1/8" = 1'-0"

J S I Jordan & Skala Engineers

555 17th Street, Suite 700 • Denver, CO 80202
p. 303.586.2375

ISSUED FOR PRICING
ISSUED FOR PERMIT
ISSUED FOR CONSTRUCTION
SHEET TITLE:
ENLARGED
BUILDING PLAN BLDG. #1B - LVL. 2

DRAWING NO.

 $\begin{array}{c} \text{DRAWING NO.} \\ \textbf{T3.13} \end{array}$

NOT FOR CONSTRUCTION


GRANT STREET APARTMENTS
290 E. 17th Ave, Denver, CO 80203
A Development of
Abacus Capital Group

ENLARGED TELECOM PLAN - BUILDING #1B - LEVEL 3

Jordan & Skala Engineers
555 17th Street, Suite 700 • Denver, CO 80202
p. 303.586.2375

NOT FOR CONSTRUCTION ISSUED FOR PRICING ISSUED FOR CONSTRUCTION SHEET TITLE:
ENLARGED
BUILDING PLAN BLDG. #1B - LVL. 3

DRAWING NO. T3.14

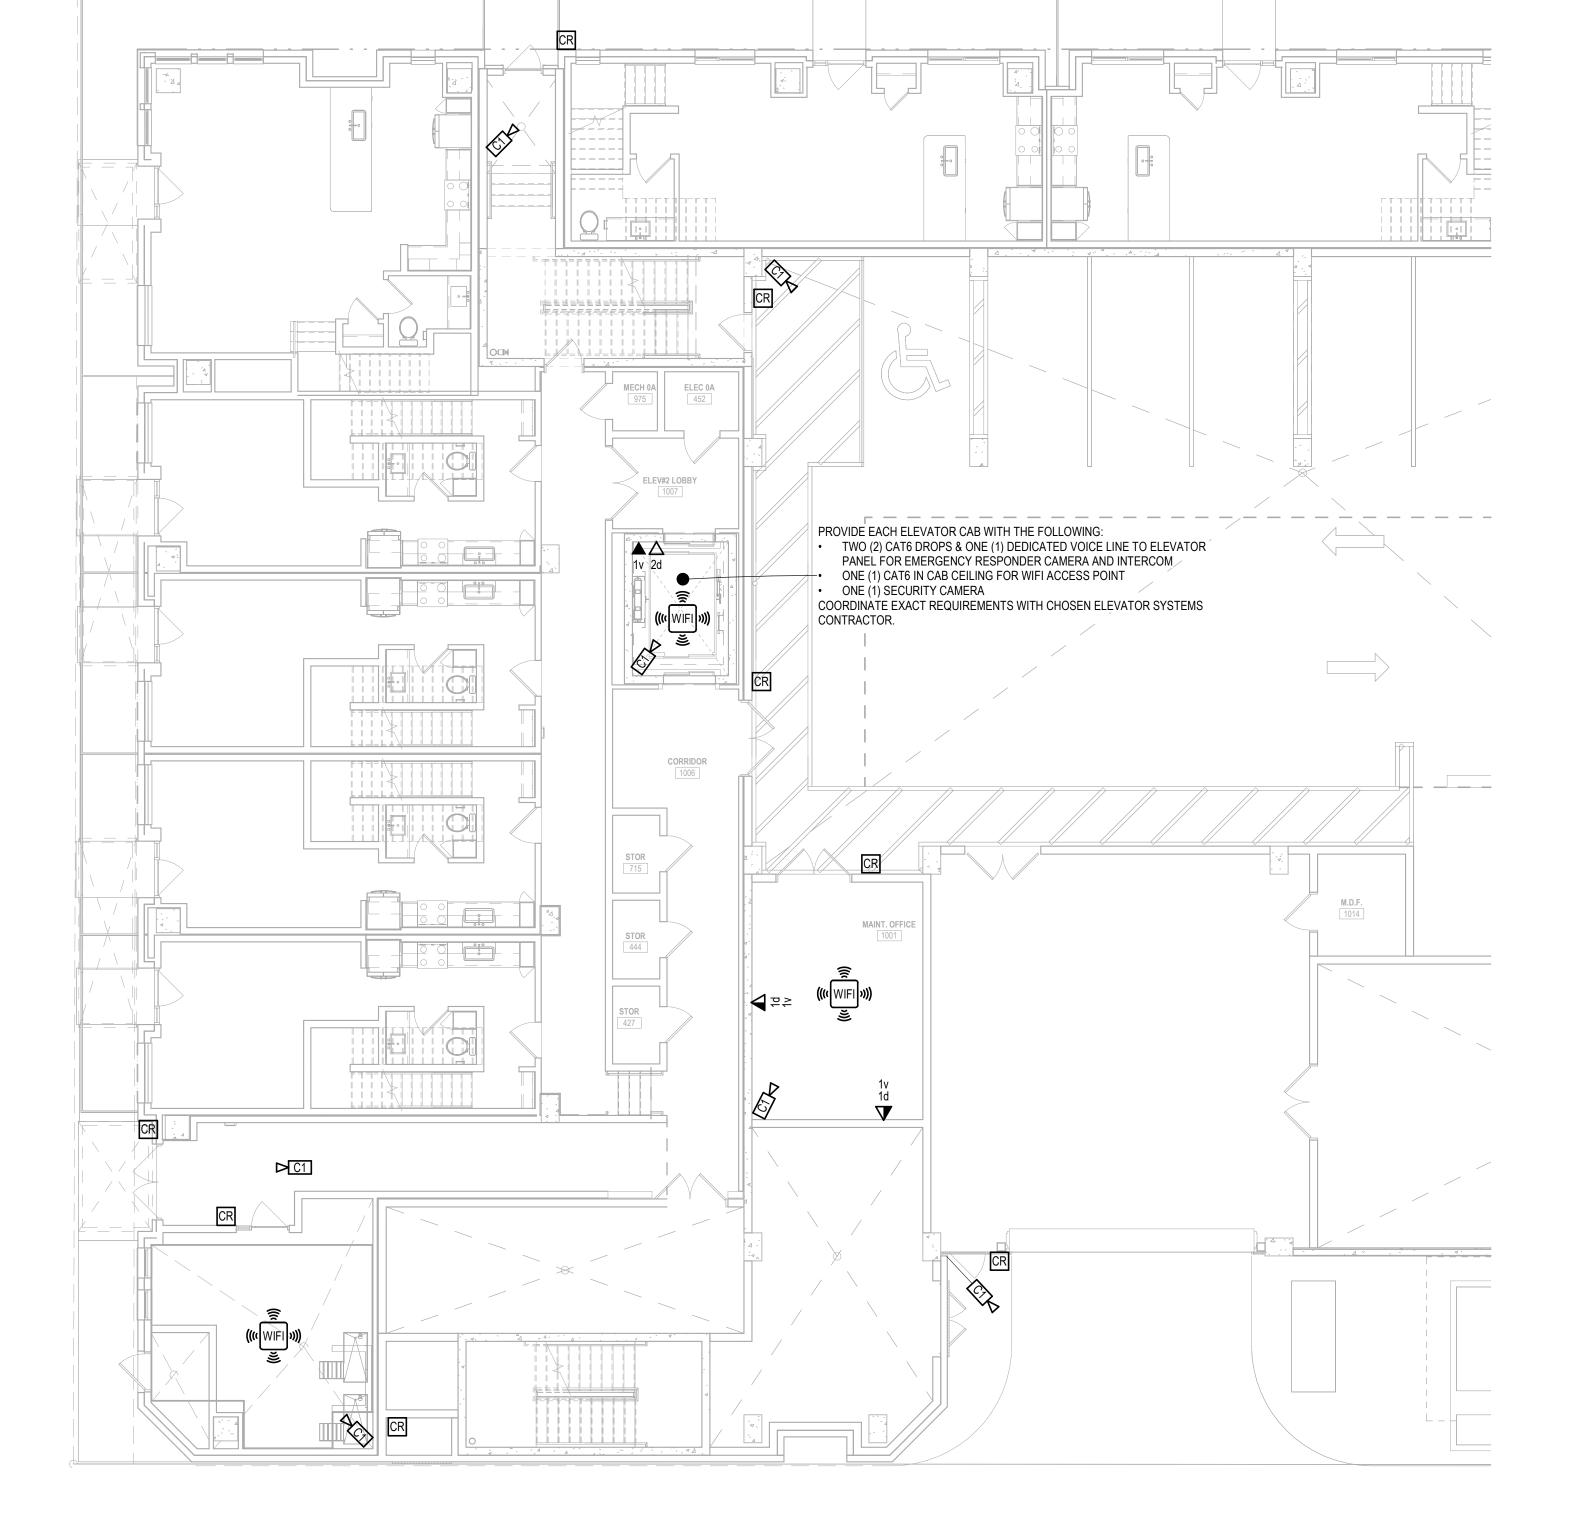

ENLARGED TELECOM PLAN - BUILDING #2 - LEVEL 1

Scale: 1/8" = 1'-0"




GRANT STREET APARTMENTS
290 E. 17th Ave, Denver, CO 80203
A Development of
Abacus Capital Group

NOT FOR CONSTRUCTION ISSUED FOR PRICING ISSUED FOR PERMIT ISSUED FOR CONSTRUCTION

SHEET TITLE:
ENLARGED
BUILDING PLAN BLDG. #2 - LVL. 1

DRAWING NO. T3.20

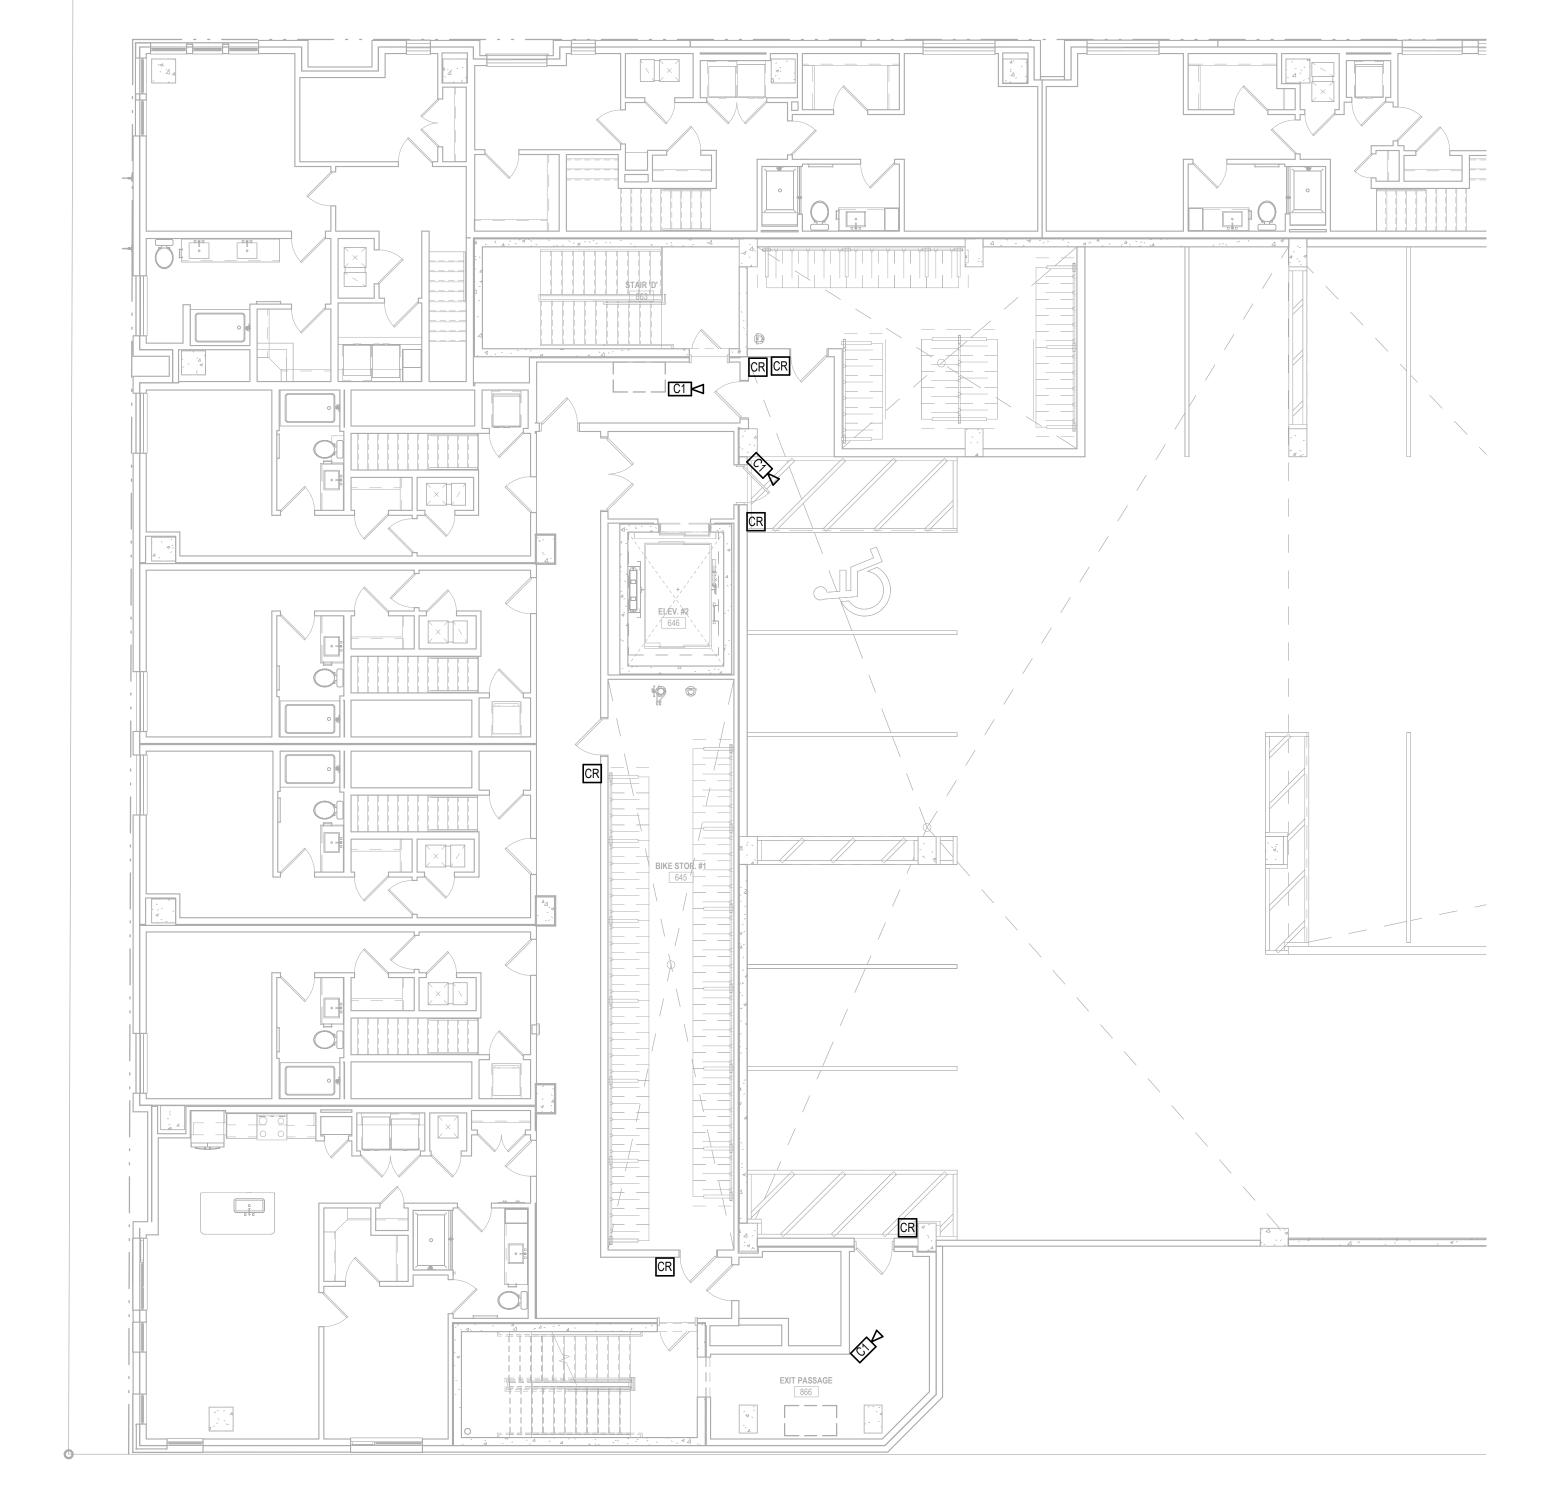

ENLARGED TELECOM PLAN - BUILDING #2 - LEVEL 2 Scale: 1/8" = 1'-0"

> Jordan & Skala Engineers
> 555 17th Street, Suite 700 • Denver, CO 80202
> p. 303.586.2375 Drawn By: Author Checked By: Checker

GRANT STREET APARTMENTS
290 E. 17th Ave, Denver, CO 80203
A Development of
Abacus Capital Group

NOT FOR CONSTRUCTION ISSUED FOR PRICING ISSUED FOR PERMIT ISSUED FOR CONSTRUCTION

SHEET TITLE:
ENLARGED
BUILDING PLAN BLDG. #2 - LVL. 2

DRAWING NO.



GRANT STREET APARTMENTS
290 E. 17th Ave, Denver, CO 80203
A Development of
Abacus Capital Group


NOT FOR CONSTRUCTION

ISSUED FOR PRICING ISSUED FOR PERMIT ISSUED FOR CONSTRUCTION

SHEET TITLE:
ENLARGED
BUILDING PLAN BLDG. #2 - LVL. 3

DRAWING NO. T3.22


Jordan & Skala Engineers
555 17th Street, Suite 700 • Denver, CO 80202
p. 303.586.2375 Checked By: Checker

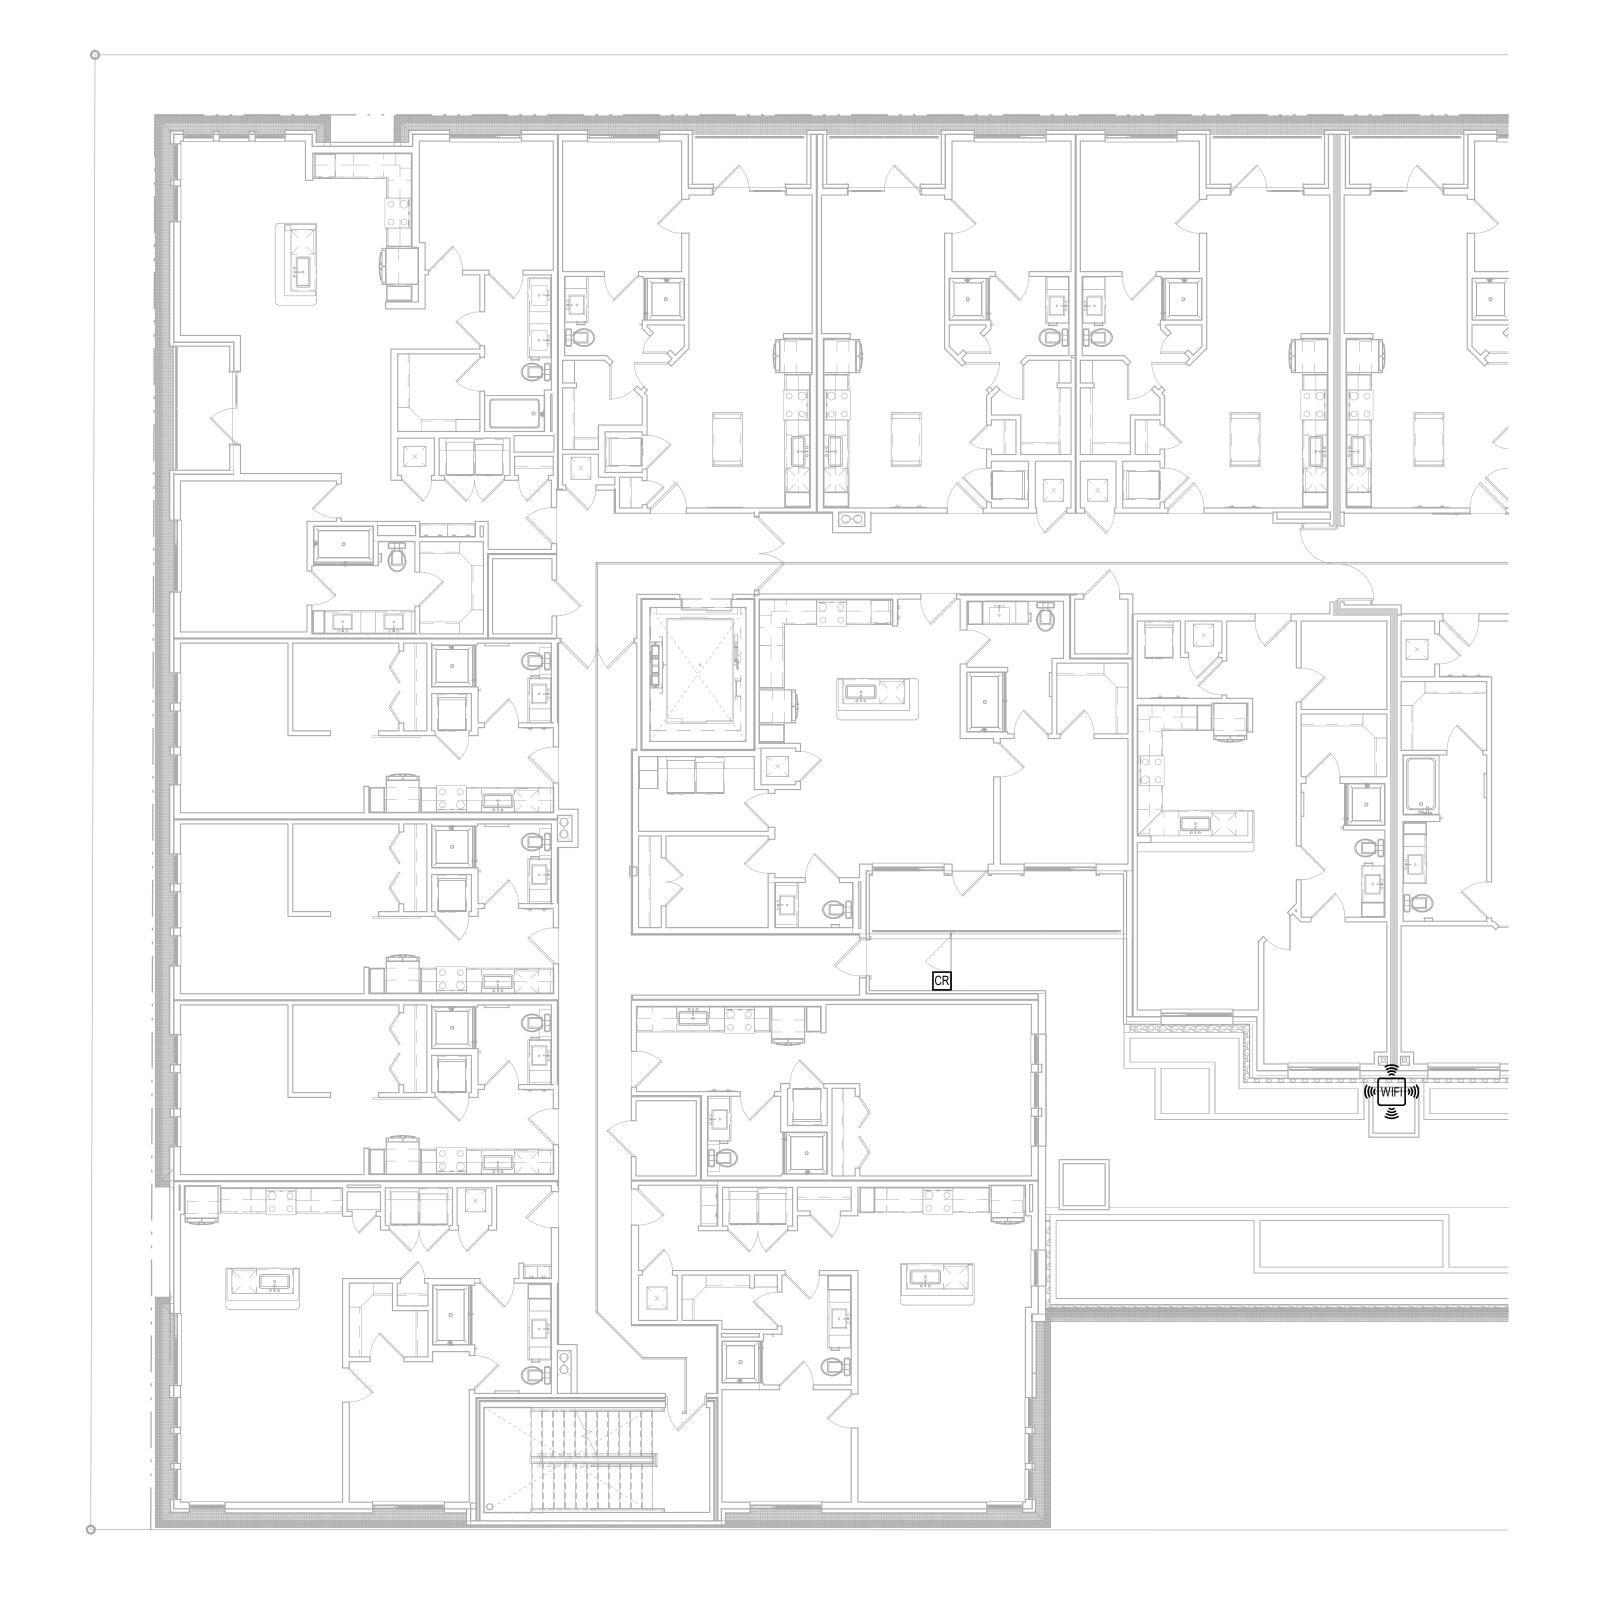



ENLARGED TELECOM PLAN - BUILDING #2 - LEVEL 3

Scale: 1/8" = 1'-0"




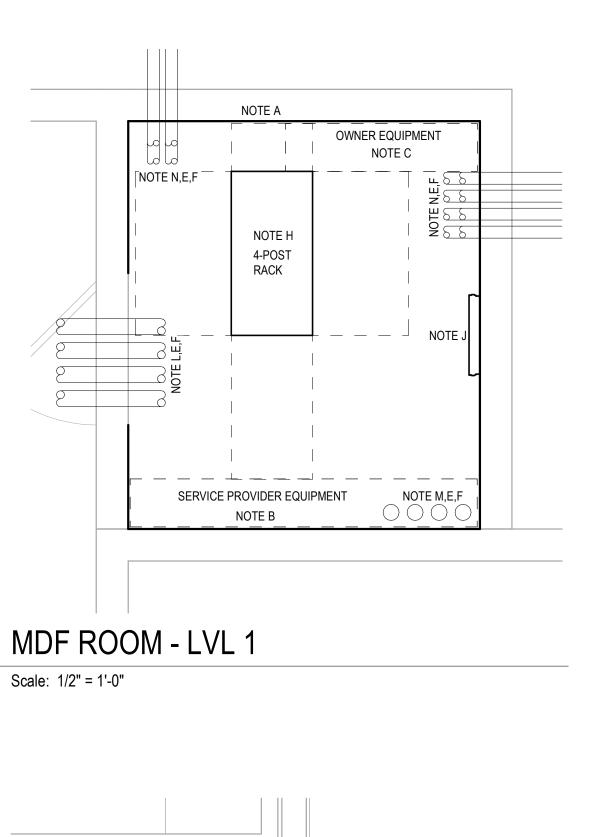

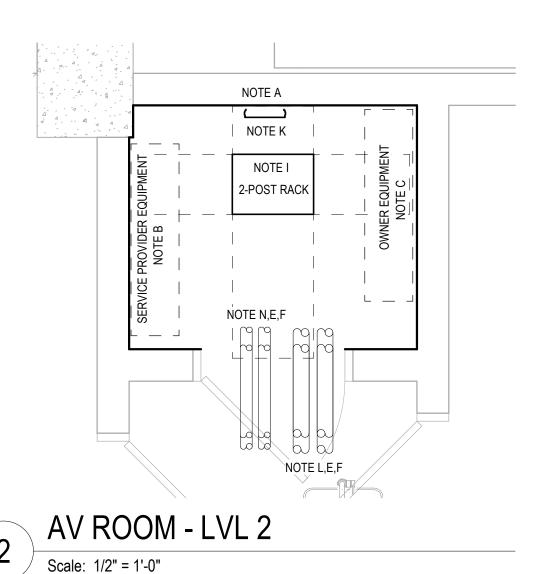


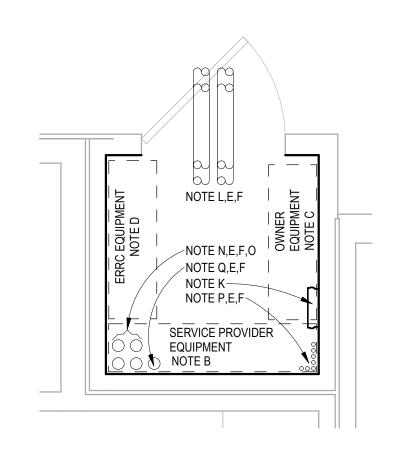


3 IDF ROOM A - LVL 3
Scale: 1/2" = 1'-0"

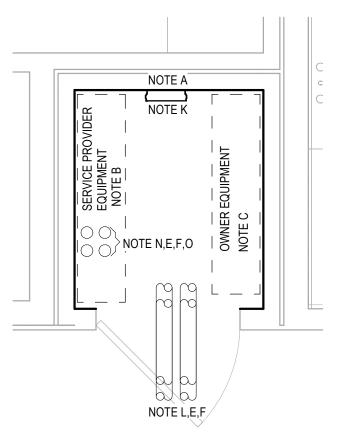

IDF ROOM B - LVL 3-6 TYP.

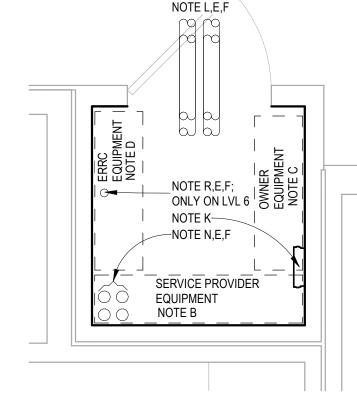

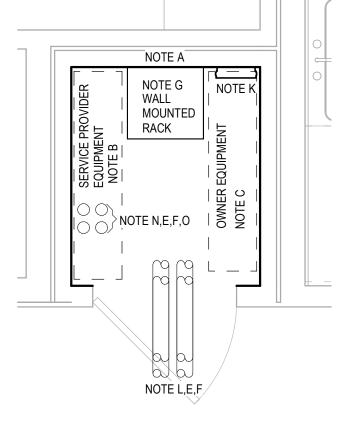

5 IDF ROOM A - LVL 4-6 TYP.


6 IDF ROOM B - LVL 7
Scale: 1/2" = 1'-0"

GENERAL NOTES:

- G-1 MINIMUM CEILING HEIGHT: SHALL BE AT LEAST 8 FT ABOVE FINISHED FLOOR.
- G-2 DOOR: FULLY OPENING LOCKABLE DOOR AT LEAST 3 FT WIDE AND 6.7 FT TALL. DOOR HINGED TO SWING OUT OF ROOM IS PREFERRED. AVOID USE OF SILLS TO EASE EQUIPMENT INSTALLATION AND REMOVAL. DOOR SHOULD BE REMOVABLE.
- G-3 POWER: EACH PRIME EQUIPMENT POWER OUTLET SHALL BE SUPPLIED BY A DEDICATED 110VAC, 20A CIRCUIT USING A QUAD NEMA 5-20R RECEPTACLE. OTHER OUTLETS SHALL BE QUAD NEMA 5-15R RECEPTACLES. OUTLETS LOCATED 16 INCHES AFF, TYPICAL.
- G-4 LIGHTING: PROVIDE SWITCHED LIGHTING TO ILLUMINATE EQUIPMENT AND WORK AREA.
- G-5 FLOORING: AVOID USE OF CARPET OR OTHER MATERIALS THAT COULD CAUSE BUILDUP OF STATIC ELECTRICITY.
- G-6 WALLS: INSTALL 3/4 INCH PLYWOOD BACKBOARDS ON ALL WALLS. BOTTOM EDGE SHALL BE APPROXIMATELY 36 INCHES ABOVE FINISHED FLOOR WITH TOP EDGE APPROXIMATELY 84 INCHES ABOVE FINISHED FLOOR. SEAL PLYWOOD WITH FIREPROOF PAINT (WHITE).
- G-7 ENVIRONMENTAL CONTROL: ENVIRONMENTAL CONTROLS SHALL BE SUFFICIENT TO MAINTAIN ROOM TEMPERATURE IN THE RANGE OF 64°F TO 75°F. INSTALL, AS A MINIMUM, A DEDICATED 1.5 TON CAPACITY COOLING UNIT. HVAC POWER SOURCE SHALL BE SEPARATE FROM OUTLETS SHOWN ON THIS SHEET.

TELECOM ROOM NOTES:

- A. PROVIDE 3/4" 4'x8' FIRE RESISTANT PLYWOOD, ORIENTED VERTICALLY, AS SHOWN. PLYWOOD SHALL BE PAINTED WITH TWO COATS OF FIRE RESISTANT PRIMER AND TWO COATS OF FIRE RESISTANT PAINT. TYPICAL ALL ROOMS.
- B. DEDICATED WALL SPACE FOR SERVICE PROVIDER EQUIPMENT. COORDINATE WITH THE SERVICE PROVIDER FOR EXACT REQUIREMENTS.
- C. DEDICATED WALL SPACE FOR ADDITIONAL NON-SERVICE PROVIDER EQUIPMENT, INCLUDING BUT NOT LIMITED TO OWNER FURNISHED EQUIPMENT & ACCESS CONTROL PANELS. COORDINATE WITH OWNER FOR EXACT REQUIREMENTS.
- D. DEDICATED WALL SPACE FOR EMERGENCY RESPONDER RADIO RESPONDER (ERRC) EQUIPMENT. COORDINATE EXACT SYSTEM REQUIREMENT WITH ERRC VENDOR.
- E. COORDINATE LOCATION OF CONDUITS WITH THE STRUCTURAL & ARCHITECTURAL DRAWINGS. RELOCATE IF NECESSARY. PROVIDE DRAWING WITH FINAL LAYOUT FOR APPROVAL AND FINAL RECORD.
- F. CONTRACTOR SHALL COORDINATE WITH STRUCTURAL DRAWINGS TO VERIFY THAT CORE DRILLING DOES NOT COMPROMISE STRUCTURAL INTEGRITY.
- G. 71.75"H x 19"W x 18"D WALL MOUNTED DATA RACK. RACK SHALL BE PROVIDED WITH TWO(2) 20AMP DEDICATED CIRCUITS, BY ELECTRICAL.
- H. 84"H x 21"W x 41"D FREE STANDING FOUR-POST DATA RACK. RACK SHALL BE PROVIDED WITH TWO (2) 20AMP DEDICATED CIRCUITS, BY ELECTRICAL.
- I. 84"H x 21"W x 15"D FREE STANDING TWO-POST DATA RACK. RACK SHALL BE PROVIDED WITH TWO(2) 20AMP DEDICATED CIRCUITS, BY ELECTRICAL.
- J. GROUNDING: INSTALL TELECOMMUNICATION MAIN GROUNDING BUSBAR (CHATSWORTH MODEL 40153 OR EQUIVALENT) IN LOCATION DEPICTED IN DRAWING.
- K. GROUNDING: INSTALL TELECOMMUNICATION GROUNDING BUSBAR(CHATSWORTH MODEL 13622-10 OR EQUIVALENT) IN LOCATION DEPICTED IN DRAWING.
- L. PROVIDE FOUR (4)-4" CONDUIT SLEEVES OVERHEAD INTO OPEN CEILING SPACE FOR HORIZONTAL CABLING HOME RUNS.
- M. FOUR (4)-4" CONDUITS, ROUTED UNDERGROUND, TO PROPERTY LINE. COORDINATE EXACT LOCATION WITH SERVICE PROVIDER(S) & CIVIL ENGINEER. SEE OVERALL FLOOR PLAN ON SHEET T3.00 FOR EXACT ROUTING.
- N. PROVIDE FOUR (4)-3" CONDUITS, FROM LEVEL 1 MDF ROOM TO EACH IDF ROOM STACK & AV ROOM. SEE
- OVERALL FLOOR PLANS & RISER DIAGRAM FOR EXACT NUMBER, ROUTING AND LOCATION OF CONDUITS.
- O. PROVIDE FOUR (4)-3" SLEEVES BETWEEN STACKED IDF ROOM.
- P. PROVIDE ONE (1)-1" CONDUIT, FROM EACH TOWNHOME STYLE UNIT TO THE NEAREST TELECOM ROOM FOR SMC PANEL HOME RUN. SEE SHEET T3.00 FOR EXACT FOR EXACT NUMBER, ROUTING, AND LOCATION OF CONDUITS.
- Q. PROVIDE ONE (1)-3" CONDUIT, FROM LEVEL 2 TOWNHOME STYLE UNIT CORRIDOR TO THE NEAREST TELECOM ROOM FOR SMC PANEL HOME RUN. SEE SHEET T3.00 FOR EXACT FOR EXACT NUMBER, ROUTING, AND LOCATION OF CONDUITS.
- R. PROVIDE ONE (1)-2" CONDUIT FROM LEVEL 6 IDF ROOM A , STUBBING PASS LEVEL 7 MECHANICAL ROOM TO ROOF FOR ERRC BACKBONE CABLING.

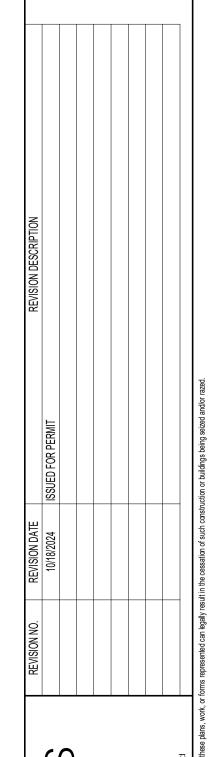

MEEKS PARTNE
16000 Memorial Drive
Suite 100
Houston, Texas 77079
281.558.8787

E. 17th Ave, Denver, CO 8
A Development of

OB NO.: 22035


NOT FOR CONSTRUCTION
ISSUED FOR PRICING
ISSUED FOR PERMIT
ISSUED FOR CONSTRUCTION

SHEET TITLE:
ENLARGED
TELECOM ROOM


 $\begin{array}{c} \text{PLAN} \\ \text{DRAWING NO.} \\ \hline \hline \hline \hline \\ \hline \hline \\ \hline \end{array}$

Jordan & Skala Engineers
555 17th Street, Suite 700 • Denver, CO 80202
p. 303.586.2375

Project Number: 23080076 Drawn By: Author Checked By: Checker

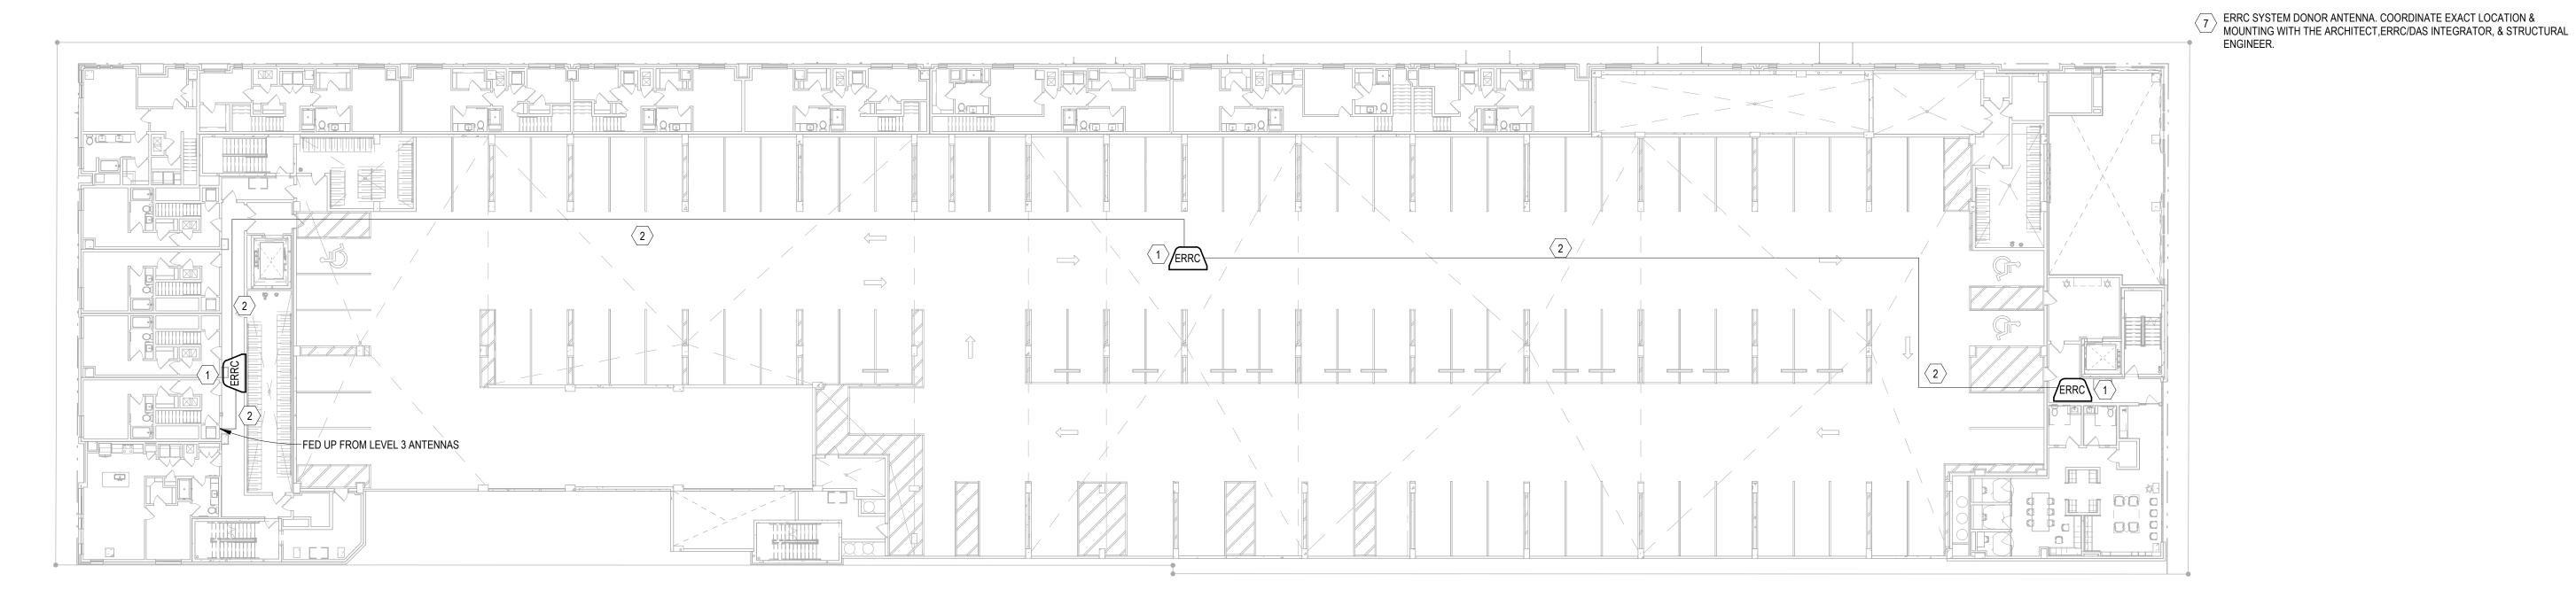

OVERALL ERRC PLAN - LEVEL 2 Scale: 1" = 20'-0"

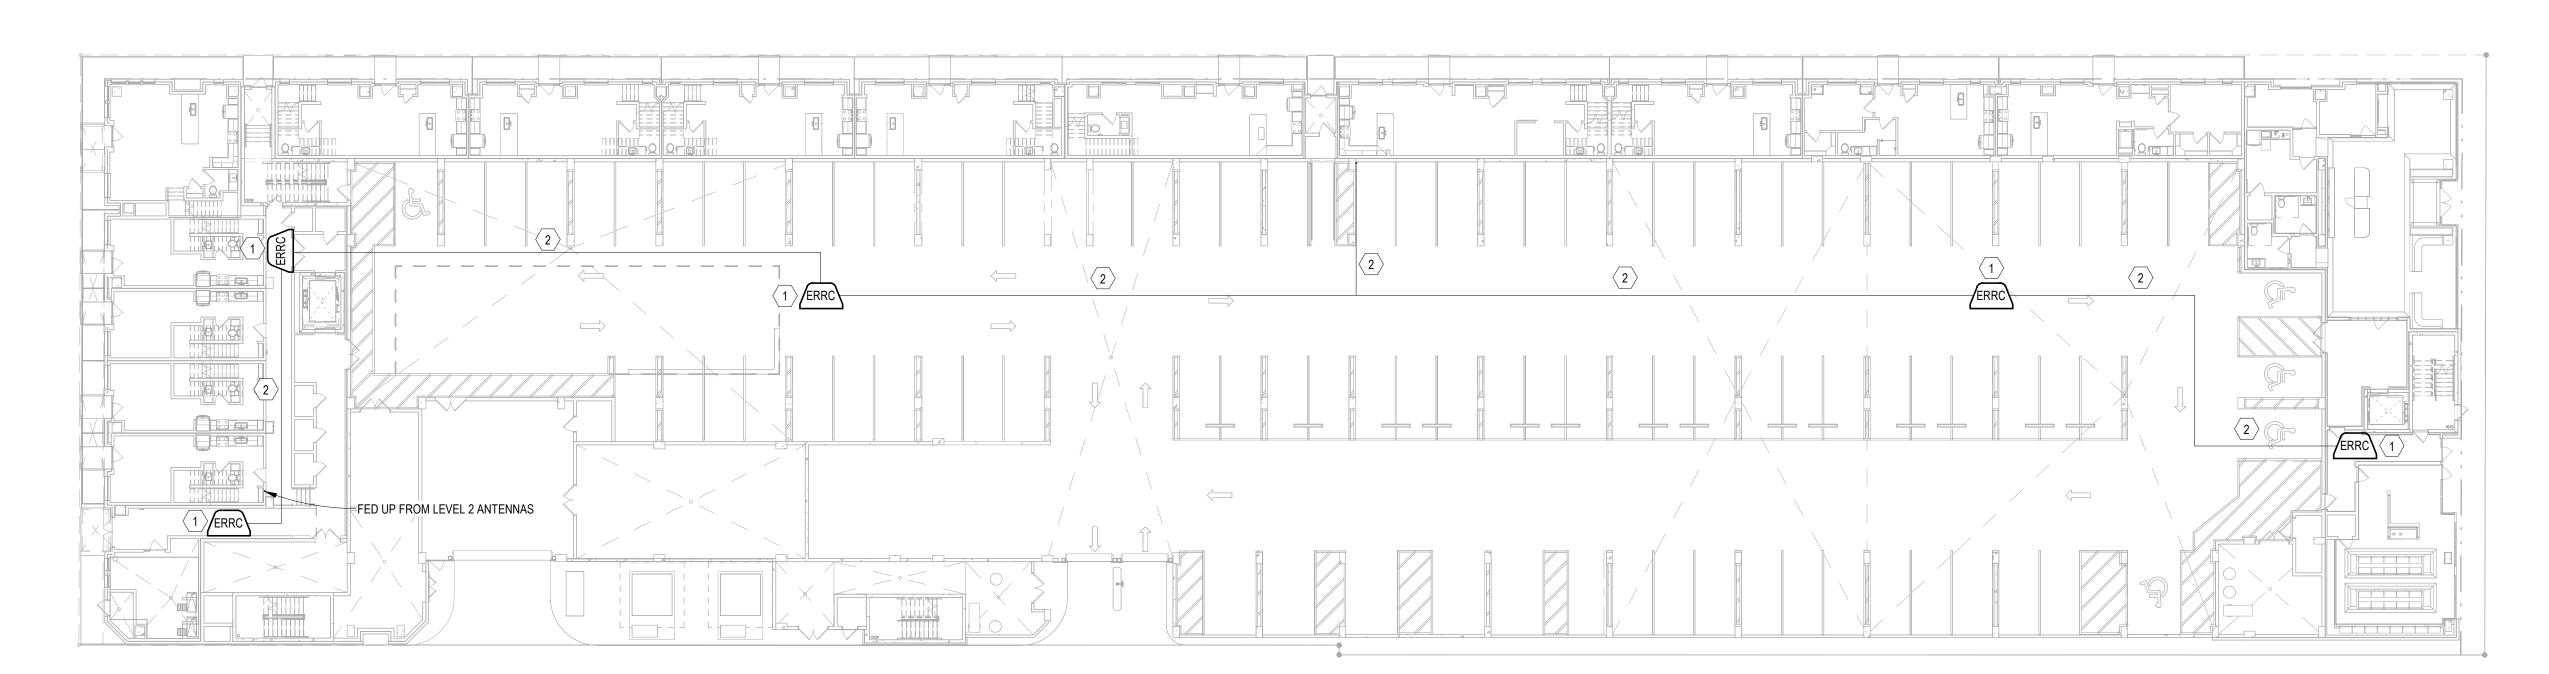

OVERALL ERRC PLAN - LEVEL 1 Scale: 1" = 20'-0"



KEY NOTES: ERRC SYSTEM

REQUIREMENTS.

1 EMERGENCY RESPONDER RADIO COVERAGE (ERRC) SYSTEM REPEATER ANTENNA; SEE SHEETS T0.10 FOR ADDITIONAL INFORMATION &

ONE (1)-1/2" HELIAX COAXIAL CABLE RUN OVERHEAD, DAISY CHAINED BETWEEN ANTENNAS. HOME RUN TO CLOSEST BDA/ REMOTE BDA ROOM. COORDINATE ROUTING WITH ARCHITECT TO AVOID OBSTRUCTIONS.

ONE (1)-2" CONDUIT ERRC SYSTEM BACKBONE/ FEEDER/ RISER COAXIAL CABLING BETWEEN ROOFTOP DONOR ANTENNA AND BDA ROOM.

COAXIAL SPLITTER; CONFIRM EXACT SPLITTER SIZES REQUIRED WITH THE ERRC SYSTEM INTEGRATOR OR INSTALLER.

RUN ONE (1) 1/2" COAXIAL CABLE FROM BI-DIRECTIONAL AMPLIFIER TO ERRC SYSTEM DONOR ANTENNA, VIA ONE (1)-2" CONDUIT, AIMED TOWARDS THE JURISDICTION'S PUBLIC SAFETY RADIO REPEATER SITE.

GROUNDED LIGHTING ARRESTOR LOCATED OUTSIDE BEFORE CABLE BUILDING ENTRY.

Checked By: Checker Drawn By: Author

Jordan & Skala Engineers
555 17th Street, Suite 700 • Denver, CO 80202
p. 303.586.2375

DRAWING NO. T4.00

PARTNE

MEEKS

GRANT STREET APARTMENTS 290 E. 17th Ave, Denver, CO 80203

A Development of Abacus Capital Group


NOT FOR CONSTRUCTION ISSUED FOR PRICING

ISSUED FOR PERMIT ISSUED FOR CONSTRUCTION


SHEET TITLE:
OVERALL BUILDING
ERRC PLAN - LEVEL
1 & 2

KEY NOTES: ERRC SYSTEM

- 1 EMERGENCY RESPONDER RADIO COVERAGE (ERRC) SYSTEM REPEATER ANTENNA; SEE SHEETS T0.10 FOR ADDITIONAL INFORMATION & REQUIREMENTS.
- ONE (1)-1/2" HELIAX COAXIAL CABLE RUN OVERHEAD, DAISY CHAINED BETWEEN ANTENNAS. HOME RUN TO CLOSEST BDA/ REMOTE BDA ROOM. COORDINATE ROUTING WITH ARCHITECT TO AVOID OBSTRUCTIONS.
- ONE (1)-2" CONDUIT ERRC SYSTEM BACKBONE/ FEEDER/ RISER COAXIAL CABLING BETWEEN ROOFTOP DONOR ANTENNA AND BDA ROOM.
- COAXIAL SPLITTER; CONFIRM EXACT SPLITTER SIZES REQUIRED WITH THE ERRC SYSTEM INTEGRATOR OR INSTALLER.
- RUN ONE (1) 1/2" COAXIAL CABLE FROM BI-DIRECTIONAL AMPLIFIER TO ERRC SYSTEM DONOR ANTENNA, VIA ONE (1)-2" CONDUIT, AIMED TOWARDS THE JURISDICTION'S PUBLIC SAFETY RADIO REPEATER SITE.
- GROUNDED LIGHTING ARRESTOR LOCATED OUTSIDE BEFORE CABLE BUILDING ENTRY.
- 7 ERRC SYSTEM DONOR ANTENNA. COORDINATE EXACT LOCATION & MOUNTING WITH THE ARCHITECT, ERRC/DAS INTEGRATOR, & STRUCTURAL ENGINEER.

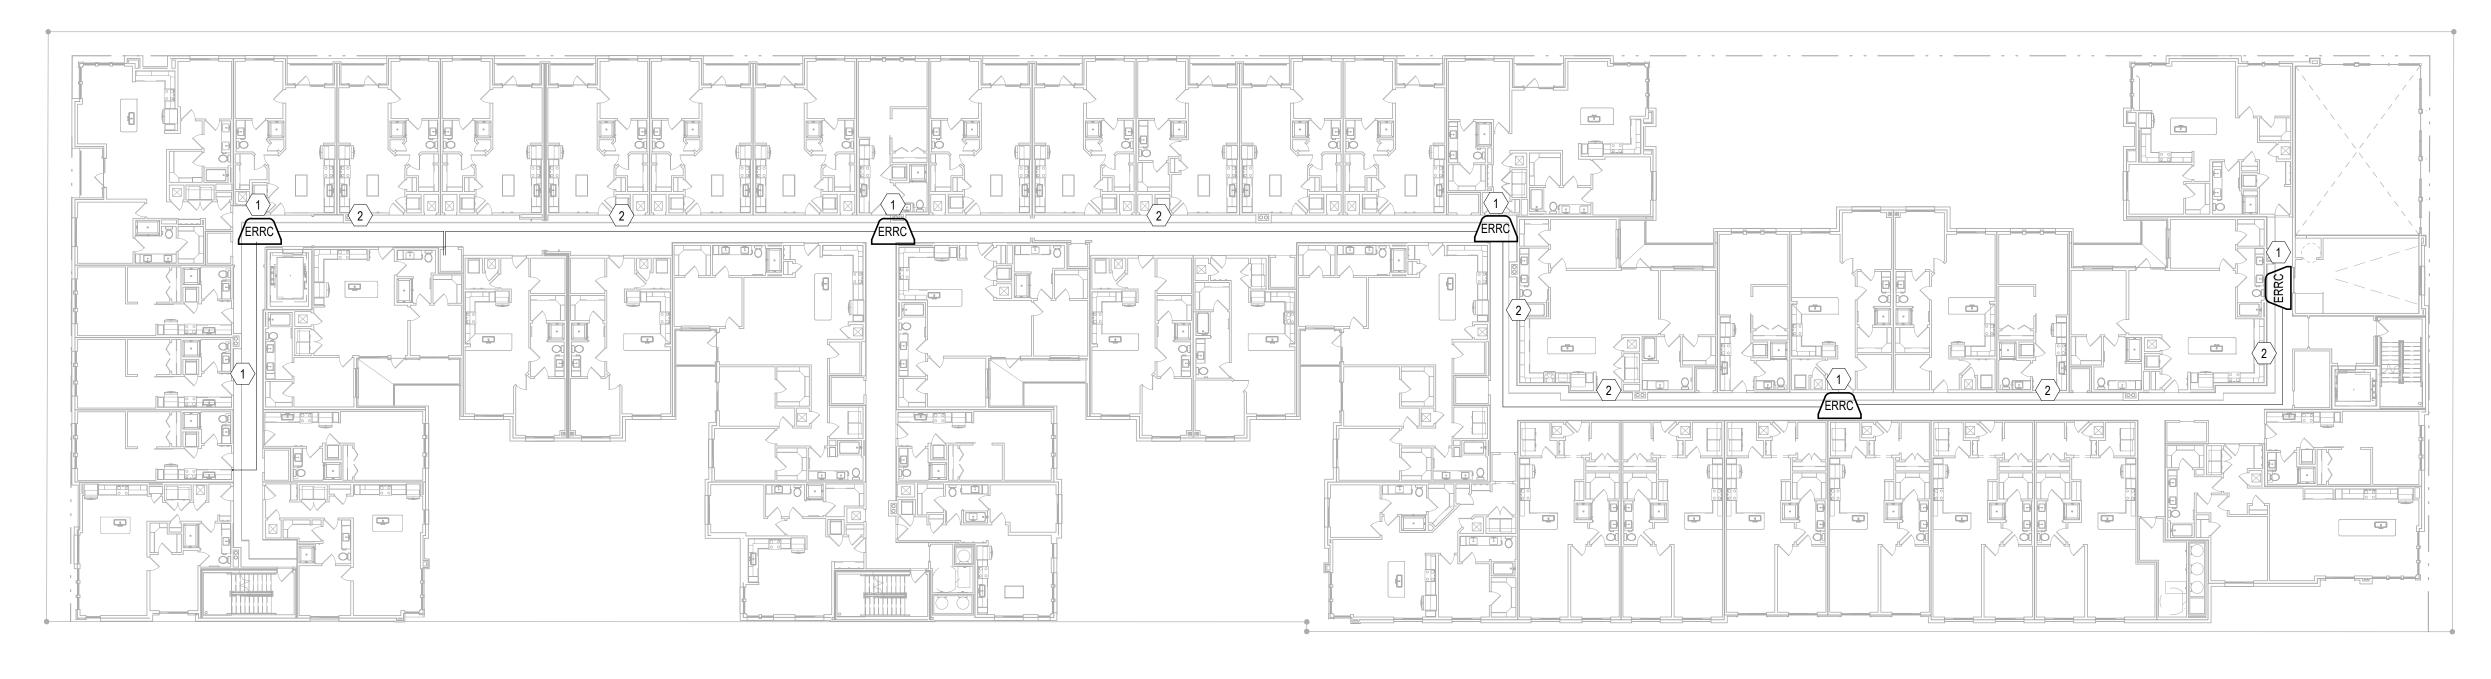

OVERALL ERRC PLAN - LEVEL 4 Scale: 1" = 20'-0"

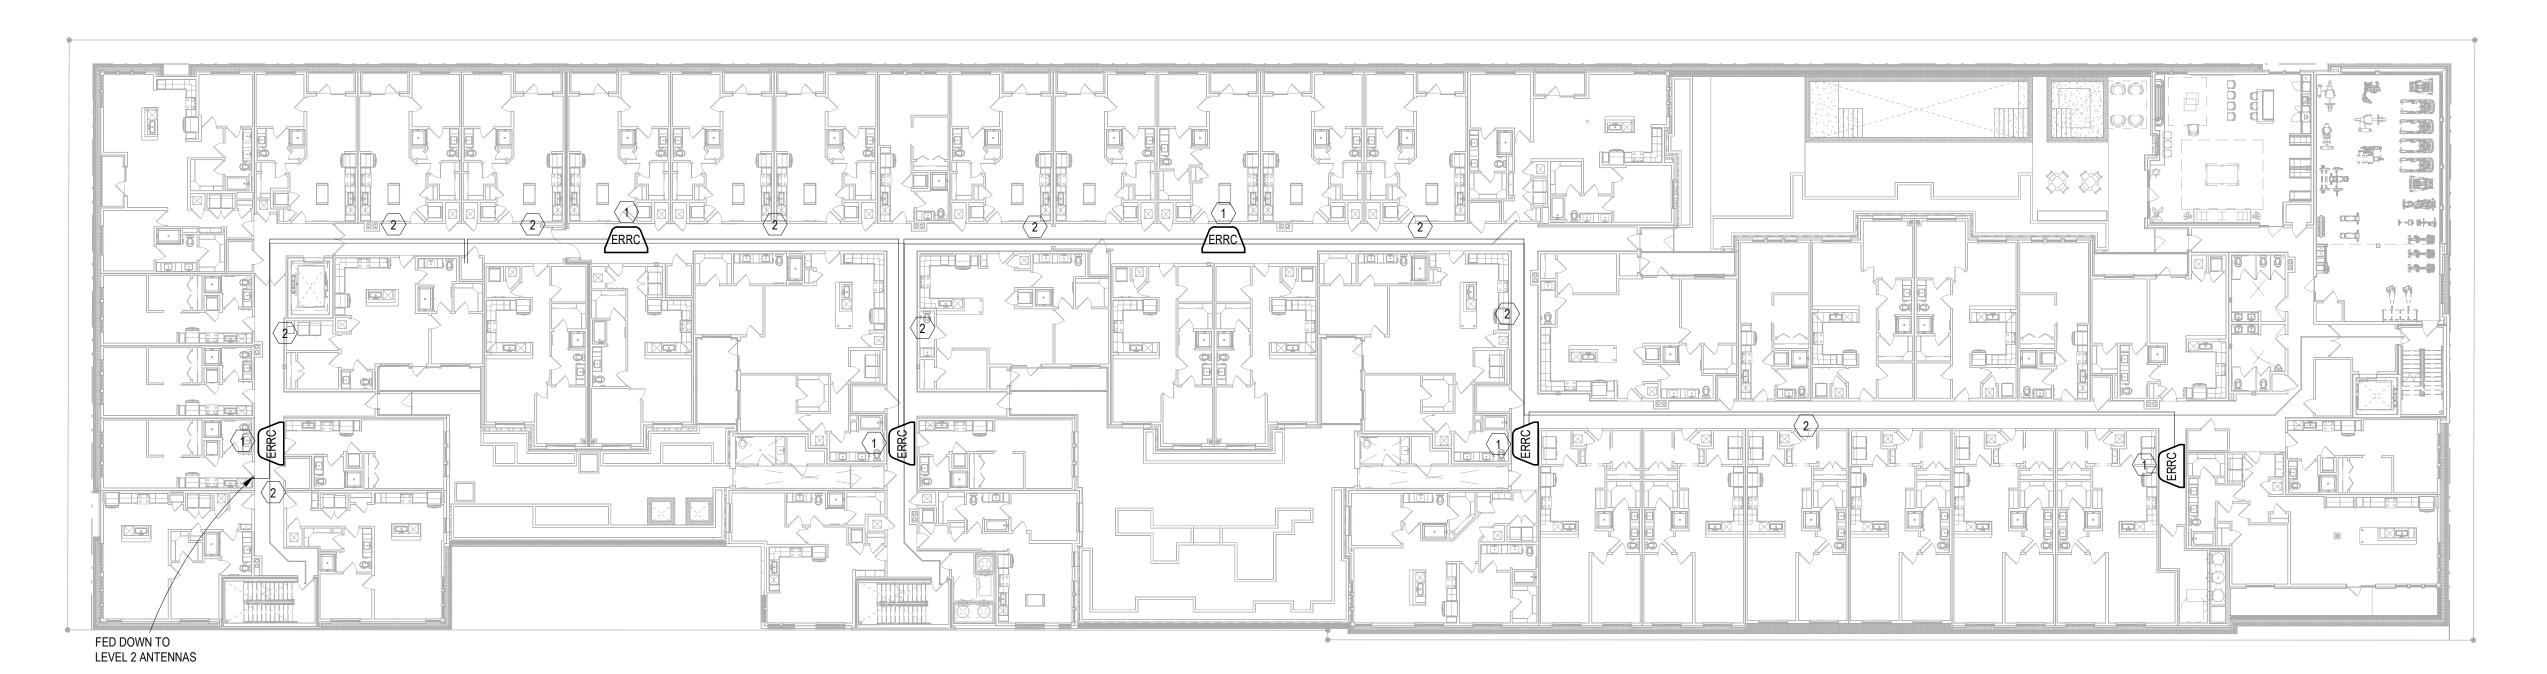

OVERALL ERRC PLAN - LEVEL 3 Scale: 1" = 20'-0"

Jordan & Skala Engineers
555 17th Street, Suite 700 • Denver, CO 80202
p. 303.586.2375

SHEET TITLE:
OVERALL BUILDING
ERRC PLAN - LEVEL
3 & 4 DRAWING NO.

T4.01

NOT FOR CONSTRUCTION ISSUED FOR PRICING ISSUED FOR PERMIT

ISSUED FOR CONSTRUCTION

ONE (1)-1/2" HELIAX COAXIAL CABLE RUN OVERHEAD, DAISY CHAINED BETWEEN ANTENNAS. HOME RUN TO CLOSEST BDA/ REMOTE BDA ROOM. COORDINATE ROUTING WITH ARCHITECT TO AVOID OBSTRUCTIONS.


ONE (1)-2" CONDUIT ERRC SYSTEM BACKBONE/ FEEDER/ RISER COAXIAL CABLING BETWEEN ROOFTOP DONOR ANTENNA AND BDA ROOM.

COAXIAL SPLITTER; CONFIRM EXACT SPLITTER SIZES REQUIRED WITH THE ERRC SYSTEM INTEGRATOR OR INSTALLER.


RUN ONE (1) 1/2" COAXIAL CABLE FROM BI-DIRECTIONAL AMPLIFIER TO ERRC SYSTEM DONOR ANTENNA, VIA ONE (1)-2" CONDUIT, AIMED TOWARDS THE JURISDICTION'S PUBLIC SAFETY RADIO REPEATER SITE.

GROUNDED LIGHTING ARRESTOR LOCATED OUTSIDE BEFORE CABLE BUILDING ENTRY.

7 ERRC SYSTEM DONOR ANTENNA. COORDINATE EXACT LOCATION & MOUNTING WITH THE ARCHITECT, ERRC/DAS INTEGRATOR, & STRUCTURAL ENGINEER.

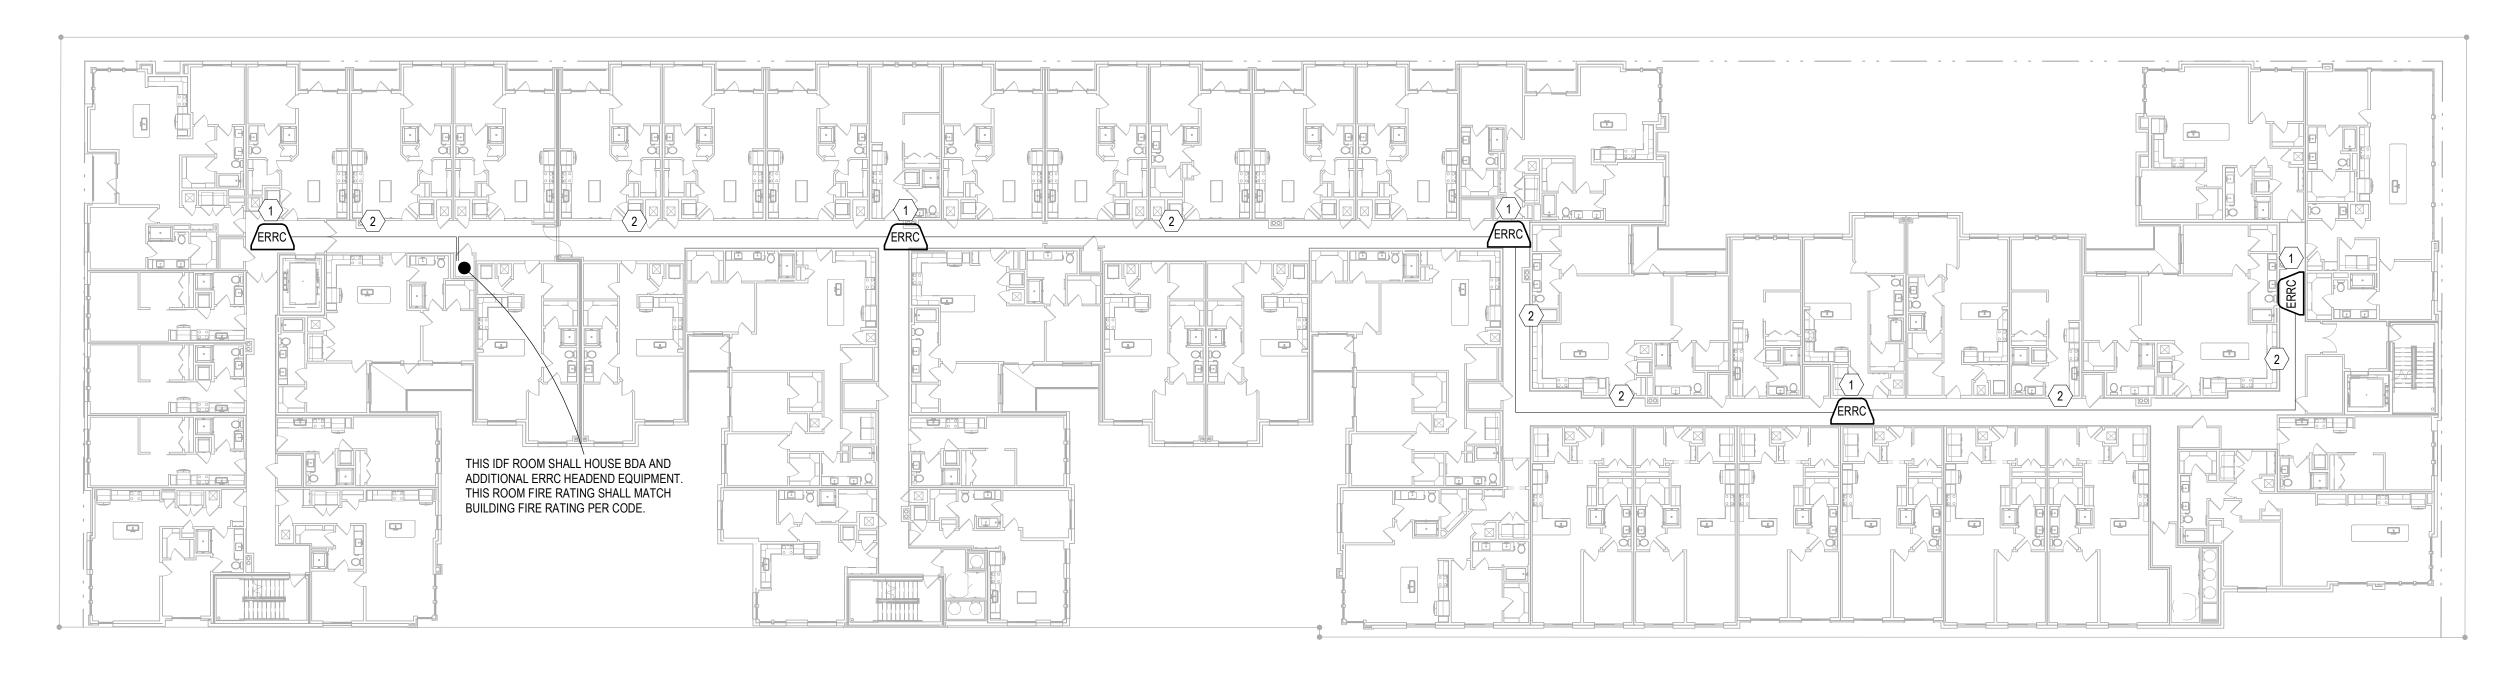

OVERALL ERRC PLAN - LEVEL 6 Scale: 1" = 20'-0"

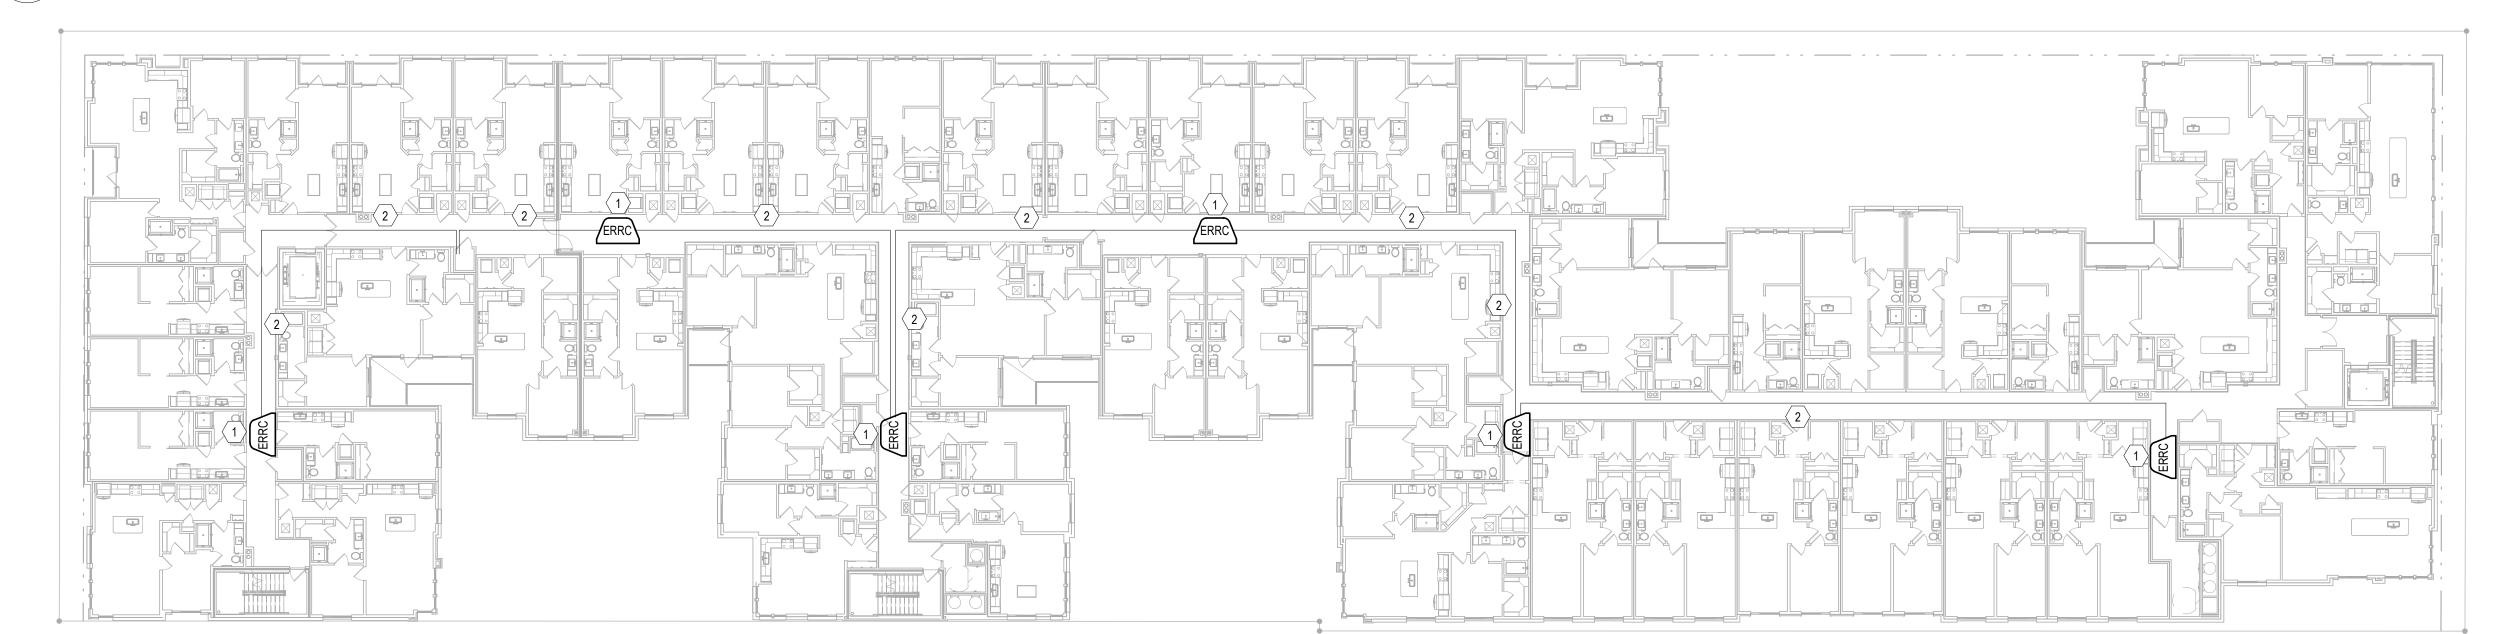

OVERALL ERRC PLAN - LEVEL 5 Scale: 1" = 20'-0"

Jordan & Skala Engineers
555 17th Street, Suite 700 • Denver, CO 80202
p. 303.586.2375

DRAWING NO.

NOT FOR CONSTRUCTION ISSUED FOR PRICING ISSUED FOR PERMIT ISSUED FOR CONSTRUCTION

SHEET TITLE:
OVERALL BUILDING
ERRC PLAN - LEVEL
5 & 6

T4.02

ONE (1)-1/2" HELIAX COAXIAL CABLE RUN OVERHEAD, DAISY CHAINED BETWEEN ANTENNAS. HOME RUN TO CLOSEST BDA/ REMOTE BDA ROOM. COORDINATE ROUTING WITH ARCHITECT TO AVOID OBSTRUCTIONS.


ONE (1)-2" CONDUIT ERRC SYSTEM BACKBONE/ FEEDER/ RISER COAXIAL CABLING BETWEEN ROOFTOP DONOR ANTENNA AND BDA ROOM.

COAXIAL SPLITTER; CONFIRM EXACT SPLITTER SIZES REQUIRED WITH THE ERRC SYSTEM INTEGRATOR OR INSTALLER.

RUN ONE (1) 1/2" COAXIAL CABLE FROM BI-DIRECTIONAL AMPLIFIER TO ERRC SYSTEM DONOR ANTENNA, VIA ONE (1)-2" CONDUIT, AIMED TOWARDS THE JURISDICTION'S PUBLIC SAFETY RADIO REPEATER SITE.


GROUNDED LIGHTING ARRESTOR LOCATED OUTSIDE BEFORE CABLE BUILDING ENTRY.

7 ERRC SYSTEM DONOR ANTENNA. COORDINATE EXACT LOCATION & MOUNTING WITH THE ARCHITECT, ERRC/DAS INTEGRATOR, & STRUCTURAL ENGINEER.

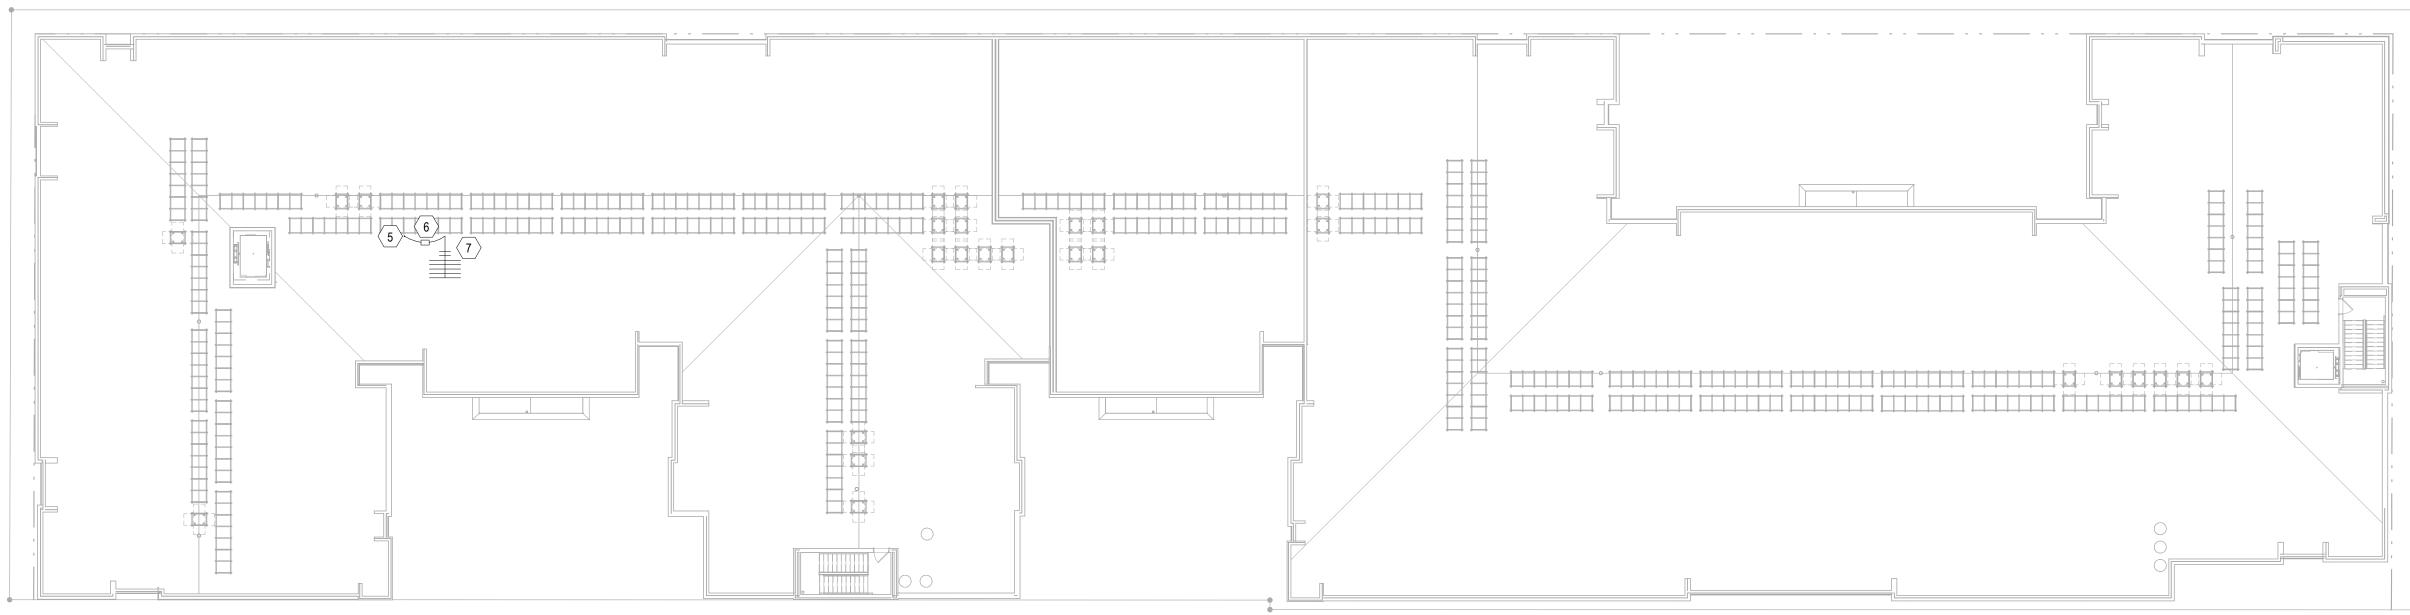

OVERALL ERRC PLAN - ROOF

Scale: 1" = 20'-0"

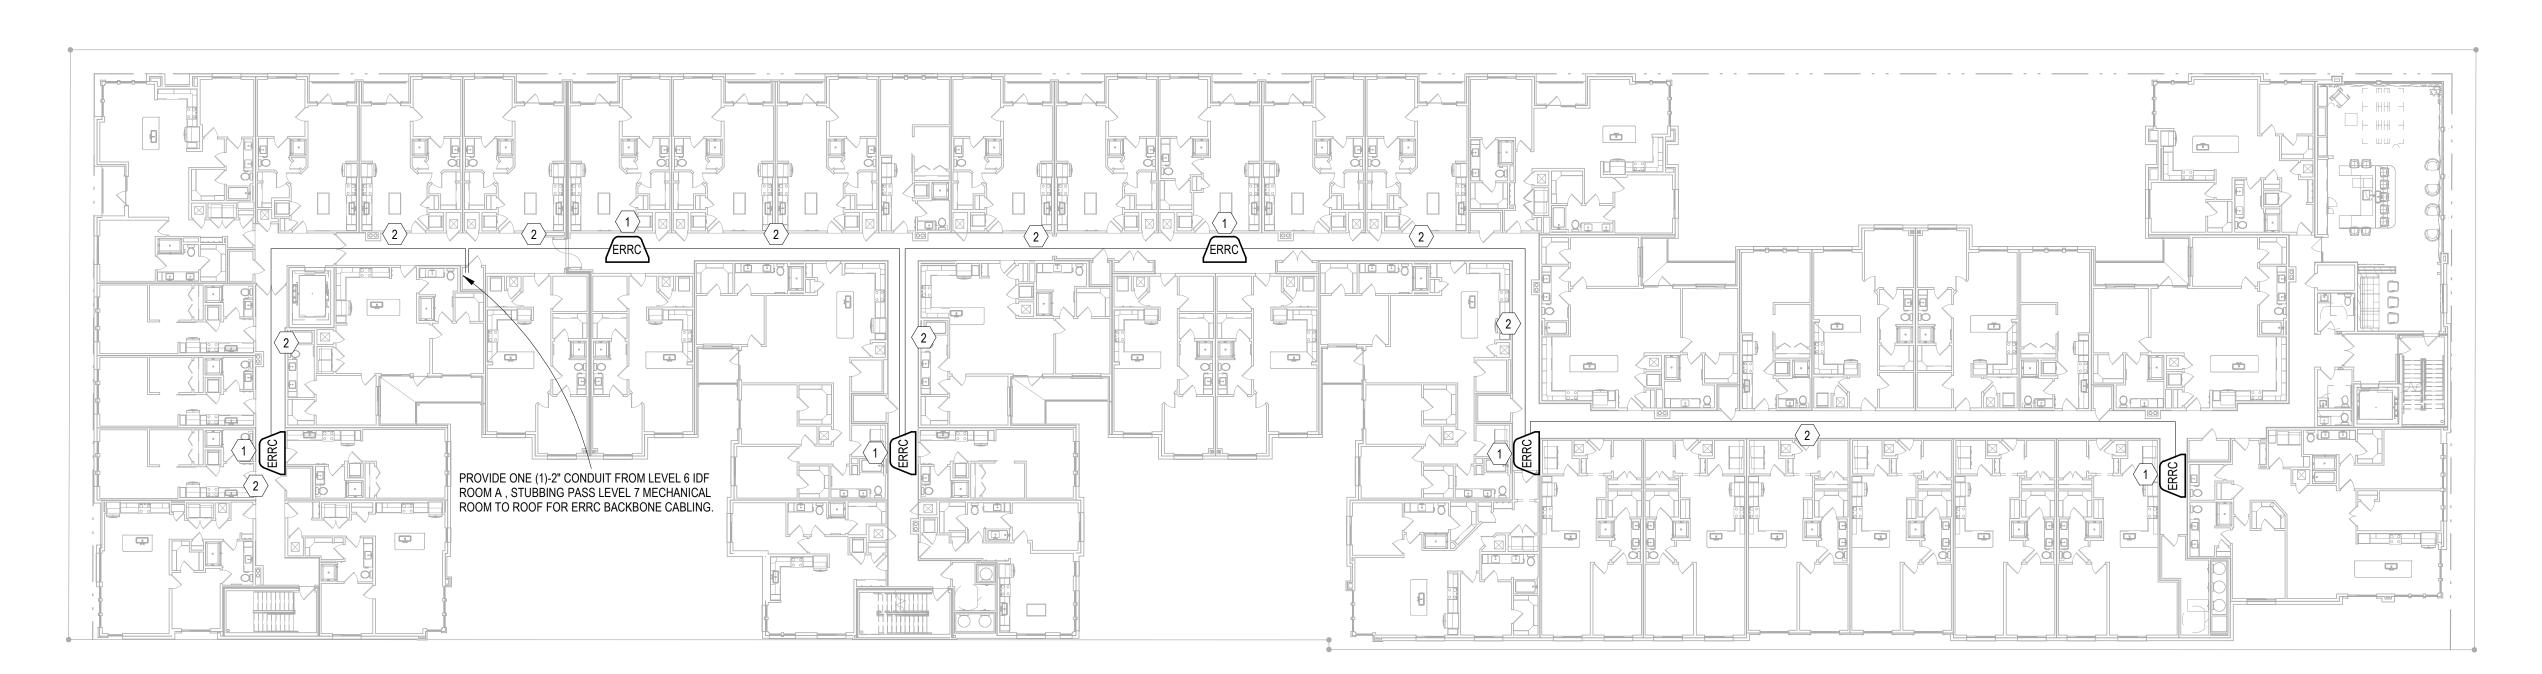

OVERALL ERRC PLAN - LEVEL 7 Scale: 1" = 20'-0"



DRAWING NO. T4.03

Jordan & Skala Engineers
555 17th Street, Suite 700 • Denver, CO 80202
p. 303.586.2375

NOT FOR CONSTRUCTION

ISSUED FOR PRICING ISSUED FOR PERMIT ISSUED FOR CONSTRUCTION SHEET TITLE:
OVERALL BUILDING
ERRC PLAN - LEVEL
7 & ROOF