





# MERCY HOMES

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BROOKLYN, NY 11215

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**OWNER/DEVELOPER:**

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Structural Engineer

**STRUCTURAL COMPANY:**

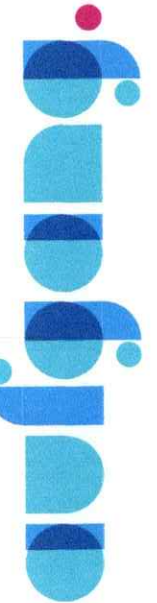
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**MEP COMPANY:**

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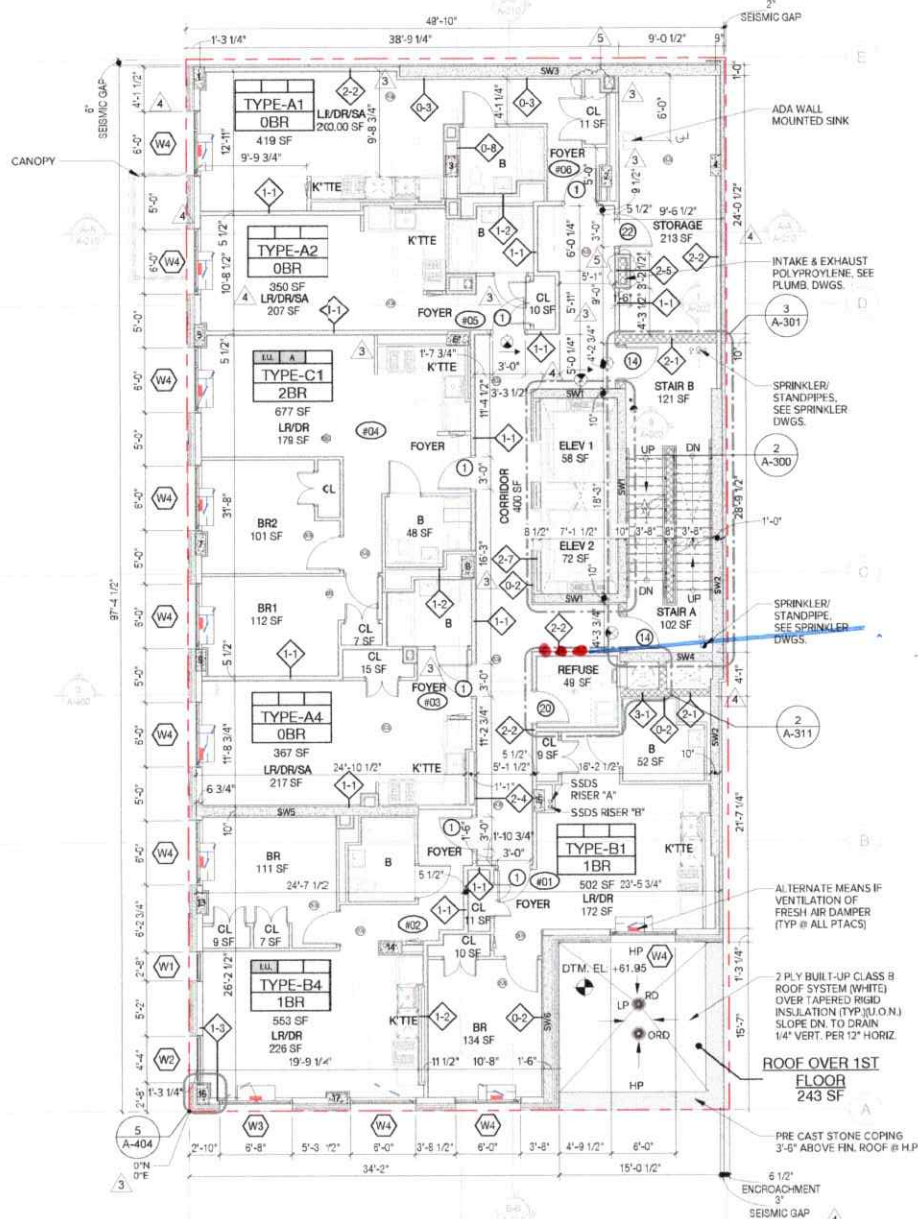
## ROOF NOTES:

### ROOFING AND PAVING:

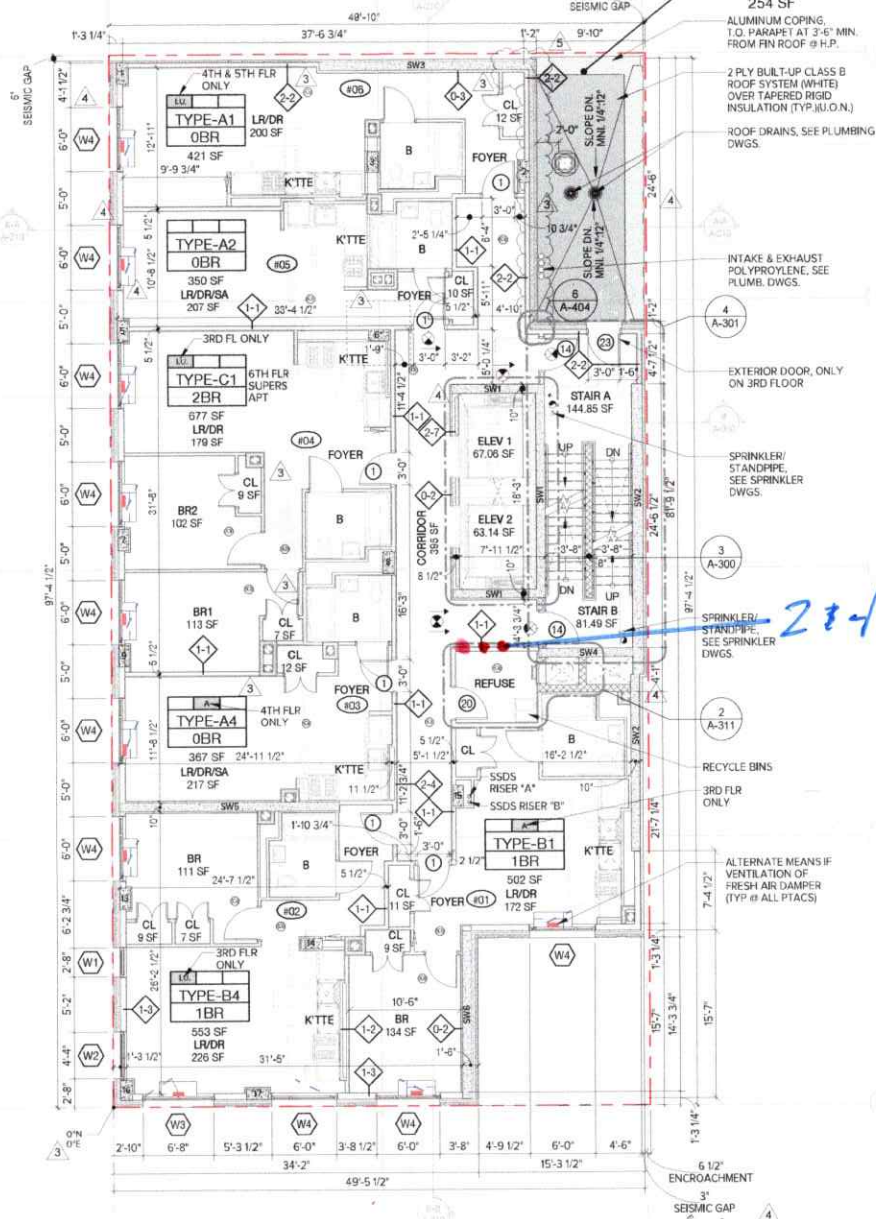
- 1) PROVIDE CLASS B ROOF SYSTEM
- 2) ROOFING SHALL BE WHITE IN COLOR
- 3) PROVIDE INSULATED PRE-FABRICATED METAL CURBS @ ALL ROOF TOP EQUIPMENT
- 4) PROVIDE CRACKS @ ALL ROOF TOP EQUIPMENT WITH POSITIVE SLOPE TO ROOF DRAIN

### REDUCED HEAT ISLAND EFFECT:

1. USE ENERGY STAR COMPLIANT AND HIGH EMISSIVE ROOFING FOR 100% OF THE ENTIRE ROOF
2. NOTE THAT ENERGY STAR-CERTIFIED PRODUCTS WILL HAVE BOTH AN INITIAL AND A MAINTAINED SOLAR REFLECTANCE VALUE
3. USE LIGHT COLORED/HIGH ALBEDO MATERIALS FOR HARDCAPED AREAS
4. PROVIDE SOLAR REFLECTANCE INDEX (SRI) OF 78 OR HIGHER



2ND FLOOR PLAN  
1/8" = 1'-0"



3RD - 6TH FLOOR PLAN  
1/8" = 1'-0"

## WALL TYPE LEGEND

NOTE: G.C. SHALL SUBMIT SHOP DRAWINGS TO ARCHITECT FOR REVIEW INDICATING SIZE, GAUGE AND SPACING OF ALL METAL STUDS AND REQUIRED METAL BOXED HEADERS.

- (2) 2 HR RATED  
2-1 2 HR RATED CMU WALL - CMU (CLASS D-2) CONT. GALVANIZED HORIZONTAL TRUSS TYPE REINFORCING @ ALTERNATIVE BLOCK COURSES. SEAL TOP OF CONCRETE BLOCK WALL TIGHT TO UNDERSIDE OF FLOOR/ROOF ABOVE CONT. FIRESTOP SEALANT AND FIRESTOPPING INSULATION WHERE GAP EXISTS BETWEEN TOP OF WALL AND BOTTOM OF PLANK (UL-184)(R20)  
2-2 2 HR RATED PARTITION - (2) LAYER OF 5/8" TYPE "X" GYP. BD. ON EACH SIDE OF 3-5/8" METAL STUDS @ 16" O.C. W/ 3-1/2" SOUND ATTENUATION INSULATION. EXTEND STUDS & GYP. BD. UP TO UNDERSIDE OF FLOOR/DECK & SEAL TIGHT TO UNDERSIDE OF FLOOR DECK AND/OR ROOF DECK W/ CONT. FIRESTOP SEALANT. (GA FILE #WP-152)(STC 55-59)  
2-4 2 HR RATED CHASE WALL - (2) LAYERS OF 5/8" WATER RESISTANT GYP. BD. SHEATHING ON ONE SIDE OF 2-1/2" METAL STUDS @ 16" O.C. @ EACH SIDE OF CHASE. EXTEND STUDS & GYP. BD. UP TO UNDERSIDE OF SLAB. SEAL TIGHT W/ CONT. FIRESTOP SEALANT. SEAL ALL PENETRATIONS WITH FIRESTOPPING INSULATION & CONT. FIRESTOP SEALANT AS REQ. PROVIDE HORIZONTAL 2-1/2" METAL STUD BRACING @ 48" O.C. MAX (UL-184)(STC 50 MIN)  
2-5 2 HR SHAF WALL (4") - (2) LAYERS OF 5/8" TYPE "X" GYP. BD. ON ONE SIDE OF 2-1/2" METAL C-H STUDS @ 16" O.C. W/ (1) LAYER OF 1" TYPE "X" GYP. UPR PANEL ON SHFT SIDE W/ 1" MINERAL FIBER INSULATION IN CAVITY. - SEAL TOP OF WALL TO CONC/PLANK FIRE TEST UL U514 / STC 45-49

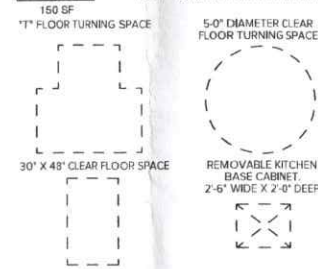
## WALL TYPE LEGEND

NOTE: G.C. SHALL SUBMIT SHOP DRAWINGS TO ARCHITECT FOR REVIEW INDICATING SIZE, GAUGE AND SPACING OF ALL METAL STUDS AND REQUIRED METAL BOXED HEADERS.

- 2-7 2 HR SHAF WALL - MASONRY EQUIVALENT - (1) LAYER OF 5/8" FIBER REINFORCED CEMENT BD. (ASTM C 1629-0 IMPACT CLASSIFICATION LEVEL 2) OVER 5/8" TYPE "X" GYP. BD. (STAGGERED JOINTS) OVER THE EXTERIOR SIDE OF 4" C-H WALL OR 6" METAL STUDS 16" O.C. W/ 1" LINER BD. (ASTM C 1629-0 LEVEL 3) INSERTED IN H PORTION OF STUDS. TYPE "AR" FIRE CODE PANELS - WP AT WET AREA. SECURE PANELS WITH NO 8 SELF DRILLING BUGLE HEAD SCREWS 12" O.C. SECURE TOP AND BOTTOM RUNNERS TO STRUCTURE. ASSEMBLY TEST ASTM 1829-0 LEVEL 2. FIRE TEST UL L415 SYSTEM E OR F / STC 45-49 W/ 1" MINERAL FIBER INSULATION IN CAVITY  
(3) 3 HR RATED  
3-1 3 HR RATED CMU WALL CMU (CLASS C-3) CONT. GALVANIZED HORIZONTAL TRUSS TYPE REINFORCING @ ALTERNATIVE BLOCK COURSES. SEAL TOP OF CONCRETE BLOCK WALL TIGHT TO UNDERSIDE OF FLOOR/ROOF ABOVE CONT. FIRESTOP SEALANT AND FIRESTOPPING INSULATION WHERE GAP EXISTS BETWEEN TOP OF WALL AND BOTTOM OF SLAB (UL-184)(R20)  
3-2 3 HR RATED WALL - (1) LAYER 1/2" TYPE "X" GYPSUM BOARD OVER 7/8" METAL HAT CHANNELS @ 24" O.C. OVER 2 HR RATED CMU/POURED IN PLACE CONCRETE. SEAL TOP OF WALL TIGHT TO UNDERSIDE OF PLANK/SLAB ABOVE WITH CONT. FIRESTOP SEALANT AND FIRESTOPPING INSULATION WHERE GAP EXISTS BETWEEN TOP OF WALL AND BOTTOM OF PLANK/SLAB. UL RUB14) PROVIDE STIC RATING OF 50-54 AT COMPACTOR CHUTE ENCLOSURE ADJACENT TO DWELLING UNITS.

## LEGEND:

- CONCRETE FOUNDATION WALL - SEE STRUCTURAL DWG'S.  
CONCRETE BLOCK WALL (CMU) - SEE PLANS FOR SIZE  
MASONRY VENEER W/ RIGID INSULATION  
EIFS FINISH  
GYPSUM BOARD PARTITION (GYP BD) - SEE PLAN FOR SIZE  
FIRE RATED SHAF WALL  
PTAC WITH ALTERNATE MEANS OF VENTILATION FRESH AIR DAMPER  
DOOR & FRAME - SEE DOOR SCHEDULE - DWG A-600  
PARTITION - SEE WALL TYPE LEGEND  
WINDOW - SEE WINDOW SCHEDULE DWG - A-600  
EXIT LIGHT & SIGN  
SMOKE / CARBON MONOXIDE DETECTOR  
SUSPENDED GYPSUM BOARD CEILING  
ELECTRIC HOUSE PANEL - SEE ELEC. DWGS.  
APARTMENT DESIGNATION # (FLOOR) XX (APARTMENT NUMBER)  
APARTMENT TYPE  
I.U. = INCLUSIONARY UNIT  
A. = MOBILITY IMPAIRED UNIT  
H.V. = HEARING & VISUALLY IMPAIRED UNIT



## GENERAL NOTES:

1. ALL PLAN DIMENSIONS ARE TAKEN FINISH TO FINISH (I.O.N.)
2. FOR KITCHEN AND TOILET ELEVATIONS, SEE DWGS A-510 THRU A-514
3. G.C. SHALL COORDINATE SIZE & LOCATION OF ALL HVAC OPENINGS IN PLANK/SLAB/DECKING WITH MECHANICAL DWGS.
4. G.C. SHALL COORDINATE SIZE AND LOCATION OF ALL MASONRY OPENINGS AT ELEVATOR ENTRANCES WITH ELEVATOR VENDOR
5. BOTTOM OF DROPPED ARCH SHALL BE 6'-6" MIN AFF.
6. FOR ELECTRICAL OUTLETS, REFER TO LATEST ELEC. CODE FOR ALL REQUIREMENTS INCLUDING HEIGHT, SPACING, ETC.

DATE	SUBMISSIONS / REVISIONS
02/09/2024	BULLETIN 3
10/20/2023	BULLETIN 2
06/16/2023	BULLETIN 1
04/07/2023	ISSUED FOR CONSTRUCTION
08/24/2022	ISSUED HPO
07/08/2022	REVISED HPO/DOB COMMENTS
06/02/2022	REVISED PER DOB COMMENTS
03/11/2022	ISSUED TO HPO/HCR
02/24/2022	REVISED PER DOB COMMENTS
04/26/2021	ISSUED TO DOB

SHEET TITLE:

## 2ND-6TH FLOOR PLANS

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12/08/20	19014	
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SCALE:	SHEET NO:	
As indicated	.00 OF	
DRAWING NO: A-101.00		
NYC DOB NUMBER: 3800228		



# MERCY HOMES

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BROOKLYN, NY 11215

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Structural Engineer

**STRUCTURAL COMPANY:**

WEXLER ASSOCIATES

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MEP Engineer

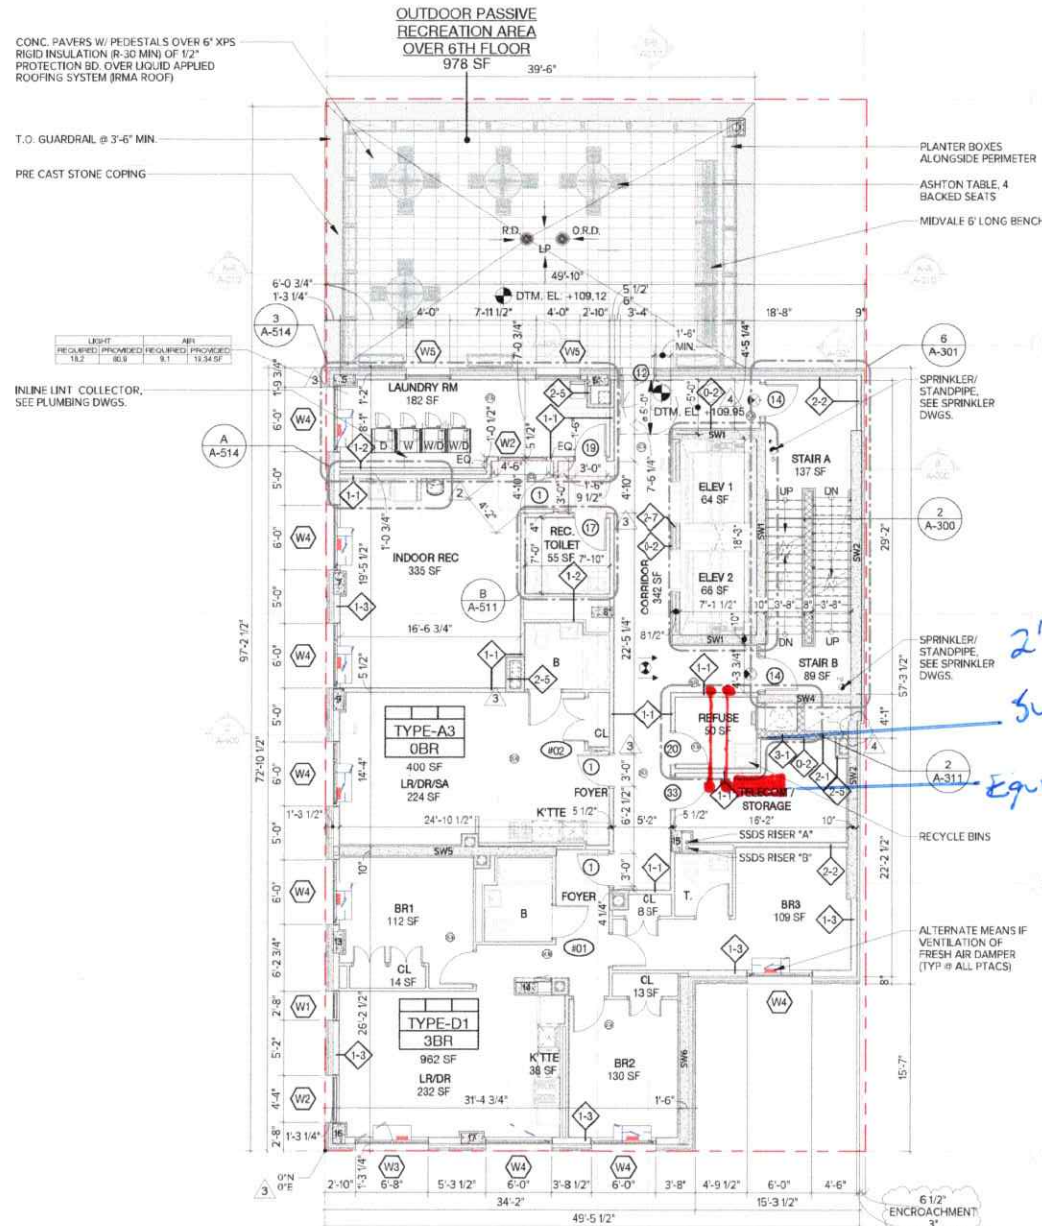
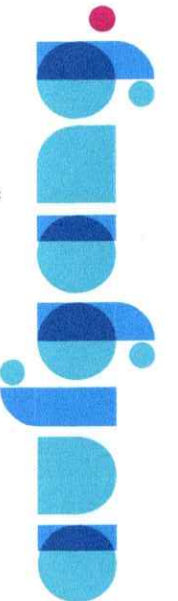
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(718) 224-9091  
Civil Engineer

**CIVIL COMPANY:**

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Phone



7TH FLOOR PLAN  
1/8" = 1'-0"

## WALL TYPE LEGEND

NOTE: G.C. SHALL SUBMIT SHOP DRAWINGS TO ARCHITECT FOR REVIEW INDICATING SIZE, GAUGE AND SPACING OF ALL METAL STUDS AND REQUIRED METAL BOXED HEADERS.

- (0) NON RATED
- 0-1 FURRING @ INTERIOR C/P CMU - (1) LAYER 5/8" TYPE "X" GYP. BD. ON ONE SIDE OF 7/8" METAL FURRING CHANNEL, 16" O.C. EXTEND STUDS UP TO UNDERSIDE OF FLOOR OR ROOF (ABOVE)
- 0-2 FURRING @ INTERIOR C/P CMU - (1) LAYER 5/8" TYPE "X" GYP. BD. OVER 1-1/2" GALV. METAL FURRING @ 2" CHANNEL, 1-1/2" RIGID INSULATION (R-7.5) AT EXTERIOR CONCRETE CMU WALLS, W.P. GYP. BD. AT TOILET AND WET AREAS
- 0-3 CHASE WALL - (1) LAYER 5/8" TYPE "X" WATER RESISTANT GYPSUM BOARD ON ONE SIDE OF 2 1/2" METAL STUDS @ 16" O.C.
- 0-3.1 SUPPLY & RETURN CHASE WALL - (1) LAYER 5/8" TYPE "X" WATER RESISTANT GYPSUM BOARD ON ONE SIDE OF 1 1/2" METAL STUDS @ 16" O.C.
- 0-4 FURRING @ EXTERIOR C/P CMU - (1) LAYER 5/8" TYPE "X" WATER RESISTANT GYP. BD. ON ONE SIDE OF 3-5/8" METAL STUDS @ 16" O.C. EXTEND STUDS UP TO UNDERSIDE OF FLOOR OR ROOF (ABOVE) 3-1/2" BATT INSULATION AT EXTERIOR WALLS (R13)
- 0-5 TYPICAL PARTITION - (1) LAYER 5/8" TYPE "X" GYP. BD. ON EACH SIDE OF 2-1/2" METAL STUDS @ 16" O.C. W.P. GYP. BD. AND 1-1/2" SOUND ATTENUATION AT BATHROOM AND TOILET ROOMS
- 0-6 PARTITION @ PANEL - (1) LAYER 5/8" TYPE "X" GYP. BD. ON EACH SIDE OF 3-5/8" METAL STUDS @ 16" O.C. - W.P. GYP. BD. AND 1-1/2" SOUND ATTENUATION AT BATHROOM AND TOILET ROOMS
- 0-6.1 TYPICAL EXTERIOR WALL PARTITION - (1) LAYER 5/8" TYPE "X" GYP. BD. ON ONE SIDE AND (1) LAYER "EXTERIOR GRADE" GYP. BD. ON OTHER SIDE OF 6" METAL STUDS WITH 5-1/2" BATT INSULATION (R-21) (UNFACED)

## WALL TYPE LEGEND

NOTE: G.C. SHALL SUBMIT SHOP DRAWINGS TO ARCHITECT FOR REVIEW INDICATING SIZE, GAUGE AND SPACING OF ALL METAL STUDS AND REQUIRED METAL BOXED HEADERS.

- 0-8 CHASE WALL PARTITION - (1) LAYER 5/8" TYPE "X" WATER RESISTANT GYP. BD. ON ONE SIDE OF 2-1/2" METAL STUDS @ 16" O.C. EXTEND STUDS UP TO UNDERSIDE OF FLOOR OR ROOF (ABOVE) 1-1/2" SOUND ATTENUATION AT BATHROOM AND TOILET ROOMS
- (1) 1 HR RATED
- 1-1 1 HR RATED TENANT PARTITION - (1) LAYER OF 5/8" TYPE "X" GYP. BD. ON (1) SIDE, (2) LAYERS OF 5/8" TYPE "X" GYP. BD. ON OTHER SIDE OF 3-5/8" METAL STUDS @ 16" O.C. W/ 3-1/2" SOUND ATTENUATION INSULATION. EXTEND STUDS & GYP. BD. UP TO UNDERSIDE OF FLOOR/DECK & SEAL TIGHT TO UNDERSIDE OF FLOOR/DECK AND/OR ROOF DECK W/ CONT. FIRESTOP SEALANT, (GA FILE #WP-1032)(STC 30-54)
- 1-2 1 HR RATED CHASE WALL PARTITION - (1) LAYER OF 5/8" TYPE "X" WATER RESISTANT GYP. BD. ON ONE SIDE OF 2-1/2" METAL STUDS @ 16" O.C. @ EACH SIDE OF CHASE. EXTEND STUDS & GYP. BD. UP TO UNDERSIDE OF SLAB/PLANK. SEAL TIGHT W/ CONT. FIRESTOP SEALANT. SEAL ALL PENETRATIONS WITH FRESAFING INSULATION & CONT. FIRESTOP SEALANT AS REQ. PROVIDE HORIZONTAL 2-1/2" METAL STUD BRACING @ 48" O.C. MAX (UL-HV442)(STC 50 MIN)

## WALL TYPE LEGEND

NOTE: G.C. SHALL SUBMIT SHOP DRAWINGS TO ARCHITECT FOR REVIEW INDICATING SIZE, GAUGE AND SPACING OF ALL METAL STUDS AND REQUIRED METAL BOXED HEADERS.

- 1-3 1 HR RATED EXTERIOR WALL - (1) LAYER 5/8" TYPE "X" GYP. BD. ON INTERIOR SIDE, (1) LAYER 5/8" EXTERIOR GRADE GYP. SHEATHING ON EXTERIOR SIDE OF 6" GALV. METAL STUDS @ 16" O.C. 5 1/2" (UNFACED) BATT INSULATION (R-21) BETWEEN STUDS OVERLAP INSULATION TABS AT STUDS - (UL-H22)
- (2) 2 HR RATED
- 2-1 2 HR RATED CMU WALL - CMU (CLASS D-2) CONT. GALVANIZED HORIZONTAL TRUSS TYPE REINFORCING @ ALTERNATIVE BLOCK COURSES. SEAL TOP OF CONCRETE BLOCK WALL TIGHT TO UNDERSIDE OF FLOOR/ROOF ABOVE CONT. FIRESTOP SEALANT AND FRESAFING INSULATION WHERE GAP EXISTS BETWEEN TOP OF WALL AND BOTTOM OF PLANK (UL-H200)
- 2-2 2 HR RATED PARTITION - (2) LAYER OF 5/8" TYPE "X" GYP. BD. ON EACH SIDE OF 3-5/8" METAL STUDS @ 16" O.C. W/ 3-1/2" SOUND ATTENUATION INSULATION. EXTEND STUDS & GYP. BD. UP TO UNDERSIDE OF FLOOR/DECK & SEAL TIGHT TO UNDERSIDE OF FLOOR/DECK AND/OR ROOF DECK W/ CONT. FIRESTOP SEALANT, (GA FILE #WP-1322)(STC 55-59)
- 2-4 2 HR RATED CHASE WALL - (2) LAYERS OF 5/8" WATER RESISTANT GYP. BD. SHEATHING ON ONE SIDE OF 2-1/2" METAL STUDS @ 16" O.C. @ EACH SIDE OF CHASE. EXTEND STUDS & GYP. BD. UP TO UNDERSIDE OF SLAB, SLAB W/ CONT. FIRESTOP SEALANT. SEAL ALL PENETRATIONS WITH FRESAFING INSULATION & CONT. FIRESTOP SEALANT AS REQ. PROVIDE HORIZONTAL 2-1/2" METAL STUD BRACING @ 48" O.C. MAX (UL-HV442)(STC 50 MIN)
- 2-5 2 HR SHAF WALL (4") - (2) LAYERS OF 5/8" TYPE "X" GYP. BD. ON ONE SIDE OF 2-1/2" METAL C-H STUDS @ 16" O.C. W/ (1) LAYER OF 1" TYPE "X" GYP. LINER PANEL ON SHFT SIDE W/ 1" MINERAL FIBER INSULATION IN CAVITY - SEAL TOP OF WALL TO CONG/PLANK (FIRE TEST UL U514 / STC 45-49)

## WALL TYPE LEGEND

NOTE: G.C. SHALL SUBMIT SHOP DRAWINGS TO ARCHITECT FOR REVIEW INDICATING SIZE, GAUGE AND SPACING OF ALL METAL STUDS AND REQUIRED METAL BOXED HEADERS.

- 2-7 2 HR SHAF WALL - MASONRY EQUIVALENT - (1) LAYER OF 5/8" FIBER REINFORCED CEMENT BD. (ASTM C 1029-0) IMPACT CLASSIFICATION LEVEL 2) OVER 5/8" TYPE "X" GYP. BD. (SPLAGGED JOINTS) OVER THE EXTERIOR SIDE OF 4" C-H 3 MLL (200A) METAL STUDS 16" O.C. W/ 1" LINER BD. (ASTM C 1029-0) LEVEL 3) INSERTED IN H PORTION OF STUDS, TYPE "AR" FIRE CODE PANELS - WP AT WET AREA. SECURE PANELS WITH NO 8 SELF DRILLING BUGLE HEAD SCREWS 12" O.C. SECURE TOP AND BOTTOM RUNNERS TO STRUCTURE. ASSEMBLY TEST ASTM 1029-0 LEVEL 2. FIRE TEST UL L415 SYSTEM E OR F / STC 45-49 W/ 1" MINERAL FIBER INSULATION IN CAVITY
- (3) 3 HR RATED
- 3-1 3 HR RATED CMU WALL CMU (CLASS C-3) CONT. GALVANIZED HORIZONTAL TRUSS TYPE REINFORCING @ ALTERNATIVE BLOCK COURSES. SEAL TOP OF CONCRETE BLOCK WALL TIGHT TO UNDERSIDE OF FLOOR/ROOF ABOVE CONT. FIRESTOP SEALANT AND FRESAFING INSULATION WHERE GAP EXISTS BETWEEN TOP OF WALL AND BOTTOM OF PLANK (UL-H200)
- 3-2 3 HR RATED WALL - (1) LAYER 1/2" TYPE "X" GYPSUM BOARD OVER 7/8" METAL HAT CHANNELS @ 24" O.C. OVER 2 HR RATED CMU POURED IN PLACE CONCRETE. SEAL TOP OF WALL TIGHT TO UNDERSIDE OF PLANK/SLAB ABOVE WITH CONT. FIRESTOP SEALANT AND FRESAFING INSULATION WHERE GAP EXISTS BETWEEN TOP OF WALL AND BOTTOM OF PLANK/SLAB. (UL #814) (PROVIDE STC RATINGS OF 50-54 AT COMPACTOR CHUTE ENCLOSURE ADJACENT TO DWELLING UNITS.

## ROOF NOTES:

### ROOFING AND PAVING:

- 1) PROVIDE CLASS "B" ROOF SYSTEM
- 2) ROOFING SHALL BE WHITE IN COLOR
- 3) PROVIDE INSULATED PRE-FABRICATED METAL CURBS @ ALL ROOFTOP EQUIPMENT
- 4) PROVIDE CRACKS @ ALL ROOF TOP EQUIPMENT WITH POSITIVE SLOPE TO ROOF DRAIN

### REDUCED HEAT - ISLAND EFFECT:

- ROOFING AND PAVING:
1. USE ENERGY STAR COMPLIANT AND HIGH EMISSIVE ROOFING FOR 100% OF THE ENTIRE ROOF
  2. NOTE THAT ENERGY STAR CERTIFIED PRODUCTS WILL HAVE BOTH AN INITIAL AND A MAINTAINED SOLAR REFLECTANCE VALUE
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  4. PROVIDE SOLAR REFLECTANCE INDEX (SRI) OF 78 OR HIGHER

## LEGEND:

- CONCRETE FOUNDATION WALL - SEE STRUCTURAL DWG'S.
- CONCRETE BLOCK WALL (CMU) - SEE PLANS FOR SIZE
- MASONRY VENEER W/ RIGID INSULATION
- BIFS FINISH
- GYPSUM BOARD PARTITION (GYP BD.) - SEE PLAN FOR SIZE
- FIRE RATED SHAF WALL
- PTAC WITH ALTERNATE MEANS OF VENTILATION FRESH AIR DAMPER
- DOOR & FRAME - SEE DOOR SCHEDULE - DWG A-600
- PARTITION - SEE WALL TYPE LEGEND
- WINDOW - SEE WINDOW SCHEDULE - DWG - A-600
- EXIT LIGHT & SIGN
- SMOKE / CARBON MONOXIDE DETECTOR
- SUSPENDED GYPSUM BOARD CEILING
- ELECTRIC HOUSE PANEL - SEE ELEC. DWGS.
- APARTMENT DESIGNATION  
#(FLOOR) XX (APARTMENT NUMBER)
- APARTMENT TYPE  
IU = INCLUSIONARY UNIT  
A = MOBILITY IMPAIRED UNIT  
HVI = HEARING & VISUALLY IMPAIRED UNIT
- 150 SF  
11" FLOOR TURNING SPACE
- 5'-0" DIAMETER CLEAR FLOOR TURNING SPACE
- 30" X 48" CLEAR FLOOR SPACE
- REMOVABLE KITCHEN BASE CABINET, 2'-6" WIDE X 2'-0" DEEP

## GENERAL NOTES:

1. ALL PLAN DIMENSIONS ARE TAKEN FINISH TO FINISH (A.O.F.)
2. FOR KITCHEN & TOILET ELEVATIONS, SEE DWG'S A-510 THRU A-514
3. G.C. SHALL COORDINATE SIZE & LOCATION OF ALL HVAC OPENINGS IN PLANK/SLAB/DECKING WITH MECHANICAL DWGS.
4. G.C. SHALL COORDINATE SIZE AND LOCATION OF ALL MASONRY OPENINGS AT ELEVATOR ENTRANCES WITH ELEVATOR VENDOR.
5. BOTTOM OF DROPPED ARCH SHALL BE 6'-6" MIN A.F.F.
6. FOR ELECTRICAL OUTLETS, REFER TO LATEST ELEC. CODE FOR ALL REQUIREMENTS INCLUDING HEIGHT, SPACING, ETC.

DATE	SUBMISSIONS / REVISIONS
10/20/2023	BULLETIN 2
06/16/2023	BULLETIN 1
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04/07/2023	ISSUED FOR CONSTRUCTION
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07/08/2022	REVISED HPD/DOB COMMENTS
06/02/2022	REVISED PER DOB COMMENTS
03/17/2022	ISSUED TO HPD/HCR
02/24/2022	REVISED PER DOB COMMENTS
04/26/2021	ISSUED TO DOB

SHEET TITLE:

## 7TH-11TH FLOOR PLANS

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ISSUE DATE:	PROJECT NO:
12/08/20	19014
DRAWN BY:	CHECKED BY:
EJ	SL
SCALE:	SHEET NO.:
As indicated	.00 OF
DRAWING NO:	A-102.00
NYC DOB NUMBER:	3800228