

GENERAL NOTES:

- A. FURNITURE SYSTEMS HAVE THREE DEDICATED CIRCUITS WITH SEPARATE NEUTRALS. ALL HOMERUNS SHALL HAVE DEDICATED NEUTRALS. WHERE LESS THAN THREE CIRCUITS ARE SHOWN FEEDING THE FURNITURE SYSTEM, WIRE THE FURNITURE SYSTEM AS FOLLOWS; 1 HOMERUN CIRCUIT - WIRE TO ALL THREE CIRCUITS 2 HOMERUN CIRCUIT - WIRE 1 TO A SINGLE CIRCUIT AND THE OTHER TO
- B. UTILIZE WIREMOLD 700 SERIES, OR APPROVED EQUAL, RACEWAY AND BACKBOXES FOR ALL INTERIOR SURFACE MOUNTING APPLICATIONS IN FINISHED SPACES. USE OF
- SURFACE MOUNTED CONDUIT IS PROHIBITED. C. UNLESS NOTED OTHERWISE, PROVIDE 2#12, 1#12 GND IN 3/4"C FOR ALL BRANCH
- D. ALL VAV UNITS ARE BEING EQUIPPED WITH FACTORY MOUNTED DISCONNECTS.

NEW WORK KEY NOTES:

CIRCUITING AND HOMERUNS.

THE REMAINING TWO CIRCUITS

- PROVIDE DEDICATED 20A, 120V BRANCH CIRCUIT FOR INDICATED REFRIGERATOR OR FREEZER RECEPTACLE.
- PROVIDE POWER BRANCH CIRCUITING TO HOT WATER HEATER SYSTEM CIRCULATION PUMP AND ASSOCIATED TIME CLOCK AND AQUASTAT. PROVIDE MOTOR-STARTING SWITCH AHEAD OF PUMP, TIME CLOCK AND AQUASTAT.
- 3. PROVIDE 30A, NON-FUSED, DISCONNECT FOR SUSPENDED WATER HEATER.
- PROVIDE 120V BRANCH CIRCUIT FOR DOOR HARDWARE POWER SUPPLY LOCATED ABOVE CEILING ON SECURED SIDE OF DOOR. POWER SUPPLY SHALL BE FURNISHED AND INSTALLED BY G.C., WIRED BY E.C.. REFER TO SECTION 281500 - INTEGRATED ACCESS CONTROL HARDWARE DEVICES FOR COMPLETE SYSTEM OPERATIONAL NARRATIVES FOR THE INTEGRATED ACCESS CONTROLLED OPENINGS.
- PROVIDE 1-1/2" DEEP JUNCTION BOX FOR RECESSING IN 7/8" FURRING AND 5/8" GYPSUM BOARD.
- COORDINATE EXACT LOCATION OF WHIP BOX WITH FINAL FURNITURE SYSTEM LAYOUT AND PROVIDE TERMINATION OF FURNITURE SYSTEM WHIP TO DESIGNATED
- PROVIDE RECESSED DUPLEX RECEPTACLE FOR WALL MOUNTED TIME CLOCK. TIME CLOCK (KRONOS #INTOUCH DX) SHALL BE PROVIDED BY OWNER. BACKPLATE PROVIDED WITH TIME CLOCK SHALL ALLOW TIME CLOCK TO BE MOUNTED OVER TOP OF THE RECESSED RECEPTACLE. RECEPTACLE SHALL BE MOUNTED APPROXIMATELY 46" A.F.F.; COORDINATE FINAL MOUNTING HEIGHT AND LOCATION WITH OWNER PRIOR TO ROUGHING-IN.
- PROVIDE HOSPITAL GRADE RECEPTACLE AT LOCATION SHOWN. UTILIZE HOSPITAL GRADE MC CABLE FOR BRANCH CIRCUITING BACK TO PANELBOARD.
- INSTALL MANUFACTURER FURNISHED PUSHBUTTON STATION FOR MOTORIZED OVERHEAD DOOR AT 48" A.F.F.. PROVIDE 3/4"C WITH 3#12 CONTROL CONDUCTORS PLUS 1#12 GROUND CONDUCTOR BETWEEN PUSHBUTTON STATION AND OVERHEAD DOOR CONTROLLER.
- PROVIDE FLUSH MOUNTED, DUAL-SERVICE, FLOOR BOX (WIREMOLD RATCHET-PRO RPNFB SERIES OR APPROVED EQUAL). BOX SHALL BE SIZED TO ACCOMMODATE QUANTITY OF WIRING DEVICES SHOWN ON THIS DRAWING AS WELL AS THE QUANTITY OF TELECOMMUNICATION OUTLETS SHOWN ON DRAWING ET-101. PROVIDE ALL REQUIRED CUTTING AND PATCHING OF EXISTING CONCRETE SLAB-ON-GRADE FLOOR TO INSTALL FLOOR BOX AND ASSOCIATED BELOW-SLAB RACEWAYS. COORDINATE EXACT LOCATION WITH OWNER'S FURNITURE LAYOUT.
- PROVIDE TELE-POWER POLE TO FEED POWER AND DATA CABLING DOWN TO FURNITURE SYSTEM. COORDINATE EXACT LOCATION WITH FINAL FURNITURE SYSTEM LAYOUT PRIOR TO ROUGHING-IN. REFER TO SPECIFICATION SECTION 260533.23 FOR ADDITIONAL REQUIREMENTS.
- 12. INSTALL LINE VOLTAGE T-STAT, FURNISHED BY MECHANICAL CONTRACTOR, TO CONTROL GAS FIRED UNIT HEATER. 120V EQUIPMENT BRANCH CIRCUITING SHALL BE ROUTED THROUGH T-STAT EN ROUTE TO UNIT HEATER. PROVIDE MOTOR-STARTING SWITCH AT UNIT HEATER.
- 13. INSTALL LINE VOLTAGE TIMECLOCK, FURNISHED BY MECHANICAL CONTRACTOR, TO CONTROL ROOFTOP EXHAUST FAN AND ASSOCIATED 120V MOTORIZED DAMPER. EQUIPMENT BRANCH CIRCUITING SHALL BE ROUTED THROUGH TIMECLOCK EN ROUTE TO EXHAUST FAN AND DAMPER.
- 14. EQUIPMENT PROVIDED WITH FACTORY MOUNTED DISCONNECT.
- 15. INSTALL LINE VOLTAGE T-STAT, FURNISHED BY MECHANICAL CONTRACTOR, TO CONTROL ROOFTOP EXHAUST FAN AND ASSOCIATED 120V MOTORIZED DAMPER. EQUIPMENT BRANCH CIRCUITING SHALL BE ROUTED THROUGH T-STAT EN ROUTE TO EXHAUST FAN AND DAMPER.
- 16. PROVIDE FLUSH MOUNTED, 2-GANG, A/V WALL BOX WITH DUPLEX RECEPTACLE AND A/V OUTLET MOUNTING PLATE (WIREMOLD EVOLUTION SERIES #EFSB2 WALL BOX OR APPROVED EQUAL). PROVIDE 1-1/4"C WITH PULLSTRING FROM A/V WALL BOX TO FLUSH MOUNTED FLOOR BOX FOR DATA CABLING AND FUTURE A/V CABLING.
- 17. PROVIDE ABOVE CEILING MOTOR-STARTING SWITCH FOR INDOOR AC UNIT.
- PROVIDE 120V BRANCH CIRCUIT TO HVAC REMOTE PANEL. COORDINATE EXACT LOCATION OF HVAC REMOTE PANEL WITH MECHANICAL CONTRACTOR PRIOR TO ROUGHING-IN.
- 19. INSTALL LINE VOLTAGE T-STAT, FURNISHED BY MECHANICAL CONTRACTOR, TO CONTROL ELECTRIC UNIT HEATER. 208V EQUIPMENT BRANCH CIRCUITING SHALL BE ROUTED THROUGH T-STAT EN ROUTE TO UNIT HEATER.
- PROVIDE SURFACE MOUNTED, UNDERCOUNTER, GFCI PROTECTED, SIMPLEX RECEPTACLE FOR INDICATED PLUG-IN SUMP PUMP. COORDINATE EXACT LOCATION WITH PLUMBING CONTRACTOR; RECEPTACLE MUST BE ACCESSIBLE ONCE PUMP IS
- 21. UTILIZE SPARE 20A-1P CIRCUIT BREAKER IN EXISTING PANELBOARD.



KEY PLAN

ERDMAN -ANTHONY www.erdmananthony.com

11 CENTURY HILL DRIVE, SUITE 105 LATHAM, NY 12110 PH: 518.783.1205

CONSULTING **ENGINEER**

UNAUTHORIZED ALTERATION OR ADDITION TO THIS DOCUMENT IS A YOLATION OF THE NEW YORK STATI REVISIONS RECORD/DESCRIPTION EXISTING CONDITIONS PLUMBING REVISIONS EDUCATION LAW. ACCESS CONTROL REVISIONS © 2024 TELECOM REVISIONS & NEW BREAKROOM C.T. MALE ASSOCIATES DESIGNER: DSU

DRAFTED : DSU

CHECKED : BRW

PROJ. NO : 21.1419

SCALE: AS NOTED

DATE: 6/21/2024

FIRST FLOOR - NEW WORK PLAN - POWER

MONTGOMERY COUNTY PUBLIC HEALTH PHASE 2

CITY OF AMSTERDAM C.T. MALE ASSOCIATES
Engineering, Surveying, Architecture, Landscape Architecture & Geology, D.P.C.

50 CENTURY HILL DRIVE, LATHAM, NY 12110 PH: 518.786.7400

COBLESKILL, NY · GLENS FALLS, NY · POUGHKEEPSIE, NY

10 HNSTOWN, NY · RED HOOK, NY · SYRACUSE NY

JOHNSTOWN, NY • RED HOOK, NY • SYRACUSE, NY

EP-101 SHEET 69 OF 78 DWG. NO: 23-0172

MONTGOMERY COUNTY, NEW YORK

				_		PAN	NELI	30A	RD I	LP1							
LOCATION:	ELECTRIC ROOM	PH	W]	MAIN BUS	S AMP:		100A									
VOLTAGE (L-L)	480	3	4	1	MAIN TYF	IAIN TYPE: MLO											
VOLTAGE (L-N)	277			•	MAIN CIRCUIT BREAKER:												
MOUNTING:	SURFACE				FEEDER SIZE: REFER TO ONE-LINE DIAGRAM												
FED FROM:	MDP				SHORT C	SHORT CIRCUIT RATING: 14,000 AIC											
FEED THRU TYPE	NO																
NOTES:																	
DESC	CRIPTION	TRIP AMPS	POLES	СКТ		ASE A MPS)		ASE B PHASE C (AMPS)		СКТ	POLES	TRIP AMPS	DESCRIPTION				
LTG E.I. OFFICE AREA		20	1	1	2.8	2.6					2	1	20	LTG WAITING AREA & CLINIC RMS			
LTG PHN	OFFICE AREA	20	1	3			2.0	1.9			4	1	20	LTG ACCOUNTING OFFICE AREA			
LTG CORRIDOR		20	1	5					1.1	1.5	6	1	20	LTG LOADING DOCK AREA			
LTG STOR. AREA & EMPLOYEE R.R.		20	1	7	1.8	3.1					8	1	20	LTG FLEX OFFICE AREA & CONFERENCE RM			
SPARE		20	1	9			0.0	0.0			10	1	20	SPARE			
SPARE		20	1	11					0.0	0.0	12	1	20	SPARE			
S	PARE	20	1	13	0.0	0.0					14	1	20	SPARE			
s	SPARE	20	1	15			0.0	0.0			16	1	20	SPARE			
s	SPARE	20	1	17					0.0	0.0	18	1	20	SPARE			
S	SPARE	20	1	19	0.0	0.0					20	1	20	SPARE			
s	SPARE	20	1	21			0.0	0.0			22	1	20	SPARE			
s	SPARE	20	1	23					0.0	0.0	24	1	20	SPARE			
S	PARE	20	1	25	0.0	0.0					26	1	20	SPARE			
s	SPARE	20	1	27			0.0	0.0			28	1	20	SPARE			
S	PARE	20	1	29					0.0	0.0	30	1	20	SPARE			
·	TOTAL L	OAD PER	₹ PHASE	(AMPS)	10	0.3	3	3.9	2	2.6			•				
	TO	TAL 3-PH	ASE LOA	D (KVA)				1.7									
	TOTA	AL 3-PHAS	E LOAD	(AMPS)			5	5.6			1						
		DE	EMAND F	ACTOR			10	00%									
	DEMAND 3-PHASE LOAD (AMI						E	5.6			1						

			F	PAN	ELB(OAF	RD L'	VP4	(SE	C. ´	1)		
OCATION: ELECTRICAL 197	PH	W	1	MAIN BUS			225A		`		,		
OLTAGE (L-L) 208	3	4		MAIN TYF	PE:		MCB						
/OLTAGE (L-N) 120		•	,	MAIN CIR	CUIT BREA	KER:	225A						
MOUNTING: SURFACE				FEEDER:	SIZE:		REFER TO	ONE-LINE	DIAGRAM				
FED FROM: T-4/MDP	SHORT CIRCUIT RATING: 10,000 AIC												
FEED THRU TYPE YES													
NOTES:		<u> </u>		BUA	.O.F. A	l Bu	105 B	l Bua	05.0	ı	<u> </u>	l l	
DESCRIPTION	TRIP AMPS	POLES	CKT		ASE A MPS)		ASE B MPS)		SE C IPS)	CKT	POLES	TRIP AMPS	DESCRIPTION
REC BUSNIESS MANAGER 170	20	1	1	6.0	6.0					2	1	20	REC DEPUTY DIRECTOR 173
REC DIRECTOR 177	20	1	3			6.0	6.0			4	1	20	REC E.I. SUPERVISOR OFFICE 180
REC E.I. OFFICE 182	20	1	5					7.5	7.5	6	1	20	REC E.I. OFFICE 179
REC E.I. OFFICE 176	20	1	7	7.5	6.0					8	1	20	CORRIDOR REC RM. 168,169,175
COPIER REC FILE/PRINT RM 175	20	1	9			6.0	1.5			10	1	20	TIME CLOCK REC CORRIDOR 167
REC RECEPTION 169	20 20	1	11					6.0	6.0	12	1	20	REC RECEPTION 169
REC WAIT. 164, RESTROOM 165, VEST. 163	20	1	13	9.0	6.0					14	1	20	ADA DOOR OPERATORS - VEST. 163
REC CORRIDOR 193, JAN. CLOSET 192	20	1	15			3.0	3.0			16	1	20	GFI REC MEN'S RM 185, WOMEN'S 186
EXAM CHAIR REC MON. EXAM RM 191	20	1	17					6.0	3.0	18	1	20	REC MON. EXAM RM 191
EXAM CHAIR REC CLINICAL EXAM RM 189	20	1	19	6.0	3.0					20	1	20	REC CLINICAL EXAM RM 189
REC CLINIC RM 190	20	1	21			3.0	3.0			22	1	20	REC CLINIC RM 190
RABIES REFRIG. REC CLINIC RM 190	20	1	23					2.0	2.0	24	1	20	PHARM VACCINE REFRIG. REC CLINIC RM 190
VACCINE MED. REFRIG. REC CLINIC RM 190	20	1	25	2.0	6.0					26	1	20	ULT FREEZER REC CLINIC RM 190
TALL REFRIG. REC CLINIC RM 190	20	1	27			2.0	7.5			28	1	20	REC PHN 184, CLIN. STOR. 188, PHN STOR. 187
GFI REC PHN 184	20	1	29					3.0	1.5	30	1	20	REFRIG. REC PHN 184
REC E.I. OFFICE 183	20	1	31	7.5	6.0		<u> </u>			32	3	20	
	20	3	33			3.0	6.0			34			WALL FURNITURE FEED - PHN 184
WALL FURNITURE FEED - PHN 184			35			<u> </u>	<u> </u>	3.0	6.0	36			
			37	3.0	6.0	<u> </u>	ļ	ļ		38	20	1	REC STOR. RM 198, BREAK ROOM 199
REC ELECTRICAL 197, CORRIDOR 194	20	1	39		<u> </u>	1.5	1.5	ļ		40	20	1	GPHREC ROOF TOP COND. UNIT (ACCU-1)
RCP-2	20	1	41			ļ		0.5	0.0	42	20	1	SPARE
(*) TOTAL LO				14	18.9	8	4.1	98	3.0				
		ASE LOAI				3	9.7			1			
TOTA	_ 3-PHAS	SE LOAD	(AMPS)				10.4						
		EMAND F				4	2%						
DEMANI	3-PHAS	SE LOAD	(AMPS)			4	6.1						

						PAN	ELB	OAF	RD L	VP1				
LOCATION:	ELECTRIC ROOM	PH	W	1	MAIN BUS			150A						
VOLTAGE (L-L)	208	3	4	1	MAIN TYF	E:		МСВ						
	120			J	MAIN CIR	CUIT BREA	KER:	150A						
MOUNTING:	SURFACE				FEEDER S	SIZE:		REFER TO	ONE-LINE	DIAGRAM				
	T-1/LP1					IRCUIT RA	ΓING:	10,000 AIC						
FEED THRU TYPE	NO													
NOTES:														
DESCRIPTION		TRIP AMPS	POLES	СКТ		ISE A MPS)		SE B (IPS)		SE C (IPS)	СКТ	POLES	TRIP AMPS	DESCRIPTION
REC FLEX SIGN	-OUT CONF. RM 208	20	1	1	6.0	7.5					2	1	20	REC FLEX SIGN-OUT OFFICE 207
REC FLEX SIGI	N-OUT OFFICE 206	20	1	3			7.5	7.5			4	1	20	REC TBD RM 203, CORRIDOR 211
COPIER REC	TBD RM 203	20	1	5					6.0	6.0	6	1	20	REC FLEX SIGN-OUT OFFICE 205
REC FLEX SIGI	N-OUT OFFICE 204	20	1	7	6.0	6.0					8	1	20	REC CONFERENCE RM 202
REC CONFE	RENCE RM 202	20	1	9			9.0	3.0			10	1	20	REC CORRIDOR 220
REC BR	EAK RM 201	20	1	11					6.0	6.0	12	1	20	REC BREASTFEEDING/PUMPING RM 2
		20	3	13	8.0	4.5					14	1	20	SP-2
	URNITURE FEED - TBD . 203			15			8.0	3.0			16	1	20	GFI REC WOMEN'S 213, MEN'S 212
IXIV	. 203		T	17					8.0	6.0	18	1	20	REC LOADING DOCK 195
OVERHEAD DOOR	- DPW GARAGE 215	20	1	19	3.0	3.0					20	1	20	REC DPW GARAGE 215
OVERHEAD DOOR	- LOADING DOCK 195	20	1	21			3.0	7.5			22	1	20	REC UNASSIGNED STORAGE 214
U	H-1	20	1	23					5.1	5.1	24	1	20	UH-2
(*) GENERATO	R LOAD CENTER	40	2	25 27	24.0	14.5	24.0	14.5			26 28	2	20	EUH-1
E	F-2	20	1	29					1.0	1.0	30	1	20	EF-3
SP	'ARE	20	1	31	0.0	0.0					32	1	20	SPARE
	'ARE	20	1	33			0.0	0.0			34	1	20	SPARE
SP	'ARE	20	1	35				<u> </u>	0.0	0.0	36	1	20	SPARE
SP	ARE	20	1	37	0.0	0.0					38	1	20	SPARE
SP	ARE	20	1	39			0.0	0.0			40	1	20	SPARE
SP	ARE	20	1	41					0.0	0.0	42	1	20	SPARE
	TOTAL L	OAD PER	R PHASE	(AMPS)	8:	2.5	8	7.0	5	0.1				
	ТОТ	AL 3-PH	ASE LOA	D (KVA)			20	6.4			1			
	TOTA	L 3-PHAS	SE LOAD	(AMPS)				3.2			1			
		DI	EMAND F	ACTOR				5%			1			
	DEMANI		SE LOAD											
*\ EXISTING ACTIVE I	OAD. LOAD INFORMATIO	N BASE	D ON SH	OP DRAV	WINGS FRO	OM PREVIC			TALLATION	PROJECT				

						PAN	NELE	30A	RD I	P1				
OCATION:	ELECTRIC ROOM	PH	W	1	MAIN BUS	S AMP:		100A						
/OLTAGE (L-L)	480	3	4	1	MAIN TYP	E:		MLO						
/OLTAGE (L-N)	277			•	MAIN CIR	CUIT BREA	KER:							
MOUNTING:	SURFACE				FEEDER S	SIZE:		REFER TO	ONE-LINE	DIAGRAN	ļ			
ED FROM:	MDP				SHORT C	IRCUIT RA	ΓING:							
EED THRU TYPE	NO													
NOTES:														
DESC	CRIPTION	TRIP AMPS	POLES	СКТ		SE A MPS)		ISE B MPS)		SE C (IPS)	СКТ	POLES	TRIP AMPS	DESCRIPTION
V	/AV-01	20	1	1	7.2	2.2					2	3	15	
V	'AV-02	20	1	3			10.8	2.2			4			(*) 'EHV-2A, 2B
		20	3	5					4.2	2.2	6			
V	'AV-03			7	4.2	7.2					8	1	20	VAV-05,06
				9			4.2	7.2			10	1	20	(*) 'EHV-2A, 2B
V	'AV-09	20	1	11					7.2	0.8	12	1	20	VAV-10,11,12
		20	3	13	4.8	1.0					14	1	20	VAV-4,13,14,15
V	'AV-19			15			4.8	9.5			16	1	20	VAV-16,17,18
				17					4.8	15.0	18	3	20	
		20	3	19	15.0	15.0					20			CUH-1
C	CUH-2			21			15.0	15.0			22			
				23					15.0	14.0	24	3	20	
S	PACE			25	0.0	14.0					26			ACC-3
S	PACE			27			0.0	14.0			28			
S	PACE			29					0.0	0.0	30			SPACE
		LOAD PER		, ,	70	0.7	8:	2.8	63	3.2	1			
		TAL 3-PHA		, ,			60	0.0			1			
TOTAL 3-PHASE LOAD (AMPS							7:	2.3			1			
	DEMAND FACTO						70	0%]			
								0.6						

LOCATION: VOLTAGE (L-L) VOLTAGE (L-N) MOUNTING: FED FROM: FEED THRU TYP NOTES:	ELECTRICAL 197 208 120 SURFACE LVP4 (SEC. 1) E NO	PH 3	W 4		MAIN BUS MAIN TYP MAIN CIRC FEEDER S SHORT CI	E: CUIT BREA SIZE:		225A MLO REFER TO 10,000 AIO	O ONE-LINE	E DIAGRAM	l			
DESCRIPTION		TRIP AMPS POLE		СКТ	PHASE A (AMPS)		PHASE B (AMPS)		PHASE C (AMPS)		СКТ	POLES	TRIP AMPS	DESCRIPTION
	AC 2.4		2	43	1.1	9.8					44	1	20	EF-1
	AC-3,4			45			1.1	6.0			46	3	20	
MALL FURNIT	THE FEED ACCOUNTING	20	3	47					6.0	6.0	48			WALL FURNITURE FEED - ACCOUNTING DEPT. 21 NE CORNER
	WALL FURNITURE FEED - ACCOUNTING DEPT. 216 - NW CORNER ADA DOOR OPERATORS - VEST. 221 COPIER REC ACCOUNTING DEPT. 216			49	6.0	6.0					50			
		-		51			6.0	1.5			52	1	20	TIME CLOCK REC CORRIDOR 220
		20	1	53					6.0	3.0	54	1	20	REC ACCOUNTING DEPT. 216
			1	55	6.0	6.0					56	1	20	
	REC ACCOUNT. SUPERV. OFFICE 217		1	57			7.5	3.0			58	1	20	REC CORRIDOR 220
	REMOTE PANEL	20	1	59					1.0	22.0	60	2	30	REC ACCOUNTING DEPT. 216 REC ACCOUNT. SUPERV. OFFICE 218 REC CORRIDOR 220 EWH-1 SPARE SPARE
	ER REC BREAK ROOM 199	20	1	61	12.0	22.0					62			
REFRIGERATO	OR REC BREAK ROOM 199	20	1	63			6.0	0.0			64	1	20	
	SPARE	20	1	65			_		0.0	0.0	66	1	20	
	SPARE	20	1	67	0.0	0.0					68	1	20	SPARE
	SPARE	20	1	69			0.0	0.0			70	1	20	SPARE
	SPARE	20	1	71					0.0	0.0	72	1	20	SPARE
	SPARE	20	1	73	0.0	0.0			<u> </u>	<u> </u>	74	1	20	SPARE
	SPARE	20	1	75 			0.0	0.0	!		76	1	20	SPARE
	SPARE	20	1	77			<u> </u>	<u> </u>	0.0	0.0	78	1	20	SPARE
	SPARE	20	1	79	0.0	0.0					80	1	20	SPARE
	SPARE	20 20	1	81			0.0	0.0	0.0	0.0	82	1	20	SPARE
	SPARE		1	83 (AMBC)		_	_		0.0	0.0	84	1	20	SPARE
	TOTAL L		ASE LOA			3.9	•	1.1	44	1.0	1			
			SE LOAD	. ,				7.3			1			
	1018				-			3.0			-			
	DEMAN		EMAND F					3%			-			
	DEMAN	D 3-PHAS	SE LUAD	(AMPS)			42	2.4						

LOCATION:	ELECTRIC ROOM	PH	W]	MAIN BUS	S AMP:		225A						
VOLTAGE (L-L)	208	3	4]	MAIN TYP			MCB						
VOLTAGE (L-N)	120					CUIT BREA	KER:	225A						
MOUNTING:	SURFACE				FEEDER S				ONE-LINE	DIAGRAM				
FED FROM:	T-6/125A ENCLOSED (C.B.			SHORT C	IRCUIT RAT	TING:	10,000 AIC	į					
FEED THRU TYPE	NO													
NOTES:														
DES	SCRIPTION	TRIP AMPS	POLES	СКТ		SE A 1PS)		ISE B MPS)		SE C IPS)	СКТ	POLES	TRIP AMPS	DESCRIPTION
EV.C	HARGER 1A	40	2	1	30.0	30.0					2	40	2	FV CHARCER 4B
EVC	HARGER IA		-	3			30.0	30.0			4			EV CHARGER 1B
EV C	HARGER 2A	40	2	5					30.0	30.0	6	40	2	EV CHARGER 2B
LVO	HAROLIN ZA			7	30.0	30.0					8			EV OFFICIENZE
EV CHAF	RGER (FUTURE)	40	2	9			0.0	0.0			10	40	2	EV CHARGER (FUTURE)
				11					0.0	0.0	12			
EV CHAF	RGER (FUTURE)	40	2	13	0.0	0.0					14	40	2	EV CHARGER (FUTURE)
		<u> </u>		15			0.0	0.0			16			
	SPACE	_		17					0.0	0.0	18			SPACE
	SPACE	_		19	0.0	0.0					20			SPACE
	SPACE			21			0.0	0.0			22			SPACE
	SPACE	-		23				<u> </u>	0.0	0.0	24			SPACE
	SPACE	_		25	0.0	0.0	0.0	0.0			26			SPACE
	SPACE SPACE	-		27 29			0.0	0.0	0.0	0.0	28 30			SPACE SPACE
		LOAD PER	DHASE		12	0.0	6	0.0		0.0	30			SPACE
		OTAL 3-PH			12	0.0		8.8	00	7.0	1			
		TAL 3-PHAS						0.0			ł			
	10		EMAND F					0%			1			
	DEMA	ND 3-PHAS						0.0			1			
				/										

REVISIONS RECORD/DESCRIPTION

1\ EXISTING CONDITIONS PLUMBING REVISIONS

TELECOM REVISIONS & NEW BREAKROOM

ACCESS CONTROL REVISIONS

9 33 393	58	
1 Venner Road	Vew York State Breyde Route 5	
	e Břeydle	
99 3 9 9	fork Stat	- Car
	Zew.	

KEY PLAN

ERDMAN -

UNAUTHORIZED ALTERATION OR ADDITION TO THIS DOCUMENT IS A VIOLATION OF THE NEW YORK STATE EDUCATION LAW.

© 2024 C.T. MALE ASSOCIATES

DESIGNER: DSU DRAFTED : DSU

CHECKED : BRW

PROJ. NO : 21.1419

SCALE: AS NOTED

DATE: 6/21/2024

ANTHONY Www.erdmananthony.com

11 CENTURY HILL DRIVE, SUITE 105 LATHAM, NY 12110 PH: 518.783.1205 CONSULTING

PANELBOARD SCHEDULES

MONTGOMERY COUNTY PUBLIC HEALTH PHASE 2


CITY OF AMSTERDAM C.T. MALE ASSOCIATES
Engineering, Surveying, Architecture, Landscape Architecture & Geology, D.P.C.
50 CENTURY HILL DRIVE, LATHAM, NY 12110 PH: 518.786.7400
COBLESKILL, NY · GLENS FALLS, NY · POUGHKEEPSIE, NY
JOHNSTOWN, NY · RED HOOK, NY · SYRACUSE, NY

Www.ctmale.com

EP-701 SHEET 72 OF 78 DWG. NO: 23-0172

MONTGOMERY COUNTY, NEW YORK

ENGINEER

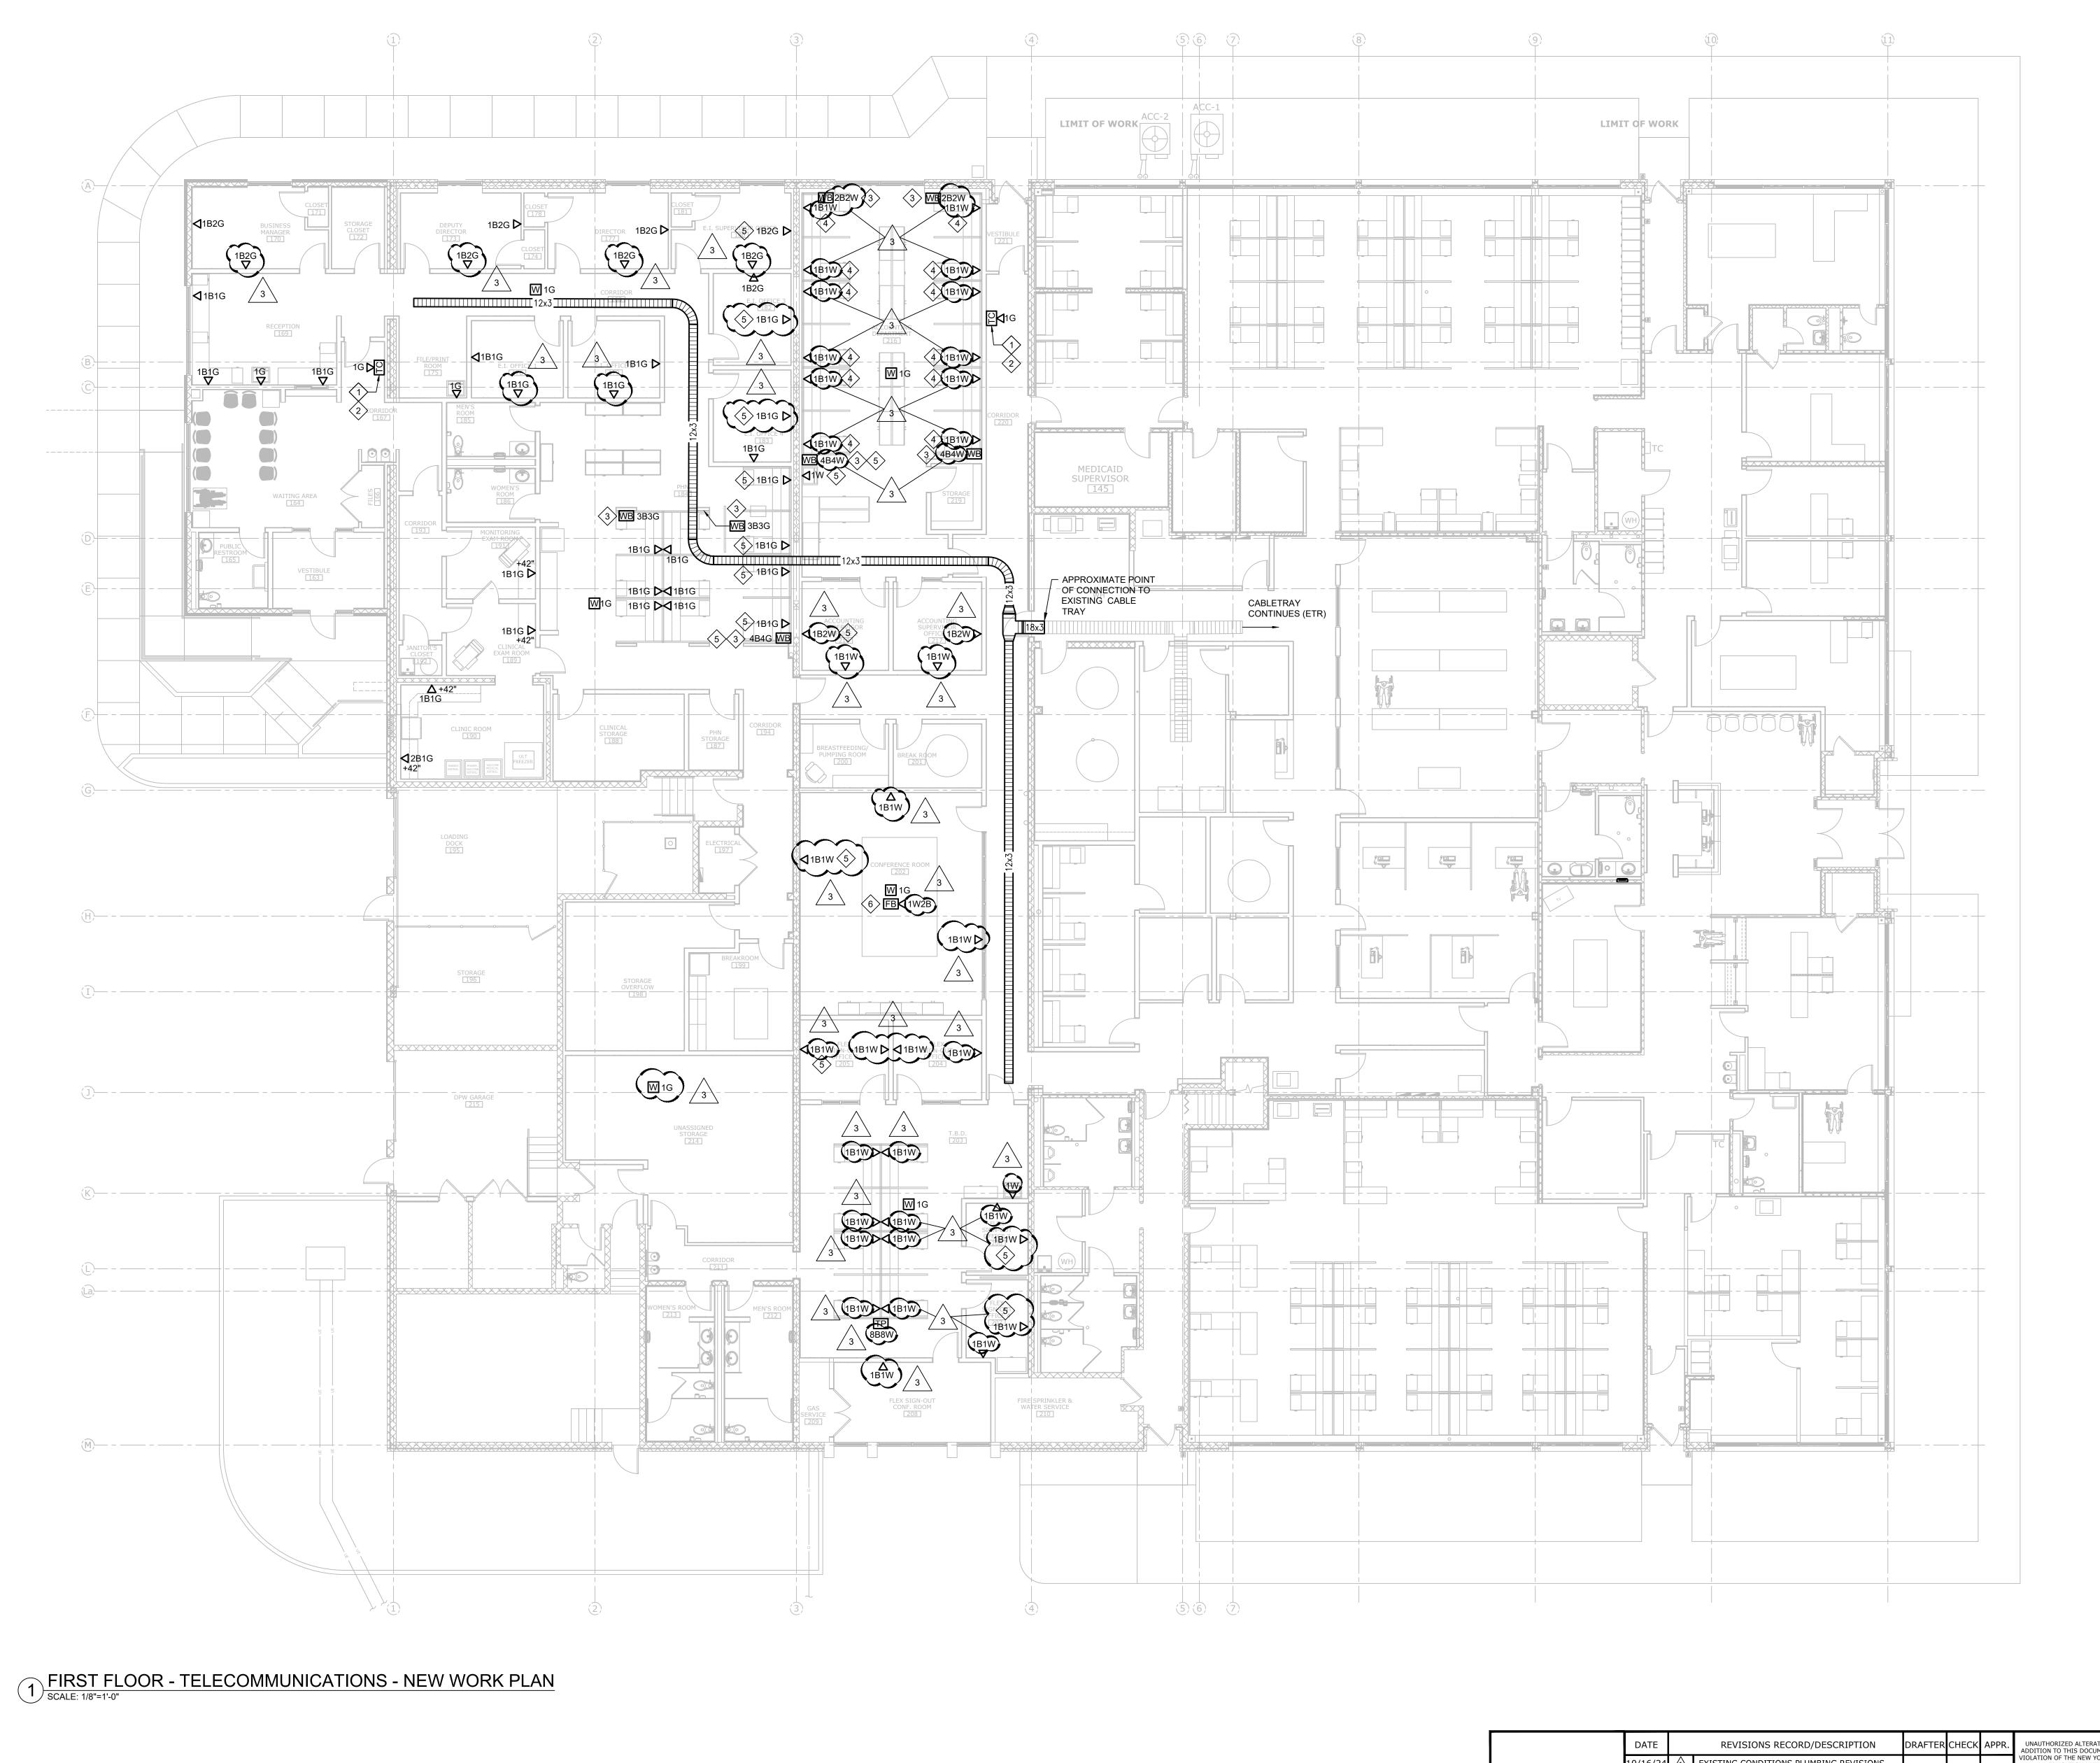

GENERAL NOTES:

- A. PROVIDE CONCEALED 1" CONDUIT FROM EACH RECESSED TELECOMMUNICATION OUTLET JUNCTION BOX AND STUB-OUT ABOVE CEILING TO PROVIDE PATHWAY FOR OUTLET TELECOMMUNICATION (TELECOM) CABLING; CABLING SHALL BE FURNISHED AND INSTALLED BY THE ELECTRICAL CONTRACTOR. UTILIZE J-HOOKS OR OTHER APPROVED SUPPORTING METHODS TO CONTINUE ROUTING CABLING TO BASKET
- BASKET TRAY (PROVIDED BY E.C.) SHALL BE ROUTED A MINIMUM OF 4" ABOVE SUSPENDED CEILING AND ROUTED BELOW ALL PIPING AND DUCTWORK. MAINTAIN A MINIMUM CLEARANCE OF 6" BETWEEN TOP OF BASKET TRAY AND ANY PIPING OR DUCTWORK CONTRACTOR SHALL MAKE OFFSETS AS REQUIRED TO ROUTE
- REFER TO DRAWING E-401 FOR TELECOMMUNICATION OUTLET AND BASKET TYPE CABLE TRAY DETAILS.

NEW WORK KEY NOTES:

AROUND EXISTING SPRINKLER PIPING.

- PROVIDE ONE (1) CAT 6 ABOVE CEILING DATA OUTLET FOR TIME CLOCK (COUNTY NETWORK - GREEN).
- PROVIDE CONCEALED 3/4" CONDUIT FROM RECESSED JUNCTION BOX AND STUB-OUT ABOVE CEILING TO PROVIDE PATHWAY FOR TIME CLOCK PATCH CABLE; PATCH CABLE SHALL BE FURNISHED AND INSTALLED BY THE ELECTRICAL CONTRACTOR. PROVIDE 3-FEET OF SLACK ON EACH END OF CABLE
- PROVIDE WALL BOX WITH GYP. BOARD WALL PLATE AND GROMMET TO FEED CABLING TO FURNITURE SYSTEM.
- 4. ROUTE TELECOM CABLING IN FURNITURE SYSTEM RACEWAY AND PROVIDE TELECOMMUNICATIONS OUTLET AT LOCATION NOTED.
- 5. DUE TO SHALLOW WALL DEPTH, UTILIZE TWO (2) 3/4-INCH CONDUITS, IN LIEU OF ONE (1) 1-INCH CONDUIT, FOR ROUTING OF DATA CABLING DOWN TO DATA OUTLET BACKBOX. PROVIDE CARVING OUT OF EXISTING BLOCK WALL TO ALLOW DATA OUTLET BACKBOX TO BE RECESSED IN WALL WITH A FLUSH FACEPLATE ON NEW
- PROVIDE QUANTITY OF DATA OUTLET INDICATED IN FLUSH MOUNTED, DUAL-SERVICE, FLOOR BOX. REFER TO DRAWING EP-101 FOR ADDITIONAL FLOOR BOX REQUIREMENTS.

		LEGEND
^	#B ▽ #G #W	DATA OUTLET - WALL OR RACEWAY MOUNTED - FLUSH. SUBSCRIPTS INDICATE THE FOLLOWING: # - QUANTITY OF CAT 6 DATA JACKS B - BLACK JACK (PHONE DROPS) G - GREEN JACK (COUNTY NETWORK) W - WHITE JACK (STATE NETWORK)
3	#B TP #G #W	TELE-POWER POLE. SUBSCRIPTS INDICATE QUANTITY OF PHONE DROPS (BLACK), COUNTY NETWORK (GREEN), OR STATE NETWORK (WHITE) DATA CABLES BEING ROUTED DOWN THROUGH POLE TO FURNITURE SYSTEM.
	#B WB #G #W	WALL BOX. SUBSCRIPTS INDICATE QUANTITY OF PHONE DROPS (BLACK), COUNTY NETWORK (GREEN), OR STATE NETWORK (WHITE) DATA CABLES BEING ROUTED THROUGH BOX TO FURNITURE SYSTEM.
	₩ #G	WIRELESS ACCESS POINT. SUBSCRIPTS INDICATE QUANTITY OF COUNTY NETWORK (GREEN) DATA JACKS SHALL BE PROVIDED IN ABOVE CEILING DATA OUTLET.



KEY PLAN

ERDMAN ANTHONY www.erdmananthony.com

11 CENTURY HILL DRIVE, SUITE 105 LATHAM, NY 12110 PH: 518.783.1205

CONSULTING ENGINEER

DATE		REVISIONS RECORD/DESCRIPTION	DRAFTER	CHECK	UNAUTHORIZED ALTERATION OR ADDITION TO THIS DOCUMENT IS A	
10/16/24	\triangle	EXISTING CONDITIONS PLUMBING REVISIONS			VIOLATION OF THE NEW YORK STATE EDUCATION LAW.	FIRST FLOOR - NEW WORK PLAN - TELECOM
11/05/24	2	ACCESS CONTROL REVISIONS			© 2024	
11/22/24	3	TELECOM REVISIONS & NEW BREAKROOM			C.T. MALE ASSOCIATES	MONTGOMERY COUNTY
	4				DESIGNER: DSU	PUBLIC HEALTH PHASE 2

DRAFTED : DSU

CHECKED : BRW

PROJ. NO : 21.1419

SCALE: AS NOTED

DATE: 6/21/2024

MONTGOMERY COUNTY
PUBLIC HEALTH PHASE 2


CITY OF AMSTERDAM C-T- MALE ASSOCIATES
Engineering, Surveying, Architecture, Landscape Architecture & Geology, D.P.C.

50 CENTURY HILL DRIVE, LATHAM, NY 12110 PH: 518.786.7400
COBLESKILL, NY · GLENS FALLS, NY · POUGHKEEPSIE, NY
JOHNSTOWN, NY · RED HOOK, NY · SYRACUSE, NY

www.ctmale.com

MONTGOMERY COUNTY, NEW YORK


ET-101 SHEET 74 OF 78 DWG. NO: 23-0172

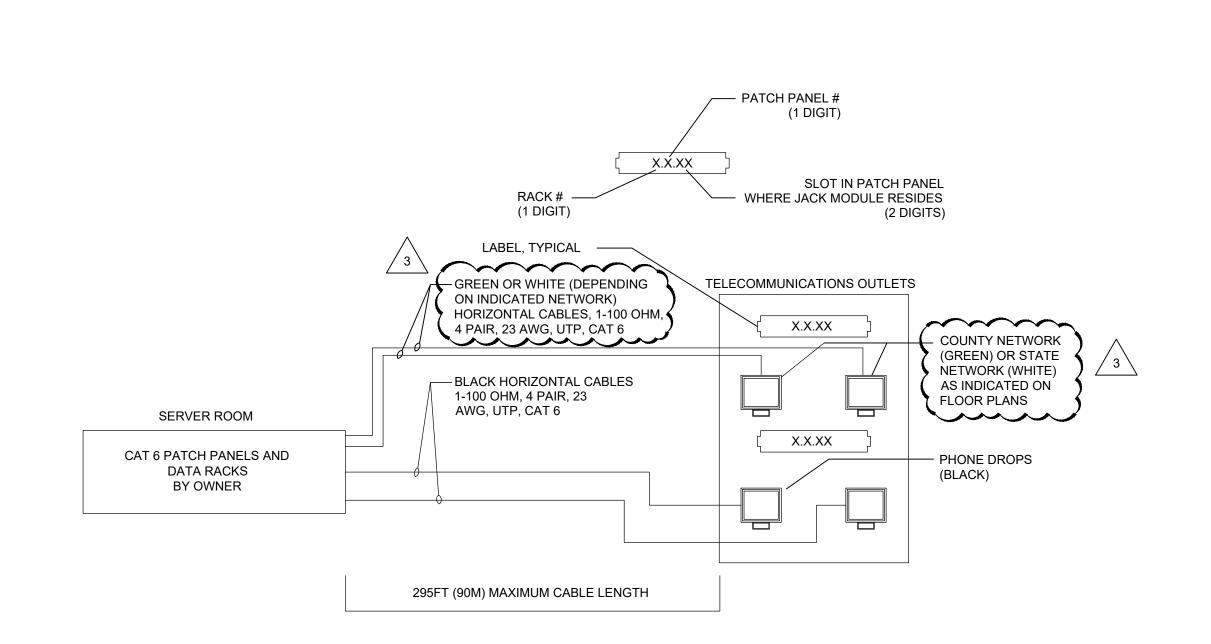

3 TYPICAL TELECOMMUNICATIONS OUTLET WIRING SCALE: N.T.S.

TYPICAL J-HOOK SUPPORT SYSTEM CEILING SLAB OR SUPPORT INSULATED THROAT CONNECTOR (TYPICAL) TYPICAL CABLE TRAY IN HALLWAY/CORRIDOR HORIZONTAL DISTRIBUTION CABLE FROM — 5'-0" MAX. 2'-6" MAX. 2'-6" MAX. WORK AREA OUTLET TO LOCAL IT ROOM TERMINATE CONDUIT WITH 6" OF J-HOOK SUPPORT SYSTEM 1"C SLEEVE WITH INSULATED BUSHINGS. PROVIDE FIRE STOPPING OF SLEEVE IF INSTALLED IN A RATED WALL. — INACCESSIBLE CEILING OR SOFFIT AREA - ACCESSIBLE PARTITION WALL CEILING - (1) 1" INSIDE DIAMETER ÈMT CONDUIT WITH HORIZONTAL DISTRIBUTION CABLE GENERAL NOTES: DEVICE BOX 1. AT ALL TELECOMMUNICATIONS OUTLETS, A 1-1/4" CONDUIT SHALL BE INSTALLED FROM EACH DEVICE BACKBOX TO J-HOOK SUPPORT SYSTEM. TYPICAL COMMUNICATIONS FACEPLATE TELECOMMUNICATIONS OUTLETS INSTALLED IN MECHANICAL SPACES SHALL BE INSTALLED IN CONDUIT TO HALLWAY/CORRIDOR. FINISHED FLOOR

TYPICAL WALL DEVICE WITH J-HOOKS & CABLE TRAY DETAIL SCALE: N.T.S.

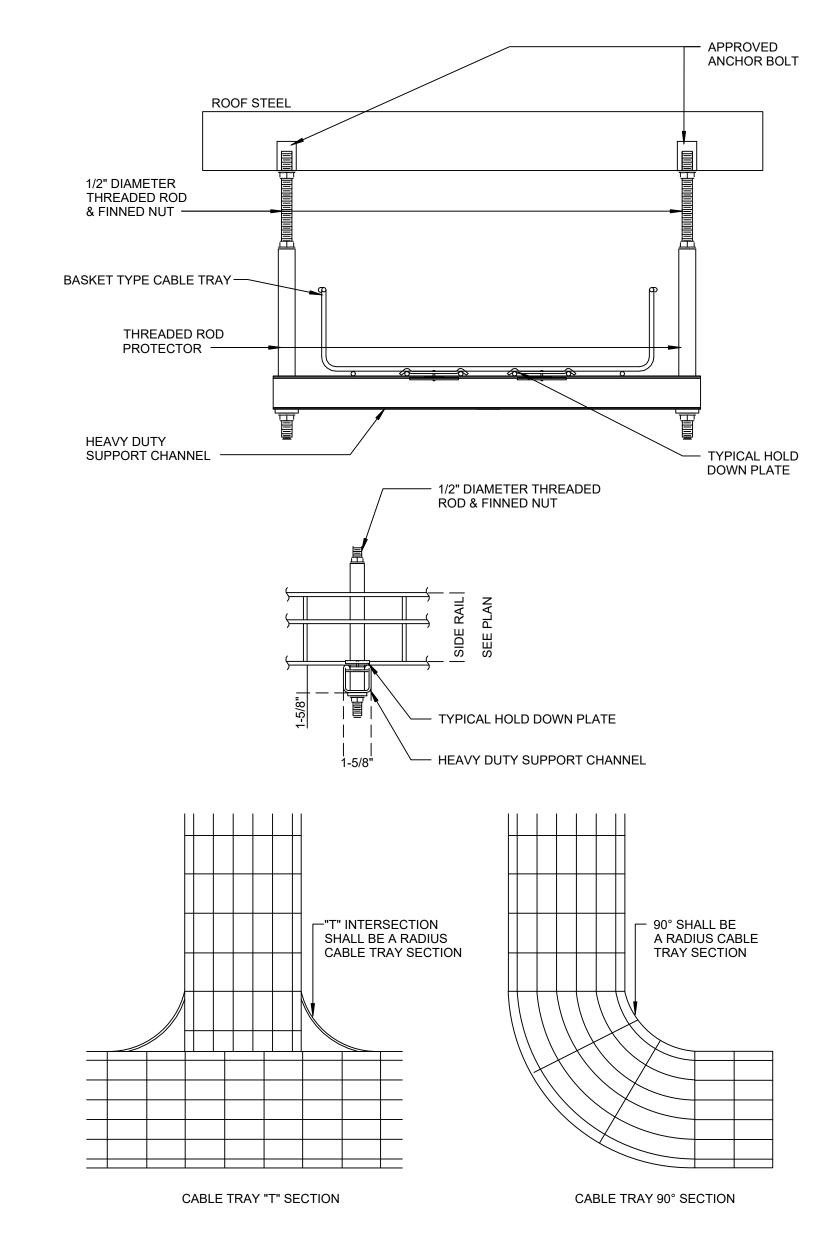

2 TYPICAL BASKET TYPE CABLE TRAY SUPPORT SYSTEM DETAIL SCALE: N.T.S.



KEY PLAN

ERDMAN = ANTHONY www.erdmananthony.com

11 CENTURY HILL DRIVE, SUITE 105 LATHAM, NY 12110 PH: 518.783.1205

CONSULTING **ENGINEER**

TELECOM DETAILS

MONTGOMERY COUNTY

PUBLIC HEALTH PHASE 2 CITY OF AMSTERDAM

MONTGOMERY COUNTY, NEW YORK C-T. MALE ASSOCIATES
Engineering, Surveying, Architecture, Landscape Architecture & Geology, D.P.C.

50 CENTURY HILL DRIVE, LATHAM, NY 12110 PH: 518.786.7400

COBLESKILL, NY · GLENS FALLS, NY · POUGHKEEPSIE, NY
JOHNSTOWN, NY · RED HOOK, NY · SYRACUSE, NY

www.ctmale.com

ET-401 SHEET 75 OF 78 DWG. NO: 23-0172

DATE		REVISIONS RECORD/DESCRIPTION	DRAFTER	CHECK	APPR.	UNAUTHORIZED ALTERATION OR ADDITION TO THIS DOCUMENT IS A					
10/16/24	\triangle	EXISTING CONDITIONS PLUMBING REVISIONS				VIOLATION OF THE NEW YORK STATE EDUCATION LAW.					
11/05/24	2	ACCESS CONTROL REVISIONS	ROL REVISIONS								
11/22/24	3	TELECOM REVISIONS & NEW BREAKROOM				© 2024 C.T. MALE ASSOCIATES					
	4					DESIGNER: DSU					
	Ŝ					DRAFTED : DSU	C				
	<u>6</u>					CHECKED : BRW					
	\triangle					PROJ. NO : 21.1419					
	<u>&</u>					SCALE: AS NOTED					
					·	DATE: 6/21/2024					