Single drops = 6 cables Dual Drops = 20 = 40 cables Triple Drops = 3 = 9 cables Quad Drops = 3 = 12 cables

TOTAL = 67 Cables

## **Cat6 Shielded**

**Dual Drops = 4 = 8 cables** Quad Drops = 1 = 4 cables TOTAL = 12 Cables

6 Shielded cables for 5G if not present

T Mobile -

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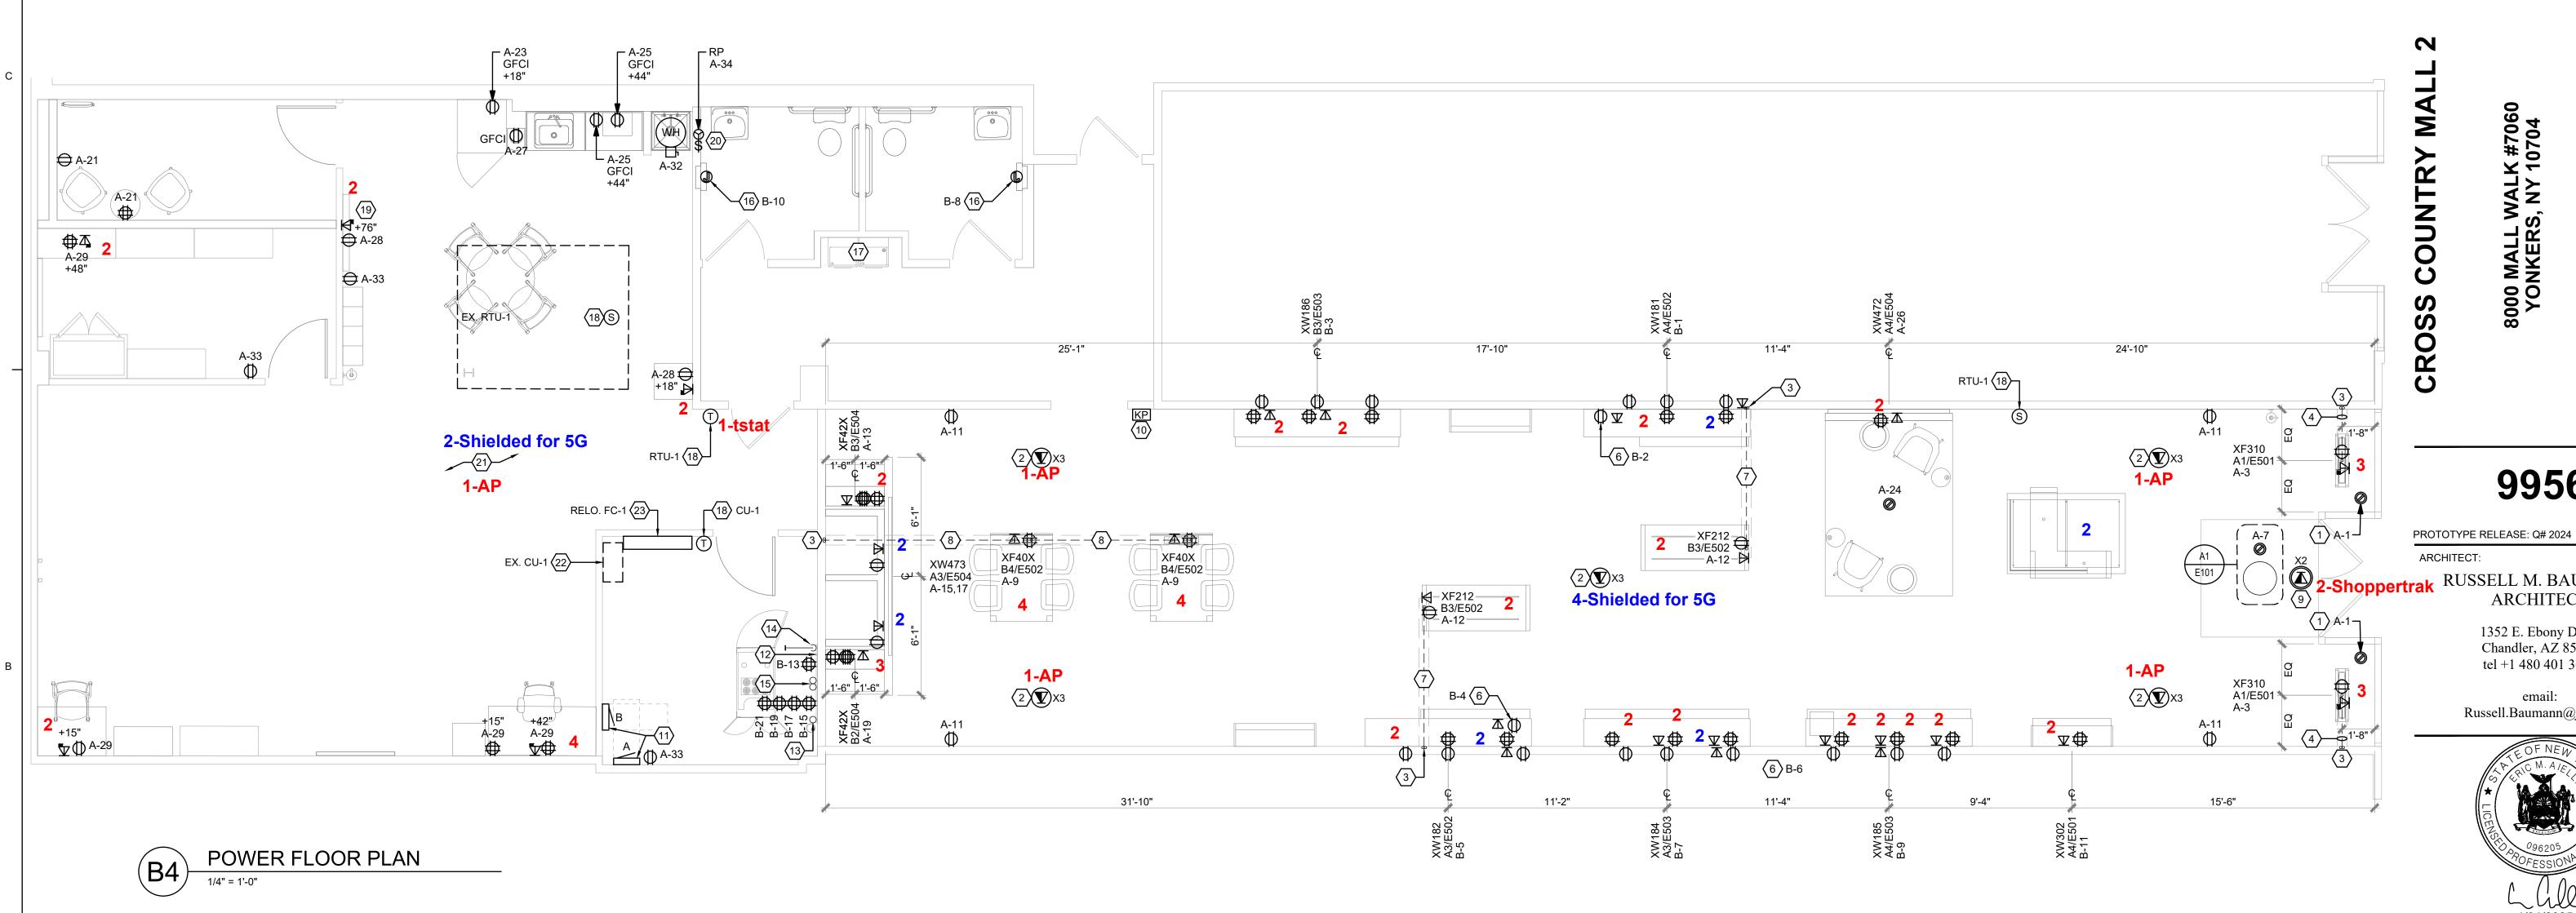
1/31/2025 CONSULTING ENGINEER:

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DESCRIPTION

DATE: 12.13.2024 REVIEWED BY: RMB SCALE: AS NOTED PROJECT NUMBER: TMO24035 DRAWN BY:

POWER FLOOR PLAN



<b>(##</b> )	NOTES
1	SHOW WINDOW RECEPTACLE(S). LOCATE MAXIMUM 18" FROM TOP OF WINDOW (NEC 210.62).
2	PROVIDE OVERHEAD AP CABLING ABOVE CEILING W/ 3'-0" MIN. SERVICE LOOP. COORDINATE W/ AP VENDOR FOR EXACT LOCATIONS.
3	PROVIDE POWER CIRCUIT AND LOW VOLTAGE WIRING TO J-BOXES ABOVE CEILING FOR CONDUIT TRENCH TO FLOOR FIXTURES.
4	SAW CUT (TRENCH) TO XF310 FIXTURE. SEE WIRING DETAILS ON SHEET E501 FOR ADDITIONAL INFORMATION AND RESPONSIBILITIES.  • CONDUIT SCHEDULE: (1) 1" GENERAL POWER, (1) 1" DATA
5	NOT USED.
6	PROVIDE DEDICATED CIRCUIT FOR DIGITAL DISPLAY EQUIPMENT. SEE DETAILS ON SHEETS E502 AND E503.
7	SAW CUT (TRENCH) TO XF212 OEM TABLE. SEE WIRING DETAILS ON SHEET E502 FOR ADDITIONAL INFORMATION AND RESPONSIBILITIES.  • CONDUIT SCHEDULE: (1) 3/4" GENERAL POWER & (1) 3/4" DATA
8	SAW CUT (TRENCH) TO WORKSHOP TABLE. SEE WIRING DETAILS ON SHEET E502 FOR ADDITIONAL INFORMATION AND RESPONSIBILITIES.  • CONDUIT SCHEDULE:  (1) 1" GENERAL POWER & (1) 1" DATA TO EACH TABLE
9	PROVIDE DATA BOX ABOVE CEILING FOR SHOPPER TRACKER. OWNER'S VENDOR WILL EXTEND CABLING BACK TO TELEPHONE BACK BOARD.
10	ROUGH IN FOR JCI KEYPAD. MOUNT AT 48" A.F.F COORDINATE EXACT LOCATION WITH SECURITY COMPANY.
11	ELECTRICAL EQUIPMENT. SEE ONE LINE DIAGRAM ON SHEET E301. T.G.C. TO

PROVIDE ALL NEC CLEARANCES.

(##)	NOTES
12	PROVIDE TELEPHONE BACKBOARD. SEE ELEVATION ON SHEET E302 FOR DETAILS.
13	PROVIDE 2" CONDUIT AND PULL CORD FROM LANDLORD TELEPHONE BACKBOARD TO THE TENANT TELEPHONE BACKBOARD.
14	PROVIDE (1) 4" CONDUIT FOR JCI CABLES.
15	PROVIDE (2) 4" CONDUIT FOR CAT6 RT CABLES.
16	PROVIDE CONNECTION TO AUTOMATIC HAND DRYER AT 34" A.F.F. (HAND DRYER FURNISHED BY OWNER THROUGH LIGHTING VENDOR). SEE ARCHITECTURAL DETAILS FOR LOCATION.
17	EXISTING ELECTRIC WATER COOLER TO REMAIN: MAINTAIN EXISTING RECEPTACLE AND CIRCUIT.
18	INSTALL OWNER SUPPLIED ENTOUCH.ONE MASTER CONTROLLER THERMOSTAT, ZONE TEMPERATURE SENSOR AND DUCT TEMPERATURE SENSOR. MOUNT THERMOSTAT AT 48" A.F.F PROVIDE AND PULL CATS CABLE FROM ET1 THERMOSTAT TO OPEN PORT ON CUSTOMER NETWORK SWITCH. MOUNT ZONE TEMPERATURE SENSOR AT 60" A.F.F. AND WIRE TO THE S2 & S2 RTN. MOUNT DUCT TEMPERATURE SENSOR IN THE MAIN SUPPLY DUCT WITHIN 6 FEET FROM UNIT AND WIRE TO S2 & S2 RTN. CABLE RUNS AND TERMINATIONS BY MC/GC (CABLE PULL).
19	REFER TO MONITOR MOUNTING DETAILS ON ARCHITECTURAL DRAWINGS.
20	PROVIDE MOTOR RATED SWITCH FOR RECIRCULATION PUMP DISCONNECT. CONNECT TO CIRCUIT INDICATED USING 2#12, #12G, IN 3/4" CONDUIT AND PROVIDE FINAL CONNECTIONS AFTER PLUMBER INSTALLATION.
21	EXISTING BOH FURNITURE TO BE REPLACED AND/OR RELOCATED, POWER AND DATA DEVICES TO REMAIN: PROVIDE NEW ONLY IF NEEDED.
22	EXISTING ROOF MOUNTED CONDENSING UNIT TO REMAIN: MAINTAIN EXISTING CIRCUITING. CONTROL WITH NEW THERMOSTAT.
23	RELOCATED FAN COIL: FIELD VERIFY POWER AND CONTROL WIRING REQUIREMENTS. FAN COIL POWERED FROM EXISTING CONDENSING UNIT.

## A. ELECTRICAL CONTRACTOR TO LABEL ALL RECEPTACLES AND PROVIDE A TYPE-WRITTEN PANEL SCHEDULE INSIDE THE ELECTRICAL PANEL. B. ALL WORK SHALL COMPLY WITH THE CURRENTLY ADOPTED CODES, ORDINANCES, AND C. ALL EQUIPMENT SHALL BE LISTED BY A RECOGNIZED TESTING LAB (i.e. U.L., ETC.) D. PROVIDE PLENUM RATED WIRING WHERE REQUIRED. COMPLY WITH NEC 300.22. E. PROPERLY GROUND RECEPTACLES, BOXES AND COVER PLATES INSTALLED IN FIXTURES PER NEC 250 AND 406. F. NO BX, AC OR ROMEX TYPE WIRING ALLOWED IN WALLS. G. ALL LOW VOLTAGE WIRING TO BE IN CONDUIT UNLESS OTHERWISE APPROVED BY AUTHORITY HAVING JURISDICTION.

**GENERAL NOTES** 

WITH A COMMISSIONING AUTHORITY TO COMPLY WITH LOCAL CODES.

## WIRING SYMBOLS

▲ DUPLEX RJ45 JACK X2 W/ 2 CAT5e WIRES

X2 OVERHEAD SHOPPER TRACKER CABLING

X3 W/ 3 CAT5e WIRES ▲ QUADPLEX RJ45 JACK X4 W/ 4 CAT5e WIRES

WHEN REQUIRED, IT IS THE OWNERS RESPONSIBILITY TO CONTRACT

X3 (A) OVERHEAD AP CABLING

**EXCLUSION ZONE MANAGER CLG DTL** 

MANAGER

-DEDICATED

FIXTURE CIRCUITING DETAIL

CIRCUIT FOR

DIGITAL DISPLAY

ALL RECEPTACLES SHOWN CIRCUITED

 LOCATE InVue 52 cm EXCLUSION ZONE MANAGER 36" FROM

PROVIDE CEILING MOUNTED DUPLEX RECEPTACLE NEXT TO

InVue 52 cm EXCLUSION ZONE

ENTRY DOOR(S)

TO CIRCUIT#