GOVERNIN	IG CODES	SITE PR	OJECT DATA				S	HEET INDEX			
3 PIKES PEAK REGIONAL BUILDING CO		SITE DATA		LATEST LATEST DELTA ISSUE	SHEET NUMBER SHEET TITLE	LATEST LATEST DELTA ISSUE	SHEET NUMBER	SHEET TITLE	LATEST LATEST SHE DELTA ISSUE NUM		
1 INTERNATIONAL BUILDING CODE (IB0 1 INTERNATIONAL EXISTING BUILDING	5 CODE (IEBC)	GROSS AREA	: 1,479,800 S.F. (33.97 AC) : PBC. (PLANNED BUSINESS CENTER)					FOUNDATION DETAILS FOUNDATION DETAILS	GENERAL	01 COVERSHEET & SHEET INDEX	
1 INTERNATIONAL ENERGY CONSERV, 1 INTERNATIONAL MECHANICAL CODE	VATION CODE (IECC)	ZONING	: PBC (PLANNED BUSINESS CENTER) AO (AIRPORT OVERLAY)				5404	FOUNDATION DETAILS	GOO	02 COVERSHEET-IECC REPORT	
1 INTERNATIONAL FUEL GAS CODE (IF 1 INTERNATIONAL PLUMBING CODE (IF	IFGC)	LOT COVERAGE % LANDSCAPE AREA	: 30% : 275,171 SF (24.0%)					FRAMING DETAILS FRAMING DETAILS	ARCHITECTURAL	D3 ADA DETAILS	
NATIONAL ELECTRICAL CODE (IF NATIONAL ELECTRICAL CODE (NEC) THE ADOPTED FIRE CODE OF THE (	5)						5503	FRAMING DETAILS	AO	01 MASTER SITE PLAN	Butler Design Gr
COLORADO BASED ON THE 2021 IN	INTERNATIONAL FIRE CODE (IFC)		REQUIRED PROVIDED					FRAMING DETAILS ROOF FRAMING DETAILS		D2PARTIAL SITE PLAN - SHOWROOMD3PARTIAL SITE PLAN - WAREHOUSE	architects & planners
9 ICC/ANSI A117.1 ACCESSIBILITY STAN		SHOWROOM (M)         123,475 S.F.           WAREHOUSE (S-1)         211,385 S.F.	: 212 SPACES AT 1:1000	LATEST LATEST DELTA ISSUE	SHEET NUMBER SHEET TITLE			ROOF FRAMING DETAILS ROOF FRAMING DETAILS		04ENLARGED SITE PLANS & DETAILS05SCREEN WALL ELEVATIONS	5017 East Washingtor Phoenix, Arizona 8503
AL AMENDMENTS TO THE ABOVE REFE PTED ORDINANCES OF THE AUTHORIT	•		<u>F.</u> : <u>35 SPACES AT 1:1000</u> . : 453 SPACES				5604	ROOF FRAMING DETAILS	AOC	06 SCREEN WALL ELEVATIONS	Phone 602-957-180
					MC1 MASTER COVER SHEET CM1 PPCM PLAN COVER SHEET			ROOF FRAMING DETAILS ROOF FRAMING DETAILS	AO AO	11 SITE DETAILS 12 SITE DETAILS	
		ACCESSIBLE (UNIVERSAL) @2%	:11 SPACES : 12 SPACES		CM2 PPCM PLAN CM3 PPCM DETAILS			TILT PANEL DETAILS	AO	I3 SITE DETAILS	
PROJECT DE	25CRIPTION	PARKING DIMENSIONS STANDARD (W/2'-0" OVERHANG)	<u>PROVIDED</u> : 9'X18'		CM4 PPCM DETAILS			STAIR FRAMING DETAILS & PLANS STAIR FRAMING DETAILS & PLANS	A11 A11	0 EXIT PLAN 11 SHOWROOM FLOOR PLAN	PRÉLIMINAR
RICAN FURNITURE WAREHOUSE IS PRO		ACCESSIBLE (W/2'-0" OVERHANG)	: 11'X18' W/ 5' AISLE : 24'/26'/30'		C1.0 SWPPP COVER SHEET C1.1 SWPPP COVER SHEET	MECHANICAL	M001	MECHANICAL, SYMBOLS, LEGEND AND NOTES		<ul><li>2 PARTIAL WAREHOUSE FLOOR PLAN</li><li>3 PARTIAL WAREHOUSE FLOOR PLAN</li></ul>	NOT FOR
NDING BUILDING, LOCATED WITHIN AN , CITY OF COLORADO SPRINGS COMPF	N AREA DEFINED IN EL PASO COUNTY IN PREHENSIVE PLAN AS A ZONE DISTRICT	DRIVE AISLES	: 24/26/30		C4.00 SMPPP KEY MAP PLAN		M111	PARTIAL SHOWROOM FLOOR PLAN MECHANICAL	A11	5 ENLARGED MAIN ENTRY-OFFICES	CONSTRUCTI
(COMERCIAL COMMUNITY), I-3 (HEAVY	Y INDUSTRY) AND IS A PORTION OF THAT ELOPMENT PROJECTS AS COMMERCIAL	SETBACKS			C4.01 SWPPP PLAN & PROFILES C4.02 SWPPP PLAN & PROFILES	_		PARTIAL SHOWROOM FLOOR PLAN MECHANICAL PARTIAL WAREHOUSE FLOOR PLAN MECHANICAL	A11		
ORT OVERLAY.		BUILDING SETBACKS FRONT	REQUIRED         PROVIDED           : 25'         : 323'-2"		C4.03 SWPPP PLAN & PROFILES		M114	PARTIAL WAREHOUSE FLOOR PLAN MECHANICAL		8 PARTIAL MEZZANINE PLAN	
	FOR SALE OF FURNITURE AND OFFICE	SIDE (EAST)	: 25' : 74'-2"		C4.04SWPPP PLAN & PROFILESC4.05SWPPP PLAN & PROFILES			ENLARGED FLOOR PLANS MECHANICAL ENLARGED FLOOR PLANS MECHANICAL	A12	21 SHOWROOM FLOOR OUTLET PLAN 21 SHOWROOM REFLECTED CEILING OUTLET PLAN	OWNERSHIP OF INSTRUMENTS OF SER All reports, plans, specifications, computer files, field other documents and instruments prepared by the des as instruments of service shall remain the property of 1
ORT AREAS AND WAREHOUSE STORA	RAGE.	SIDE (WEST) REAR	: 25' : 278'-7" : 25' : 127'-11"		C4.06 SWPPP KEY MAP PLAN		M117	SHOWROOM MEZZANINE FLOOR PLAN MECHANICAL	A15	31 SHOWROOM REFLECTED CEILING PLAN	as instruments or service shall remain the property or professional. The design professional shall retain all c statutory and other reserved rights, including the cop
					C4.07SWPPP PLAN & PROFILESC4.08SWPPP PLAN & PROFILES			PARTIAL WAREHOUSE MEZZANINE FLOOR PLAN MECHANICAL	A15		
LEGAL DES	SCRIPTION	BUILDING	PROJECT DATA		C4.09 SWPPP PLAN & PROFILES		M119	PARTIAL WAREHOUSE MEZZANINE FLOOR PLAN MECHANICAL	A13	PARTIAL MEZZANINE REFLECTED CEILING PLAN	
					C4.10SWPPP PLAN & PROFILESC4.11SWPPP PLAN & PROFILES		M201	MECHANICAL ROOF PLAN		95PARTIAL MEZZANINE REFLECTED CEILING PLAN96ENLARGED MAIN ENTRY OFFICE REFLECTED CEILING	
	LED AT RECEPTION NO. 208068886 AND HE WEST HALF OF SECTION 7, TOWNSHIP	BUILDING DATA BUILDING OCCUPANCY	: M/ 5-1 / F-1		C4.12 SWPPP KEY MAP PLAN C4.13 SWPPP PLAN & PROFILES			MECHANICAL SCHEDULE MECHANICAL SCHEDULE		PLAN 37 ENLARGED MAINTENANCE REFLECTED CEILING PLN	
	P.M. CITY OF COLORADO SPRINGS, EL	CONSTRUCTION TYPE	: M/ 5-1 / F-1 : VB, UNLIMITED AREA		C4.14 SWPPP PLAN & PROFILES			MECHANICAL DETAILS		8 PARTIAL MEZZANINE REFLECTED CEILING PLAN - LOW	
		SHOWROOM (M)	: 123,475 G.S.F.		C4.15 SWPPP PLAN & PROFILES C4.16 SWPPP PLAN & PROFILES	PLUMBING	P001	SCHEDULES - PLUMBING	Α15	9 PARTIAL MEZZANINE REFLECTED CEILING PLAN - LOW 41 SHOWROOM FINISHES FLOOR PLAN	
NING 1,479,800 SQ. FT. OR 33.972 A	AUREJ, MURE UT LESS	WAREHOUSE (S-1) MAREHOUSE MEZZANINE (F-1)	: 211,385 G.S.F. : 34,240 G.S.F.		C4.17 SWPPP PLAN & PROFILES		P002	CALCULATIONS - PLUMBING		2 SHOWROOM FINISHES ENLARGED FLOOR PLAN	
		TOTAL BUILDING AREA	: 369,100 G.S.F.		C4.18 SWPPP PLAN & PROFILES C4.19 SWPPP DETAILS			PARTIAL SHOWROOM FLOOR PLAN PLUMBING PARTIAL SHOWROOM FLOOR PLAN PLUMBING	A12	3 SHOWROOM FINISHES ENLARGED FLOOR PLAN 4 SHOWROOM FINISHES ENLARGED FLOOR PLAN	
		4			C4.20 SWPPP DETAILS		P113	PARTIAL WAREHOUSE FLOOR PLAN PLUMBING	A14	5 SHOWROOM FINISHES ENLARGED FLOOR PLAN	
CONTA	ACTS	FIRE RATING			C4.21 SWPPP DETAILS C4.22 SWPPP DETAILS			PARTIAL WAREHOUSE FLOOR PLAN PLUMBING ENLARGED FLOOR PLANS PLUMBING	A14	6 WAREHOUSE FINISHES FLOOR PLAN 17 WAREHOUSE FINISHES FLOOR PLAN	
		FIRE RESISTANCE RATING REQUIREM	IENTS FOR TYPE 'VB' CONSTRUCTION PER IBC		GEC1 GRADING EROSION SEDIMENT QUALITY CONTROL			ENLARGED FLOOR PLANS PLUMBING PARTIAL MEZZANINE PLAN PLUMBING		8 WAREHOUSE MEZZANINE FINISHES FLOOR PLAN	
	ARCHITECT	TABLE 601 & 602			EC1 GRADING EROSION SEDIMENT QUALITY CONTROL		P118	PARTIAL MEZZANINE PLAN PLUMBING		MAREHOUSE MEZZANINE FINISHES FLOOR PLAN51ENLARGED RESTROOM PLANS / ELEVATIONS	
	BUTLER DESIGN GROUP	SPRINKLERS: STRUCTURAL FRAME:	: FULL AUTOMATIC SYSTEM : N.R.		PLAN           EC2         GRADING EROSION SEDIMENT CONTROL PLAN	_		ROOF PLAN SHOWROOM PLUMBING ROOF PLAN WAREHOUSE WEST PLUMBING	A15	2 ENLARGED RESTROOM PLANS / ELEVATIONS 3 ENLARGED RESTROOM PLANS / ELEVATIONS	
00D, CO 880112 s	5017 E WASHINGTON STREET SUITE 100	EXTERIOR BEARING WALLS: INTERIOR BEARING WALLS:	: N.R. : N.R.		EC3 GRADING EROSION SEDIMENT CONTROL PLAN		P213	ROOF PLAN WAREHOUSE EAST PLUMBING		4 ENLARGED RESTROOM PLANS / ELEVATIONS	
T: NOLAN MORRISON	PHOENIX, AZ 85034 PHONE: (602) 957-1800	INTERIOR NON-BEARING WALLS:	: N.R.		EC4 GRADING EROSION SEDIMENT QUALITY CONTROL PLAN		P311	WASTE & VENT SCHEMATIC - PLUMBING	A15		
	CONTACT: TOBY RODGERS	FLOOR CONSTRUCTION ROOF CONSTRUCTION	: N.R. : N.R.		EC5 GRADING EROSION SEDIMENT QUALITY CONTROL DETAILS			ELECTRICAL NOTES & SYMBOLS	A15	7 INTERIOR ELEVATIONS	tor (SZ
	LANDSCAPE ARCHITECT	SHAFT ENCLOSURES: (ALL WOOD TO BE FIRE RETARDANT	: N.R. T)		EC6 GRADING EROSION CONTROL PLAN - INTERIM			ELECTRICAL NOTES & SYMBOLS LUMINAIRE SCHEDULE & ENERGY CALCS	A15	8 INTERIOR MILLWORK ELEVATION 9 INTERIOR MILLWORK ELEVATION	H H H
	LASKIN & ASSOCIATES				EC7GRADING EROSION CONTROL PLAN - FINALEC8GRADING EROSION CONTROL PLAN - FINAL		E004	LUMINAIRE SCHEDULE & ENERGY CALCS	A2	11 ROOF PLAN-SHOWROOM	
NASHINGTON ST, SUITE 108	5017 E WASHINGTON STREET SUITE 110	ALLOWABLE AREA			EC9 GRADING EROSION CONTROL DETAILS			ELECTRICAL SITE PLAN SITE LIGHTING PLAN		2 ROOF PLAN-WAREHOUSE WEST 3 ROOF PLAN- WAREHOUSE EAST	
(303) 801-2911 f	PHOENIX, AZ 85034	(AUTOMATIC SPRINKLER ESFR AT			EC10GRADING EROSION CONTROL DETAILSG1GRADING KEY MAP PLAN		E013	PHOTOMETRIC SITE PLAN		4 CLERESTORY PLANS AND DETAILS	* <b></b> > <b>_</b> Z
	PHONE: (602) 840-7771 CONTACT: DANIEL DODSON	AREA INCREASE DUE TO 60 YARI	DS AT ALL SIDES: UNLIMITED AREA		G2 GRADING & DRAINAGE PLAN			LIGHT FIXTURE CUT SHEET FUEL STATION CONDUIT PLAN	A2	<ul><li>CANOPY PLANS AND DETAILS</li><li>OVERALL EXTERIOR BUILDING ELEVATIONS</li></ul>	
					G3GRADING & DRAINAGE PLANG4GRADING & DRAINAGE PLAN		E101	PARTIAL SHOWROOM LIGHTING PLAN	A30	22 ENLARGED PARTIAL ELEVATIONS	
	MECHANICAL/PLUMBING				G5 GRADING & DRAINAGE PLAN			PARTIAL SHOWROOM LIGHTING PLAN PARTIAL WAREHOUSE LIGHTING PLAN		D3ENLARGED PARTIAL ELEVATIONSD4ENLARGED PARTIAL ELEVATIONS	
. MCDONALD DRIVE	KRAEMER ENGINEERING, INC. 2050 W. WHISPERING WIND DRIVE				G6GRADING & DRAINAGE PLANG7GRADING & DRAINAGE PLAN			PARTIAL WAREHOUSE LIGHTING PLAN ENLARGED MAIN ENTRY-OFFICES LTG	A30	D5 ENLARGED PARTIAL ELEVATIONS	
SDALE, AZ 85250	SUITE 158 PHOENIX, AZ 85085	HEIGHT CALCULATIONS			G8 GRADING & DRAINAGE PLAN G9 GRADING & DRAINAGE PLAN	_	E106	ENLARGED CAFE-CUST PICKUP / SALES MEZZ LTG		D6ENLARGED PARTIAL ELEVATIONSD7ENLARGED PARTIAL ELEVATIONS	
	PHONE: (602) 285-1669	ALLOWABLE BUILDING HEIGHT PER IE ALLOWABLE BUILDING HEIGHT	<u>BC TABLE 504.4</u> : 3 STORIES, 55'- <i>0</i> "		G10 GRADING & DRAINAGE PLAN			ENLARGED MAINTENANCE LTG PLAN PARTIAL MEZZANINE LIGHTING PLAN		28 ENLARGED PARTIAL ELEVATIONS 21 DOOR TYPES	
		(CODE) AUTOMATIC SPRINKLER	: 75'-0"		G11 GRADING & DRAINAGE PLAN P1 PAVING KEY MAP PLAN		E109	PARTIAL MEZZANINE LIGHTING PLAN	A40	DOOR SCHEDULES	nor 1
RICAL		PROVIDED BUILDING HEIGHT	: 1 STORIES, 41'-7" T.O.D., 50"		P2 PAVING PLAN			PARTIAL SHOWROOM POWER PLAN PARTIAL SHOWROOM POWER PLAN		D3     WINDOW TYPES       D4     WINDOW TYPES	A U
ER ENGINEERING, INC. 1. WHISPERING WIND DRIVE			TOWER MAX.		P3         PAVING PLAN           P4         PAVING PLAN		E203	PARTIAL WAREHOUSE POWER PLAN	A50	D1 BUILDING SECTIONS	
58 X, AZ 85085		EXITING CALCULATIONS			P5 PAVING PLAN			PARTIAL WAREHOUSE POWER PLAN ENLARGED MAIN ENTRY-OFFICES POWER PLAN		D2 BUILDING SECTIONS D4 WALL SECTIONS	
(602) 708-1389		SEE SHEET A110 FOR EXITING CALCU	ILATIONS, OCCUPANT LOADS AND PROVIDED		P6         PAVING PLAN           P7         PAVING PLAN	-		ENLARGED CUSTOMER PICKUP POWER ENLARGED MAINTENANCE POWER PLAN	A50	D5 WALL SECTIONS	
CT: MARK BENTLEY		TRAVEL DISTANCES			51 WASTEWATER SERVICE PLAN COVER SHEET		E208	PARTIAL MEZZANINE POWER PLAN		D6     WALL SECTIONS       D7     WALL SECTIONS	
		PI UMRING FIXT	URE CALCULATIONS		S2WASTEWATER SERVICE PLAN GENERAL NOTESS3WASTEWATER SERVICE KEY MAP PLAN			PARTIAL MEZZANINE POWER PLAN PARTIAL SHOWROOM SPECIAL SYSTEMS PLAN	A50	08 WALL SECTIONS	
					54WASTEWATER SERVICE PLAN55WASTEWATER SERVICE PLAN	_	E302	PARTIAL SHOWROOM SPECIAL SYSTEMS PLAN		09       INSET WALL SECTIONS         0       STAIR PLANS AND DETAILS	
		MINIMUM PLUMBING FACILITIES (IBC C PER TABLE 2902.1 (REQUIRED/PROV	-		U1 UTILITY SERVICE PLAN COVER SHEET			PARTIAL WAREHOUSE SPECIAL SYSTEMS PLAN PARTIAL WAREHOUSE SPECIAL SYSTEMS PLAN	A5	11STAIR PLANS AND DETAILSD1DOOR DETAILS	
					U2 UTILITY SERVICE PLAN GENERAL NOTES U3 UTILITY SERVICE KEY MAP PLAN	_	E305	ENLARGED MAIN ENTRY-OFFICES SPECIAL SYSTEMS	A60	22 WINDOW DETAILS	
		OCCUPANCY WATER CLOSETS*	LAVATORIES DRINKING SERV FOUNTAIN SINK		U4 UTILITY SERVICE PLAN		E306	PLAN ENLARGED CUSTOMER PICKUP / SALES SPECIAL		21     ARCHITECTURAL DETAILS       22     ARCHITECTURAL DETAILS	
		USE         LOAD         RATIO         M         RATIO           M         2042/2= 1021         1 PER 500         2/9         1 PER 500         2	2/10 1 PER 2/6 1 PER 2/7 1 PER 2/4 1	1	U5 UTILITY SERVICE PLAN U6 UTILITY SERVICE PLAN			SYSTEMS PLAN ENLARGED MAINTENANCE SPECIAL SYSTEMS PLAN	ATC	ARCHITECTURAL DETAILS	
			2/10         750         2/10         750         2/1         1000         2/4         1           1         PER         1         PER         1         PER         1         1		W1 WATER PLAN COVER SHEET		E308	PARTIAL MEZZANINE SPECIAL SYSTEMS PLANS		04     ARCHITECTURAL DETAILS       05     ARCHITECTURAL DETAILS	
		F/5 769/2= 1 PER 1/00 4/8 1 PER 100	4/5 1 PER 1/7 1 PER 1/5 1 PER 4/5 1 PER 1/4 1	J	W2WATER PLAN GENERAL NOTESW3WATER KEY MAP PLAN			PARTIAL MEZZANINE SPECIAL SYSTEMS PLANS PARTIAL SHOWROOM HVAC POWER PLAN	ATC	06 ARCHITECTURAL DETAILS	Case #:
		EYEWASH REQUIRED			M4 WATER PLAN		E402	PARTIAL SHOWROOM HVAC POWER PLAN		D7     ARCHITECTURAL DETAILS       D1     ARCHITECTURAL ROOF DETAILS	Plan Check #: Date:
VICINIT		*419.2 SUBSTITUTION FOR WATER			W5     WATER PLAN       W6     WATER PLAN			PARTIAL WAREHOUSE HVAC POWER PLAN PARTIAL WAREHOUSE HVAC POWER PLAN	Aða	2 ARCHITECTURAL ROOF DETAILS	
		URINALS SHALL NOT BE SUBSTITUT WATER CLOSETS IN ALL OTHER OU	TED FOR MORE THAN 50% OF THE REQUIRED		W7WATERMAIN PLAN & PROFILEW7.1WATERMAIN PLAN & PROFILE		E405	ENLARGED MAIN ENTRY-OFFICES HVAC POWER PLAN	STRUCTURAL 500	01 GENERAL STRUCTURAL NOTES	Revisions:
. WOODMEN RD	E. WOODMEN RD				W1.1     MATERMAIN PLAN & PROFILE       W7.2     WATERMAIN PLAN & PROFILE			ENLARGED CAFE-CUST PICKUP / SALES MEZZ HVAC POWER PLAN	500	02 GENERAL STRUCTURAL NOTES 03 TYPICAL DETAILS	
		SEPARAT	E SUBMITTALS		W7.3WATERMAIN PLAN & PROFILEW7.4WATERMAIN PLAN & PROFILE			ENLARGED MAINTENANCE HVAC POWER PLAN PARTIAL MEZZANINE HVAC POWER PLAN	500	04 TYPICAL DETAILS	
				-	W7.5 WATERMAIN PLAN & PROFILE		E409	PARTIAL MEZZANINE HVAC POWER PLAN		D5TYPICAL DETAILSD6TYPICAL DETAILS	
		<ul><li>FIRE SPRINKLERS</li><li>FIRE ALARMS</li></ul>			W7.6WATER SERVICE PLAN & PROFILEW7.7WATER SERVICE PLAN & PROFILE	_		ONE LINE DIAGRAM SES-A ONE LINE DIAGRAM SES-B	500	07 TYPICAL DETAILS	
(2) C		<ul> <li>OFFSITE IMPROVEMENTS</li> <li>SIGNAGE</li> </ul>			W7.8 WATER SERVICE PLAN & PROFILE		E513	FEEDER SCHEDULES		08 SCHEDULE 09 WIND PRESSURE DIAGRAMS	
SISTERS GROVE					W7.9WATER SERVICE PLAN & PROFILEW7.10WATER SERVICE PLAN & PROFILE			ONE LINE DIAGRAM / DETAILS, NOTES PANELBOARD SCHEDULES	51 <sup>°</sup>	1 SHOWROOM - FOUNDATION PLAN	
ê /			D SUBMITTALS	LANDSCAPE			E612	PANELBOARD SCHEDULES		2 WAREHOUSE - WEST FOUNDATION PLAN 3 WAREHOUSE - EAST FOUNDATION PLAN	
	MESA POINT				L.01LANDSCAPE COVER SHEETL.02LANDSCAPE PLANS			PANELBOARD SCHEDULES PANELBOARD SCHEDULES	512	21 WAREHOUSE - PARTIAL MEZZANINE FRAMING PLAN	
	BLACK FORREST RD	• STEEL JOISTS, JOIST GIRDERS	AND TRUSSES		L.03 LANDSCAPE PLANS		E615	PANELBOARD SCHEDULES		22 WAREHOUSE - PARTIAL MEZZANINE FRAMING PLAN 11 SHOWROOM - ROOF FRAMING PLAN	
					L.04 LANDSCAPE PLANS L.05 LANDSCAPE PLANS			PANELBOARD SCHEDULES PANELBOARD SCHEDULES	52	2 WAREHOUSE WEST - ROOF FRAMING PLAN	Project Number:
SITE	/ /	SPECIAL	INSPECTIONS		L.06 IRRIGATION PLANS		E618	PANELBOARD SCHEDULES		<ul><li>3 WAREHOUSE EAST - ROOF FRAMING PLAN</li><li>4 ENLARGED FRAMING PLANS</li></ul>	Drawn By:
					L.07 IRRIGATION PLANS L.08 IRRIGATION PLANS		E619	PANELBOARD SCHEDULES	52	5 ENLARGED FRAMING PLANS	Title:
		SEE STRUCTURAL FOR ADDITIO	DNAL REQUIREMENTS		L.09 IRRIGATION PLANS					21 ENLARGED FRAMING PLANS 22 ENLARGED FRAMING PLANS	COVERSHEET
	)				L.10 LANDSCAPE DETAILS	_				22 ENLARGED FRAMING FLANS 21 TILT PANEL ELEVATIONS	
	DUBLIN BLVD				L.11 IRRIGATION DETAILS						
	DUBLIN BLVD				L.12 SPECIFICATION				530	D2 TILT PANEL ELEVATIONS D3 PANEL TYPES	
	DUBLIN BLVD								530 530 530	D2TILT PANEL ELEVATIONSD3PANEL TYPESD4PANEL TYPESD5PANEL TYPES	G00

ARCHITECTURA	AL SYMBOLS	COMcheck	Software Ver	sion 4.1	5.1			
Ę	CENTERLINE REFERENCE	Envelop	e Complia	nce Co	ertifi	icate		
CJ EJ PJ MCJ CONTROL EXPANSION PANEL MASONR CONTROL		Project Information						
#	KEYNOTE SYMBOL	Energy Code: Project Title:	2015 IECC American Furniture War					
$\mathbf{x}$	WINDOW SYMBOL	Location: Climate Zone: Project Type:	Colorado Springs, Color 5b New Construction	ado				
#	DOOR SYMBOL	Vertical Glazing / Wall Area: Skylight / Roof Area	2% 0%					
#	TOILET ROOM ACCESSORIES	Construction Site:	Owner/Agent:			gner/Contract		
#	WALL TYPE	American Heights Colorado Springs, CO 80923	Nolan Morrison American Furniture American Furniture Englewood, CO 801	Warehouse	But 501 Pho	oenix, AZ 85	Group ngton St #107 5034	7
#	MATERIAL FINISH	Additional Efficiency Package(s)	303-489-3333 nmorrison@afwonli	ne.com		8-957-1800 Idl@butlerde	esigngroup.co	ım
#	PANEL NUMBER	High efficiency HVAC. Systems that do not report.		ment will be identi	fied in the m	iechanical rec	quirements chec	cklist
<u> </u>	CEILING HEIGHT SYMBOL	Building Area		Floor A				
-+	VERTICAL ELEVATION	Envelope Assemblies		122				
+ <i>O</i> '- <i>O</i> " F.F.	PLAN SPOT ELEVATION	Assembly			Cavity R-Value	Cont. R-Value	Proposed U-Factor	Budget U- Factor <sub>(a)</sub>
· · · · · · · · · · · · · · · · · · ·	COLUMN GRID REFERENCE	Showroom Roof: Insulation Entirely Above I		<b>Perimeter</b> 122500		30.0	0.032	0.032
MAT. OQLOR	EXTERIOR MATERIAL SYMBOL	Skylight 1: Metal Frame with Thermal Break Specs.: Product ID Trufflite HWHS, SHGC ( Retail] (b)	0.26, [Bldg. Use 1 -	640			0.260	0.500
	DETAIL CUT REFERENCES	Floor 1: Slab-On-Grade:Heated, Vertical 1 f <u>NORTH</u> North Wall: Solid Concrete:8" Thickness, No		4750 9948	 13.0	19.0 9.0	0.970	0.790
	ELEVATION REFERENCE	Metal, [Bldg. Use 1 - Retail] HM Door: Insulated Metal, Swinging, [Bldg.		141			0.540	0.370
# 	WALL SECTION CUT REFERENCE	<u>EAST</u> East Wall: Solid Concrete:10'' Thickness, N Metal, [Bldg. Use 1 - Retail]	lormal Density, Furring:	9750	13.0	9.0	0.062	0.090
# 	BUILDING SECTION CUT REFERENCE	Door 5: Insulated Metal, Swinging, [Bldg. Us Door 6: Insulated Metal, Non-Swinging, [Bld	-	71 168			0.540 0.540	0.370 0.179
ARCH. ABBRE	EVIATIONS	<u>SOUTH</u> South Wall: Solid Concrete:8'' Thickness, N Metal, [Bldg. Use 1 - Retail]	lormal Density, Furring:	9606	13.0	9.0	0.062	0.090
	HED FLOOR PTD PAINT(ED) HED GRADE QTY QUANTITY	Main Entry: Glass (> 50% glazing):Metal Fra Specs.: Product ID Solar Ban 70 XL, SHGC Retail] (b)		512			0.240	0.770
CONCRETE FOC FACE ACC ACCESSIBLE FOS FACE	OF COLUMN RAD RADIUS OF STUDS R&R REMOVE AND OF MULLION REPLACE	Cafe Entry: Glass (> 50% glazing):Metal Fra		384			0.240	0.770
DISABILITIES ACT FOM FACE ADJ ADJUSTABLE FS FIRE AFF ABOVE GA GAUG	E OF WALL RD ROAD SPRINKLER REC RECOMMEND SE REF REFER,	Project Title: American Furniture Wa Data filename: C:\Users\omuro\Docum		orings.cck			Report d Pag	date: 04/21/21 ge 1 of 10
ALT ALTERNATE DISPO ANSI AMERICAN GYP BD GYPS	5UM BOARD REQ'D REQUIRED	COMcheck	Software Ver	sion 4.1	.5.1			
	DER RM ROOM DWARE ROW RIGHT-OF-WAY		oe Complia	nce C	ertif	icate	;	
ARCH ARCHITECT HR HOUR AVE AVENUE HT HEIGH	HT SES SERVICE							
BLDGBUILDINGHVACHEATCABCABINETVENTCGCORNER GUARDAND	ILATING, SECTION	Project Information Energy Code:	2015 IECC					
CJ CONTROL JOINT CONI	DITIONING SPEC SPECIFICATION JDE(D) SS STAINLESS RIOR STEEL	Project Title: Location: Climate Zone:	American Furniture Wa Colorado Springs, Colo 5b					
CLR CLEAR LAV LAVA COL COLUMN MFR MANU	ATORY ST. STREET JFACTURER STD STANDARD	Project Type: Vertical Glazing / Wall Area:	New Construction					
CONT CONTINUE MEZZ MEZZ CORR CORRUGATED MCJ MASO	HANICAL STL STEEL ANINE STOR STORAGE ONRY STRUCT STRUCTURE,	Skylight / Roof Area	0%					
CT CERAMIC TILE MTL META	TROL JOINT STRUCTURAL AL SUBST SUBSTITUTE IN CONTRACT SYS SYSTEM	Construction Site: American Heights Colorado Springs, CO 80923	Owner/Agent: Nolan Morrison American Furnitur	e Warehouse	То	igner/Contract dd Lawrence Itler Design (	e	
DIA DIAMETER OC ON C DIM DIMENSION OCC OCCU	TO SCALE TEMP TEMPORARY ENTER TOW TOP OF WALL JPANT TRD TREAD		American Furnitur Englewood, CO 80 303-489-3333 nmorrison@afwon	e Warehouse 112	50 Ph 60	17 E. Washin oenix, AZ 85 8-957-1800	ington St #107 5034	
DN DOWN DRAI DS DOWN SPOUT OH OVER	RHEAD NOTED	Additional Efficiency Package(s High efficiency HVAC. Systems that do not	3)				lesigngroup.co	
EDF ELECTRIC PERF PERF	OSITE VAR VARIABLE, FORATED VARIANCE,	report. Building Area	· · · · · · · · · · · · · · · · · · ·	Floor			1	
FOUNTAIN PJ PANE EJ EXPANSION JOINT PL PROF	PENDICULAR VARIATION EL JOINT VCT VINYL PERTY LINE COMPOSITION	1-Warehouse : Nonresidential		210				
ELEC ELECTRIC PLUMB PLUM ELEV ELEVATOR, PLYMD PLYM ELEVATION PNL. PANE	NOOD VERT VERTICAL EL W/ WITH	Envelope Assemblies						
EQ EQUAL PREF	PARATION, COVERING PARE WH WALL HYDRANT	Assembly		Gross Area or Perimeter	Cavity R-Value	Cont. R-Value		Budget U- Factor <sub>(a)</sub>
EXT EXTERIOR PROJ PRO.	GRAM WIN WINDOW JECT XFMR TRANSFORMER PERTY	Warehouse Roof: Insulation Entirely Above Warehouse]	e Deck, [Bldg. Use 1 -	210000		30.0	0.032	0.032
FE FIRE EXTINGUISHER		Skylight 1: Metal Frame with Thermal Brea Specs.: Product ID Trufflite HWHS, SHGC Warehouse] (b)	0.26, [Bldg. Use 1 -	640			0.260	0.500
		Floor 1: Slab-On-Grade:Heated, Vertical 1 Warehouse] (c)	ft., [Bldg. Use 1 -	7200		19.0	0.970	0.790
		<u>NORTH</u> North Wall: Solid Concrete:10" Thickness, Metal, [Bldg. Use 1 - Warehouse] HM Door: Insulated Metal, Swinging, [Bldg		23071 144	13.0	13.0	0.050 0.540	0.090 0.370
		<u>EAST</u> East Wall: Solid Concrete:10" Thickness, I		144 13577	 13.0	 13.0	0.540	0.370
		Metal, [Bldg. Use 1 - Warehouse] HM Door: Insulated Metal, Swinging, [Bldg		126			0.540	0.370
		<u>SOUTH</u> South Wall: Solid Concrete:10" Thickness, None, [Bldg. Use 1 - Warehouse]		19544		13.0	0.067	0.090
		HM Doors: Insulated Metal, Swinging, [Bld OH Door: Insulated Metal, Swinging, [Bldg		168 1112			0.540 0.540	0.370 0.370

Project Title: American Furniture Warehouse

Data filename: C:\Users\omuro\Documents\COMcheck\AFW CoSprings\_WH.cck

Assembly	Gross Area or Perimeter	Cavity R-Value	Cont. R-Value	Proposed U-Factor	Budget U- Factor <sub>(a)</sub>
Specs.: Product ID Solar Ban 70 XL, SHGC 0.27, [Bidg. Use 1 - Retail] (b)					
WEST West Wall: Solid Concrete:8" Thickness, Normal Density, Furring: Metal, [Bldg. Use 1 - Retail]	10476	13.0	9.0	0.062	0.090
HM Doors: Insulated Metal, Swinging, [Bldg. Use 1 - Retail]	141			0.540	0.370
<ul> <li>(a) Budget U-factors are used for software baseline calculations ON</li> <li>(b) Fenestration product performance must be certified in accordance</li> <li>(c) Slab-On-Grade proposed and budget U-factors shown in table a</li> </ul>	ce with NFRC and re			entation.	
Envelope PASSES: Design 6% better than code					

Compliance Statement: The proposed envelope design represented in this document is consistent with the building plans, specifications, and other calculations submitted with this permit application. The proposed envelope systems have been designed to meet the 2015 IECC requirements in COMcheck Version 4.1.5.1 and to comply with any applicable mandatory requirements listed in the Inspection Checklist. 4.22.21 Date Name - Title Signature

Project Title:	American Furniture Warehouse	Report date: 04/21/21
Data filename:	C:\Users\omuro\Documents\COMcheck\AFW CoSprings.cck	Page 2 of 10

Assembly	Gross Area or Perimeter	Cavity R-Value	Cont. R-Value	Proposed U-Factor	Budget U- Factor <sub>(a)</sub>
WEST West Wall: Solid Concrete:10" Thickness, Normal Density, Furring:	12852	13.0	13.0	0.050	0.090
Metal, [Bldg. Use 1 - Warehouse]					
Cust Pickup Storefront: Metal Frame:Fixed, Perf. Specs.: Product ID Oldcastle, SHGC 0.40, [Bldg. Use 1 - Warehouse] (b)	616			0.240	0.380
HM Doors: Insulated Metal, Swinging, [Bldg. Use 1 - Warehouse]	63		-	0.540	0.370
OH Door: Insulated Metal, Non-Swinging, [Bldg. Use 1 - Warehouse]	168			0.540	0.179
Cust Pickup Door: Glass (> 50% glazing):Metal Frame, Entrance Door, Perf. Specs.: Product ID Oldcastle, SHGC 0.40, [Bldg. Use 1 - Warehouse] (b)	24	-	-	0.240	0.770

(a) Budget U-factors are used for software baseline calculations ONLY, and are not code requirements.

(b) Fenestration product performance must be certified in accordance with NFRC and requires supporting documentation. (c) Slab-On-Grade proposed and budget U-factors shown in table are F-factors.

Envelope PASSES: Design 5% better than code Envelope Compliance Statement

Compliance Statement: The proposed envelope design represented in this document is consistent with the building plans, specifications, and other calculations submitted with this permit application. The proposed envelope systems have been designed to meet the 2015 IECC requirements in COMcheck Version 4.1.5.1 and to comply with any applicable mandatory requirements listed in the Inspection Checklist. 422.21

Name - Title



OWNERSHIP OF INSTRUMENTS OF SERVICE All reports, plans, specifications, computer files, field data, notes and other documents and instruments prepared by the design professional as instruments of service shall remain the property of the design professional. The design professional shall retain all common law, statutory and other reserved rights, including the copyright thereto.

Butler Design Group Inc. architects & planners

g




<b>O</b>	LE FU
	FESTY
	tour 📙
V	M


Case #: Plan Check #: Date: 10/15/24 Revisions:

G0(	)2
Title: COVERS	HEET-IECC REPORT
•	OM
Drawn By:	
	20068.100
Project Number:	


Project Title: American Furniture Warehouse Data filename: C:\Users\omuro\Documents\COMcheck\AFW CoSprings\_WH.cck



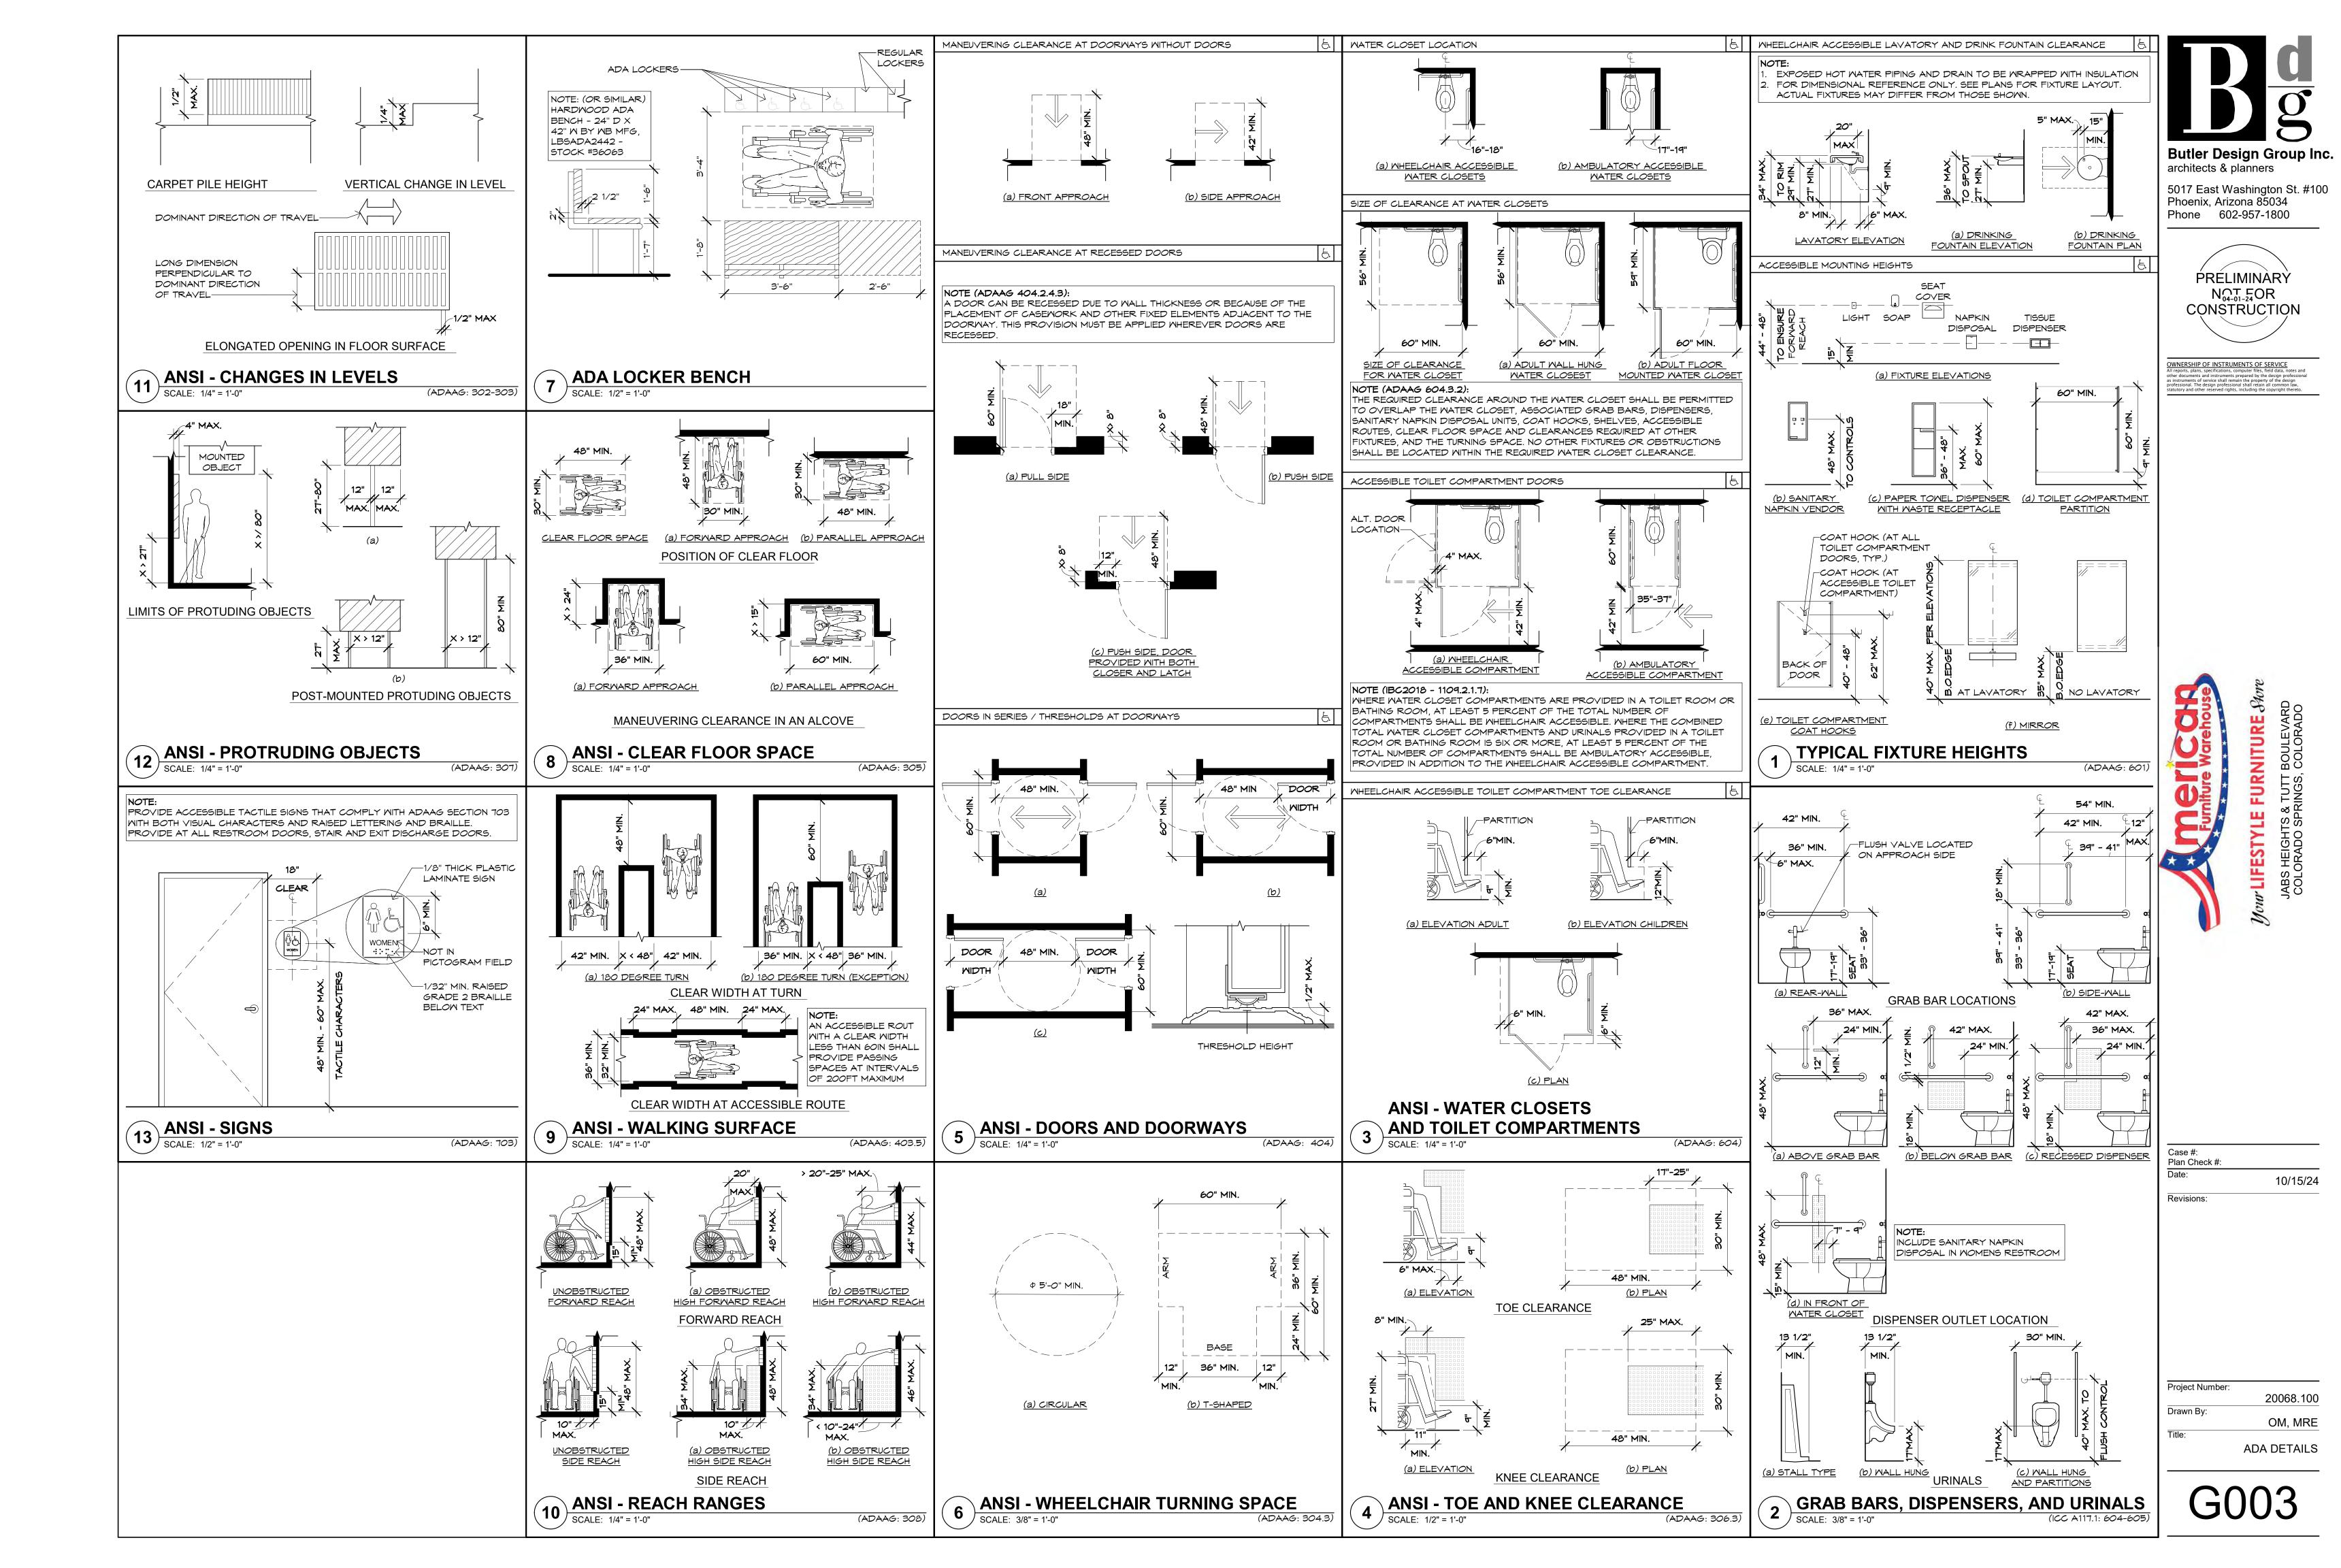

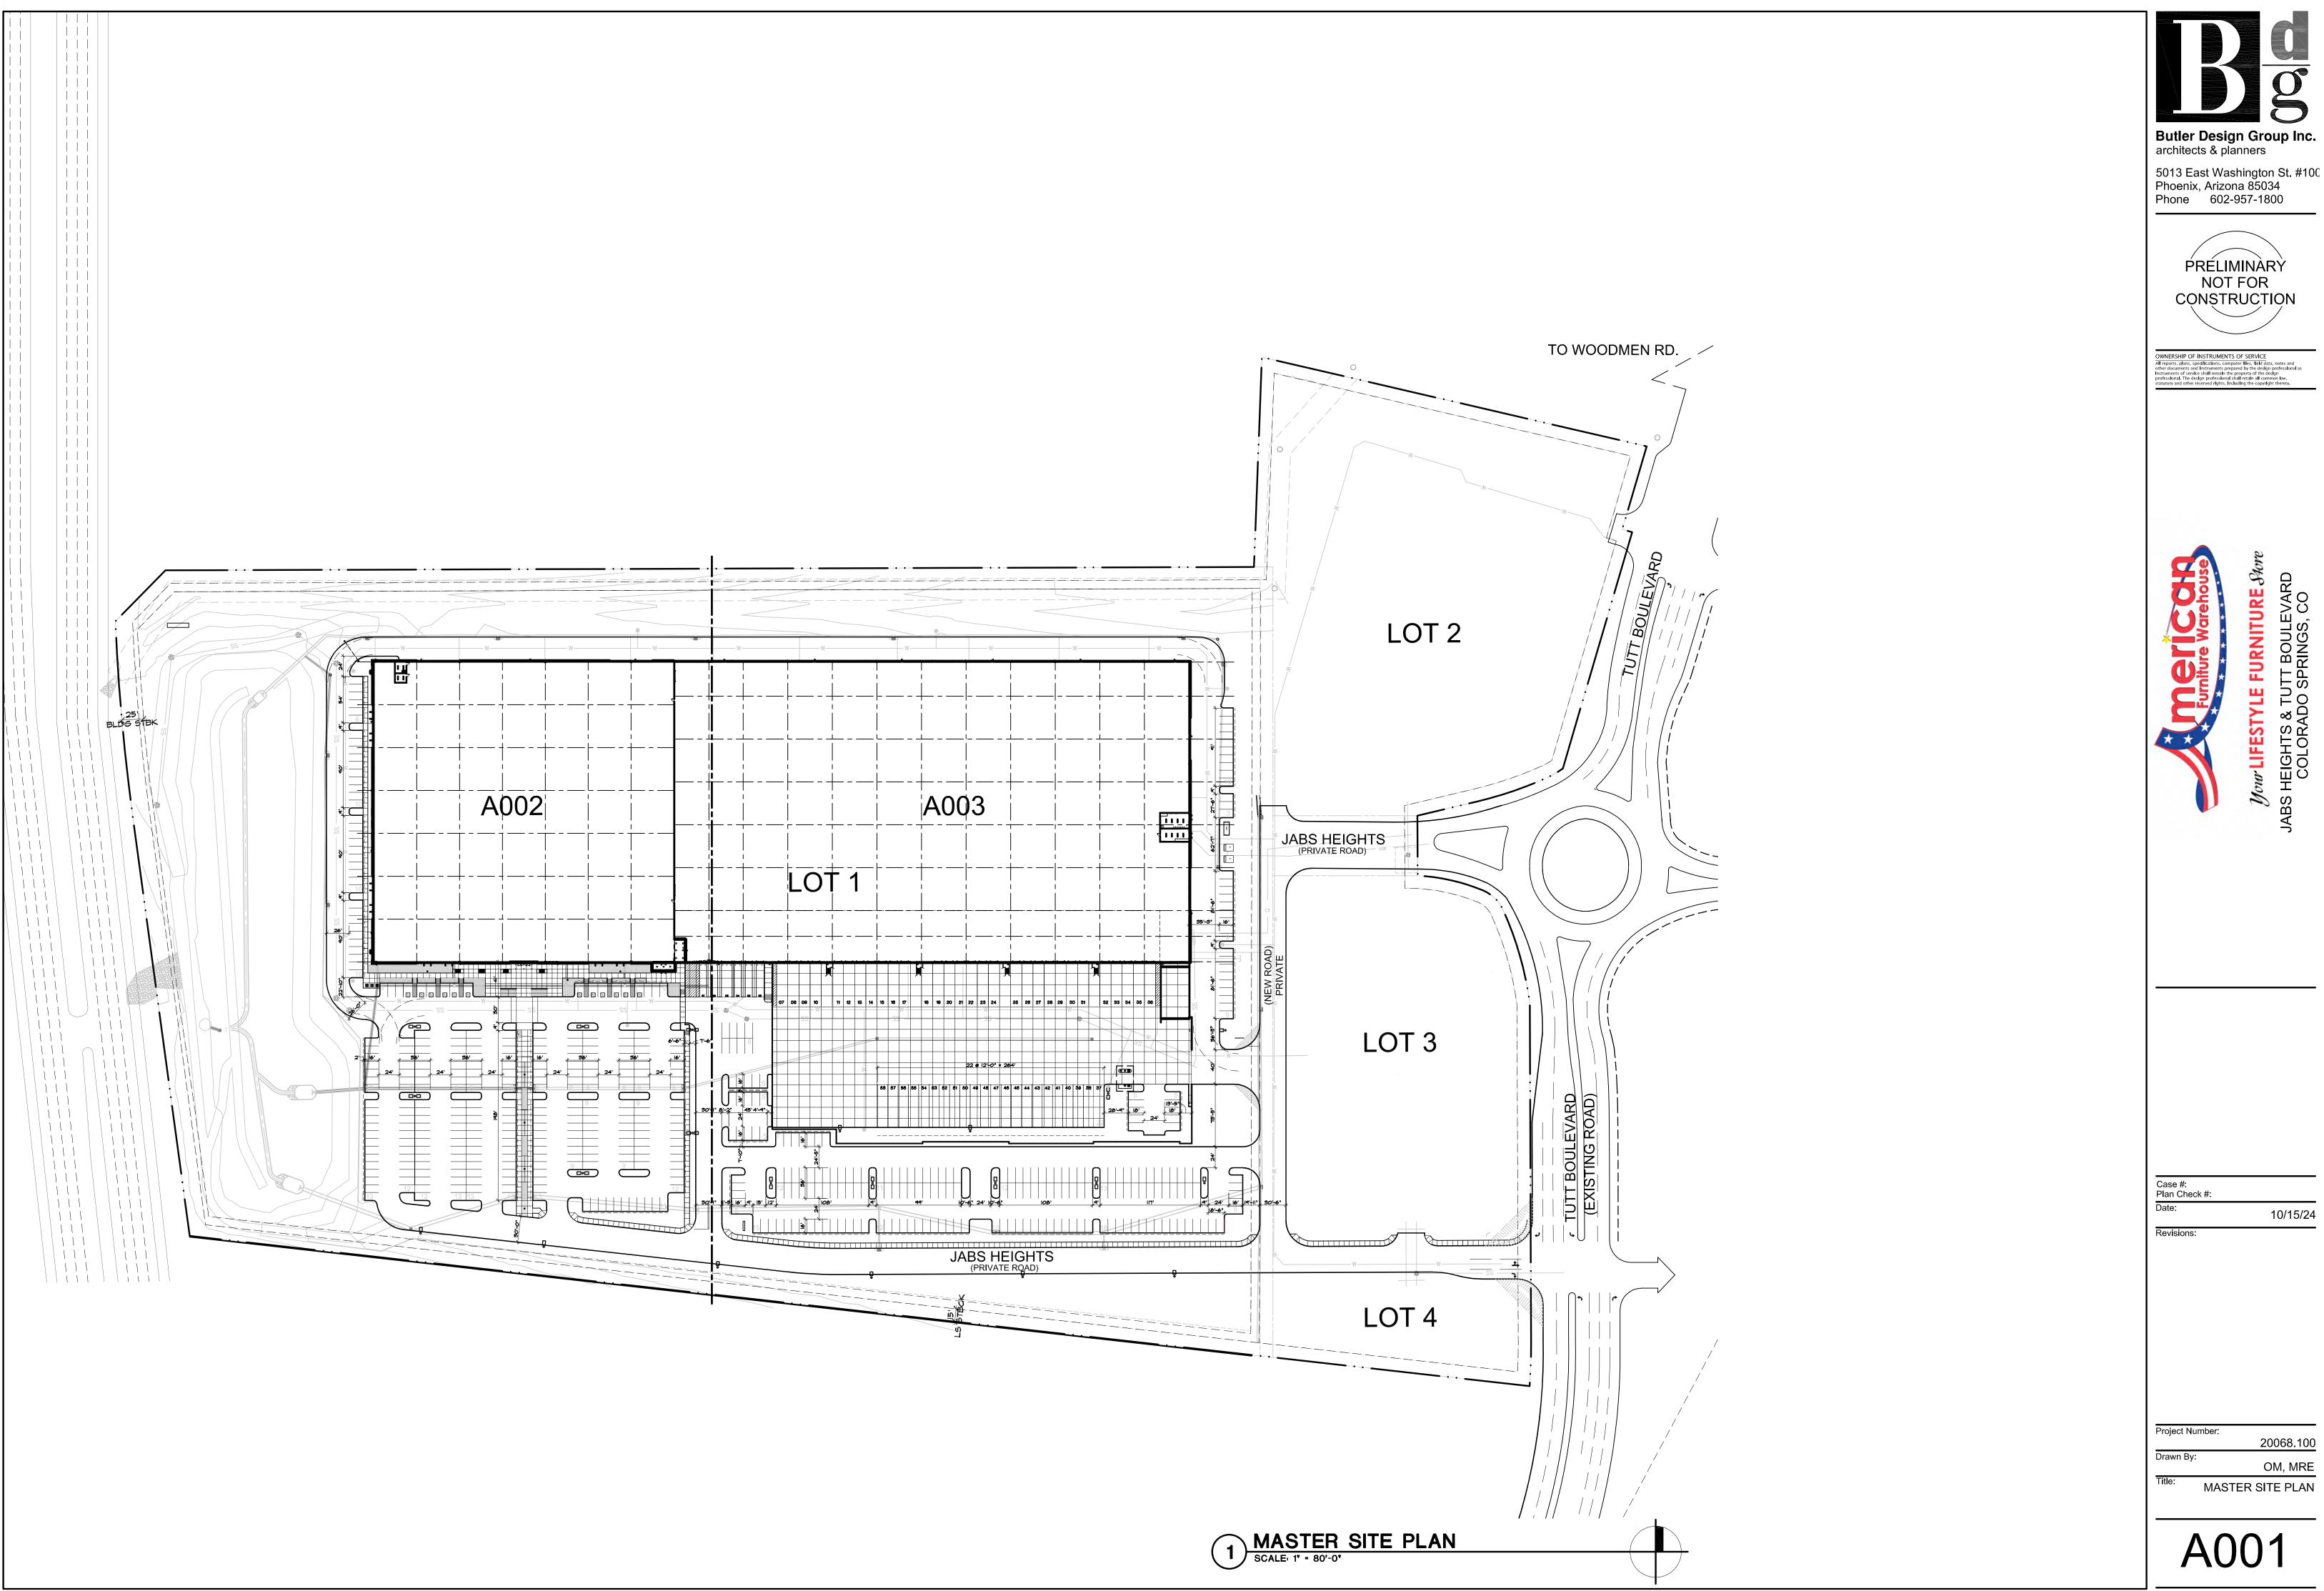


20068.100 OM, MRE MASTER SITE PLAN

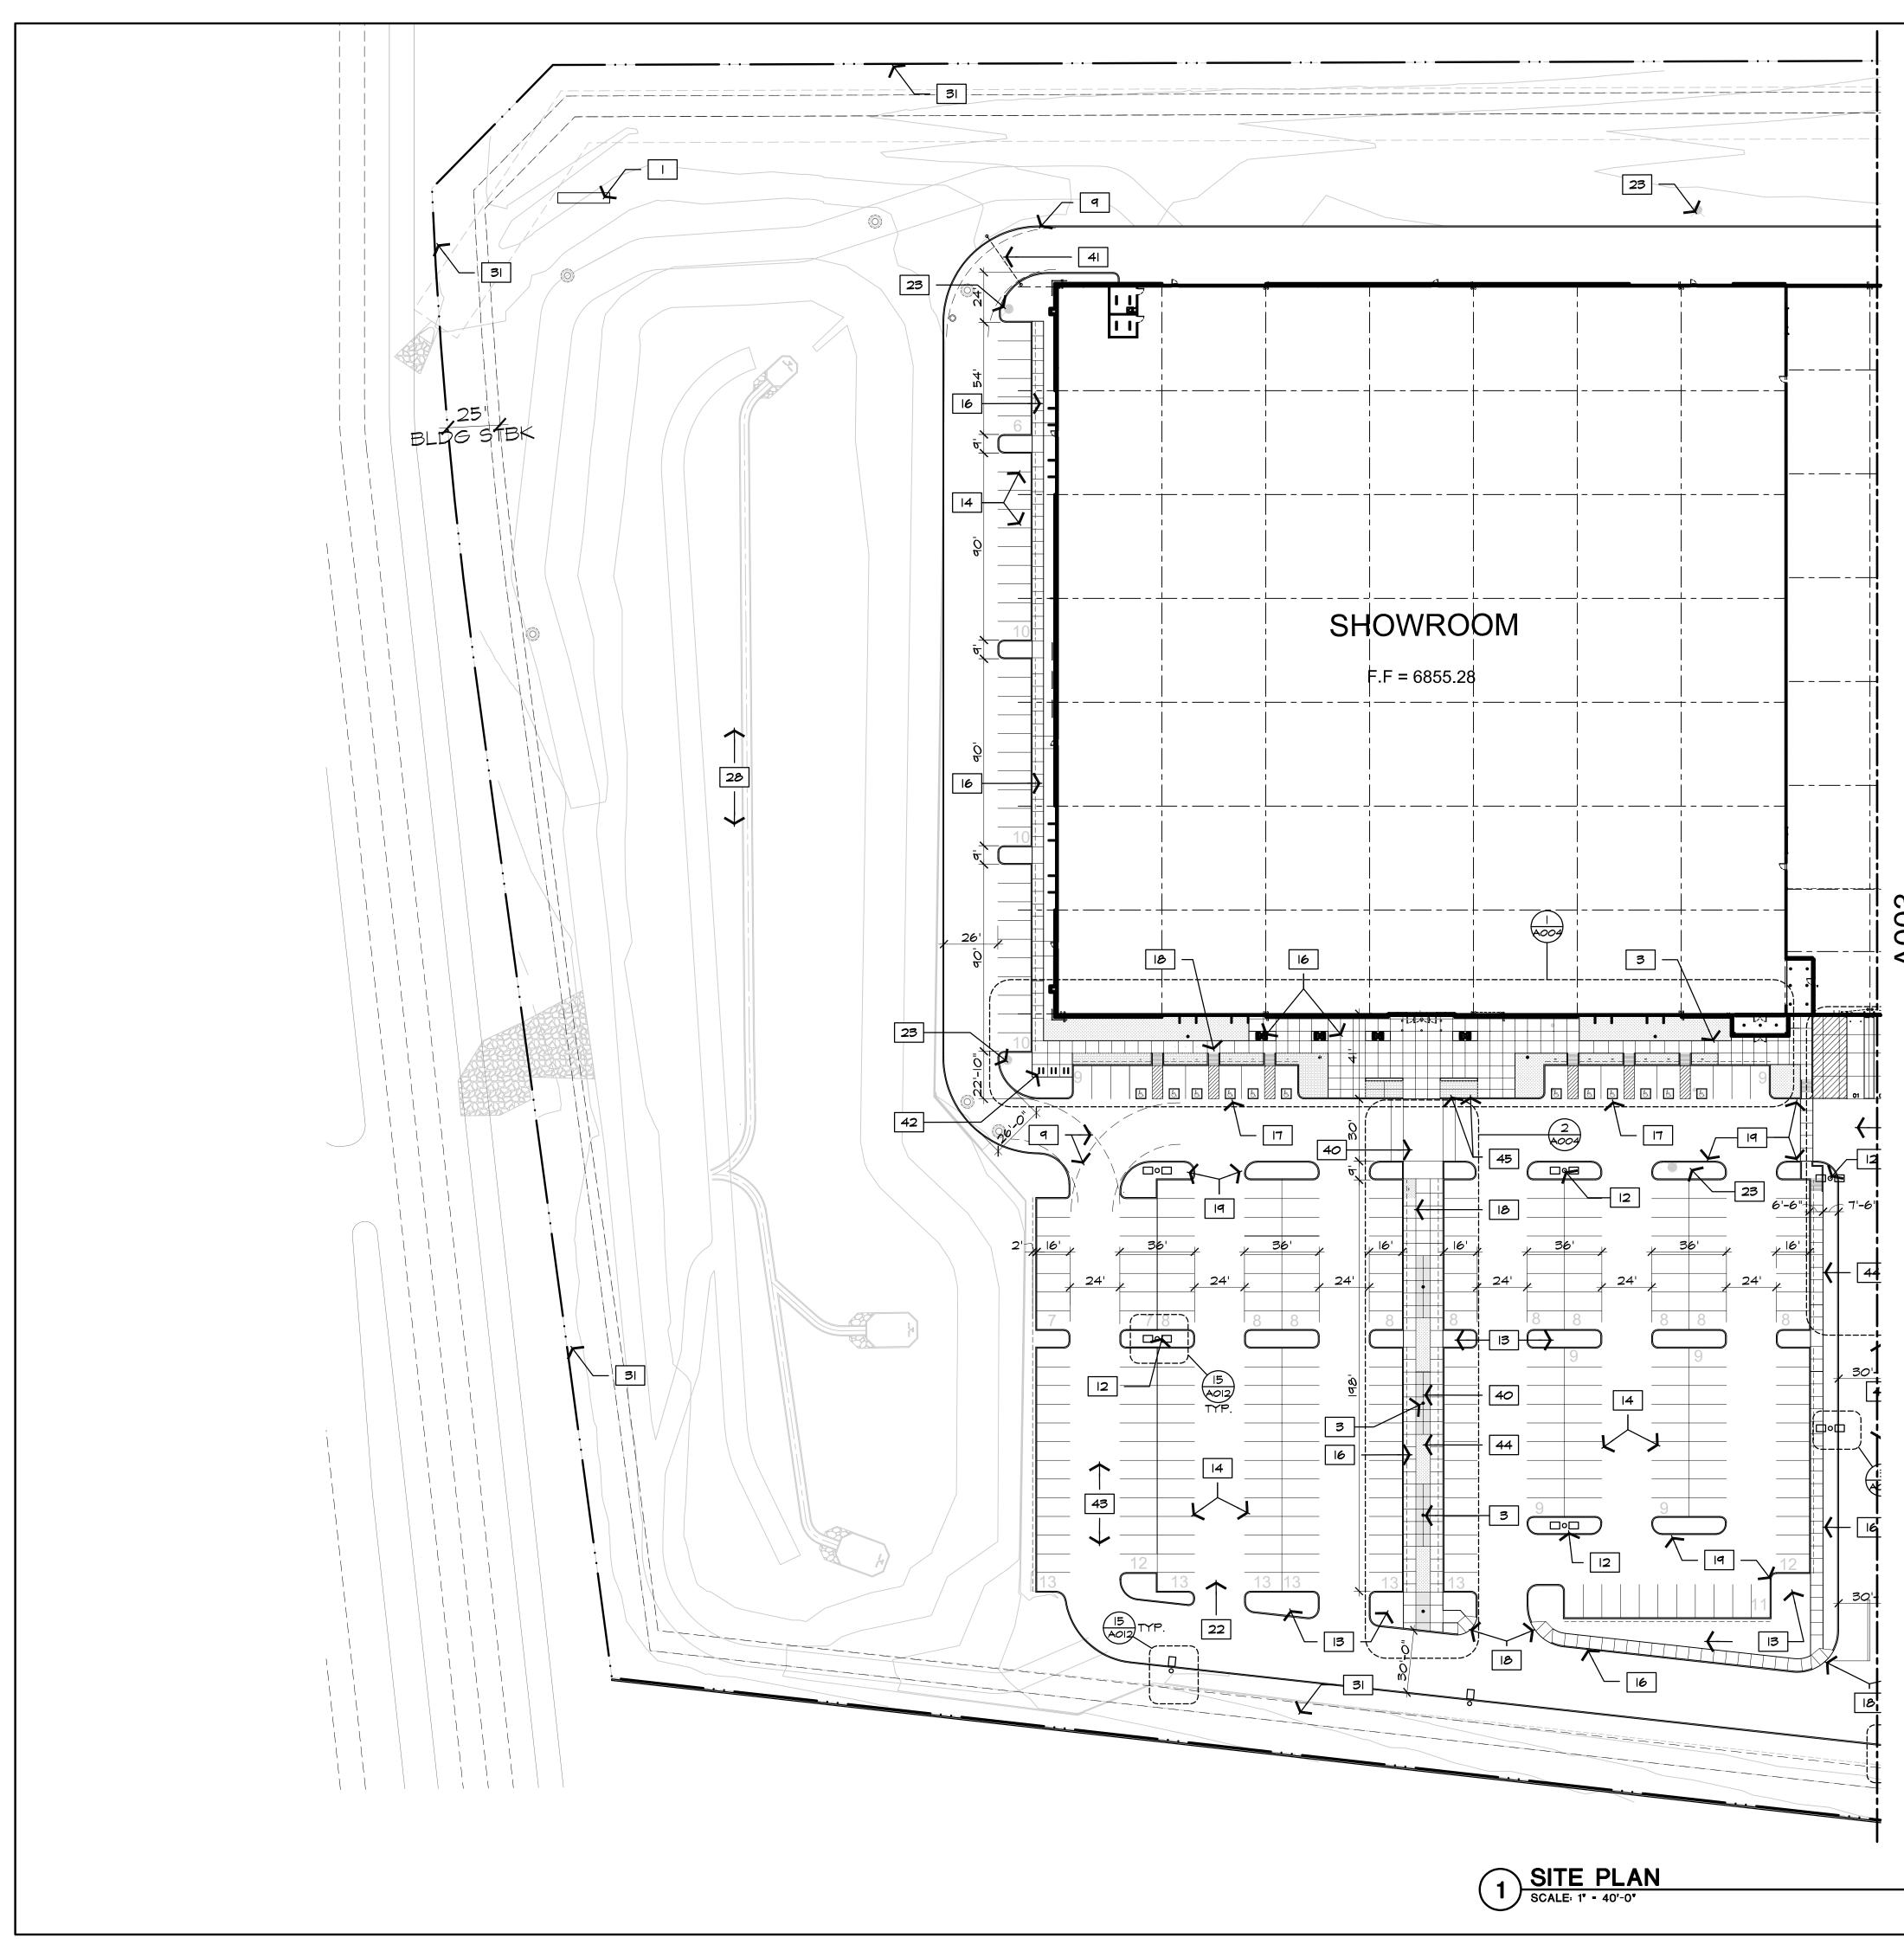



A003


<b>SITE PLAN KEYED NOTES</b>	
<ol> <li>60'-0" DIGITAL READER PYLON SIGN</li> <li>PAD MOUNTED ELECTRICAL TRANSFORMERS - SEE ELECTRICAL</li> </ol>	
3. PEDESTRIAN LIGHTING- SEE ELECTRICAL	
4. FIRE RISER / PUMP ROOM	
<ol> <li>MROUGHT IRON SECURITY FENCE</li> <li>MANUAL SLIDING GATE WITH KNOX PADLOCK</li> </ol>	Butler Design Group Inc.
1. 1'-O" X 1'-6" CURB RECESS TO ALLOW FOR GATE WHEELS, TYP.	Butler Design Group Inc. architects & planners
8. DOCK HIGH LOADING	5013 East Washington St. #100
9. FIRE TRUCK TURN RADIUS/ MANEUVERING AREA	Phoenix, Arizona 85034 Phone 602-957-1800
10. TRAILER STORAGE 11. DASHED LINE INDICATES 10' SEMI OVERHANG	
12. SITE LIGHTING - SEE ELECTRICAL-LETTER INDICATES BASE TYPE	
13. LANDSCAPE AREA - SEE LANDSCAPE	PRÉLIMINÀRY
14. 4" WIDE WHITE PAINTED STRIPES, TYPICAL	NOT FOR CONSTRUCTION
15. 4" WIDE WHITE PAINTED STRIPE OVER 6" BLACK STRIPE, TYPICAL 16. CONCRETE SIDEWALK - SEE CIVIL	
17. ACCESSIBLE PARKING	
18. ACCESSIBLE RAMP - SEE CIVIL	OWNERSHIP OF INSTRUMENTS OF SERVICE All reports, plans, specifications, computer files, field data, notes and other documents and instruments prepared by the design professional as instruments of service shall remain the property of the design professional. The design professional shall retain all common law.
19. CONCRETE CURB - SEE CIVIL 20. 12" HIGH CURB AT TRAILER PARKING	professional. The design professional shall retain all common law, statutory and other reserved rights, including the copyright thereto.
21. CONCRETE PAVEMENT OVER BASE COURSE PER SOILS REPORT RECOMMENDATIONS - SEE CIVIL	
22. NEW ACCESS DRIVE - SEE CIVIL	
23. FIRE HYDRANT - SEE CIVIL	
24. MONUMENT SIGN LOCATION, SIGNAGE UNDER SEPARATE PERMIT. SIGN TO BE INSTALLED PRIOR TO OCCUPANCY	
25. TRUCKS 'ENTRY ONLY' SIGN - UNDER SEPARATE PERMIT	
26. TRUCKS 'EXIT ONLY' SIGN - UNDER SEPARATE PERMIT	
27. 8" DIA. X 6'-0" H. PIPE BOLLARDS 28. RETENTION BASIN PER CIVIL	<b>2</b>
29. ACID WASH CONCRETE	
30. GAS EASEMENT	
31. PROPERTY LINE 32. EXISTING POWER POLE	
33. NEW POWER POLE	
34. FUEL PUMP	
35. INTERNAL REFUSE RECYCLE BAYS (2) 10'X14' DOORS 36. 26' FIRE TRUCK LANE PAINTED RED. ONLY IN TRUCK COURT AREA	
37. FIRE DEPARTMENT CONNECTION	
38. FDC/PIV/BFP CONCRETE VAULT- REFER TO CIVIL PLANS	
39. WATER METER CONCRETE VAULT- REFER TO CIVIL PLANS 40. COLORED CONCRETE 3/4" EXPOSED AGGREGATE	your LII
41. CHAIN BARRIER WITH SIGNAGE	BS I SB
42. BYCICLE RACK	JAI
43. ASPHALT PAVEMENT 44. ADA ROUTE	
45. FLAGPOLE	
<ul> <li>SITE PLAN GENERAL NOTES</li> <li>SEE CIVIL AND LANDSCAPE DOCUMENTS FOR ADDITIONAL ITEMS OF COORDINATION.</li> </ul>	
2. SEE ELECTRICAL DOCUMENTS FOR SITE LIGHTING AND REQUIRED SITE RELATED ITEMS WHICH REQUIRE SERVICE.	
3. SEE ENLARGED PLANS FOR ADDITIONAL INFORMATION IN RELATIONSHIP TO HARDSCAPE, DRIVES, PARKING AREAS AND MISCELLANEOUS ITEMS.	
<ol> <li>SEE SOILS REPORT FOR GUIDELINES FOR SITE PREPARATION, FOOTING SOIL PREPARATION AND ADDITIONAL REQUIREMENTS FOR SLOPES AT BUILDING PERIMETERS.</li> </ol>	
<ul> <li>SEE SOILS REPORT AND CIVIL DOCUMENTS FOR PAVING SECTIONS AND LOCATIONS.</li> <li>THE GENERAL CONTRACTOR IS TO VISIT THE SITE FOR OBSERVATION OF ANY</li> </ul>	
EXISTING CONDITIONS SHALL REPORT ANY AND ALL CONFLICTS BETWEEN THE DOCUMENTS AND THE FIELD CONDITIONS.	
I. ALL EXISTING SITE EQUIPMENT AND FEATURES I. E. LANDSCAPING, PERIMETER LIGHTING, SIDEWALKS, TRANSFORMERS, TEL. CO. BOXES, WATER METERS ETC. SHALL BE PROTECTED FROM DAMAGE UNLESS OTHER WISE NOTED TO REMOVED OR RELOCATED.	
<ol> <li>ALL AREAS OF PEDESTRIAN ACCESS SHALL COMPLY WITH THE AMERICANS WITH DISABILITY ACT AND LOCAL ENFORCED CODES, THERE WILL BE NO EXCEPTIONS.</li> </ol>	Case #: Plan Check #: Date: 10/15/24
9. TRANSITION AT SIDEWALKS SHALL NOT EXCEED 1/2 INCH UNLESS APPROVED RAMP HAS BEEN INSTALLED.	Revisions:
<ul> <li>10. ALL NEW AND EXISTING UTILITIES WITHIN OR CONTIGUOUS TO THIS SITE SHALL BE PLACED UNDERGROUND.</li> <li>11. ALL SITE FOURMENT SHALL BE PAINTED TO MATCH AD IACENT BUILDING. SITE</li> </ul>	
<ol> <li>ALL SITE EQUIPMENT SHALL BE PAINTED TO MATCH ADJACENT BUILDING, SITE WALL, OR LANDSCAPE AS APPLIES.</li> <li>SEE SPECIFICATIONS FOR ADDITIONAL ITEMS OF COORDINATION AND</li> </ol>	
SPECIFIC REQUIREMENTS FOR PRODUCTS AND PROCEDURES. 13. FINAL COORDINATION OF OFFSITE LIGHTING SHALL BE REQUIRED AND	
COORDINATED WITH LOCAL UTILITY COMPANY. 14. 14. ALL SIGNAGE SHALL BE LOCATED PER THE APPROVED PAD - UNDER SEPARATE PERMIT.	
15. S.E.S. PANELS AND ANY OTHER ABOVE GROUND ULTILITY CABINET SHALL BE FULY SCREENED FROM VIEW FROM STREETS OR FROM AREAS ACCESSIBLE TO CUSTOMERS AND THE GENERAL PUBLIC, SCREENING MAY BE ACCOMPLISHED BY ANY ONE OF THE FOLLOWING METHODS.	Project Number: 20068.100 Drawn By:
A. FULLY RECESSING THE CABINET INTO THE BUILDING AND ENCLOSING IT BY A SOLID DOOR OR DOORS SEPARATE FROM THE CABINET;	Title: SITE PLAN
B. SCREENING WITH A DECORATIVE MASONRY WALL OF THE SAME HEIGHT AS THE PANEL. THE SCREEN WALL MAY BE L-SHAPED, U-SHAPED OR A STRAIGHT WALL PARALLEL TO THE CABINET, DEPENDING ON THE LOCATION OF THE CABINET.	A002
C. AN ALTERNATIVE SCREENING METHOD APPROVED BY THE PLANNING DEPARTMENT PRIOR TO ISSUANCE OF THE CABINET.	

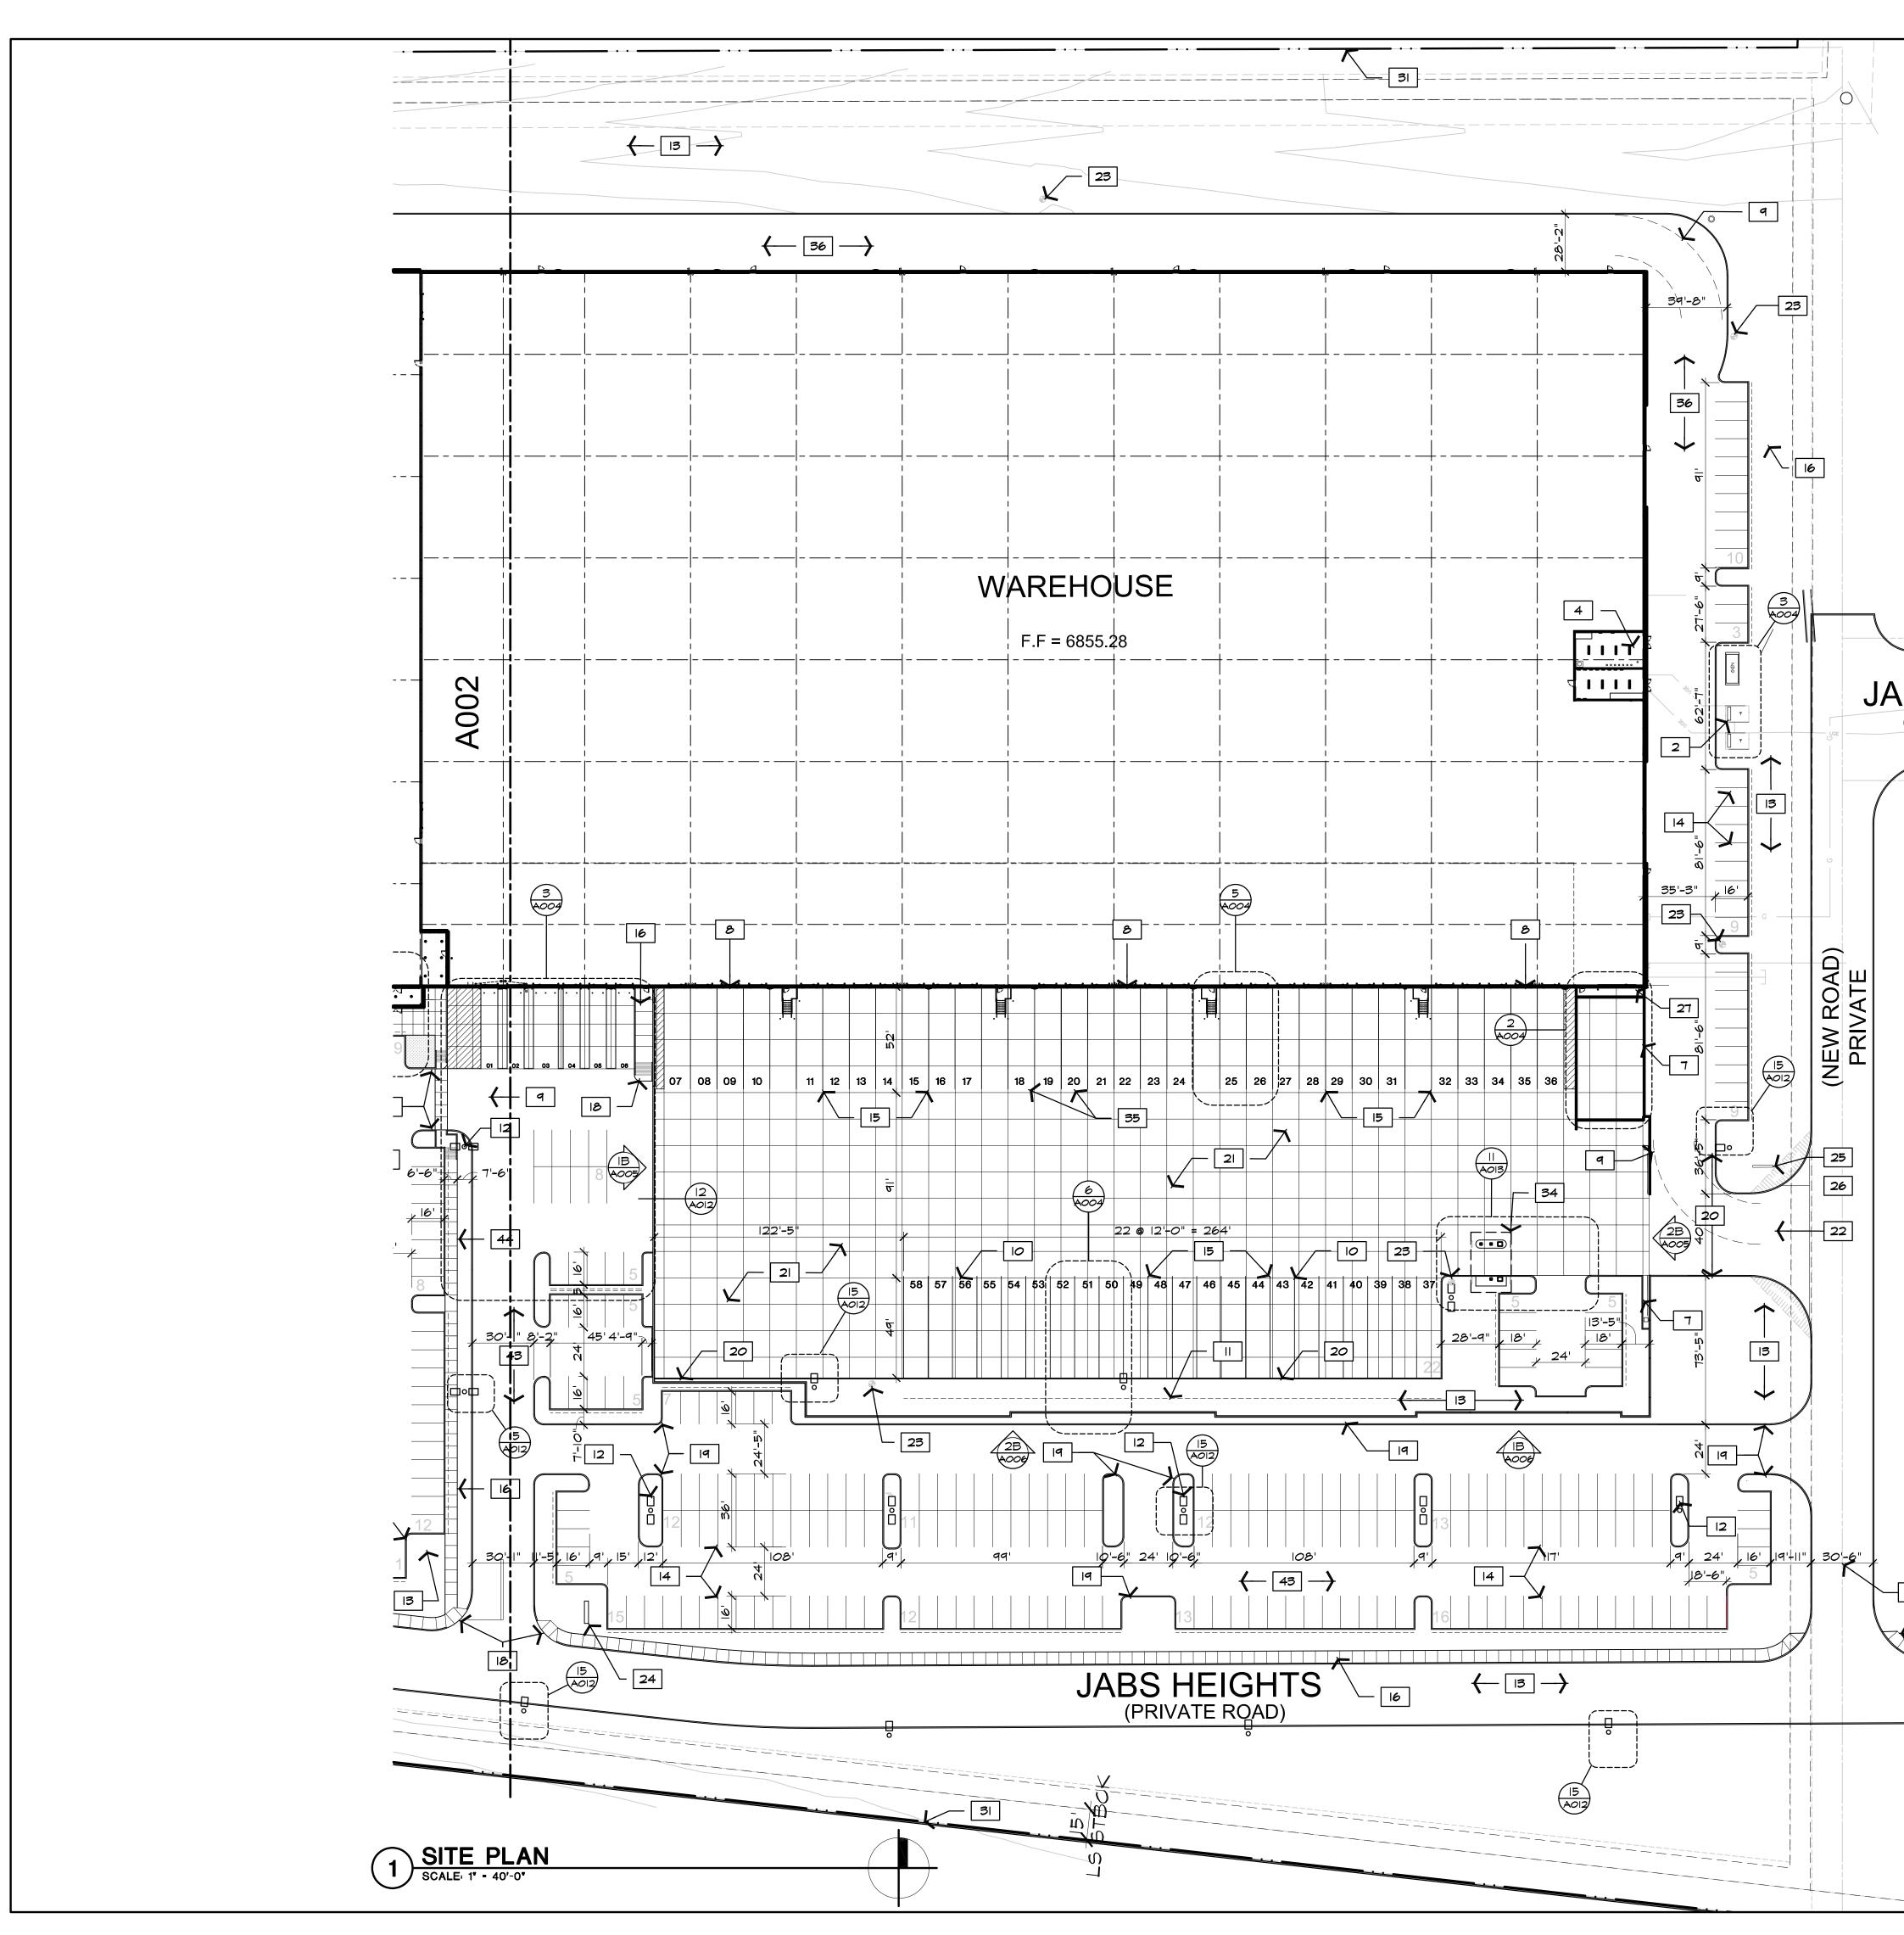

	<b>SITE PLAN KEYED NOTES</b>	
	<ol> <li>60'-0" DIGITAL READER PYLON SIGN</li> <li>PAD MOUNTED ELECTRICAL TRANSFORMERS - SEE ELECTRICAL</li> </ol>	
	<ol> <li>PEDESTRIAN LIGHTING- SEE ELECTRICAL</li> <li>FIRE RISER / PUMP ROOM</li> </ol>	$\mathbf{P}$
	5. WROUGHT IRON SECURITY FENCE	
	<ol> <li>MANUAL SLIDING GATE WITH KNOX PADLOCK</li> <li>1'-0" X 1'-6" CURB RECESS TO ALLOW FOR GATE WHEELS, TYP.</li> </ol>	Butler Design Group Inc. architects & planners
	8. DOCK HIGH LOADING	5013 East Washington St. #100
	9. FIRE TRUCK TURN RADIUS/ MANEUVERING AREA	Phoenix, Arizona 85034 Phone 602-957-1800
	10. TRAILER STORAGE 11. DASHED LINE INDICATES 10' SEMI OVERHANG	
	12. SITE LIGHTING - SEE ELECTRICAL-LETTER INDICATES BASE TYPE	
	13. LANDSCAPE AREA - SEE LANDSCAPE 14. 4" WIDE WHITE PAINTED STRIPES, TYPICAL	PRELIMINARY
	15. 4" WIDE WHITE PAINTED STRIPE OVER 6" BLACK STRIPE, TYPICAL	CONSTRUCTION
	16. CONCRETE SIDEWALK - SEE CIVIL	
	17. ACCESSIBLE PARKING 18. ACCESSIBLE RAMP - SEE CIVIL	OWNERSHIP OF INSTRUMENTS OF SERVICE All reports, plans, specifications, computer files, field data, notes and
	19. CONCRETE CURB - SEE CIVIL	other documents and Instruments prepared by the design professional as Instruments of service shall remain the property of the design professional. The design professional shall retain all common law, statutory and other reserved rights, including the copyright thereto.
	20. 12" HIGH CURB AT TRAILER PARKING 21. CONCRETE PAVEMENT OVER BASE COURSE PER SOILS REPORT RECOMMENDATIONS - SEE CIVIL	
	22. NEW ACCESS DRIVE - SEE CIVIL	
	23. FIRE HYDRANT - SEE CIVIL 24. MONUMENT SIGN LOCATION, SIGNAGE UNDER SEPARATE PERMIT. SIGN TO BE INSTALLED PRIOR TO OCCUPANCY	
	25. TRUCKS 'ENTRY ONLY' SIGN - UNDER SEPARATE PERMIT	
	26. TRUCKS 'EXIT ONLY' SIGN - UNDER SEPARATE PERMIT	
BS HE	27. 8" DIA. X 6'-0" H. PIPE BOLLARDS 28. RETENTION BASIN PER CIVIL	Store Store
(PRIVATE F	29. ACID WASH CONCRETE	
	30. GAS EASEMENT 31. PROPERTY LINE	, CO F
	32. EXISTING POWER POLE	
	33. NEW POWER POLE	
	34. FUEL PUMP 35. INTERNAL REFUSE RECYCLE BAYS (2) 10'X14' DOORS	
	36. 26' FIRE TRUCK LANE PAINTED RED. ONLY IN TRUCK COURT AREA	
	37. FIRE DEPARTMENT CONNECTION 38. FDC/PIV/BFP CONCRETE VAULT- REFER TO CIVIL PLANS	LOR SUR
	39. WATER METER CONCRETE VAULT- REFER TO CIVIL PLANS	
	40. COLORED CONCRETE 3/4" EXPOSED AGGREGATE	S HEIG
	41. CHAIN BARRIER WITH SIGNAGE 42. BYCICLE RACK	IAB;
	43. ASPHALT PAVEMENT	
	44. ADA ROUTE 45. FLAGPOLE	
	SITE PLAN GENERAL NOTES	
	1. SEE CIVIL AND LANDSCAPE DOCUMENTS FOR ADDITIONAL ITEMS OF COORDINATION.	
	2. SEE ELECTRICAL DOCUMENTS FOR SITE LIGHTING AND REQUIRED SITE RELATED ITEMS WHICH REQUIRE SERVICE.	
	3. SEE ENLARGED PLANS FOR ADDITIONAL INFORMATION IN RELATIONSHIP TO HARDSCAPE, DRIVES, PARKING AREAS AND MISCELLANEOUS ITEMS.	
	<ol> <li>SEE SOILS REPORT FOR GUIDELINES FOR SITE PREPARATION, FOOTING SOIL PREPARATION AND ADDITIONAL REQUIREMENTS FOR SLOPES AT BUILDING PERIMETERS.</li> </ol>	
	5. SEE SOILS REPORT AND CIVIL DOCUMENTS FOR PAVING SECTIONS AND LOCATIONS.	
	6. THE GENERAL CONTRACTOR IS TO VISIT THE SITE FOR OBSERVATION OF ANY EXISTING CONDITIONS SHALL REPORT ANY AND ALL CONFLICTS BETWEEN THE DOCUMENTS AND THE FIELD CONDITIONS.	
	<ol> <li>ALL EXISTING SITE EQUIPMENT AND FEATURES I. E. LANDSCAPING, PERIMETER LIGHTING, SIDEWALKS, TRANSFORMERS, TEL. CO. BOXES, WATER METERS ETC. SHALL BE PROTECTED FROM DAMAGE UNLESS OTHER WISE NOTED TO REMOVED OR RELOCATED.</li> </ol>	
	<ol> <li>ALL AREAS OF PEDESTRIAN ACCESS SHALL COMPLY WITH THE AMERICANS WITH DISABILITY ACT AND LOCAL ENFORCED CODES, THERE WILL BE NO EXCEPTIONS.</li> </ol>	Case #: Plan Check #: Date: 10/15/24
	9. TRANSITION AT SIDEWALKS SHALL NOT EXCEED 1/2 INCH UNLESS APPROVED RAMP HAS BEEN INSTALLED.	Revisions:
	10. ALL NEW AND EXISTING UTILITIES WITHIN OR CONTIGUOUS TO THIS SITE SHALL BE PLACED UNDERGROUND.	
31	<ol> <li>ALL SITE EQUIPMENT SHALL BE PAINTED TO MATCH ADJACENT BUILDING, SITE WALL, OR LANDSCAPE AS APPLIES.</li> <li>ADDITIONAL ITEMS OF COORDINATION AND</li> </ol>	
18	<ol> <li>SEE SPECIFICATIONS FOR ADDITIONAL ITEMS OF COORDINATION AND SPECIFIC REQUIREMENTS FOR PRODUCTS AND PROCEDURES.</li> <li>FINAL COORDINATION OF OFFSITE LIGHTING SHALL BE REQUIRED AND</li> </ol>	
	<ul> <li>13. FINAL COORDINATION OF OFFSTTE LIGHTING SHALL BE REQUIRED AND</li> <li>COORDINATED WITH LOCAL UTILITY COMPANY.</li> <li>14.</li> <li>14. ALL SIGNAGE SHALL BE LOCATED PER THE APPROVED PAD - UNDER</li> </ul>	
	SEPARATE PERMIT.	
	15. S.E.S. PANELS AND ANY OTHER ABOVE GROUND ULTILITY CABINET SHALL BE FULY SCREENED FROM VIEW FROM STREETS OR FROM AREAS ACCESSIBLE TO CUSTOMERS AND THE GENERAL PUBLIC, SCREENING MAY BE ACCOMPLISHED BY ANY ONE OF THE FOLLOWING METHODS.	Project Number: 20068.100 Drawn By: MRE
	A. FULLY RECESSING THE CABINET INTO THE BUILDING AND ENCLOSING IT BY A SOLID DOOR OR DOORS SEPARATE FROM THE CABINET;	Title: SITE PLAN
	B. SCREENING WITH A DECORATIVE MASONRY WALL OF THE SAME HEIGHT AS THE PANEL. THE SCREEN WALL MAY BE L-SHAPED, U-SHAPED OR A STRAIGHT WALL PARALLEL TO THE CABINET, DEPENDING ON THE LOCATION OF THE CABINET.	A003
	C. AN ALTERNATIVE SCREENING METHOD APPROVED BY THE PLANNING DEPARTMENT PRIOR TO ISSUANCE OF THE CABINET.	

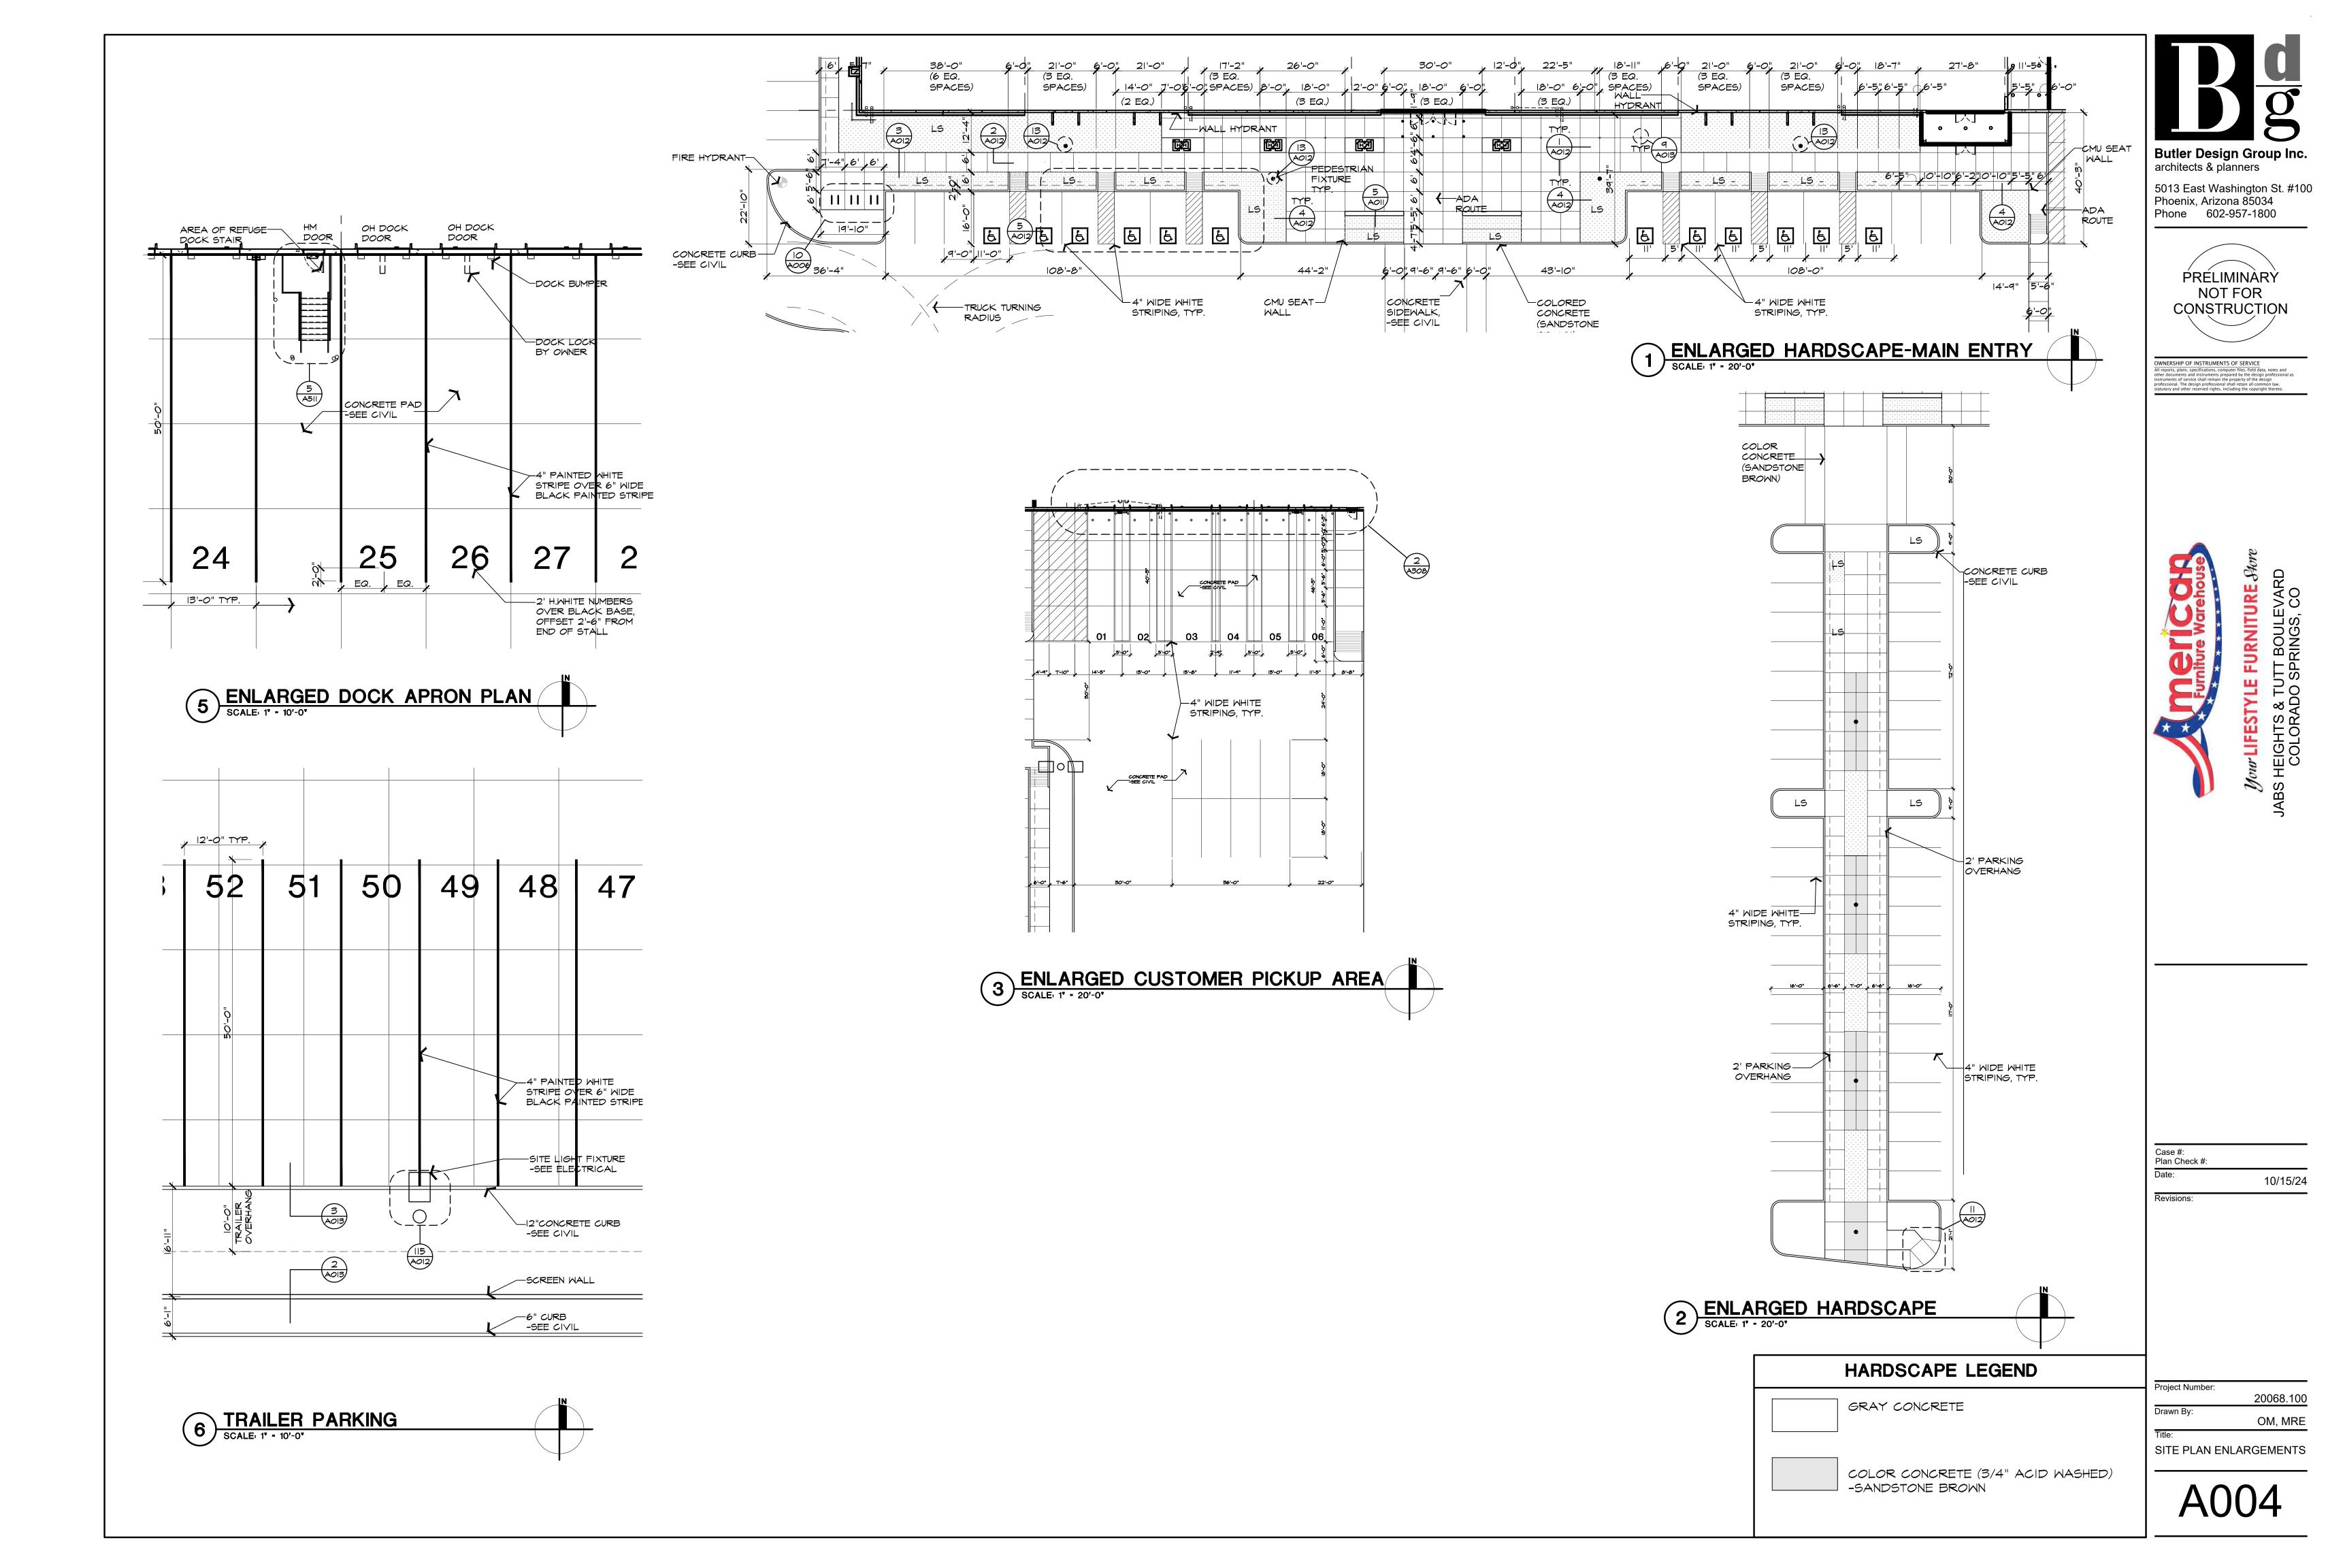

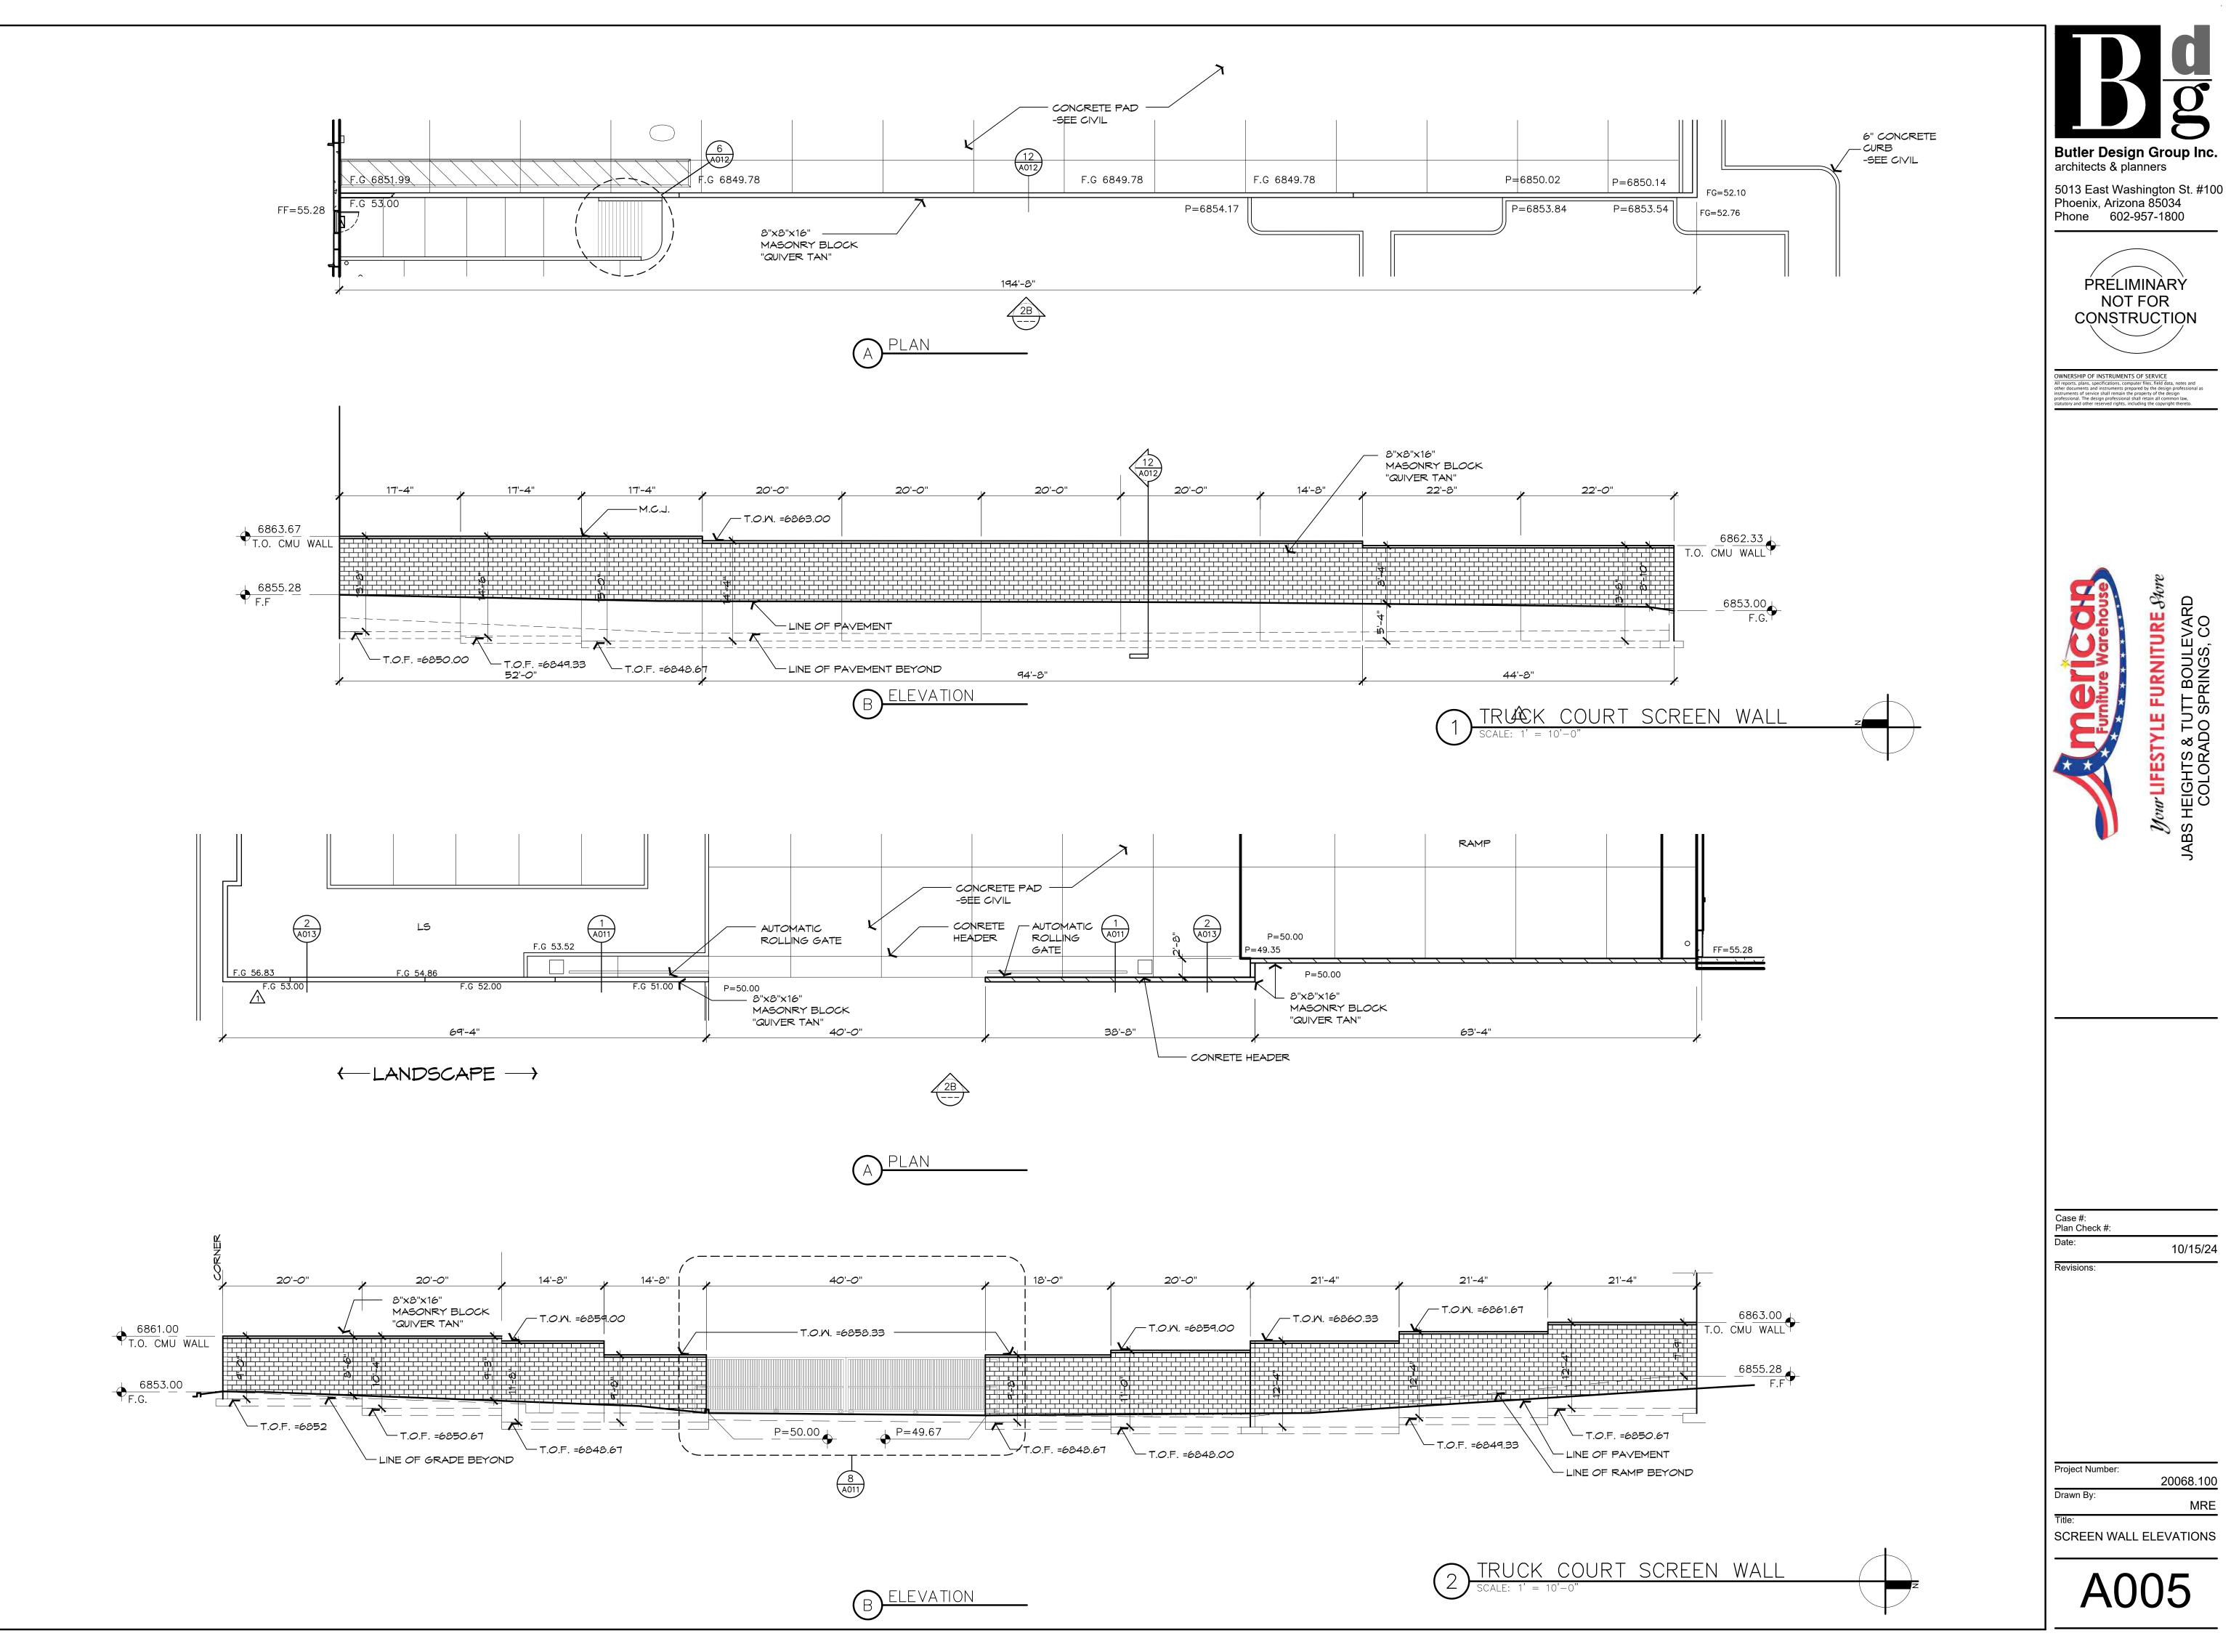

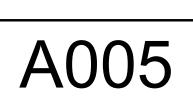

Project Number: 20068.100 Drawn By: MRE Title: SCREEN WALL ELEVATIONS

Case #: Plan Check #: Date: 10/15/24 Revisions:

**Merican** Furniture Warehouse


*Jour* LIFESTYLE FURNITURE *Su* ABS HEIGHTS & TUTT BOULEVARD COLORADO SPRINGS, CO


 $\Box$ 


**PRÉLIMINÀRÝ** 


NOT FOR


CONSTRUCTION

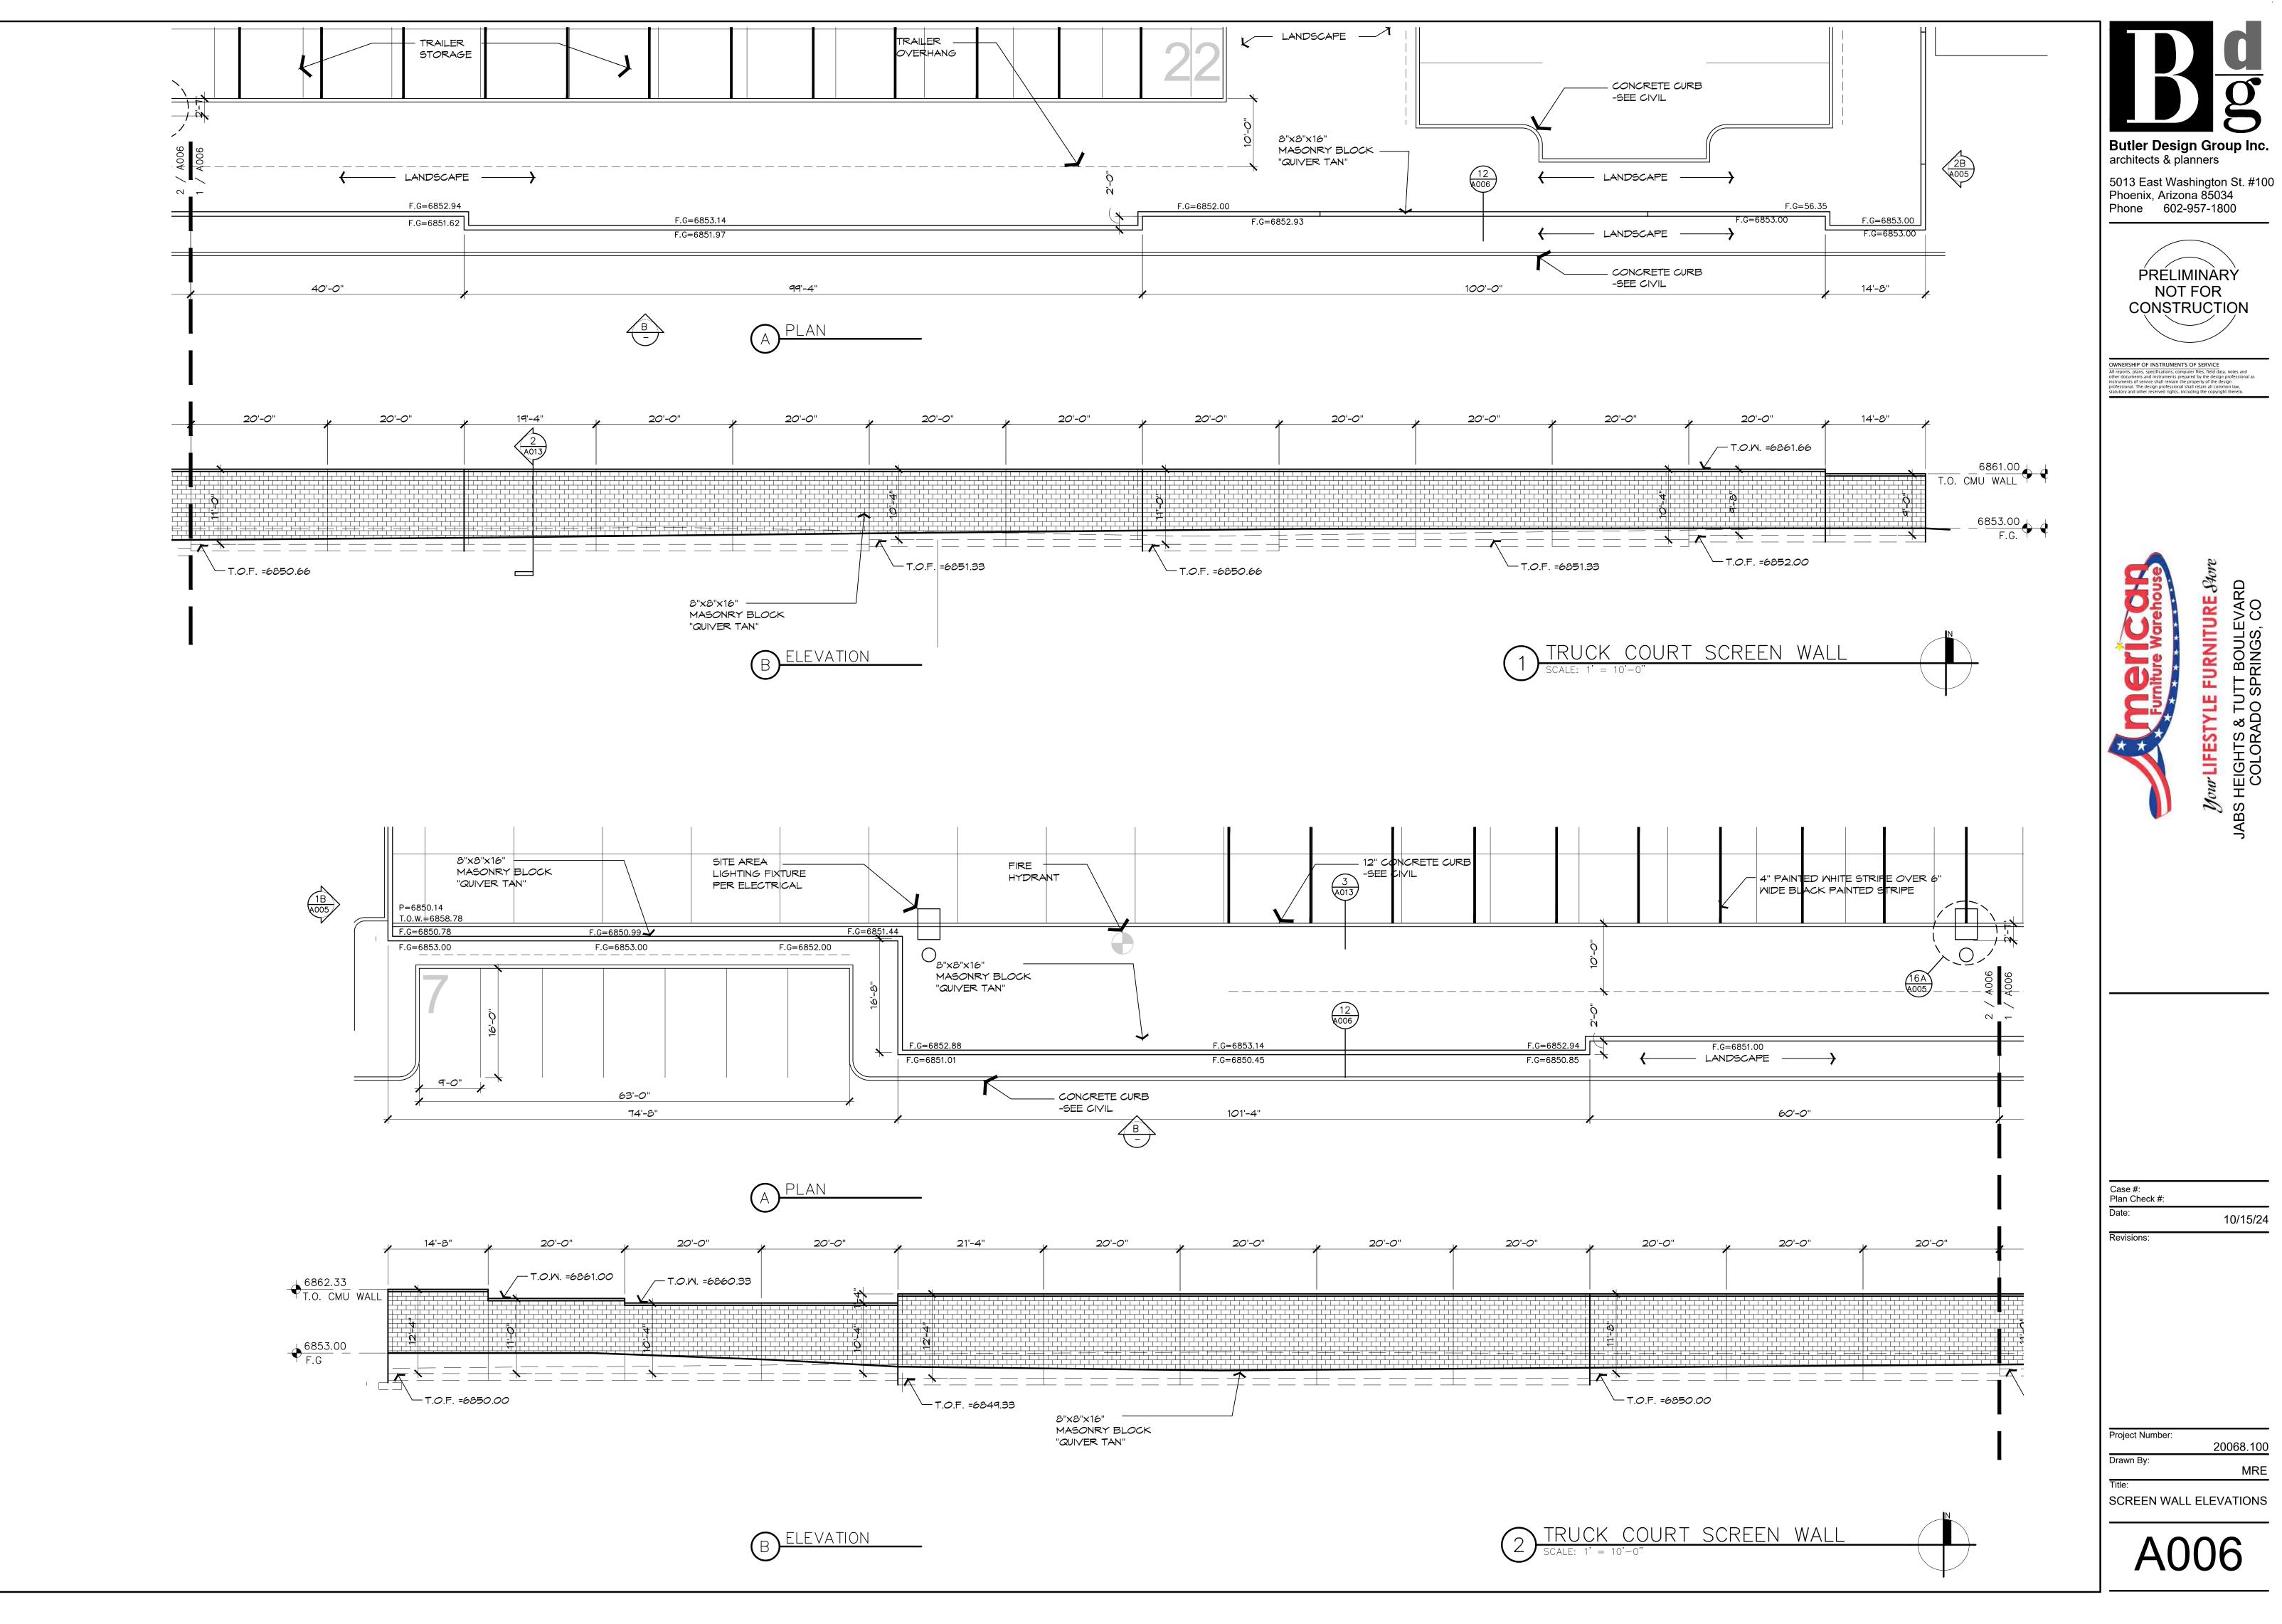


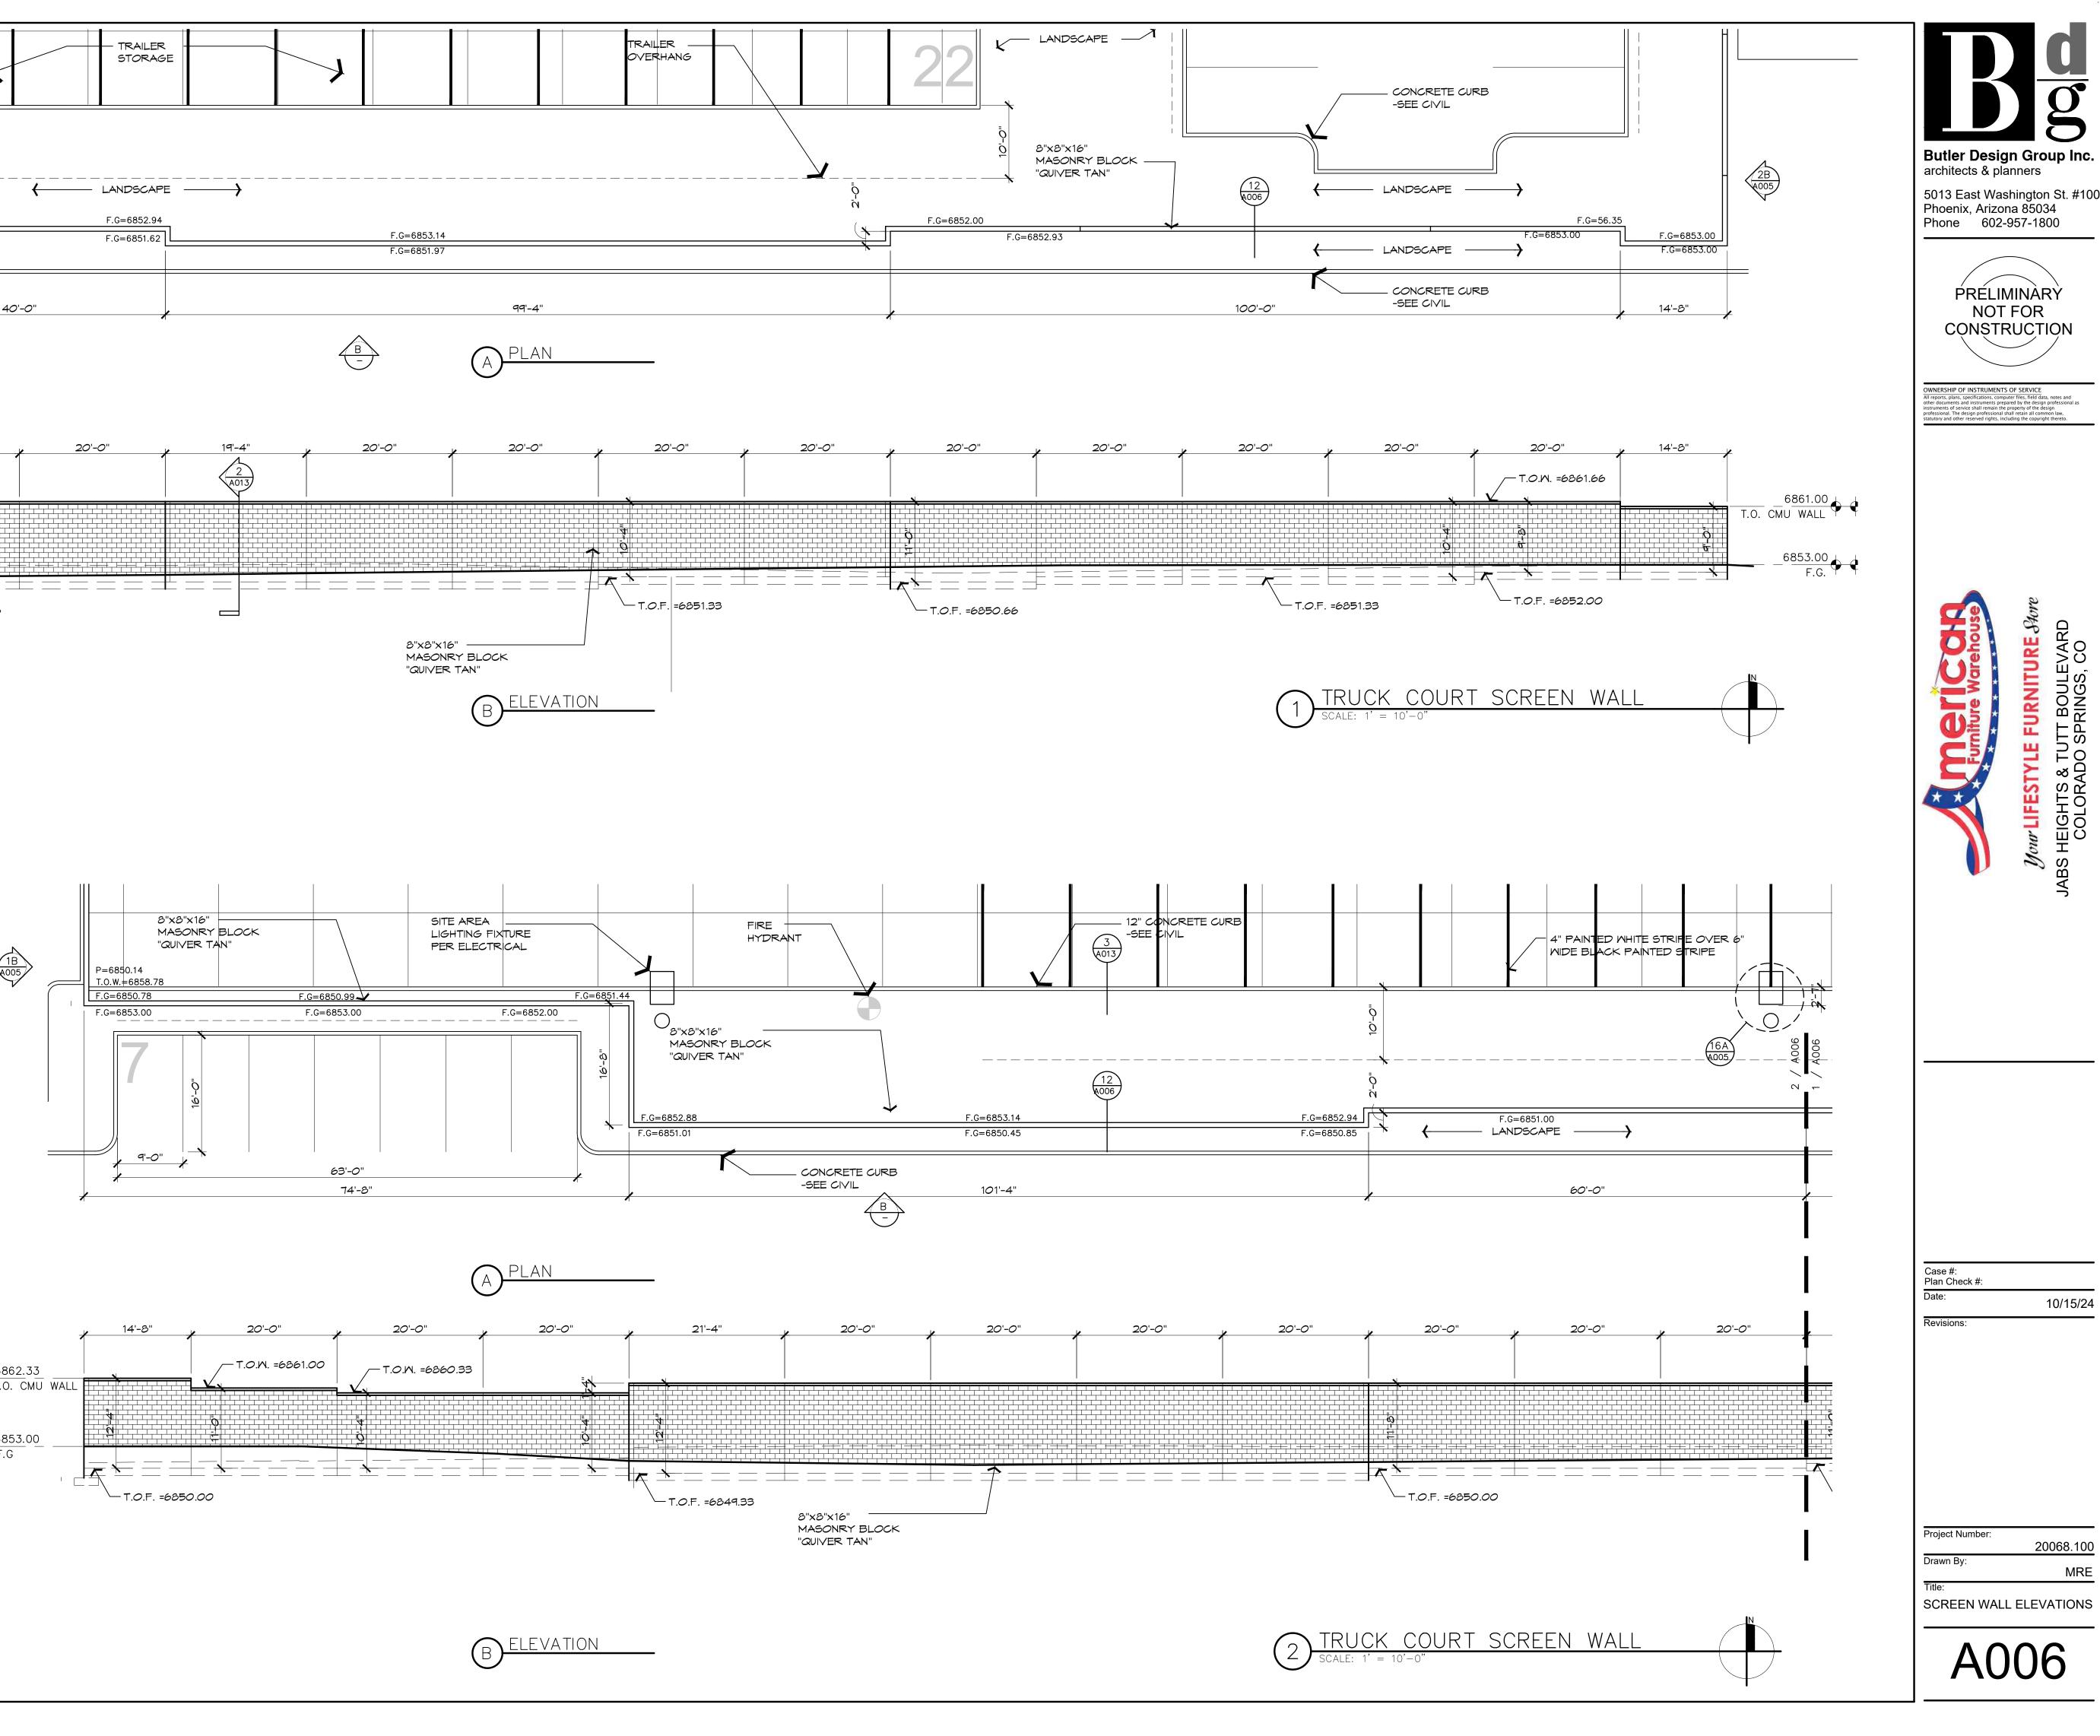


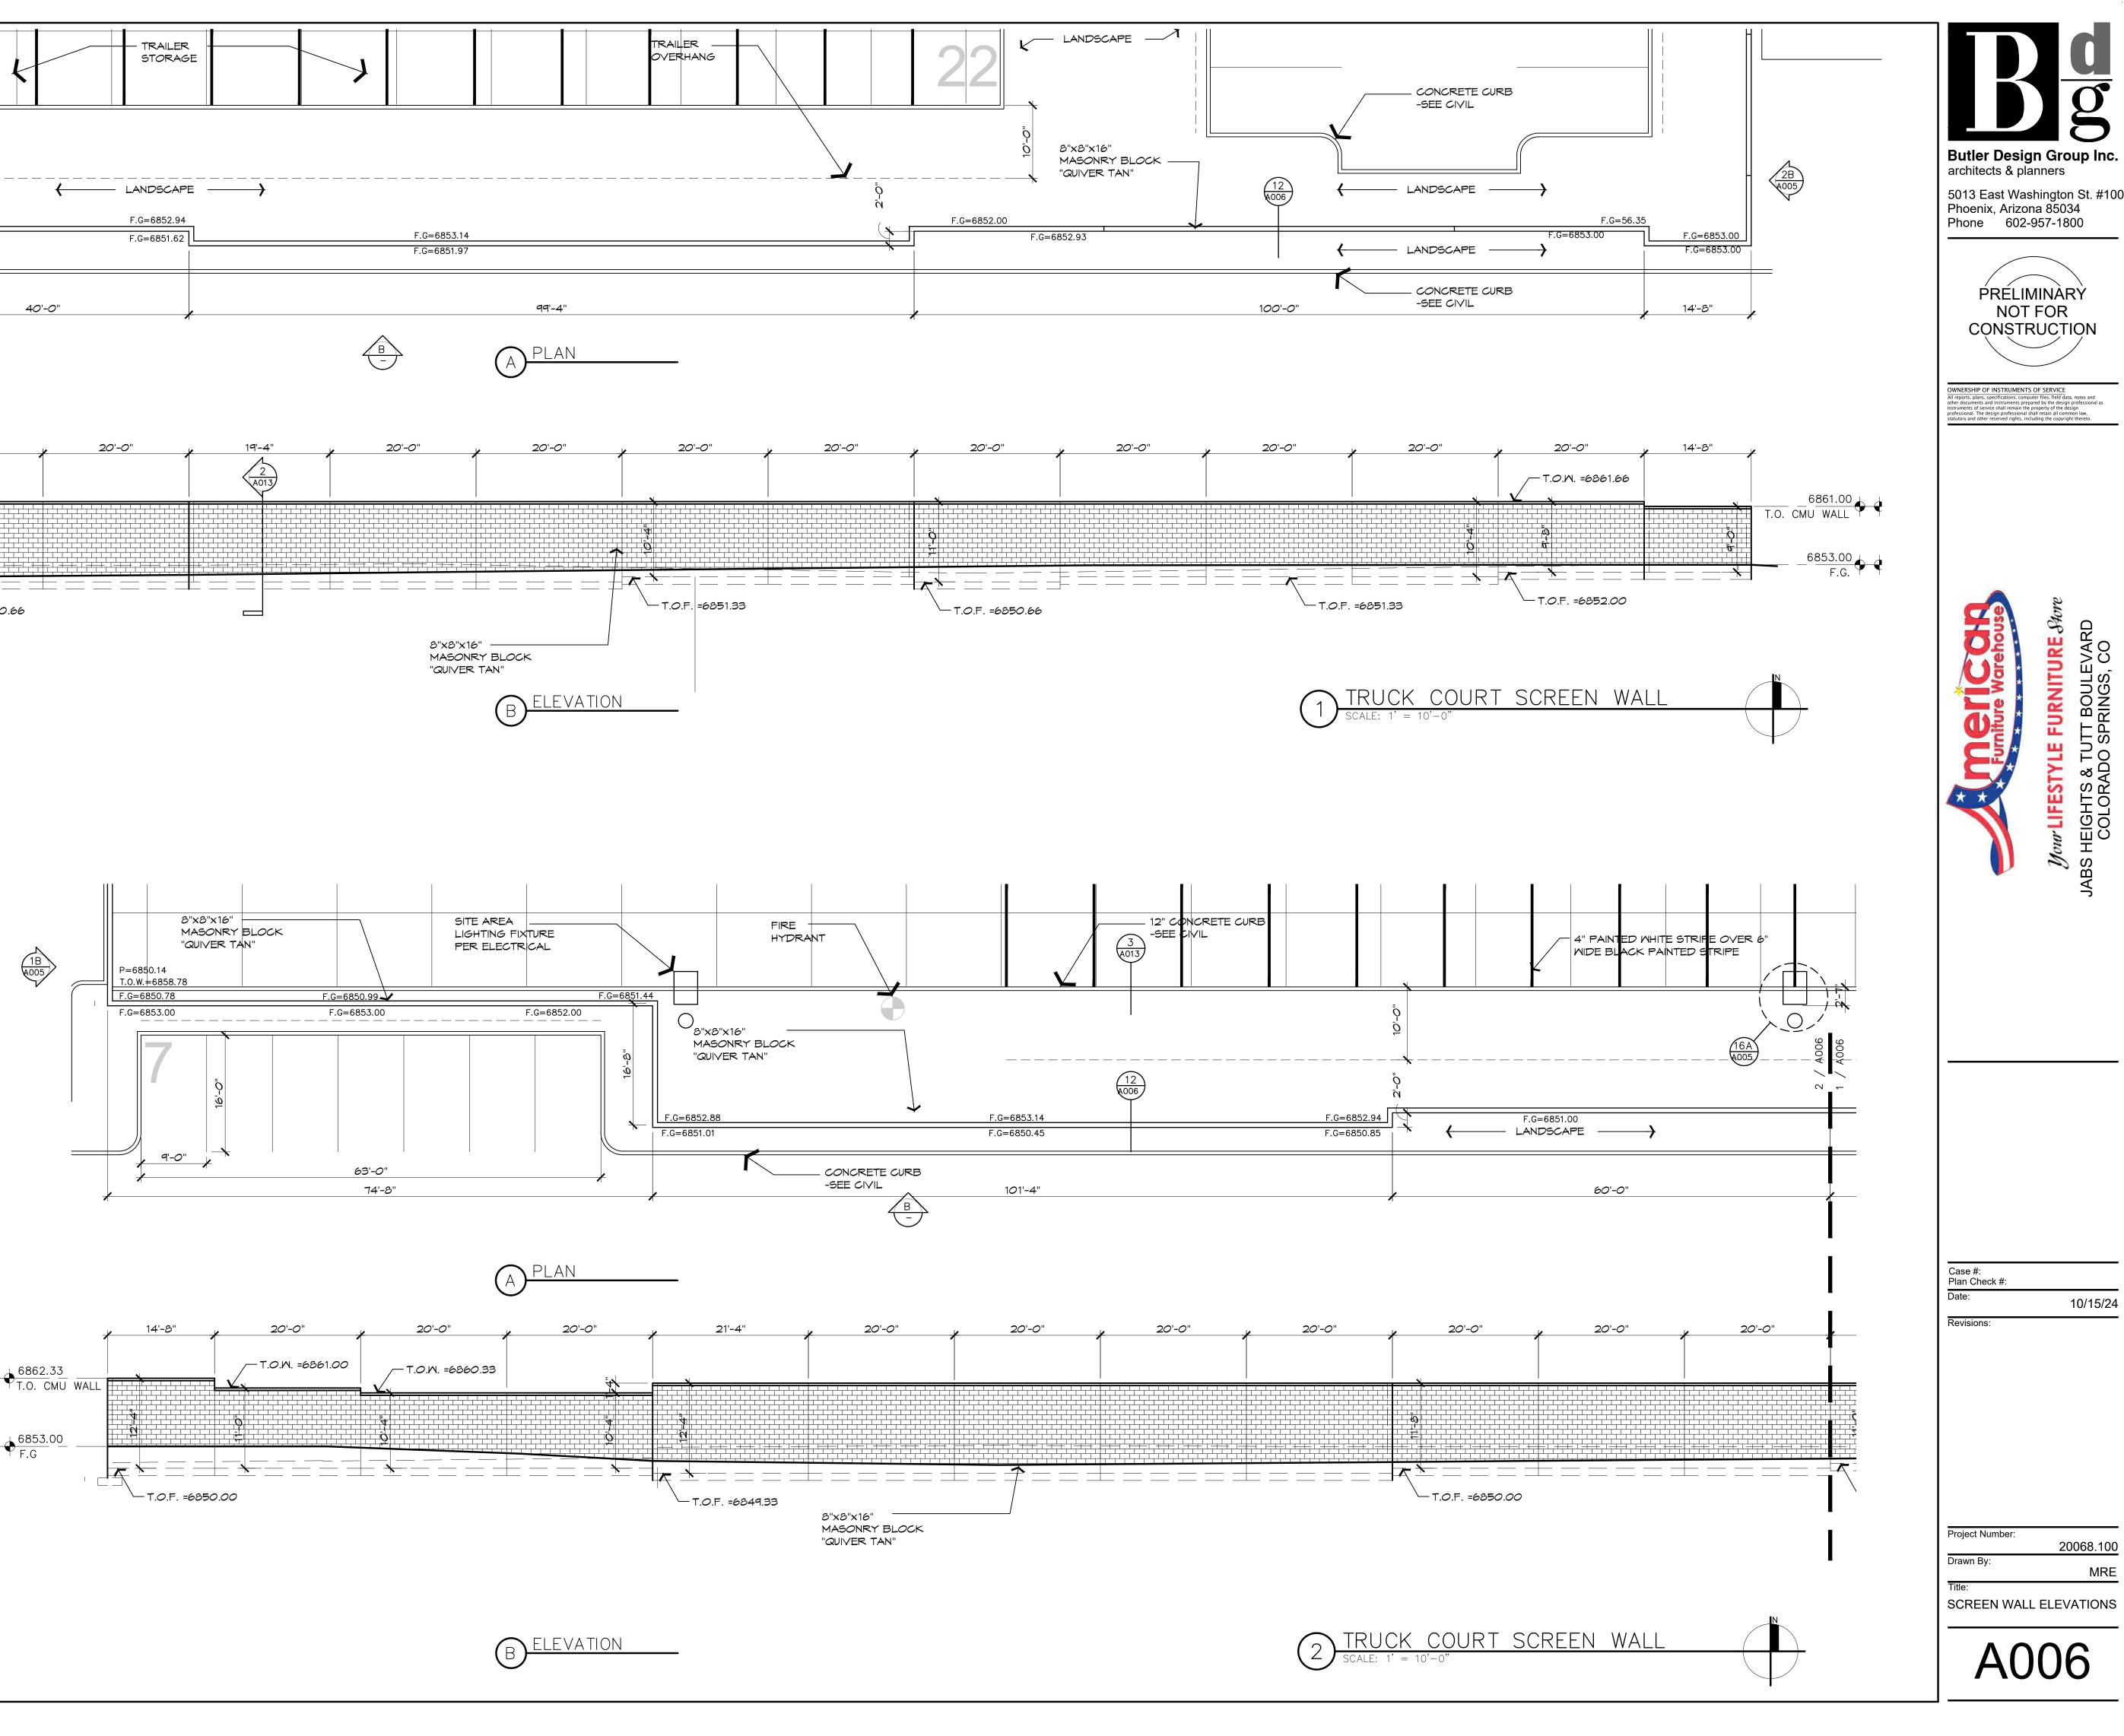


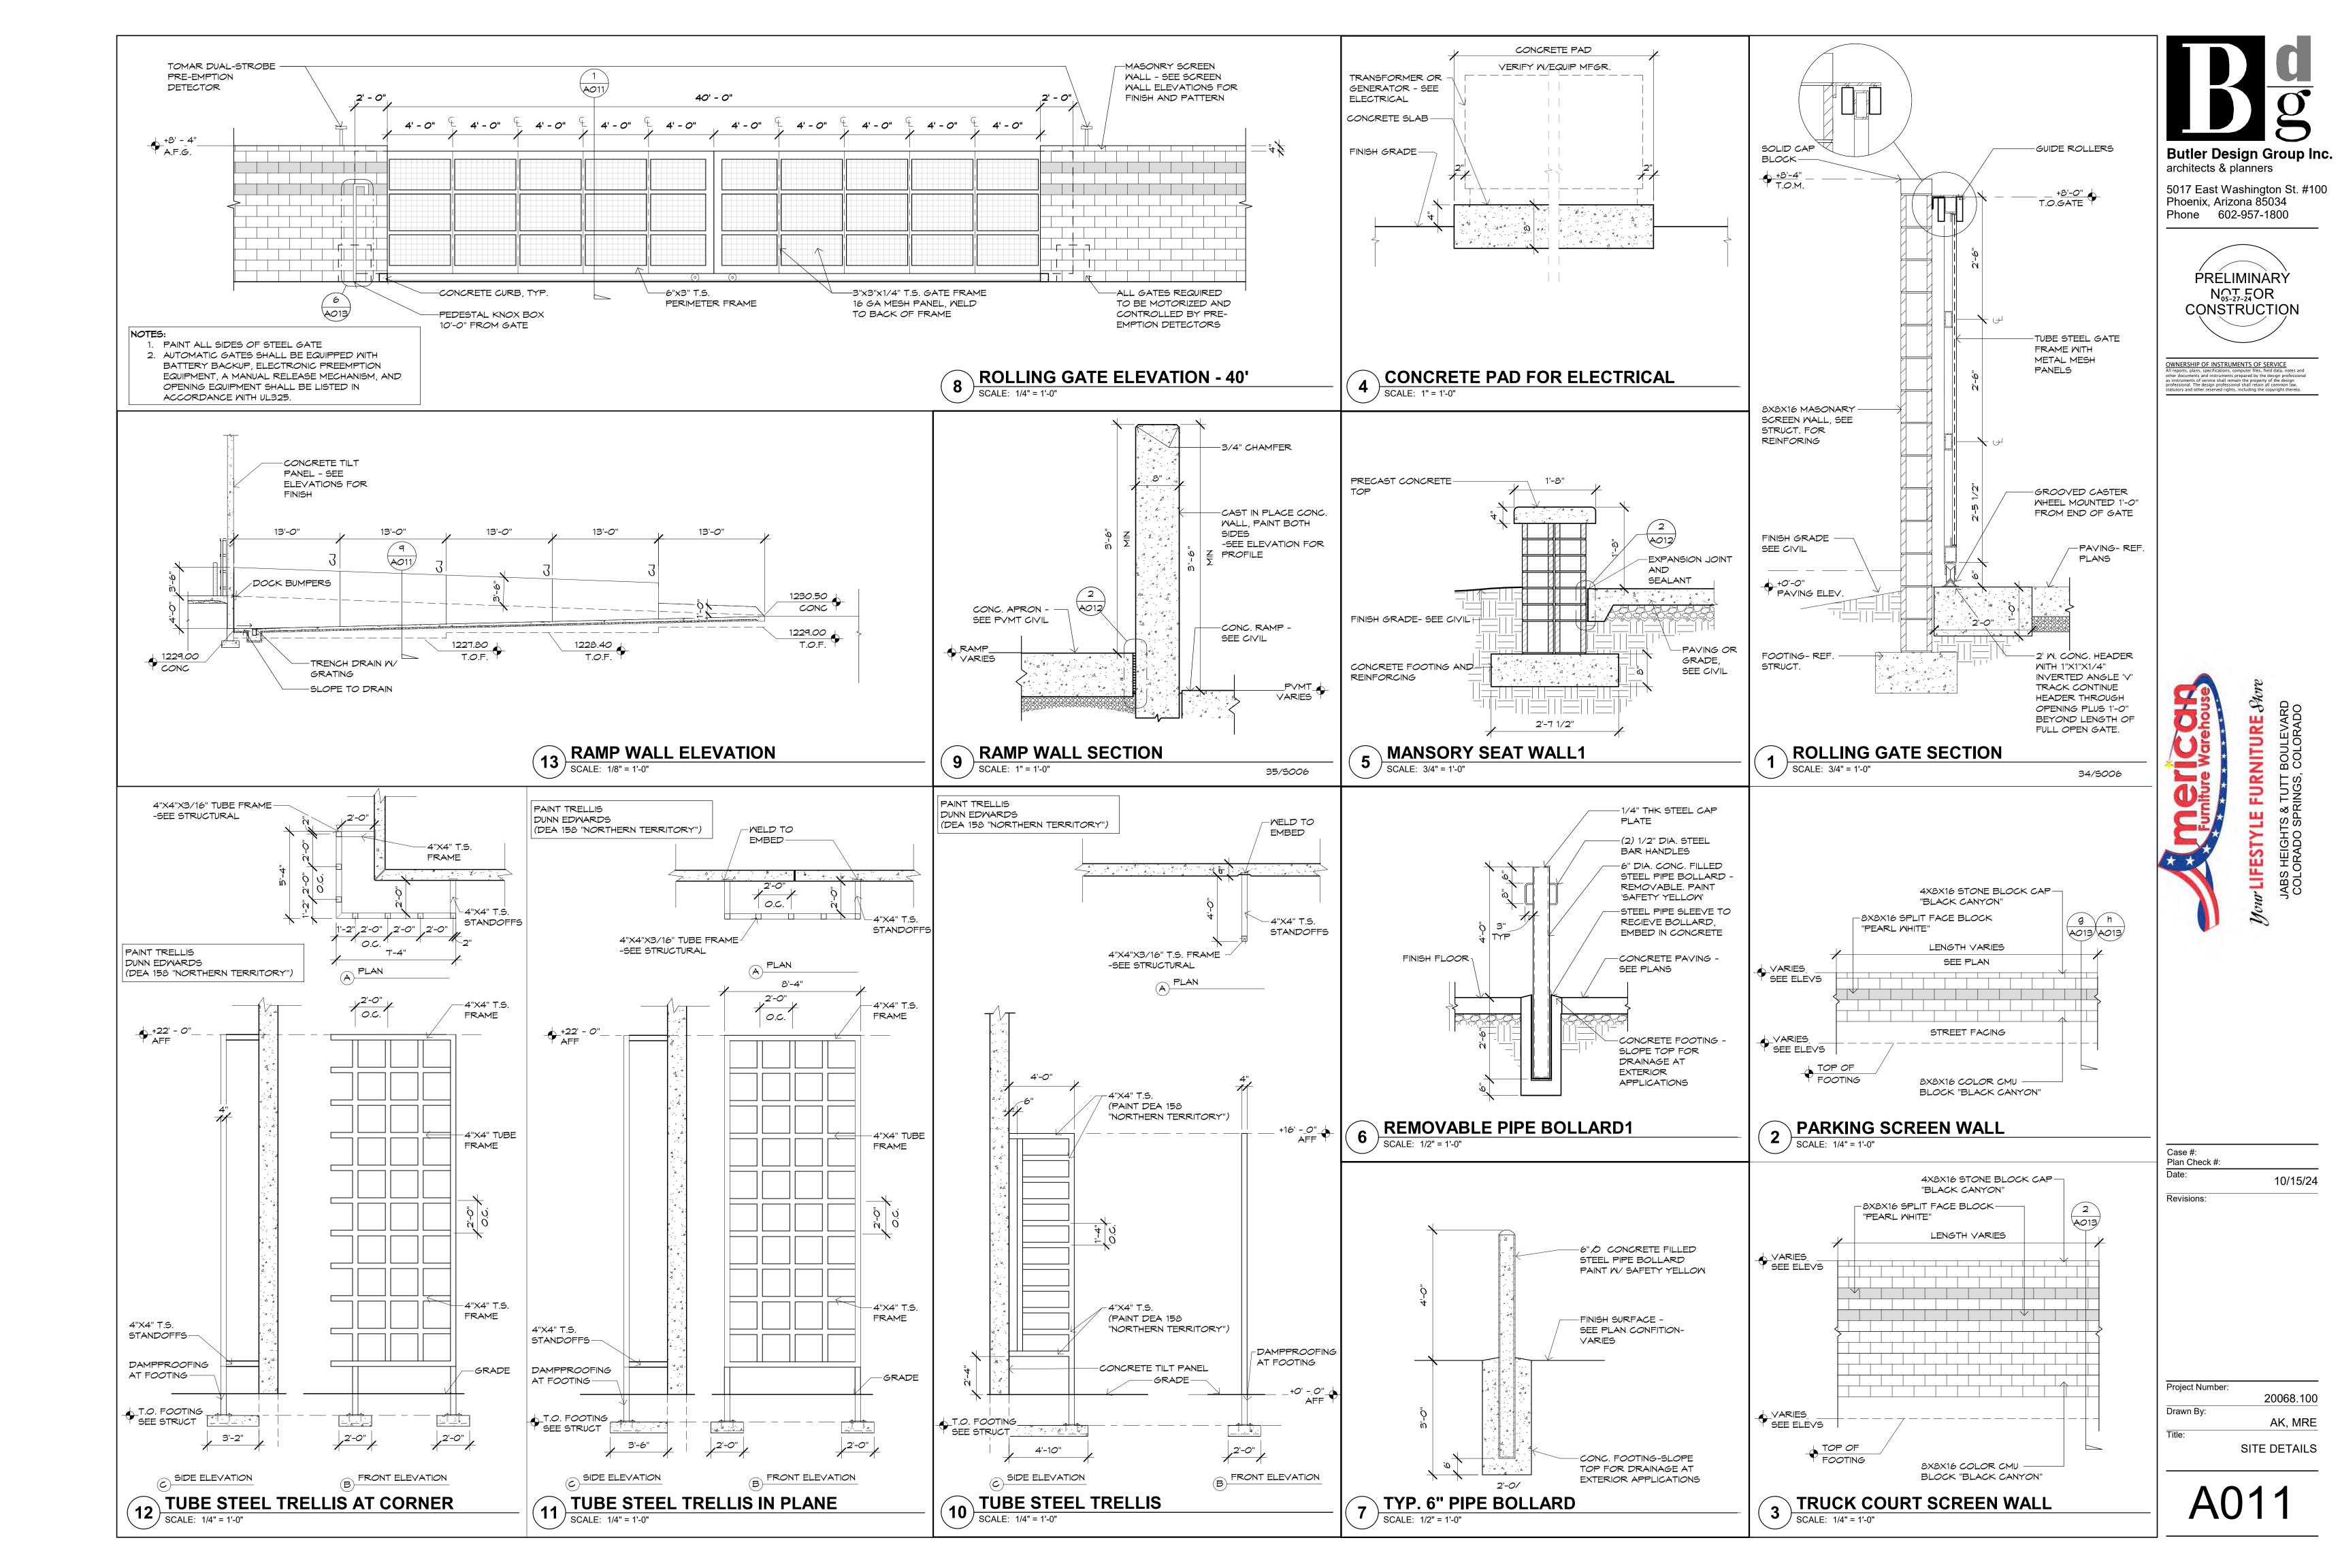


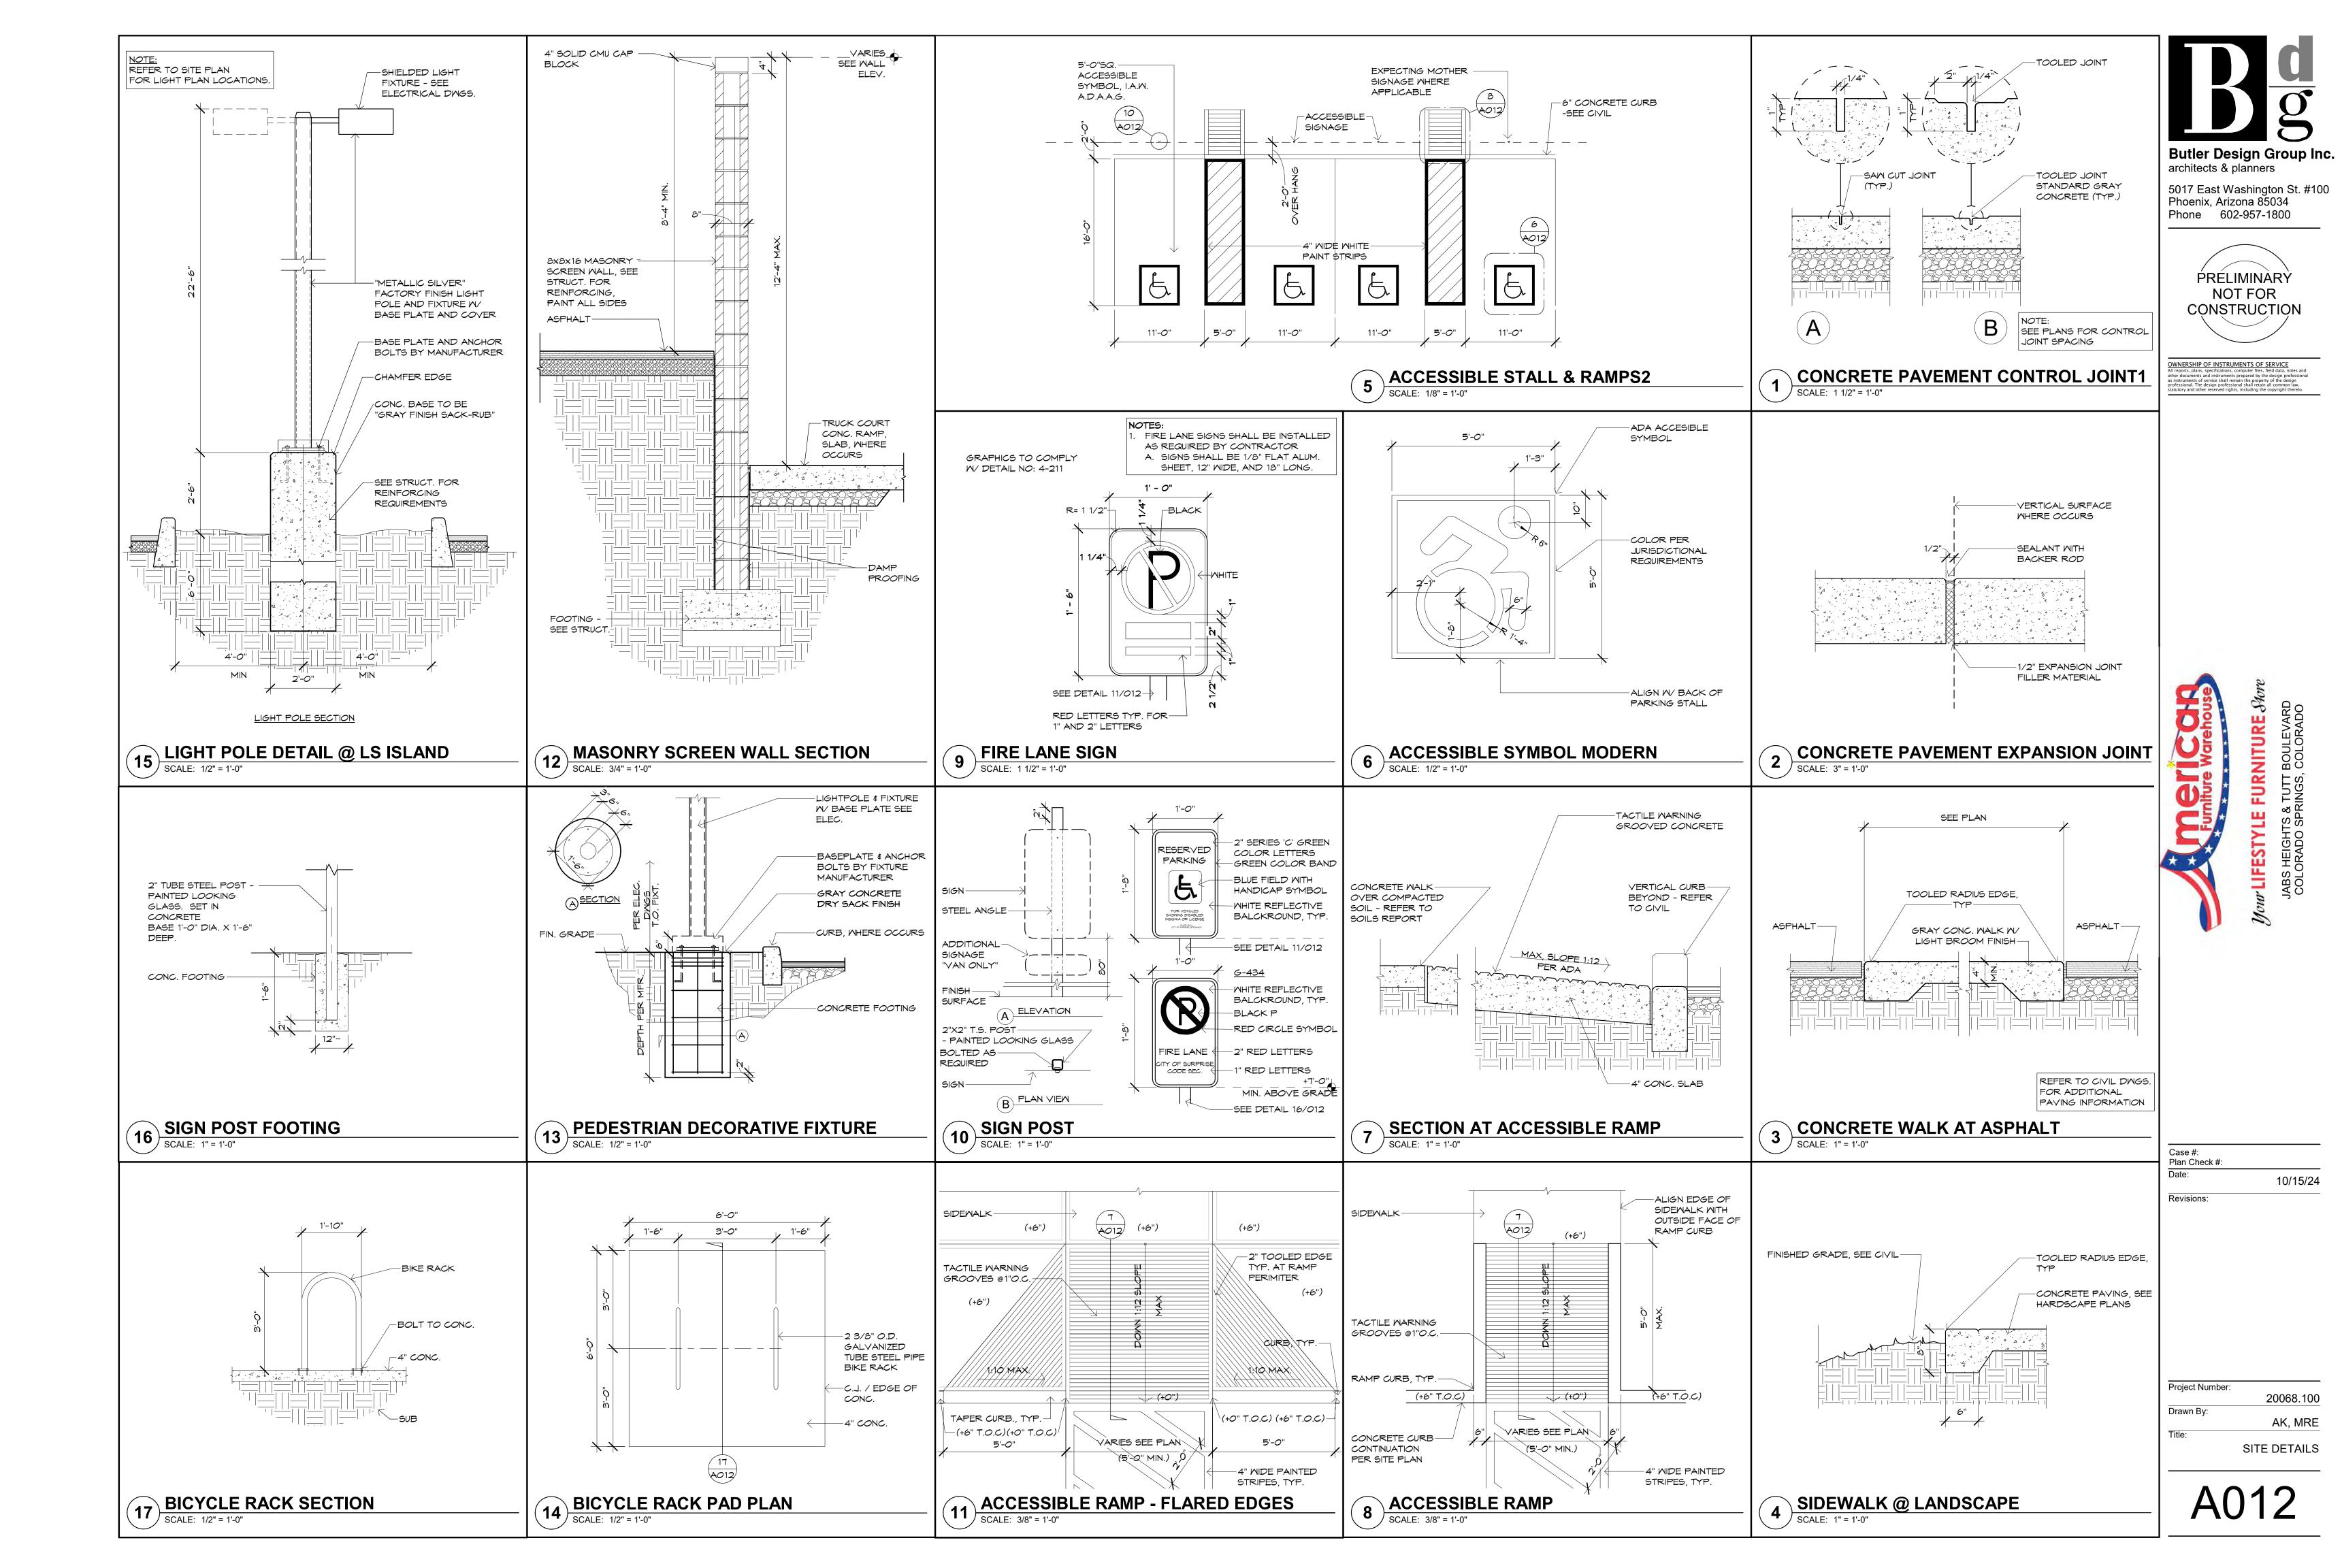


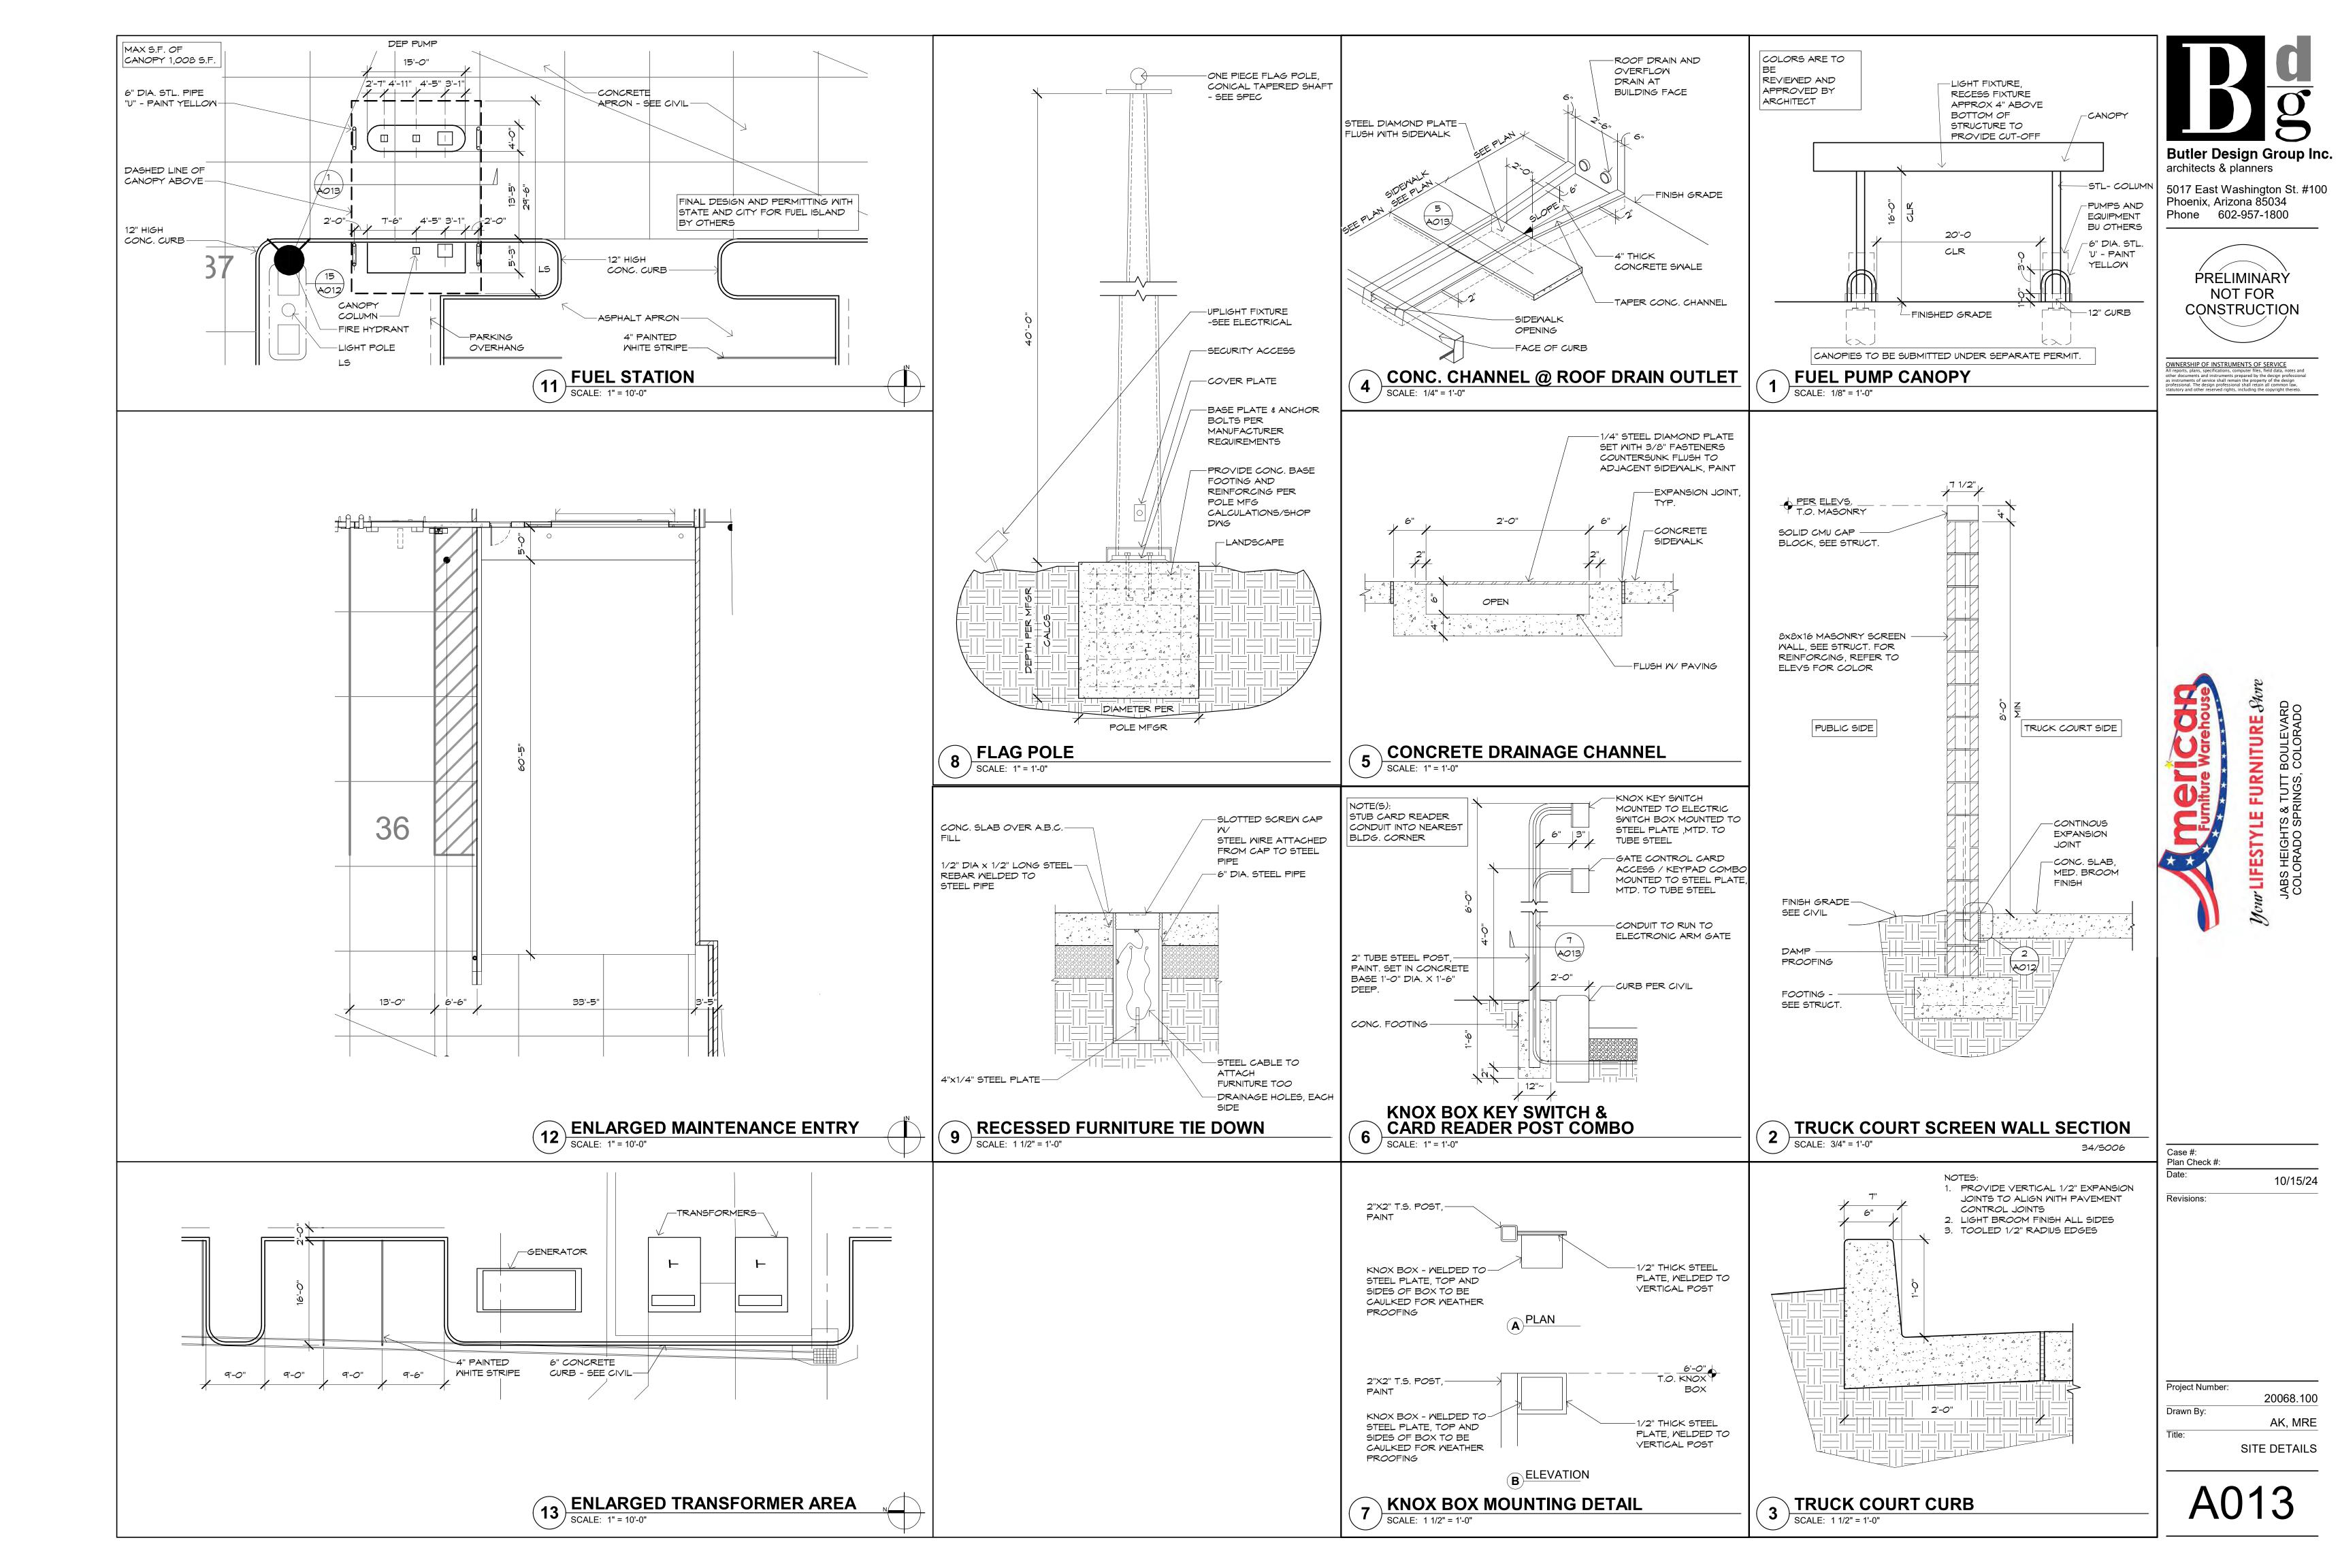

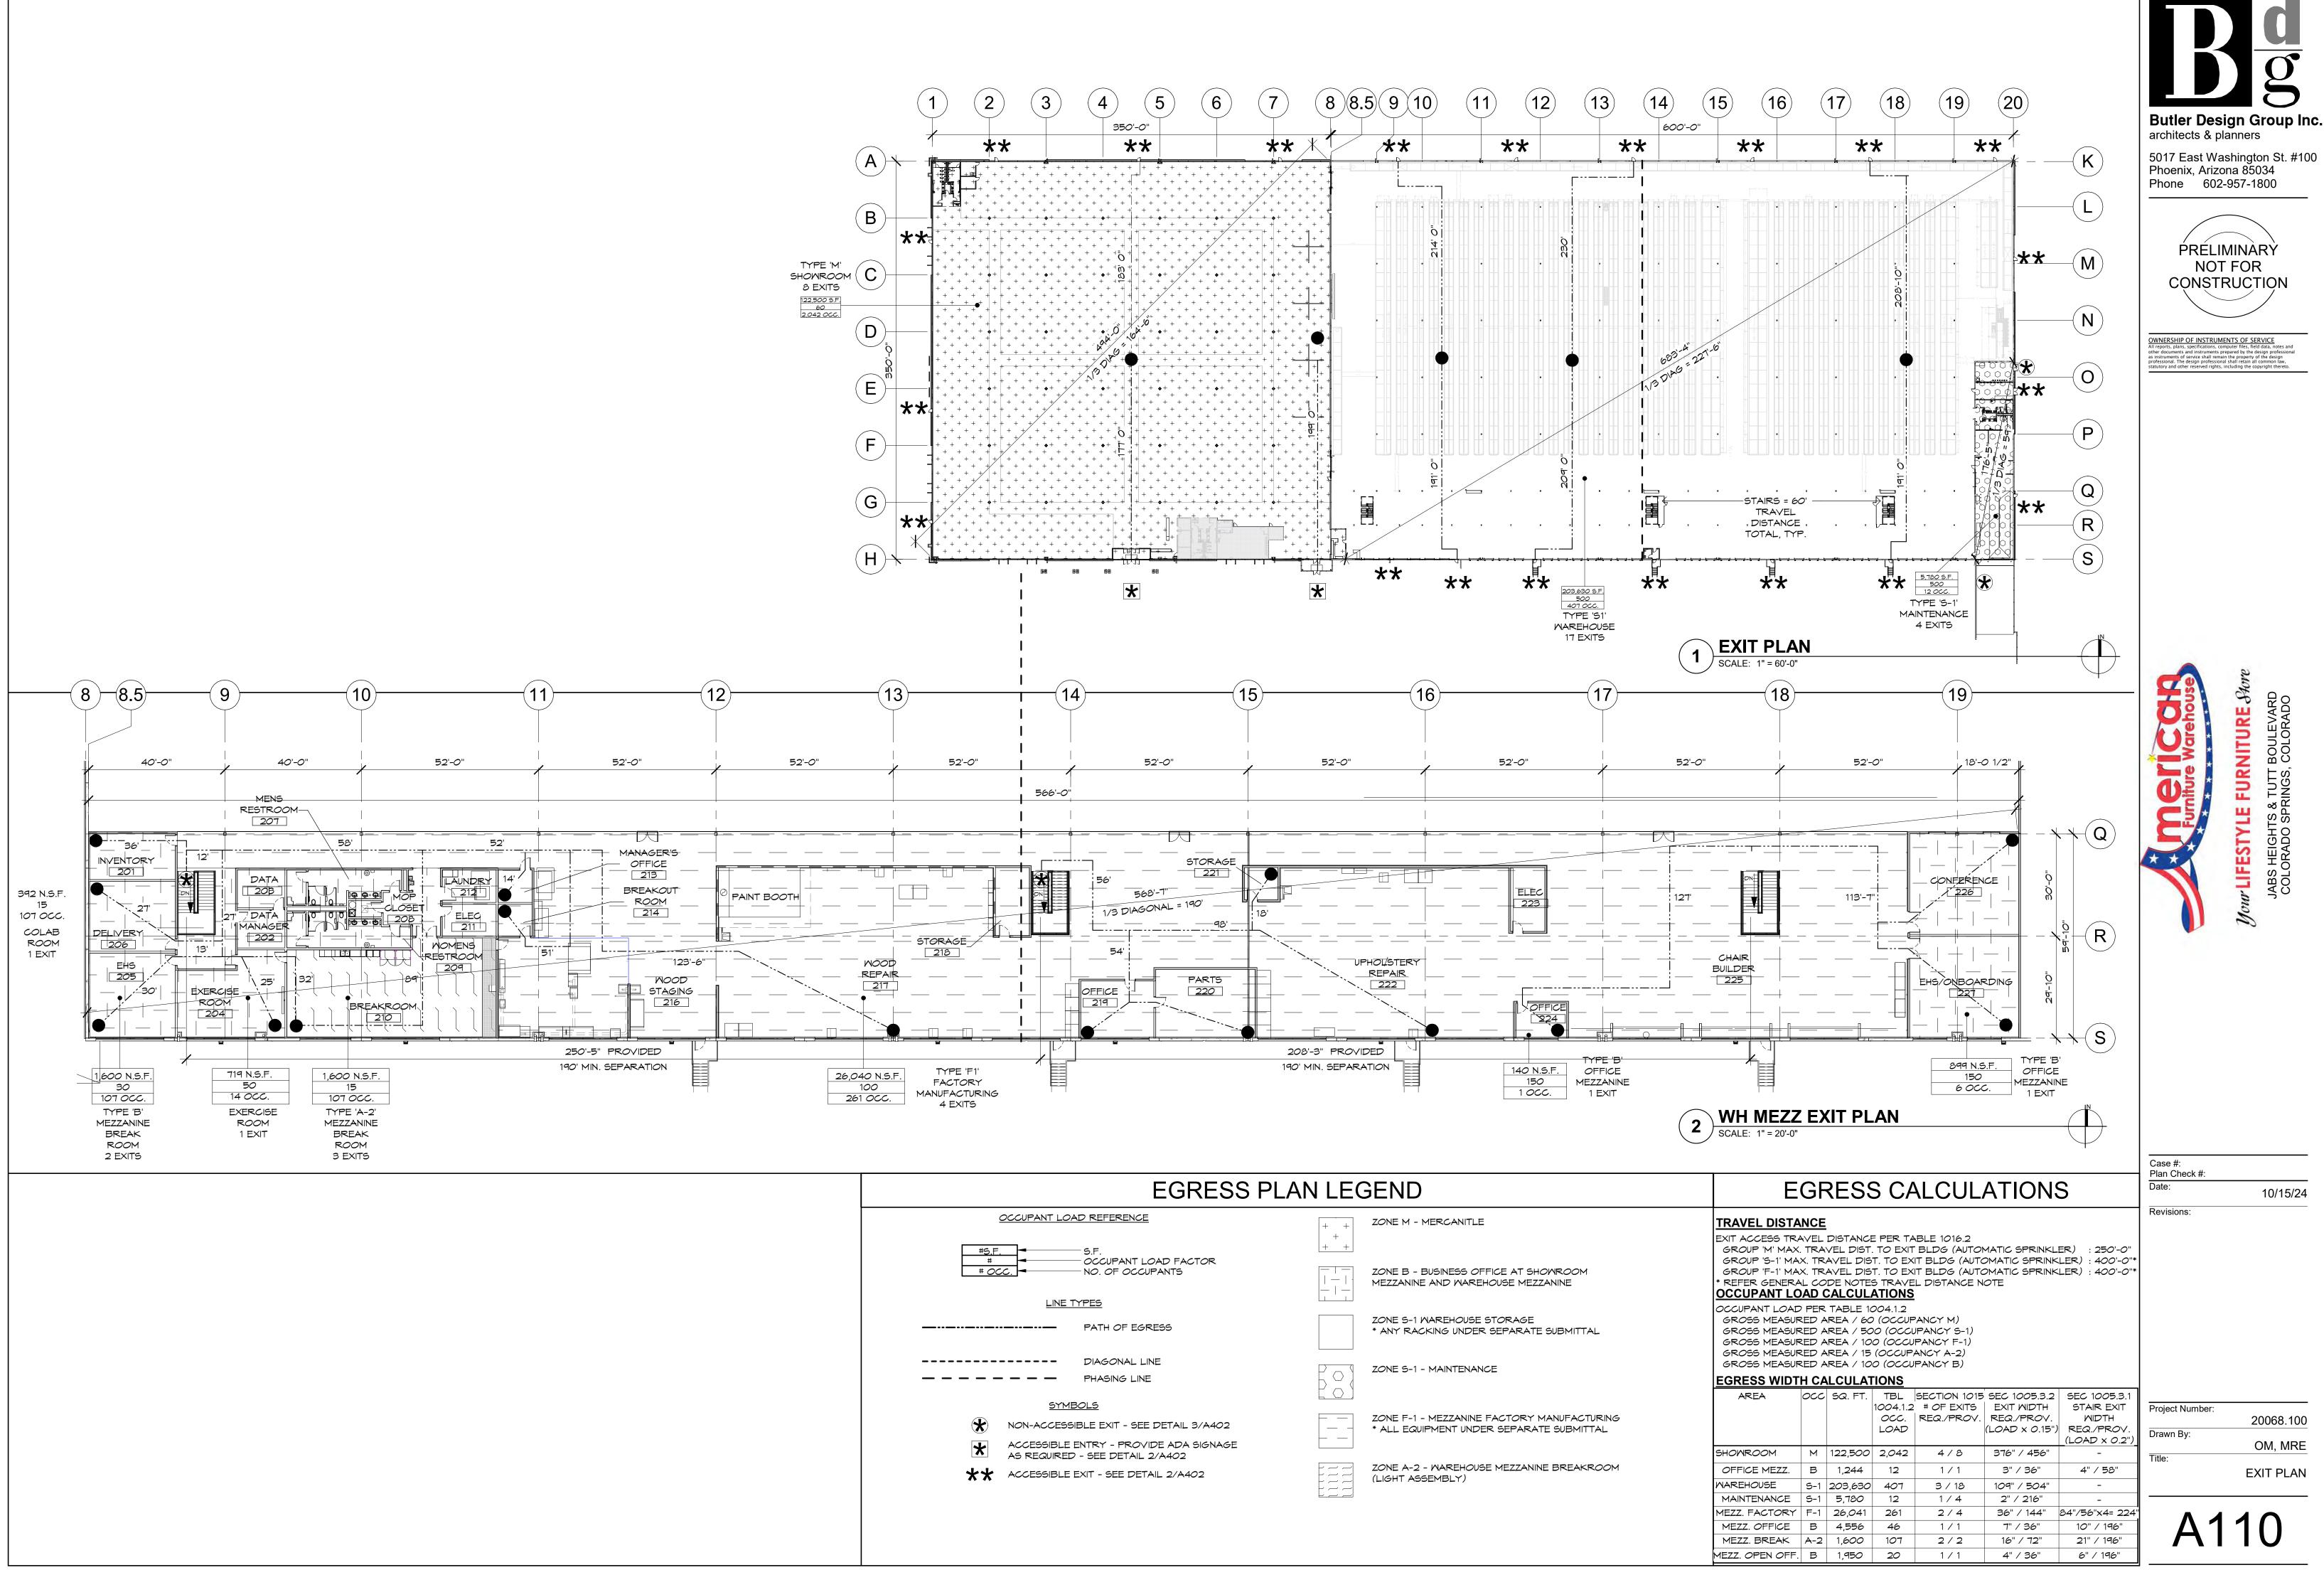

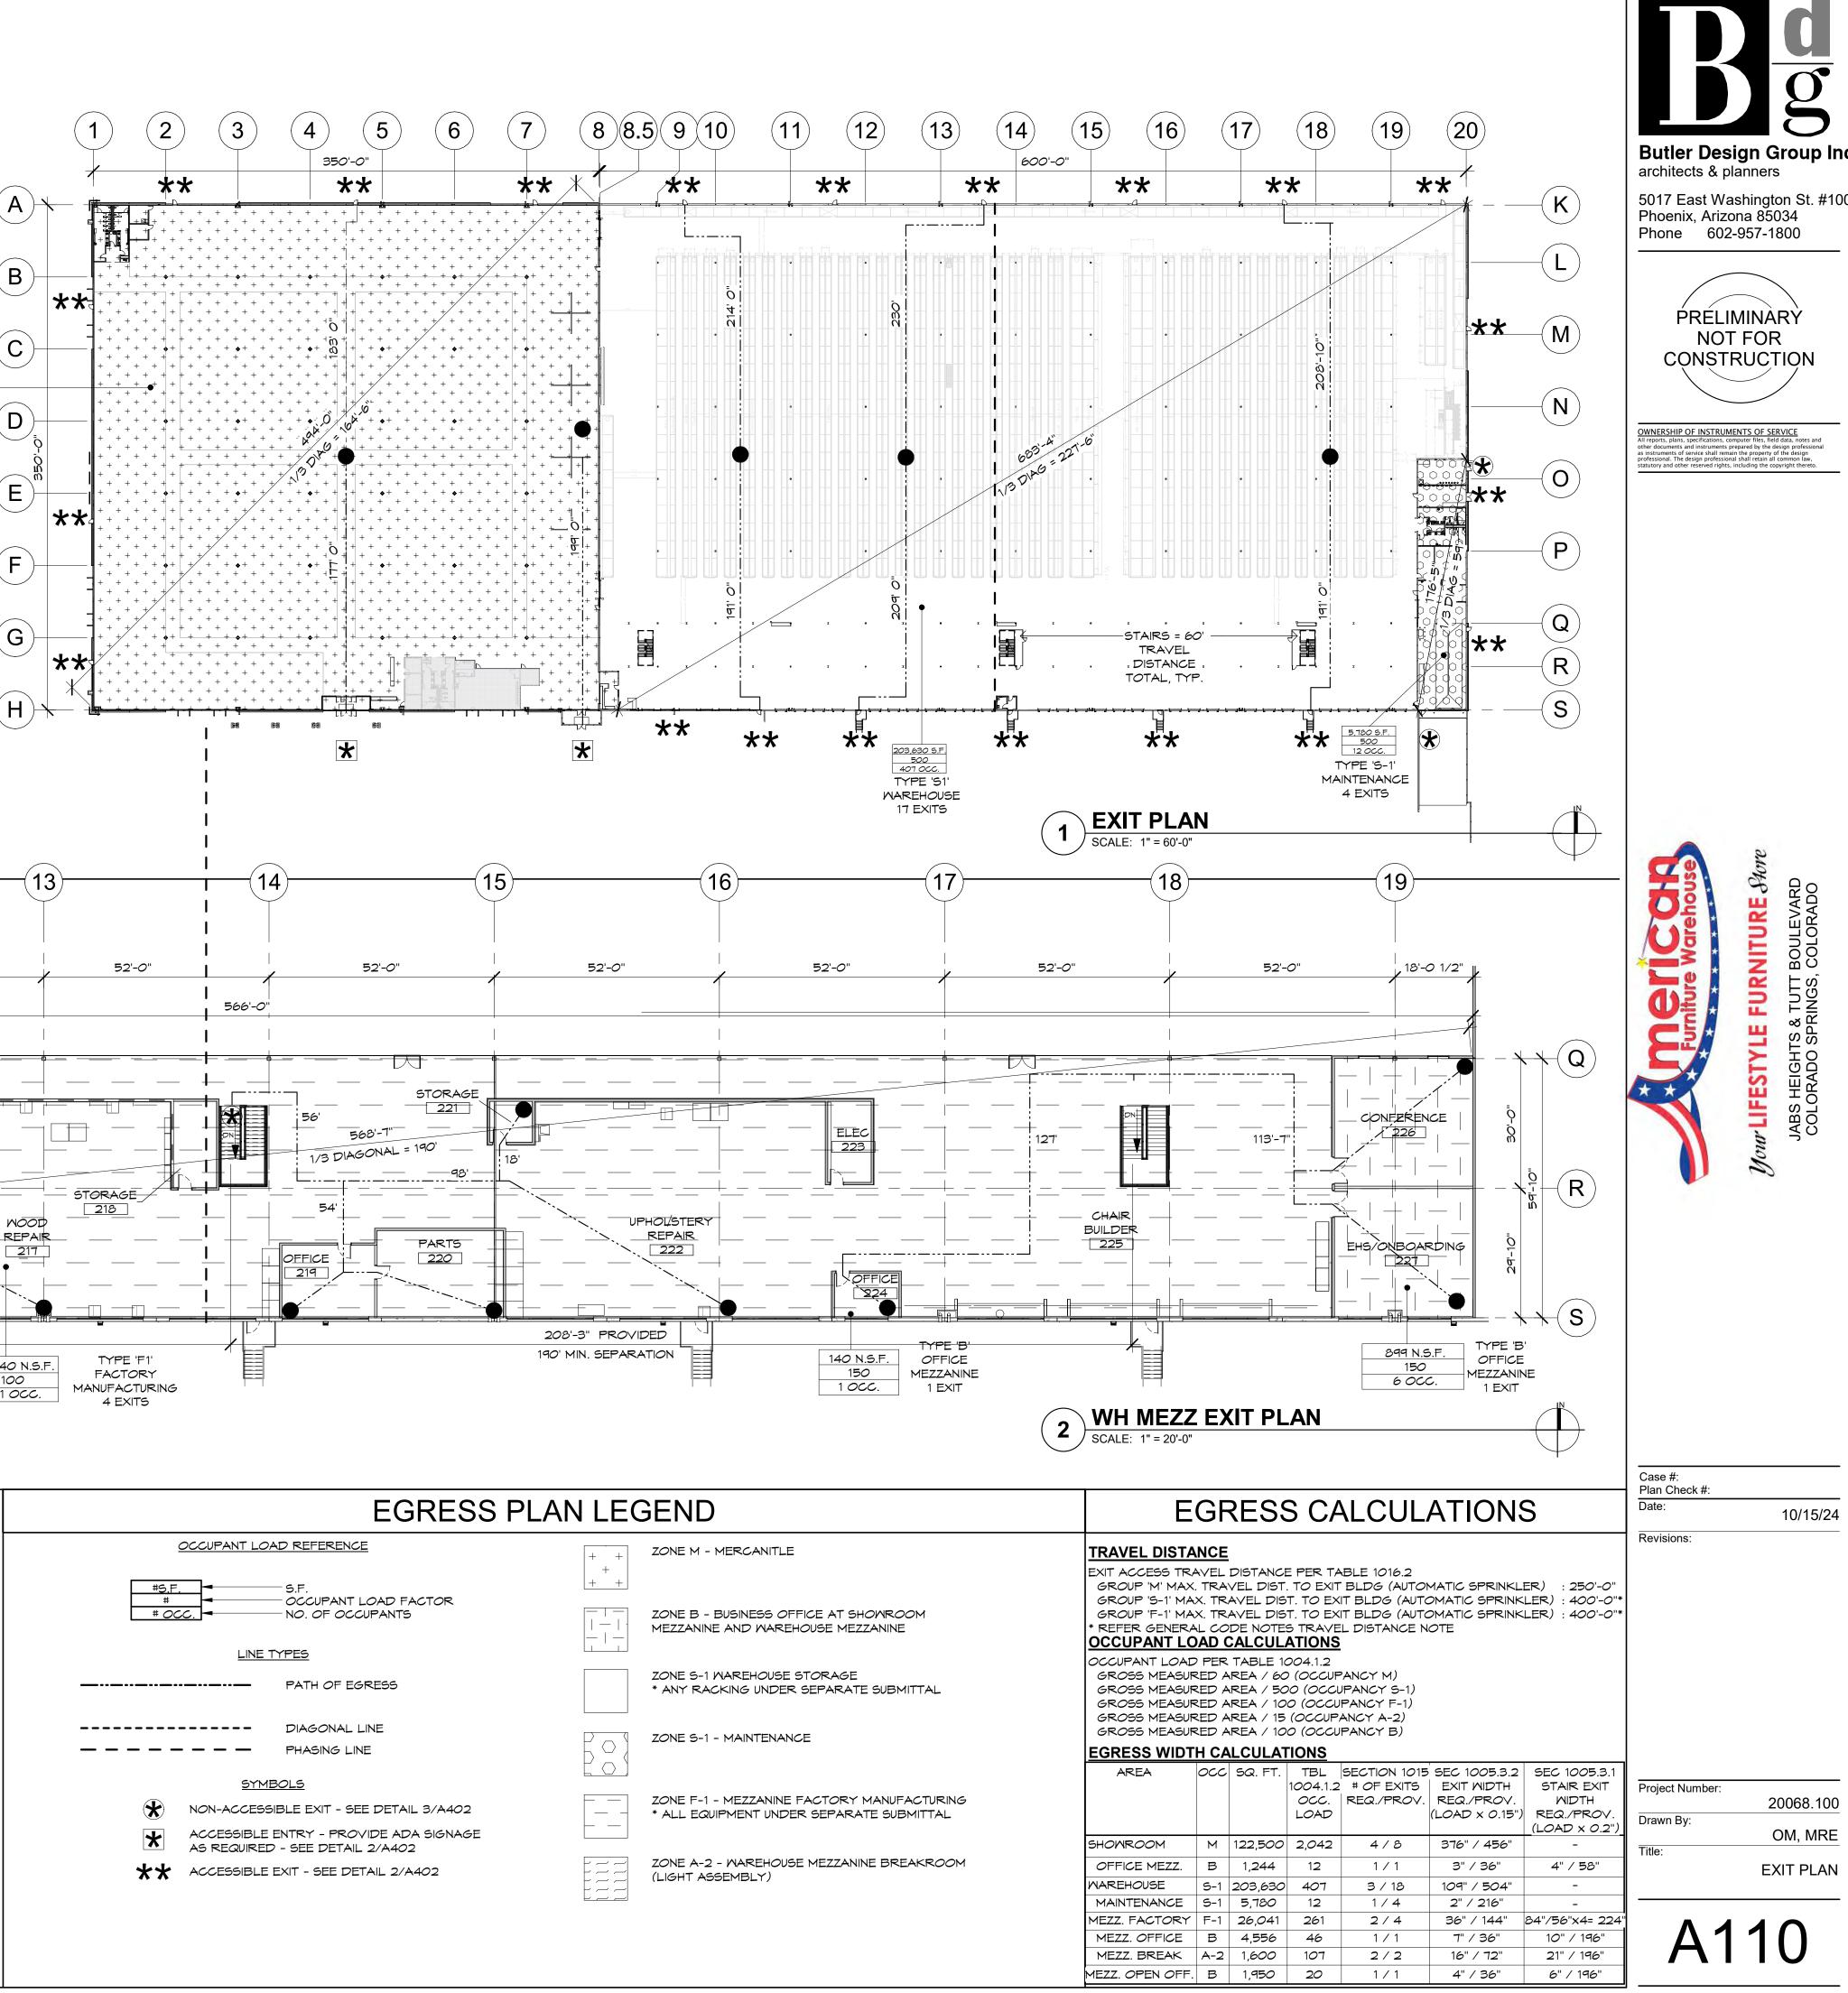

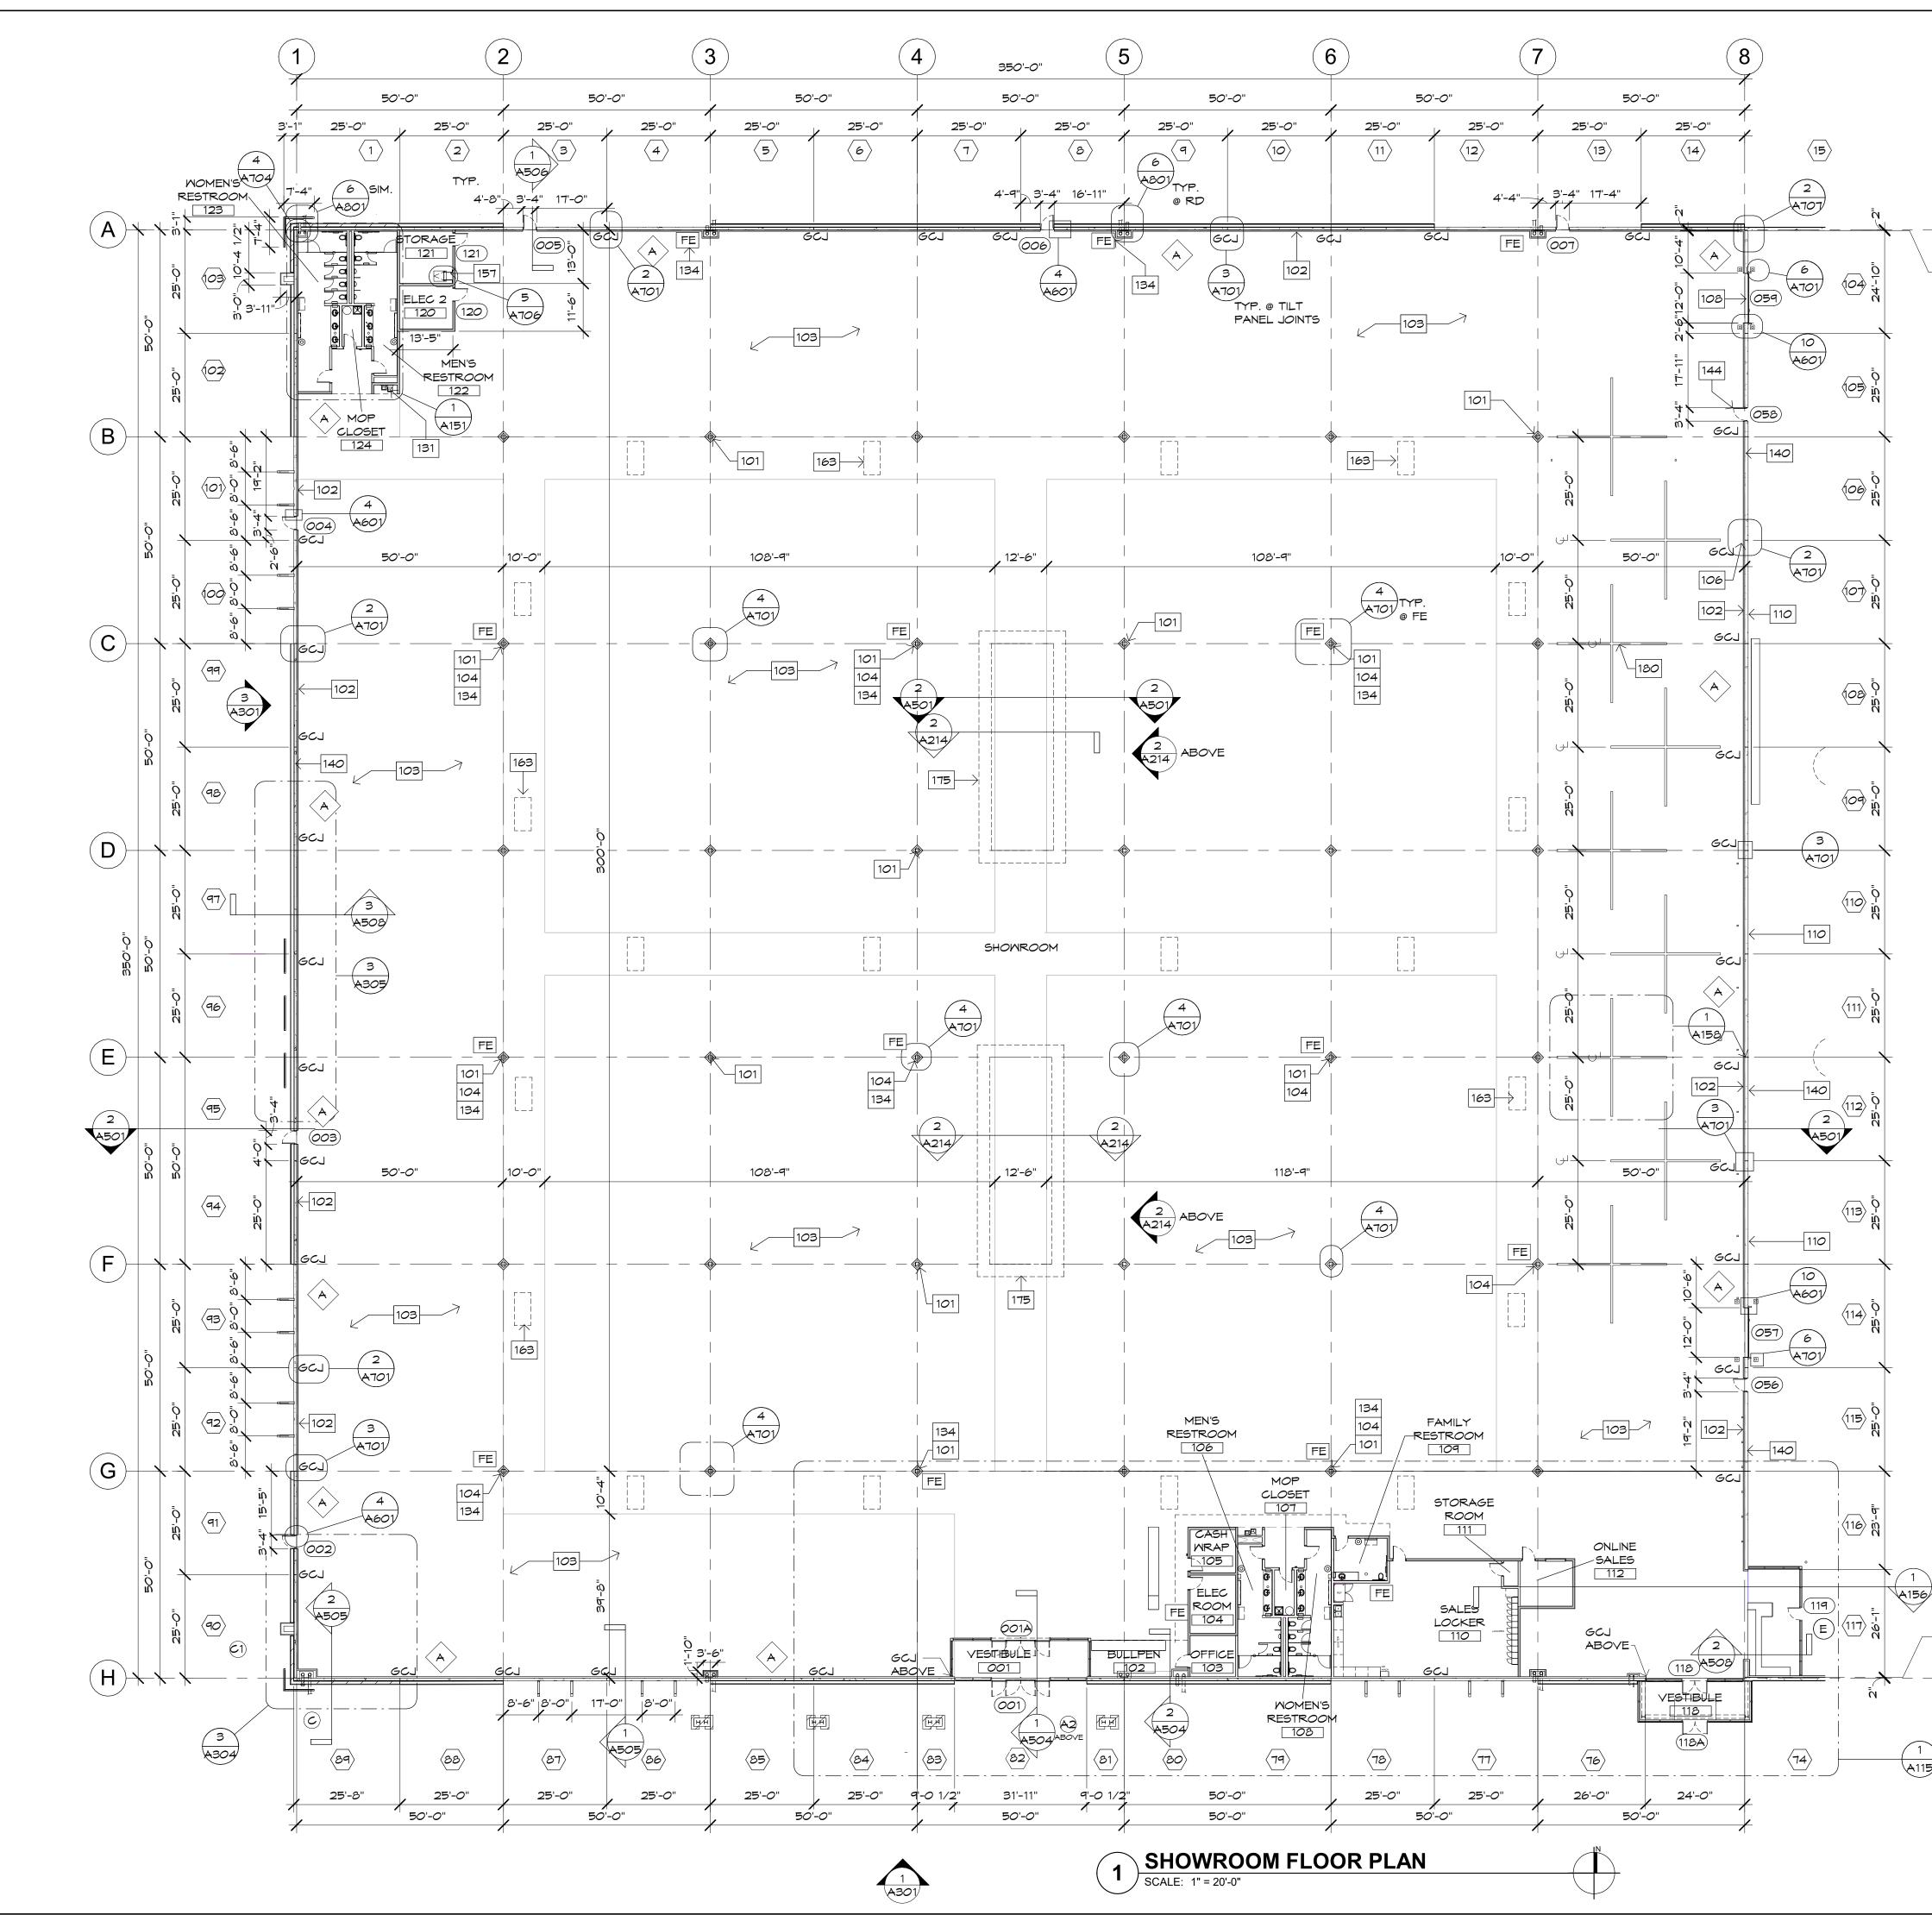

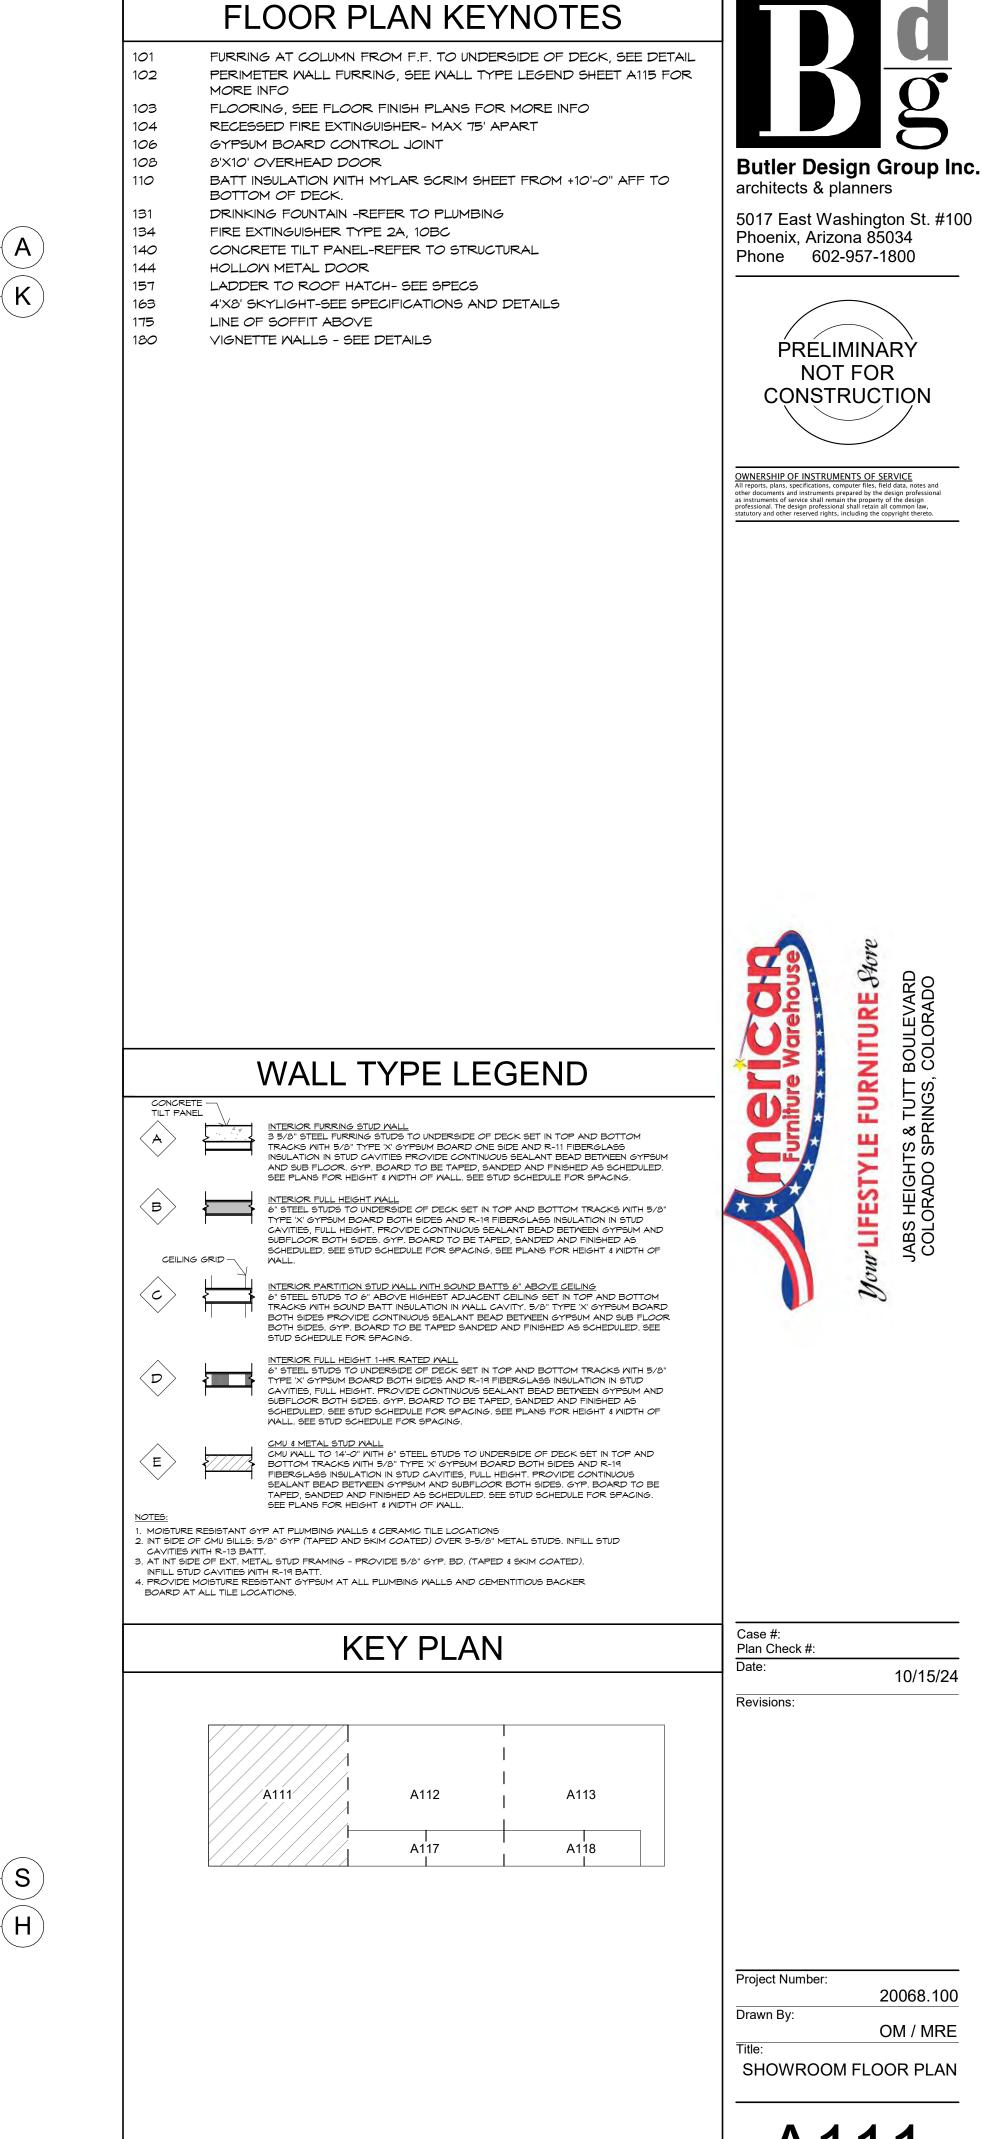


A115/

S


Ή


Α


A111

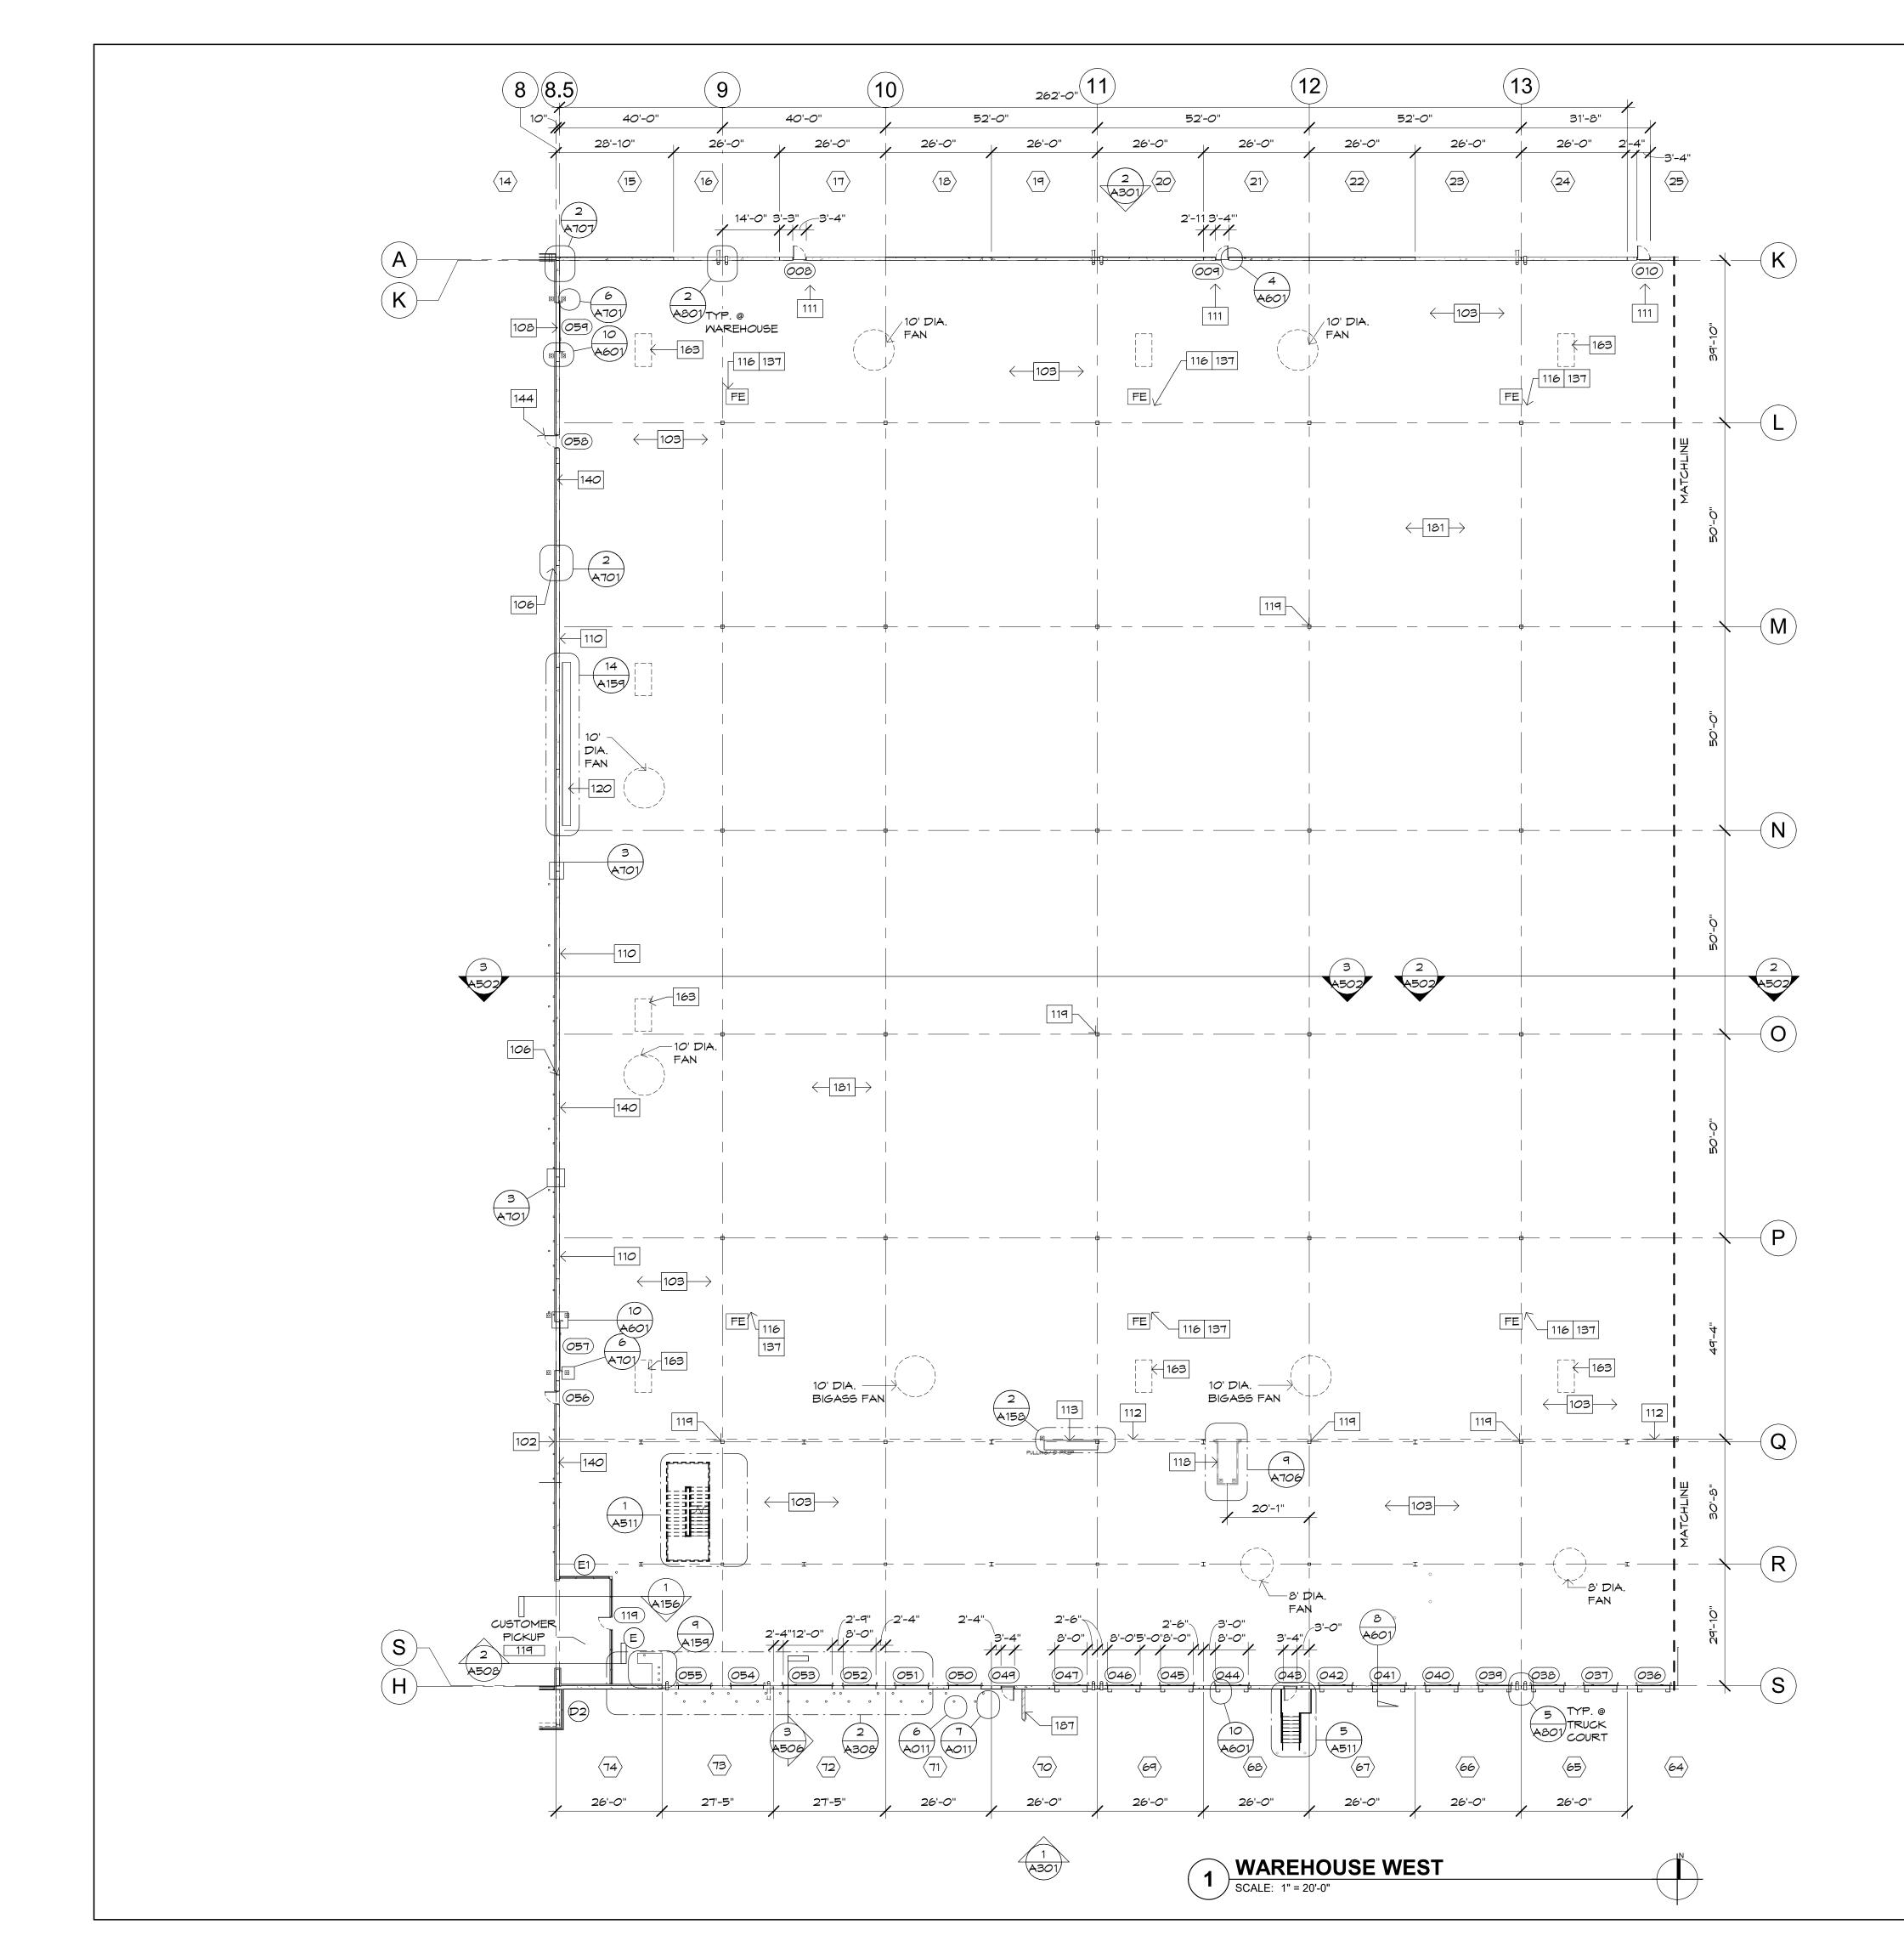


FLOOR PLAN KEYNOTES g PERIMETER WALL FURRING, SEE WALL TYPE LEGEND SHEET A115 102 FOR MORE INFO 103 FLOORING, SEE FLOOR FINISH PLANS FOR MORE INFO 106 GYPSUM BOARD CONTROL JOINT 108 8'X10' OVERHEAD DOOR Butler Design Group Inc. 110 BATT INSULATION WITH MYLAR SCRIM SHEET FROM +10'-0" AFF TO BOTTOM OF DECK. architects & planners 111 CLEAR PASSAGE WAY AT FUTURE RACKING FOR EXITING 112 LINE OF MEZZANINE ABOVE 5017 East Washington St. #100 113 Phoenix, Arizona 85034 WORKSTATION PODIUM AND GUIDERAILS - WITH POWER AND DATA -SEE DETAILS Phone 602-957-1800 116 SURFACE MOUNTED FIRE EXTINGUISHER- MAX 100' 118 GUIDE TRACKS AT FLOOR, ALIGN WITH MEZZANINE GATE ABOVE 119 STEEL COLUMN- REFER TO STRUCTURAL. PAINT COLUMNS TO 8' HIGH WARNING YELLOW. PAINT ALL COLUMNS FROM WARNING COLOR TO ROOF DECK. PRÉLIMINARY 120 MILLWORK, SEE DETAIL NOT FOR FIRE EXTINGUISHER TYPE 2A, 20B-C 137 140 CONCRETE TILT PANEL-REFER TO STRUCTURAL CONSTRUCTION HOLLOW METAL DOOR 144 163 4'X8' SKYLIGHT-SEE SPECIFICATIONS AND DETAILS 181 RACKING UNDER SEPARATE PERMIT 187 SITE RETAINING WALL OWNERSHIP OF INSTRUMENTS OF SERVICE All reports, plans, specifications, computer files, field data, notes ar other documents and instruments prepared by the design profession as instruments of service shall remain the property of the design professional. The design professional shall retain all common law, statutory and other reserved rights, including the copyright thereto. FURNITURE & **JLEVAI** BOL TUTT INGS, 02 **KEY PLAN** ωŭ ... *r***LIFESTYL** JABS HEIGHT: COLORADO { 2 A113 A111 ∕A112∕ A117 A118 Case #: Plan Check #: WALL TYPE LEGEND Date: 10/15/24 CONCRETE -TILT PANEL Revisions: INTERIOR FURRING STUD WALL 3 5/8" STEEL FURRING STUDS TO UNDERSIDE OF DECK SET IN TOP AND BOTTOM TRACKS WITH 5/8" TYPE 'X' GYPSUM BOARD ONE SIDE AND R-11 FIBERGLASS INSULATION IN STUD CAVITIES PROVIDE CONTINUOUS SEALANT BEAD BETWEEN GYPSUM AND SUB FLOOR. GYP. BOARD TO BE TAPED, SANDED AND FINISHED AS SCHEDULED. SEE DATE FOR UNITED TO AND TO BE TAPED, SANDED AND FINISHED AS SCHEDULED. (A)SEE PLANS FOR HEIGHT & WIDTH OF WALL. SEE STUD SCHEDULE FOR SPACING. INTERIOR FULL HEIGHT WALL 6" STEEL STUDS TO UNDERSIDE OF DECK SET IN TOP AND BOTTOM TRACKS WITH 5/8" TYPE 'X' GYPSUM BOARD BOTH SIDES AND R-19 FIBERGLASS INSULATION IN STUD (в> CAVITIES, FULL HEIGHT. PROVIDE CONTINUOUS SEALANT BEAD BETWEEN GYPSUM AND SUBFLOOR BOTH SIDES. GYP. BOARD TO BE TAPED, SANDED AND FINISHED AS SCHEDULED. SEE STUD SCHEDULE FOR SPACING. SEE PLANS FOR HEIGHT & WIDTH OF CEILING GRID — MALL. INTERIOR PARTITION STUD WALL WITH SOUND BATTS 6" ABOVE CEILING 6" STEEL STUDS TO 6" ABOVE HIGHEST ADJACENT CEILING SET IN TOP AND BOTTOM TRACKS WITH SOUND BATT INSULATION IN WALL CAVITY. 5/8" TYPE 'X' GYPSUM BOARD  $\langle c \rangle$ BOTH SIDES PROVIDE CONTINUOUS SEALANT BEAD BETWEEN GYPSUM AND SUB FLOOR BOTH SIDES. GYP. BOARD TO BE TAPED SANDED AND FINISHED AS SCHEDULED. SEE STUD SCHEDULE FOR SPACING. INTERIOR FULL HEIGHT 1-HR RATED WALL 6" STEEL STUDS TO UNDERSIDE OF DECK SET IN TOP AND BOTTOM TRACKS WITH 5/8" TYPE 'X' GYPSUM BOARD BOTH SIDES AND R-19 FIBERGLASS INSULATION IN STUD  $\langle D \rangle$ Project Number: CAVITIES, FULL HEIGHT. PROVIDE CONTINUOUS SEALANT BEAD BETWEEN GYPSUM AND 20068.100 SUBFLOOR BOTH SIDES. GYP. BOARD TO BE TAPED, SANDED AND FINISHED AS SCHEDULED. SEE STUD SCHEDULE FOR SPACING. SEE PLANS FOR HEIGHT & WIDTH OF WALL. SEE STUD SCHEDULE FOR SPACING. Drawn By: OM, MRE <u>CMU & METAL STUD WALL</u> CMU WALL TO 14'-O" WITH 6" STEEL STUDS TO UNDERSIDE OF DECK SET IN TOP AND BOTTOM TRACKS WITH 5/8" TYPE X GYPSUM BOARD BOTH SIDES AND R-19 Title: (E)PARTIAL WAREHOUSE FIBERGLASS INSULATION IN STUD CAVITIES, FULL HEIGHT. PROVIDE CONTINUOUS SEALANT BEAD BETWEEN GYPSUM AND SUBFLOOR BOTH SIDES. GYP. BOARD TO BE FLOOR PLAN TAPED, SANDED AND FINISHED AS SCHEDULED. SEE STUD SCHEDULE FOR SPACING. SEE PLANS FOR HEIGHT & WIDTH OF WALL. NOTES: MOISTURE RESISTANT GYP AT PLUMBING WALLS & CERAMIC TILE LOCATIONS
 INT SIDE OF CMU SILLS: 5/8" GYP (TAPED AND SKIM COATED) OVER 3-5/8" METAL STUDS. INFILL STUD CAVITIES WITH R-13 BATT.
 AT INT SIDE OF EXT. METAL STUD FRAMING - PROVIDE 5/8" GYP. BD. (TAPED & SKIM COATED). INFILL STUD CAVITIES WITH R-19 BATT.
 PROVIDE MOISTURE RESISTANT GYPSUM AT ALL PLUMBING WALLS AND CEMENTITIOUS BACKER BOARD AT AULTURE OCCUPIEN A112 BOARD AT ALL TILE LOCATIONS.

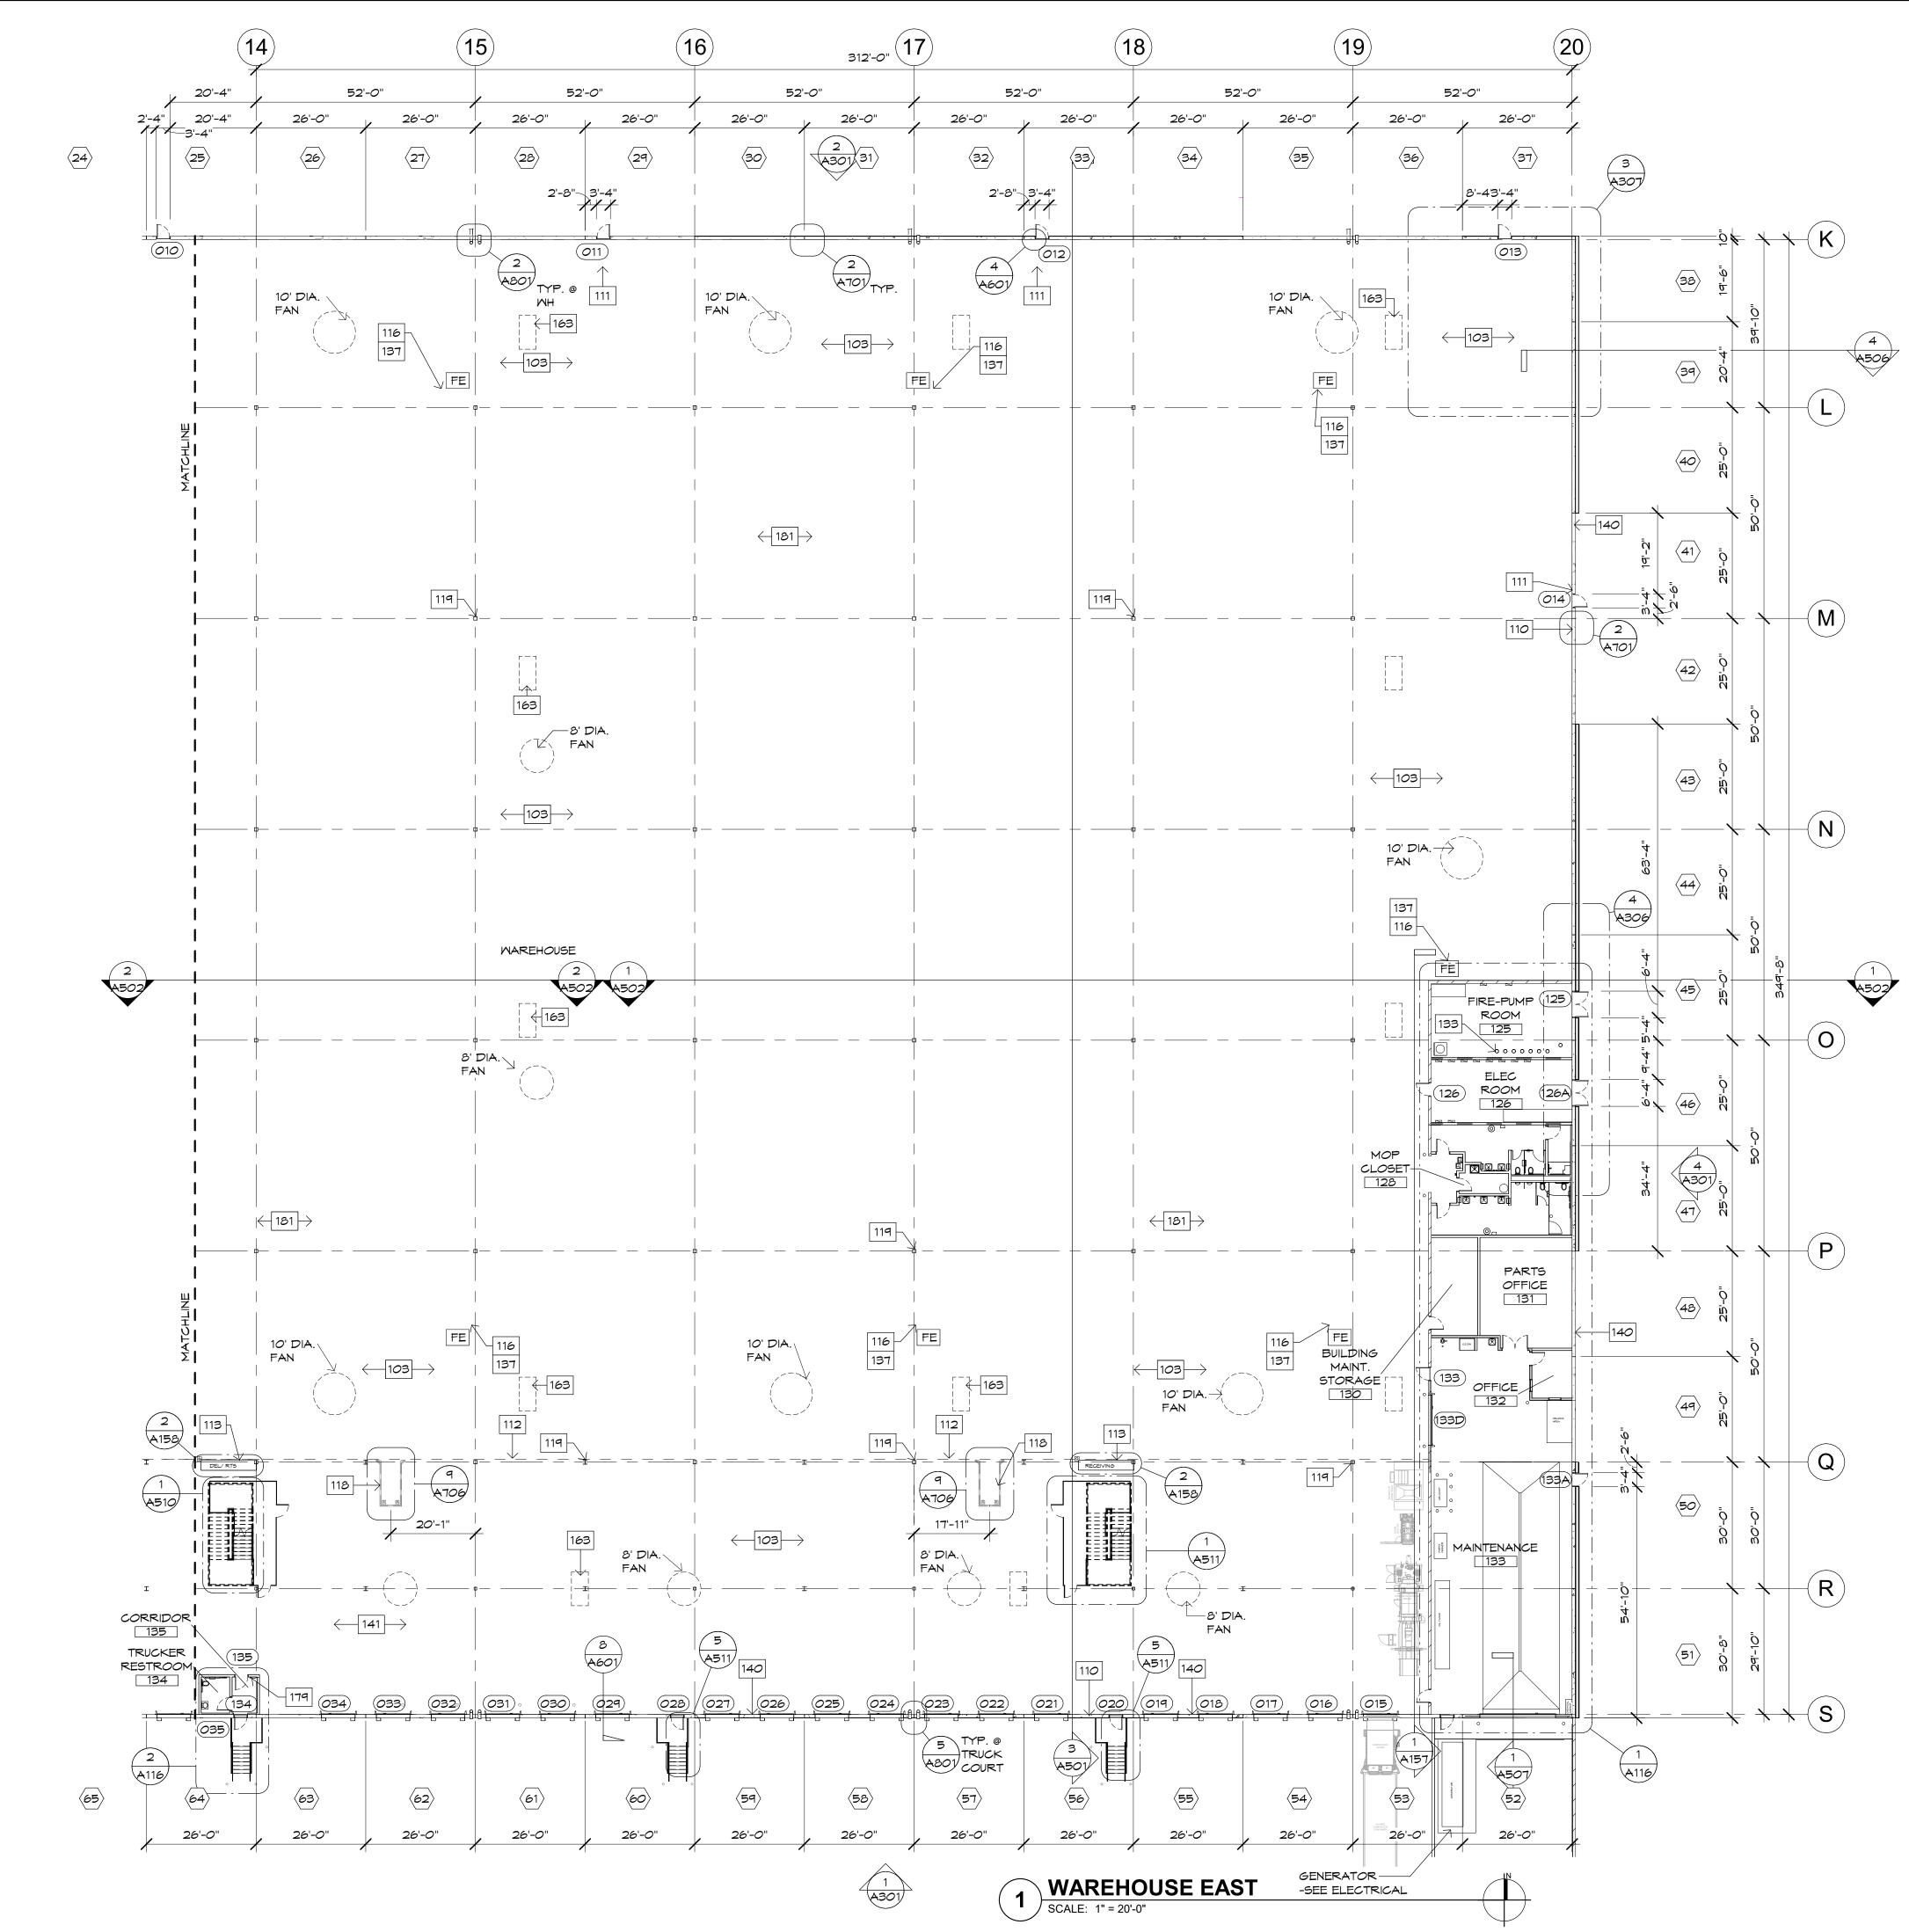


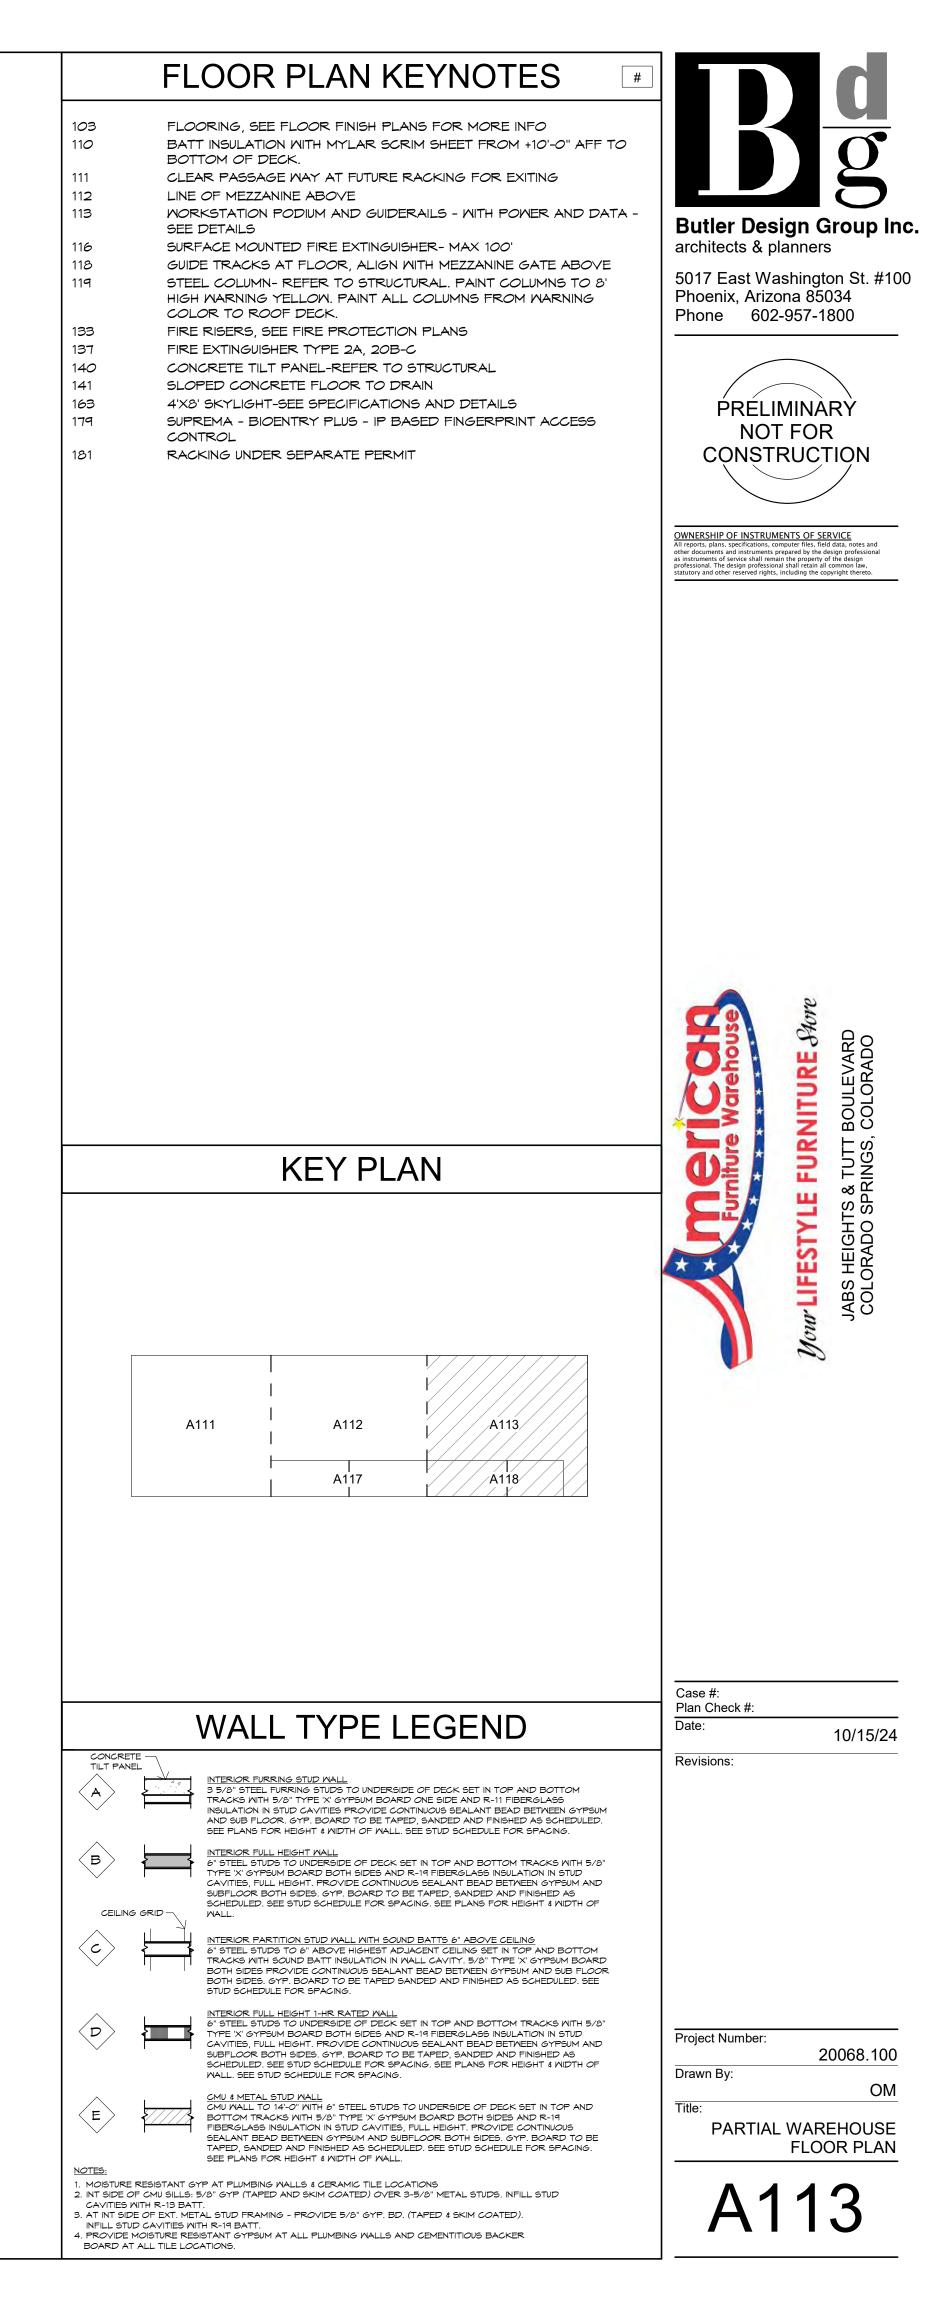

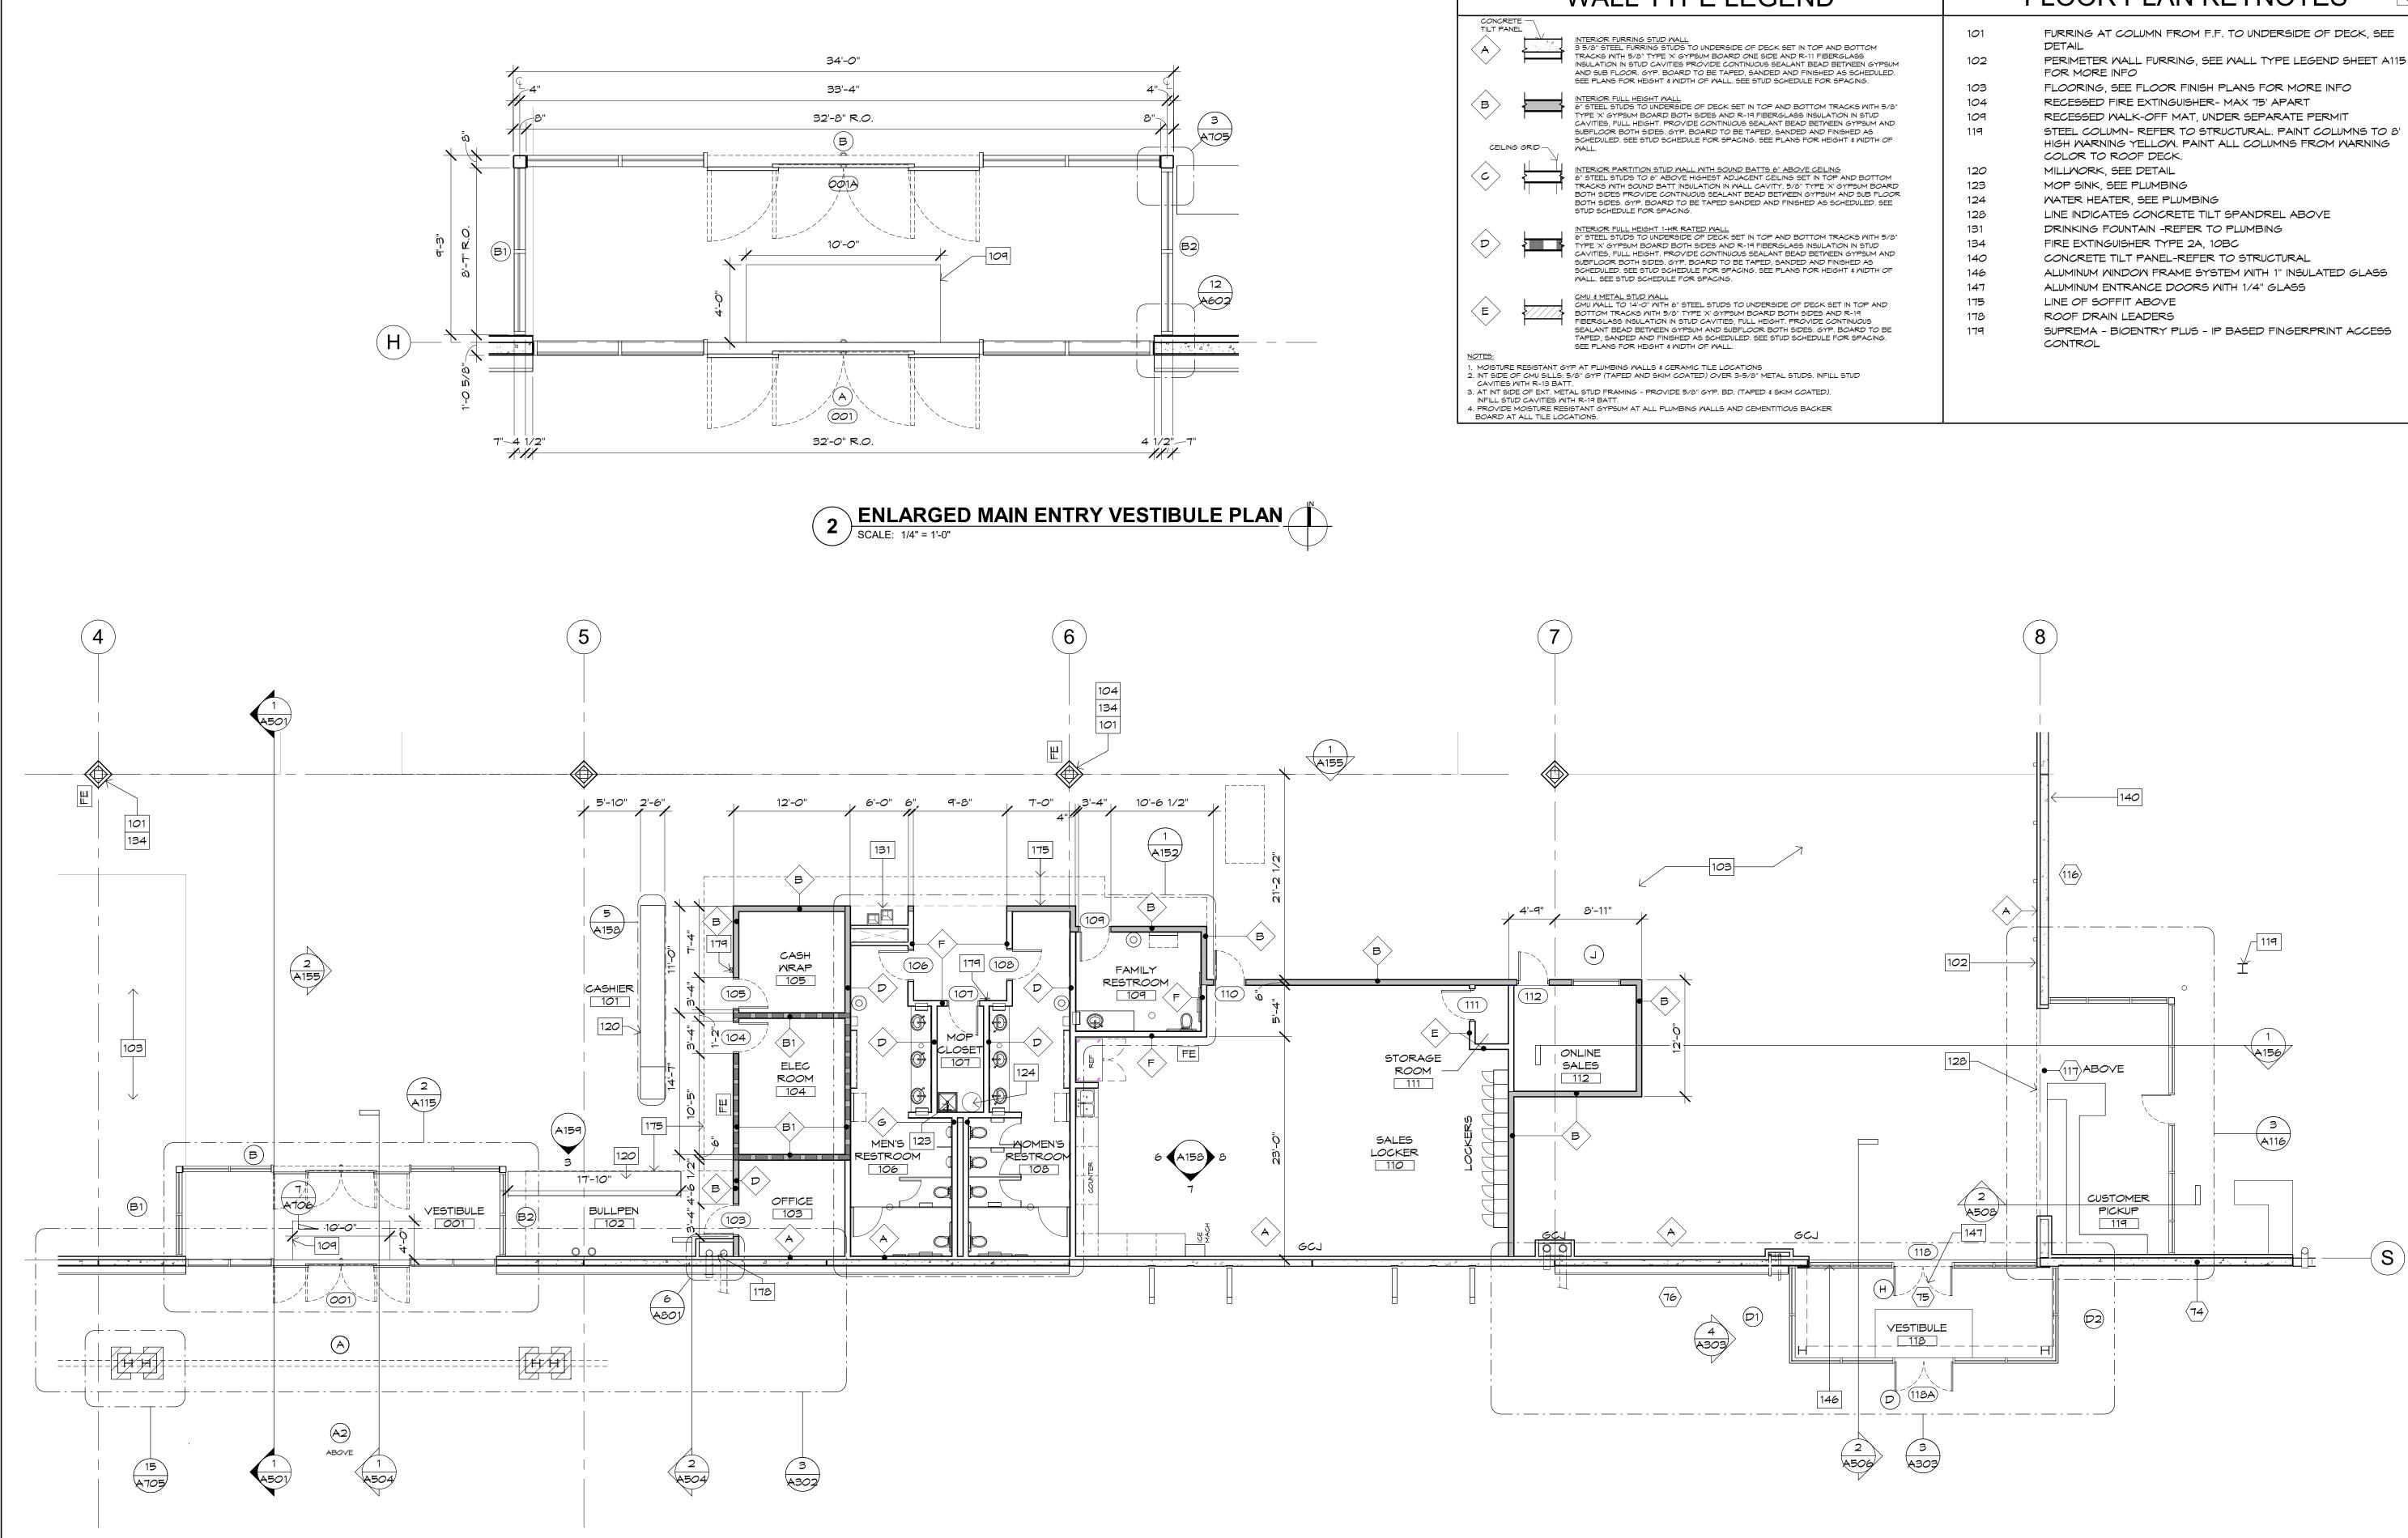

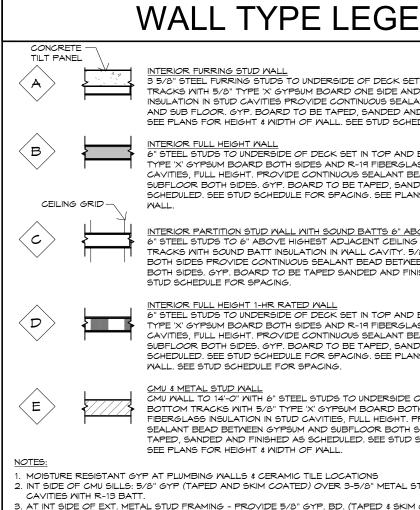


	FLOOR PLAN KEYNOTES	
102 103 104 109	FURRING AT COLUMN FROM F.F. TO UNDERSIDE OF DECK, SEE DETAIL PERIMETER WALL FURRING, SEE WALL TYPE LEGEND SHEET A115 FOR MORE INFO FLOORING, SEE FLOOR FINISH PLANS FOR MORE INFO RECESSED FIRE EXTINGUISHER- MAX 75' APART RECESSED WALK-OFF MAT, UNDER SEPARATE PERMIT STEEL COLUMN- REFER TO STRUCTURAL PAINT COLUMNS TO 8'	Butler Design Group Inc.
-	HIGH WARNING YELLOW. PAINT ALL COLUMNS FROM WARNING COLOR TO ROOF DECK.	architects & planners 5017 East Washington St. #100
123 124	MILLWORK, SEE DETAIL MOP SINK, SEE PLUMBING WATER HEATER, SEE PLUMBING LINE INDICATES CONCRETE TILT SPANDREL ABOVE	Phoenix, Arizona 85034 Phone 602-957-1800
131 134 140	DRINKING FOUNTAIN -REFER TO PLUMBING FIRE EXTINGUISHER TYPE 2A, 10BC CONCRETE TILT PANEL-REFER TO STRUCTURAL ALUMINUM WINDOW FRAME SYSTEM WITH 1" INSULATED GLASS	PRELIMINARY
175 178	ALUMINUM ENTRANCE DOORS WITH 1/4" GLASS LINE OF SOFFIT ABOVE ROOF DRAIN LEADERS SUPREMA - BIOENTRY PLUS - IP BASED FINGERPRINT ACCESS CONTROL	NOT FOR CONSTRUCTION
		OWNERSHIP OF INSTRUMENTS OF SERVICE All reports, plans, specifications, computer files, field data, notes and other documents and instruments prepared by the design professional as instruments of service shall remain the property of the design professional. The design professional shall retain all common law, statutory and other reserved rights, including the copyright thereto.
	101 102 103 104 109 119 120 123 124 128 131 134 140 146 147 175 178 179	DETAIL102PERIMETER WALL FURRING, SEE WALL TYPE LEGEND SHEET A115 FOR MORE INFO103FLOORING, SEE FLOOR FINISH PLANS FOR MORE INFO104RECESSED FIRE EXTINGUISHER- MAX 75' APART109RECESSED WALK-OFF MAT, UNDER SEPARATE PERMIT119STEEL COLUMN- REFER TO STRUCTURAL. PAINT COLUMNS TO 8' HIGH WARNING YELLOW. PAINT ALL COLUMNS FROM WARNING COLOR TO ROOF DECK.120MILLWORK, SEE DETAIL123MOP SINK, SEE PLUMBING124WATER HEATER, SEE PLUMBING125LINE INDICATES CONCRETE TILT SPANDREL ABOVE131DRINKING FOUNTAIN -REFER TO PLUMBING134FIRE EXTINGUISHER TYPE 2A, 10BC140CONCRETE TILT PANEL-REFER TO STRUCTURAL146ALUMINUM WINDOW FRAME SYSTEM WITH 1" INSULATED GLASS147ALUMINUM ENTRANCE DOORS WITH 1/4" GLASS175LINE OF SOFFIT ABOVE178ROOF DRAIN LEADERS

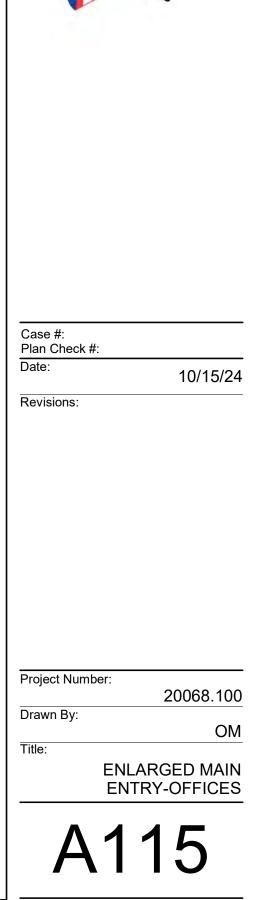






BOULEVAF COLORAD TUTT RINGS, *Vour*LIFESTYLE F JABS HEIGHTS & <sup>-</sup> COLORADO SPRI \_∞ K

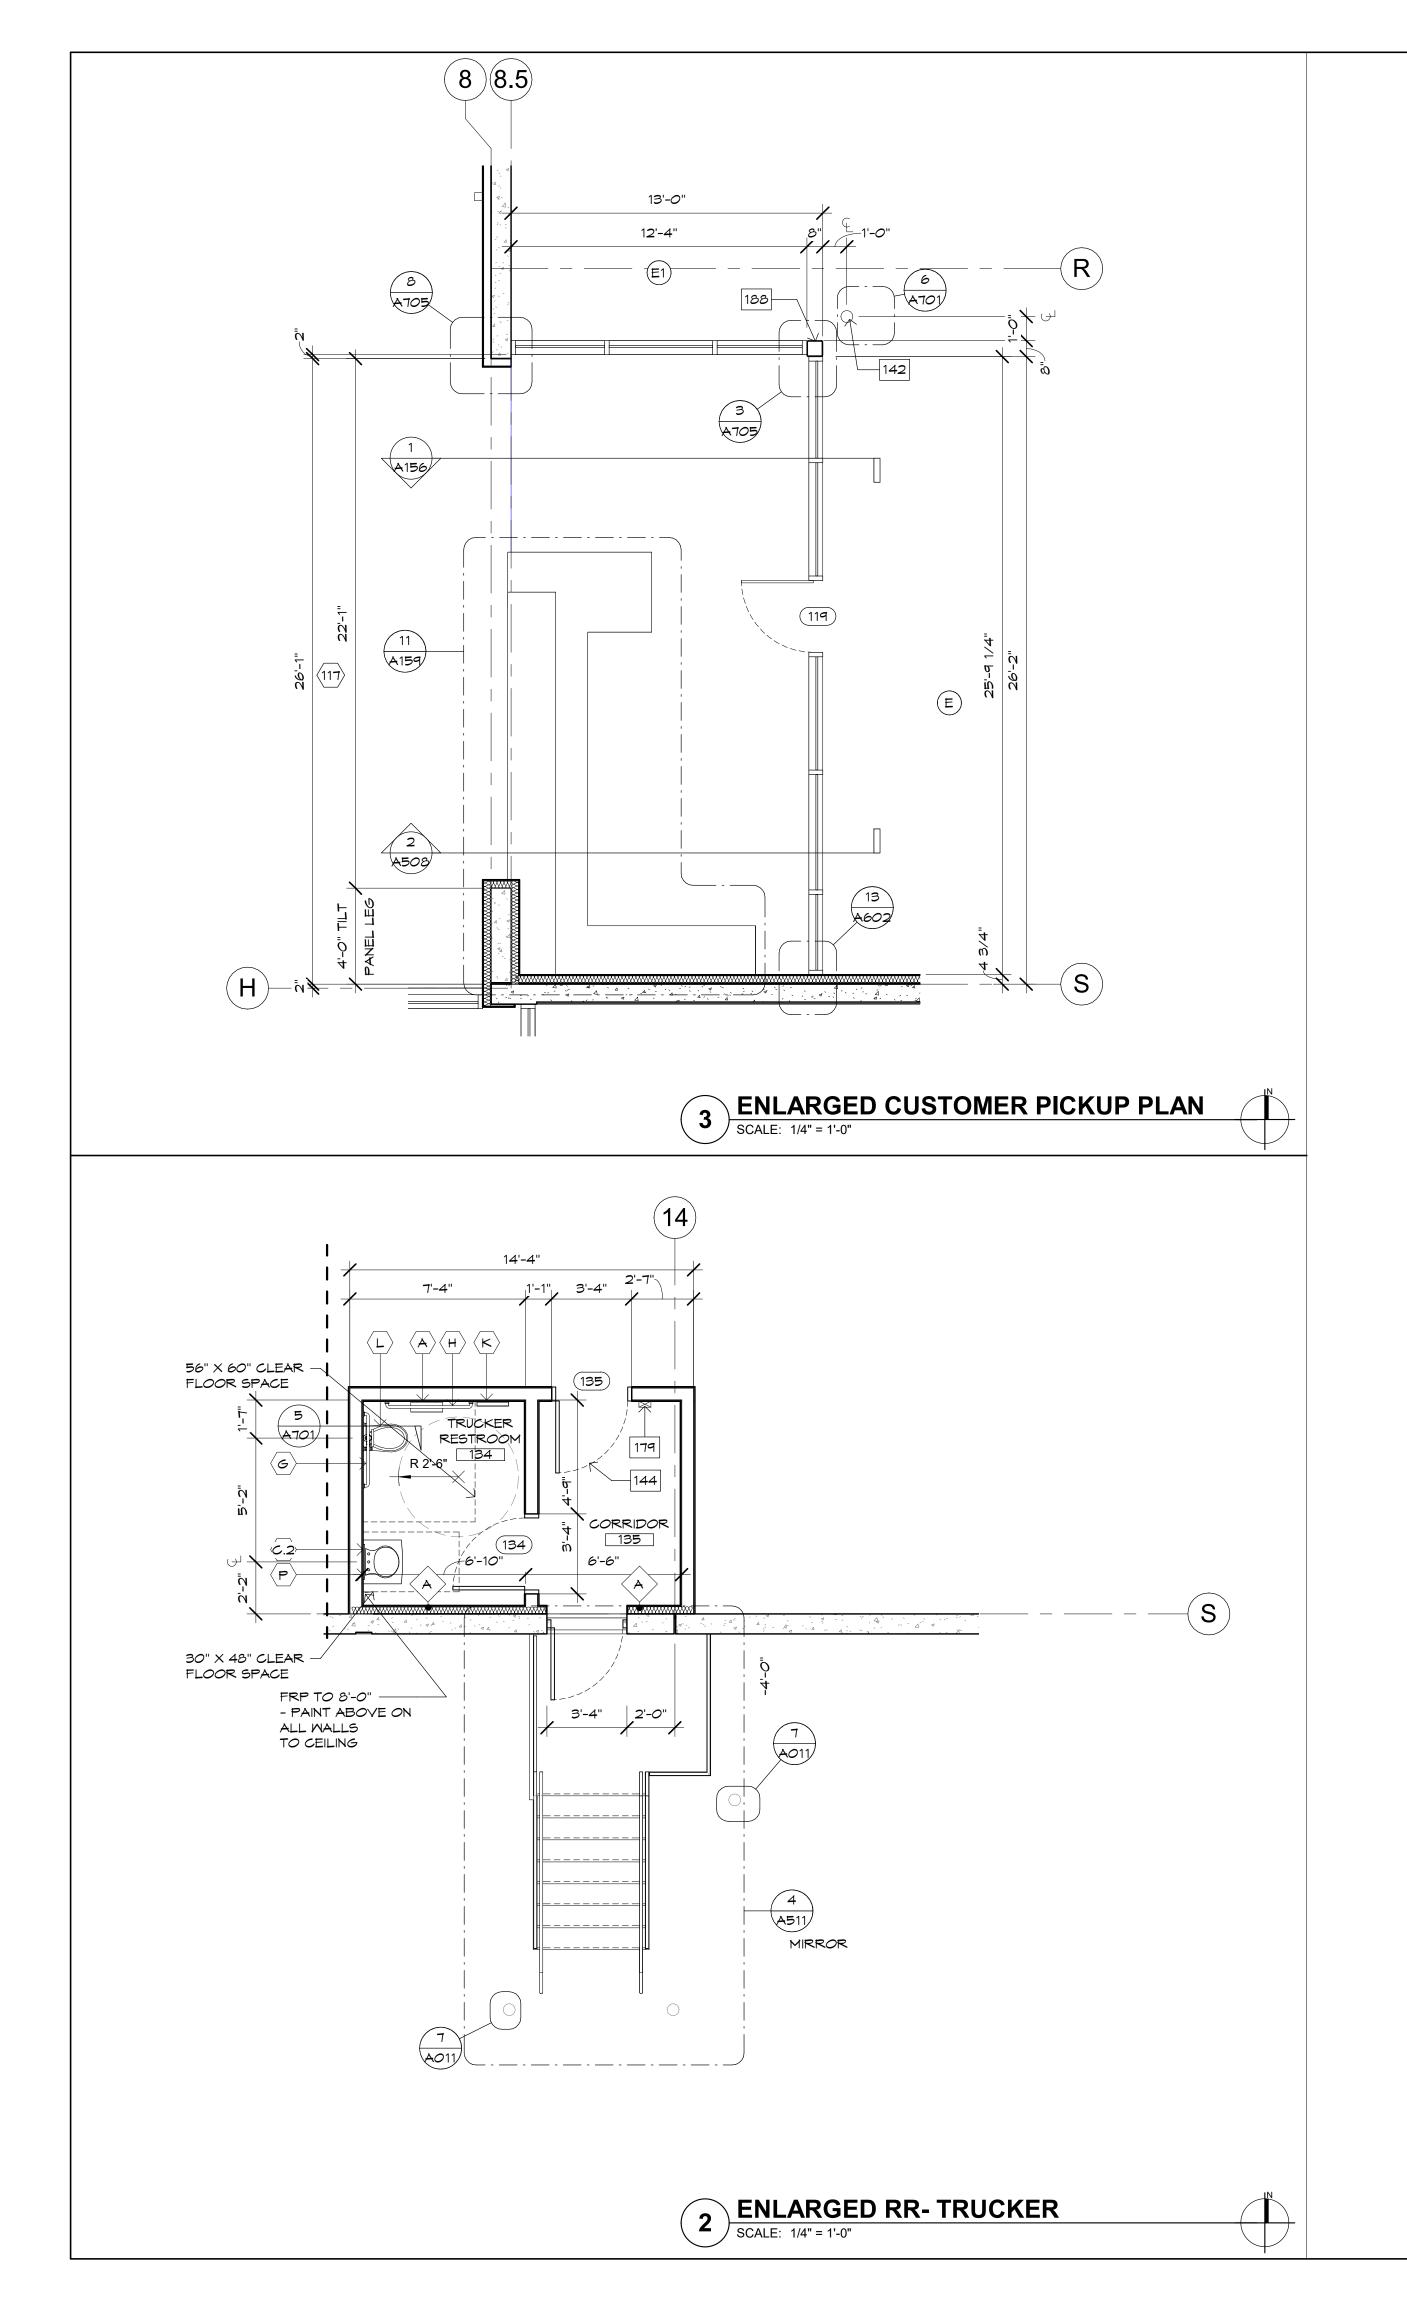



1 HR

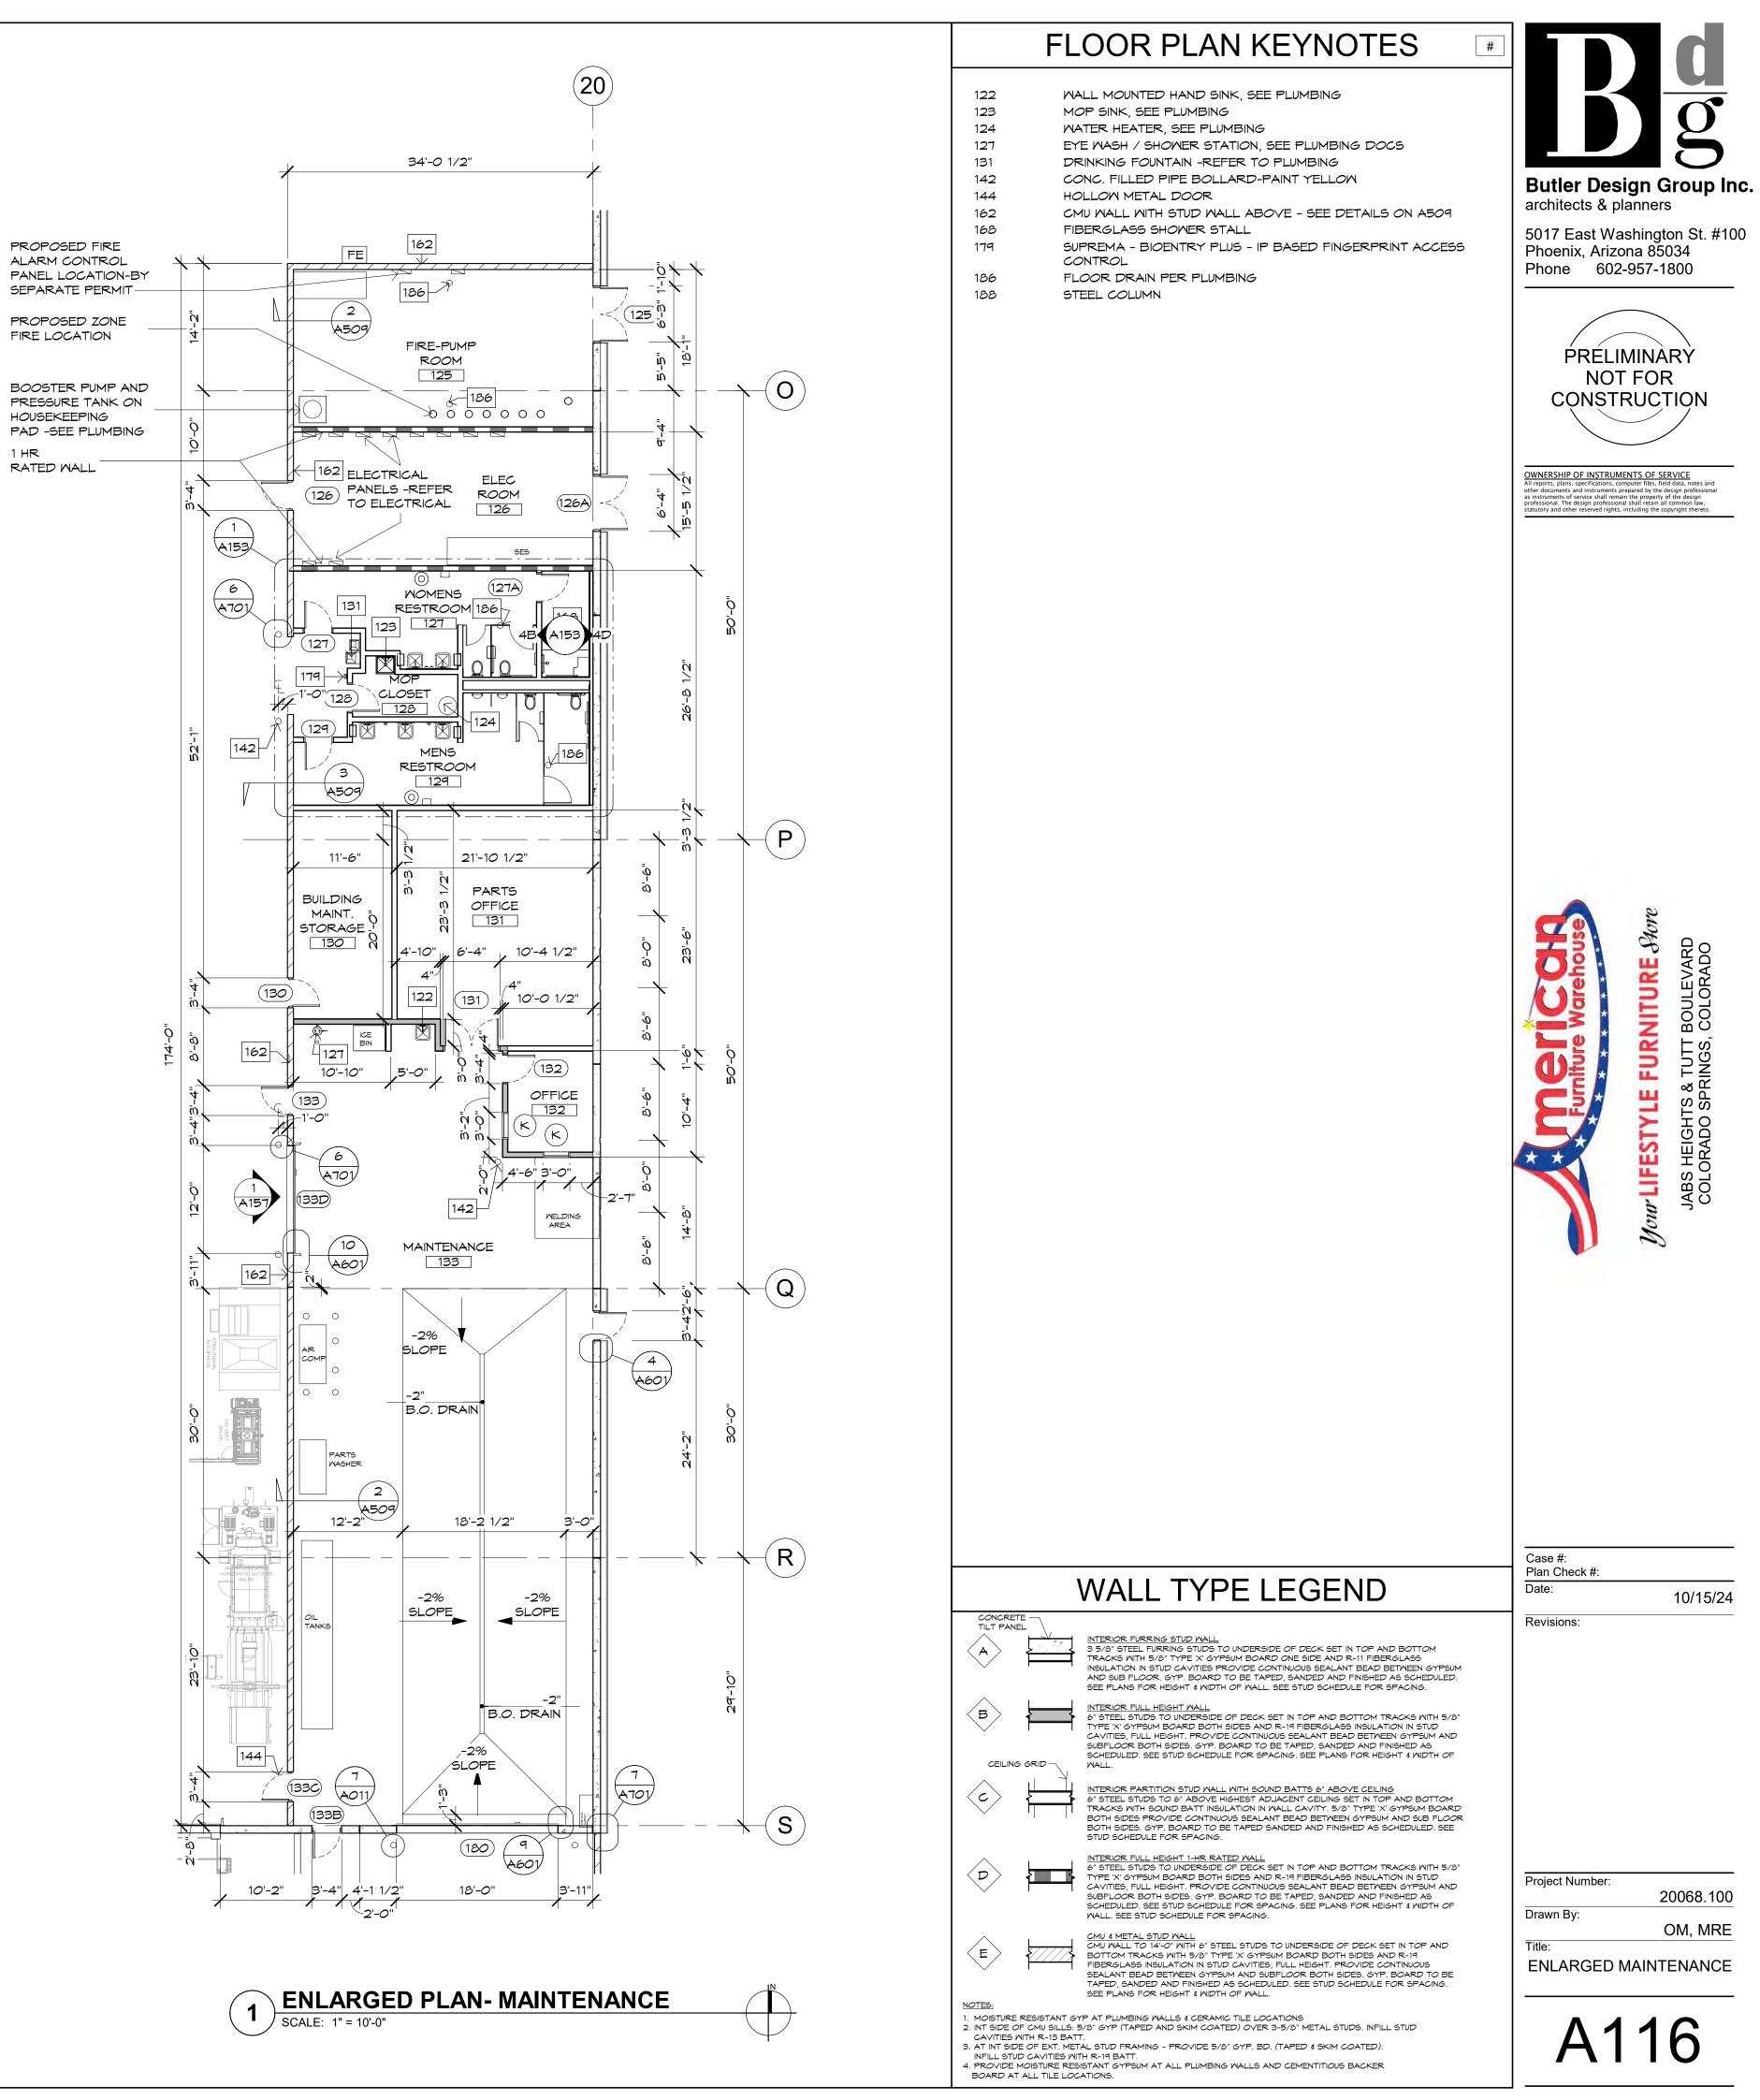

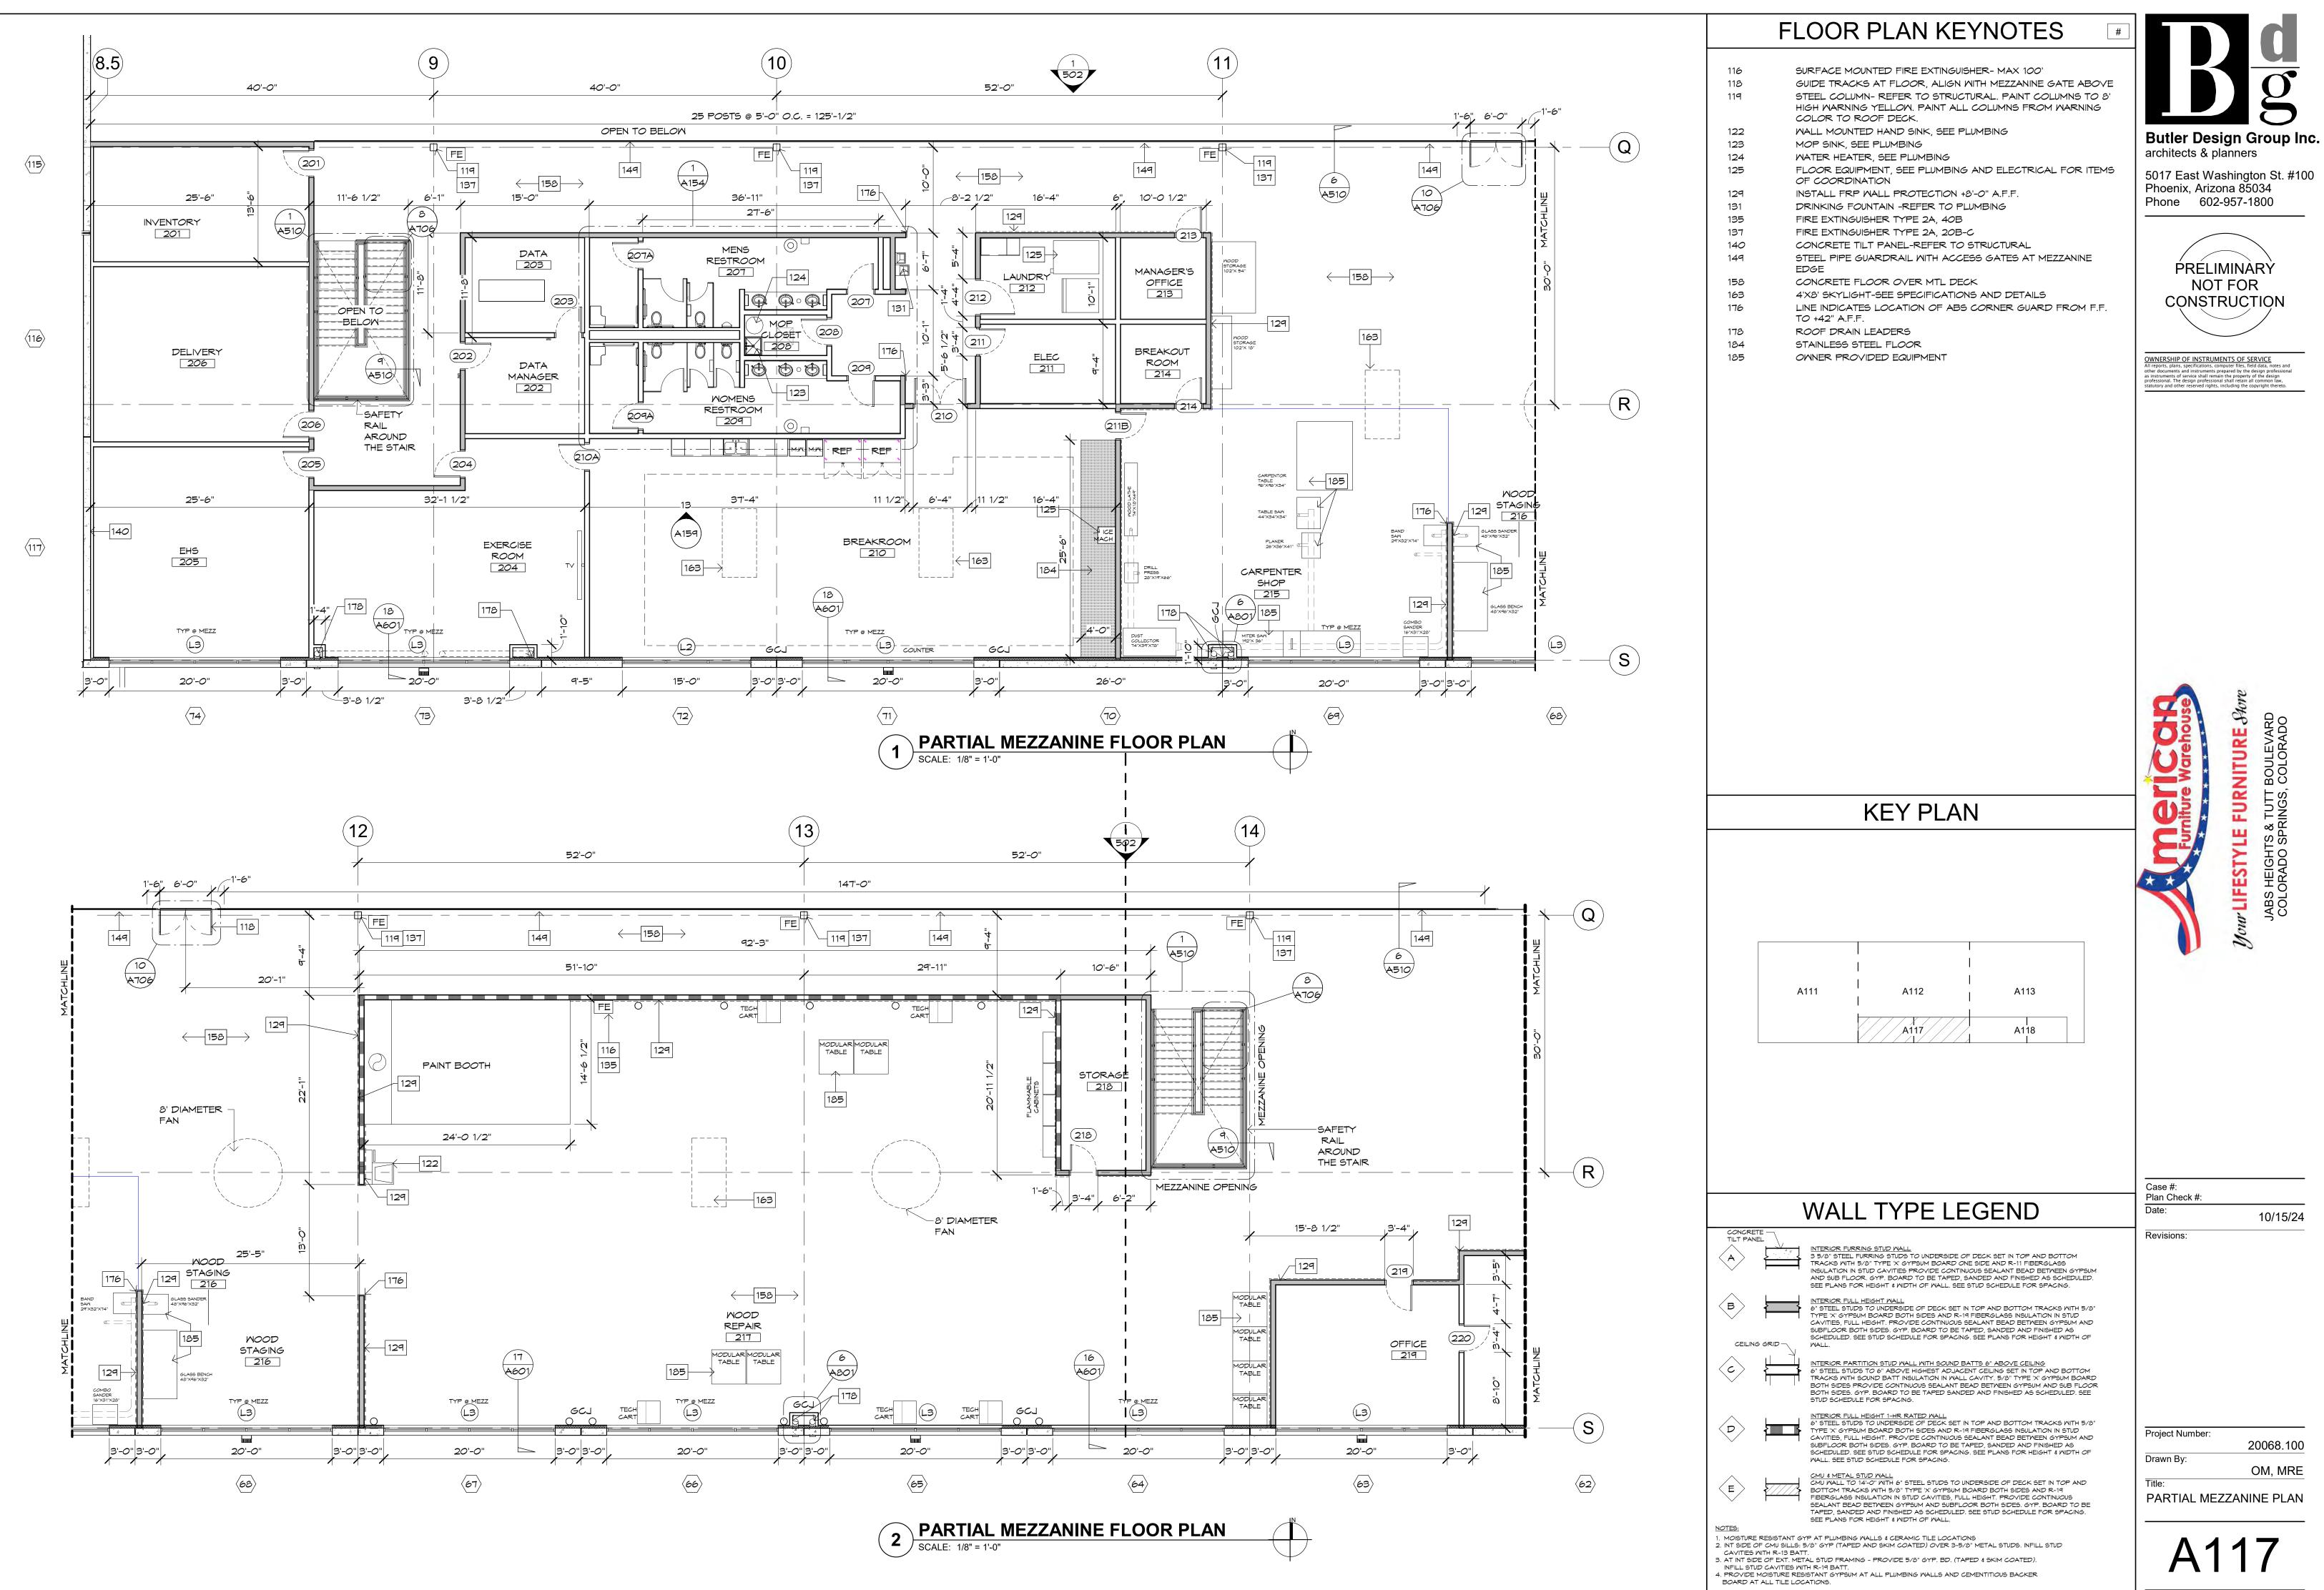


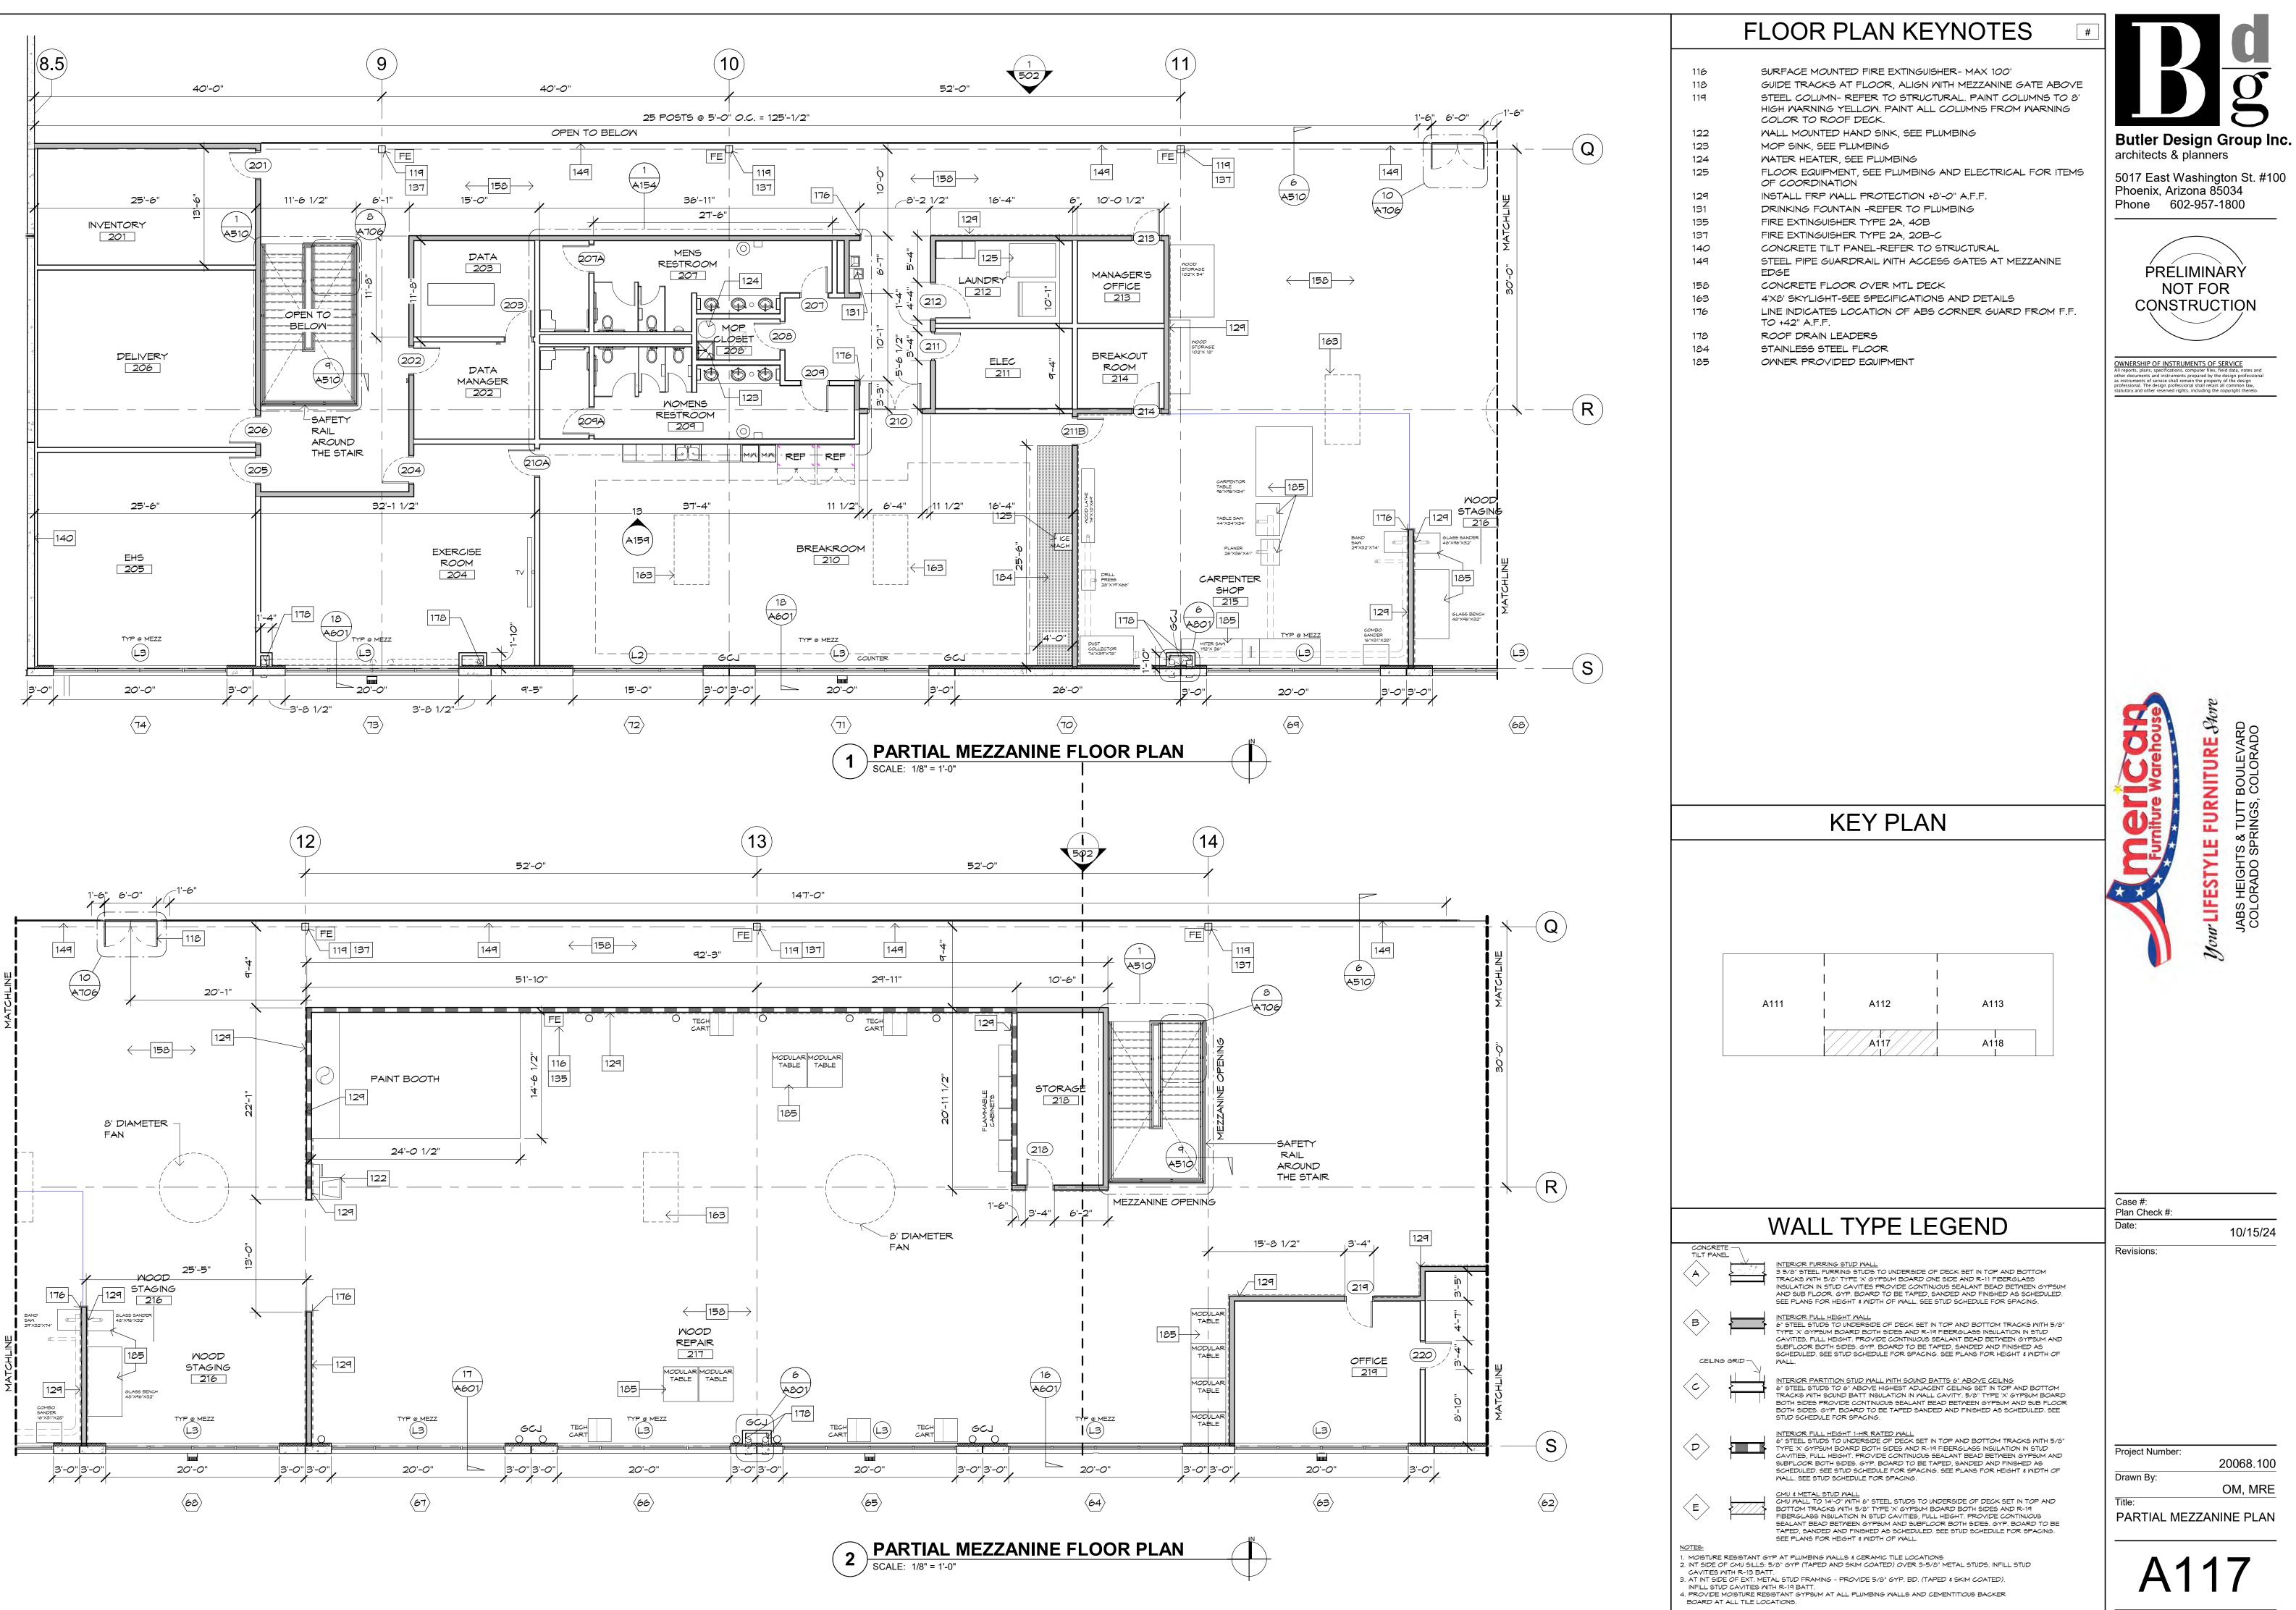


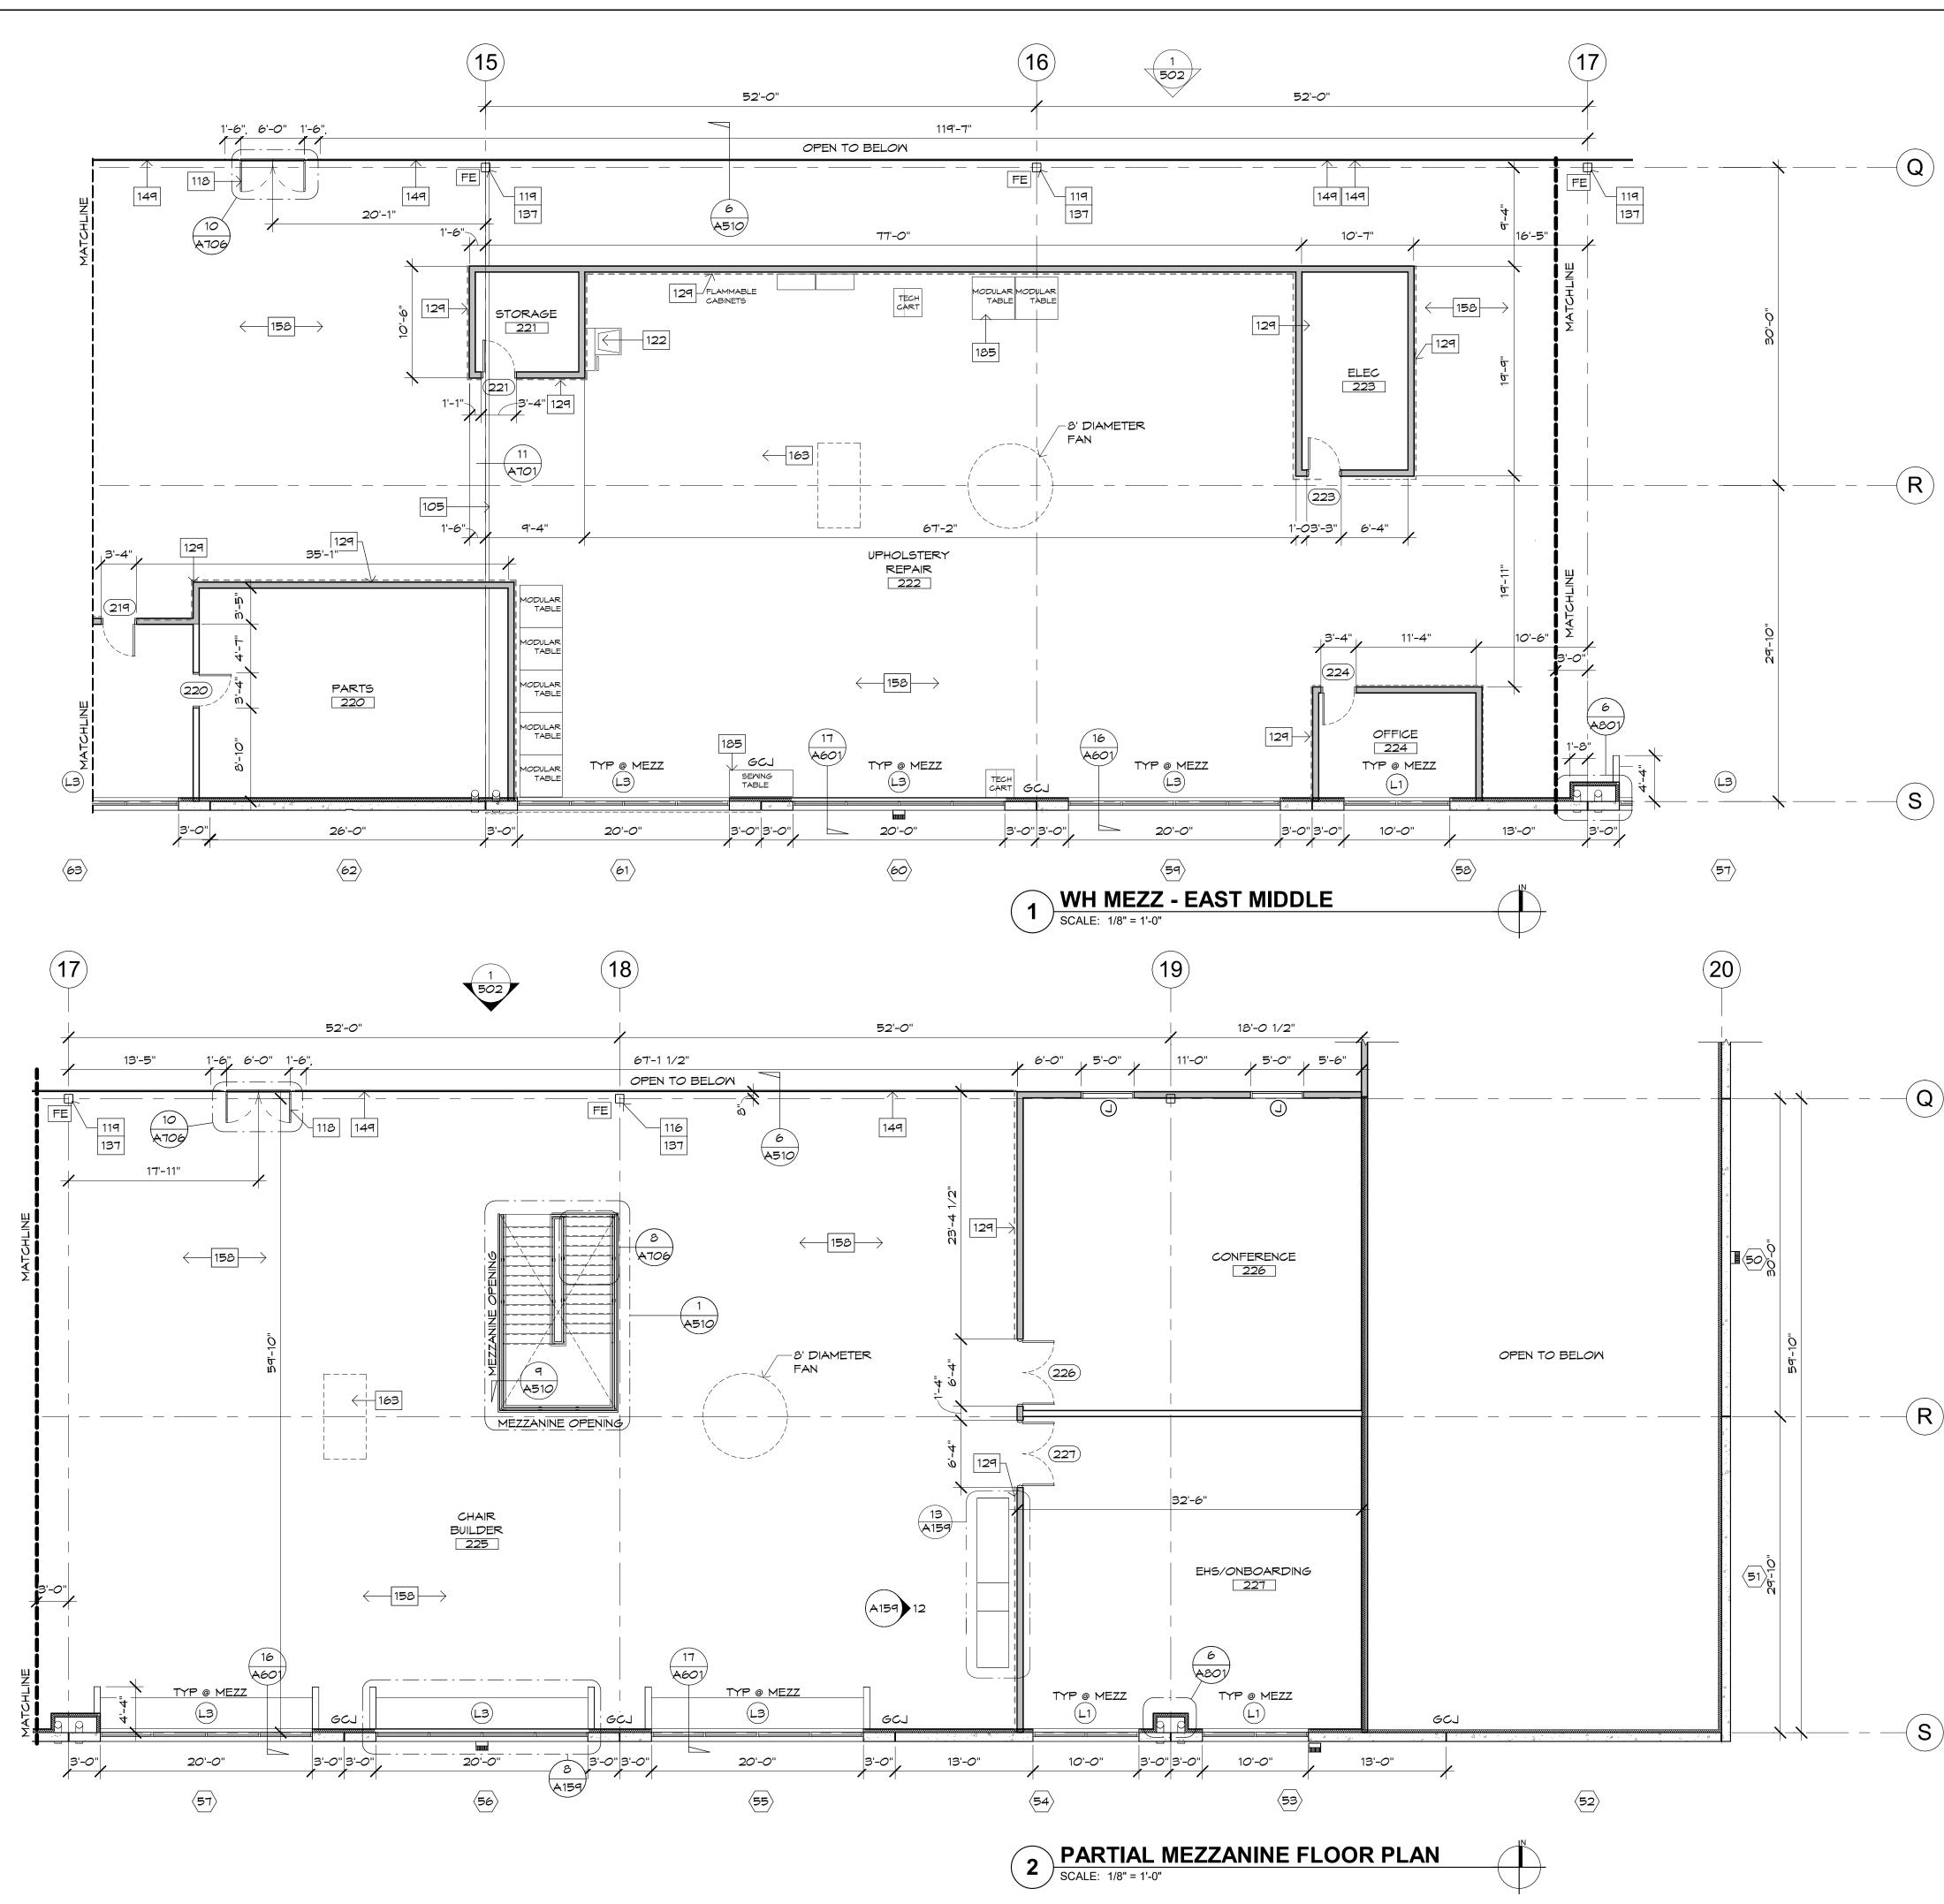


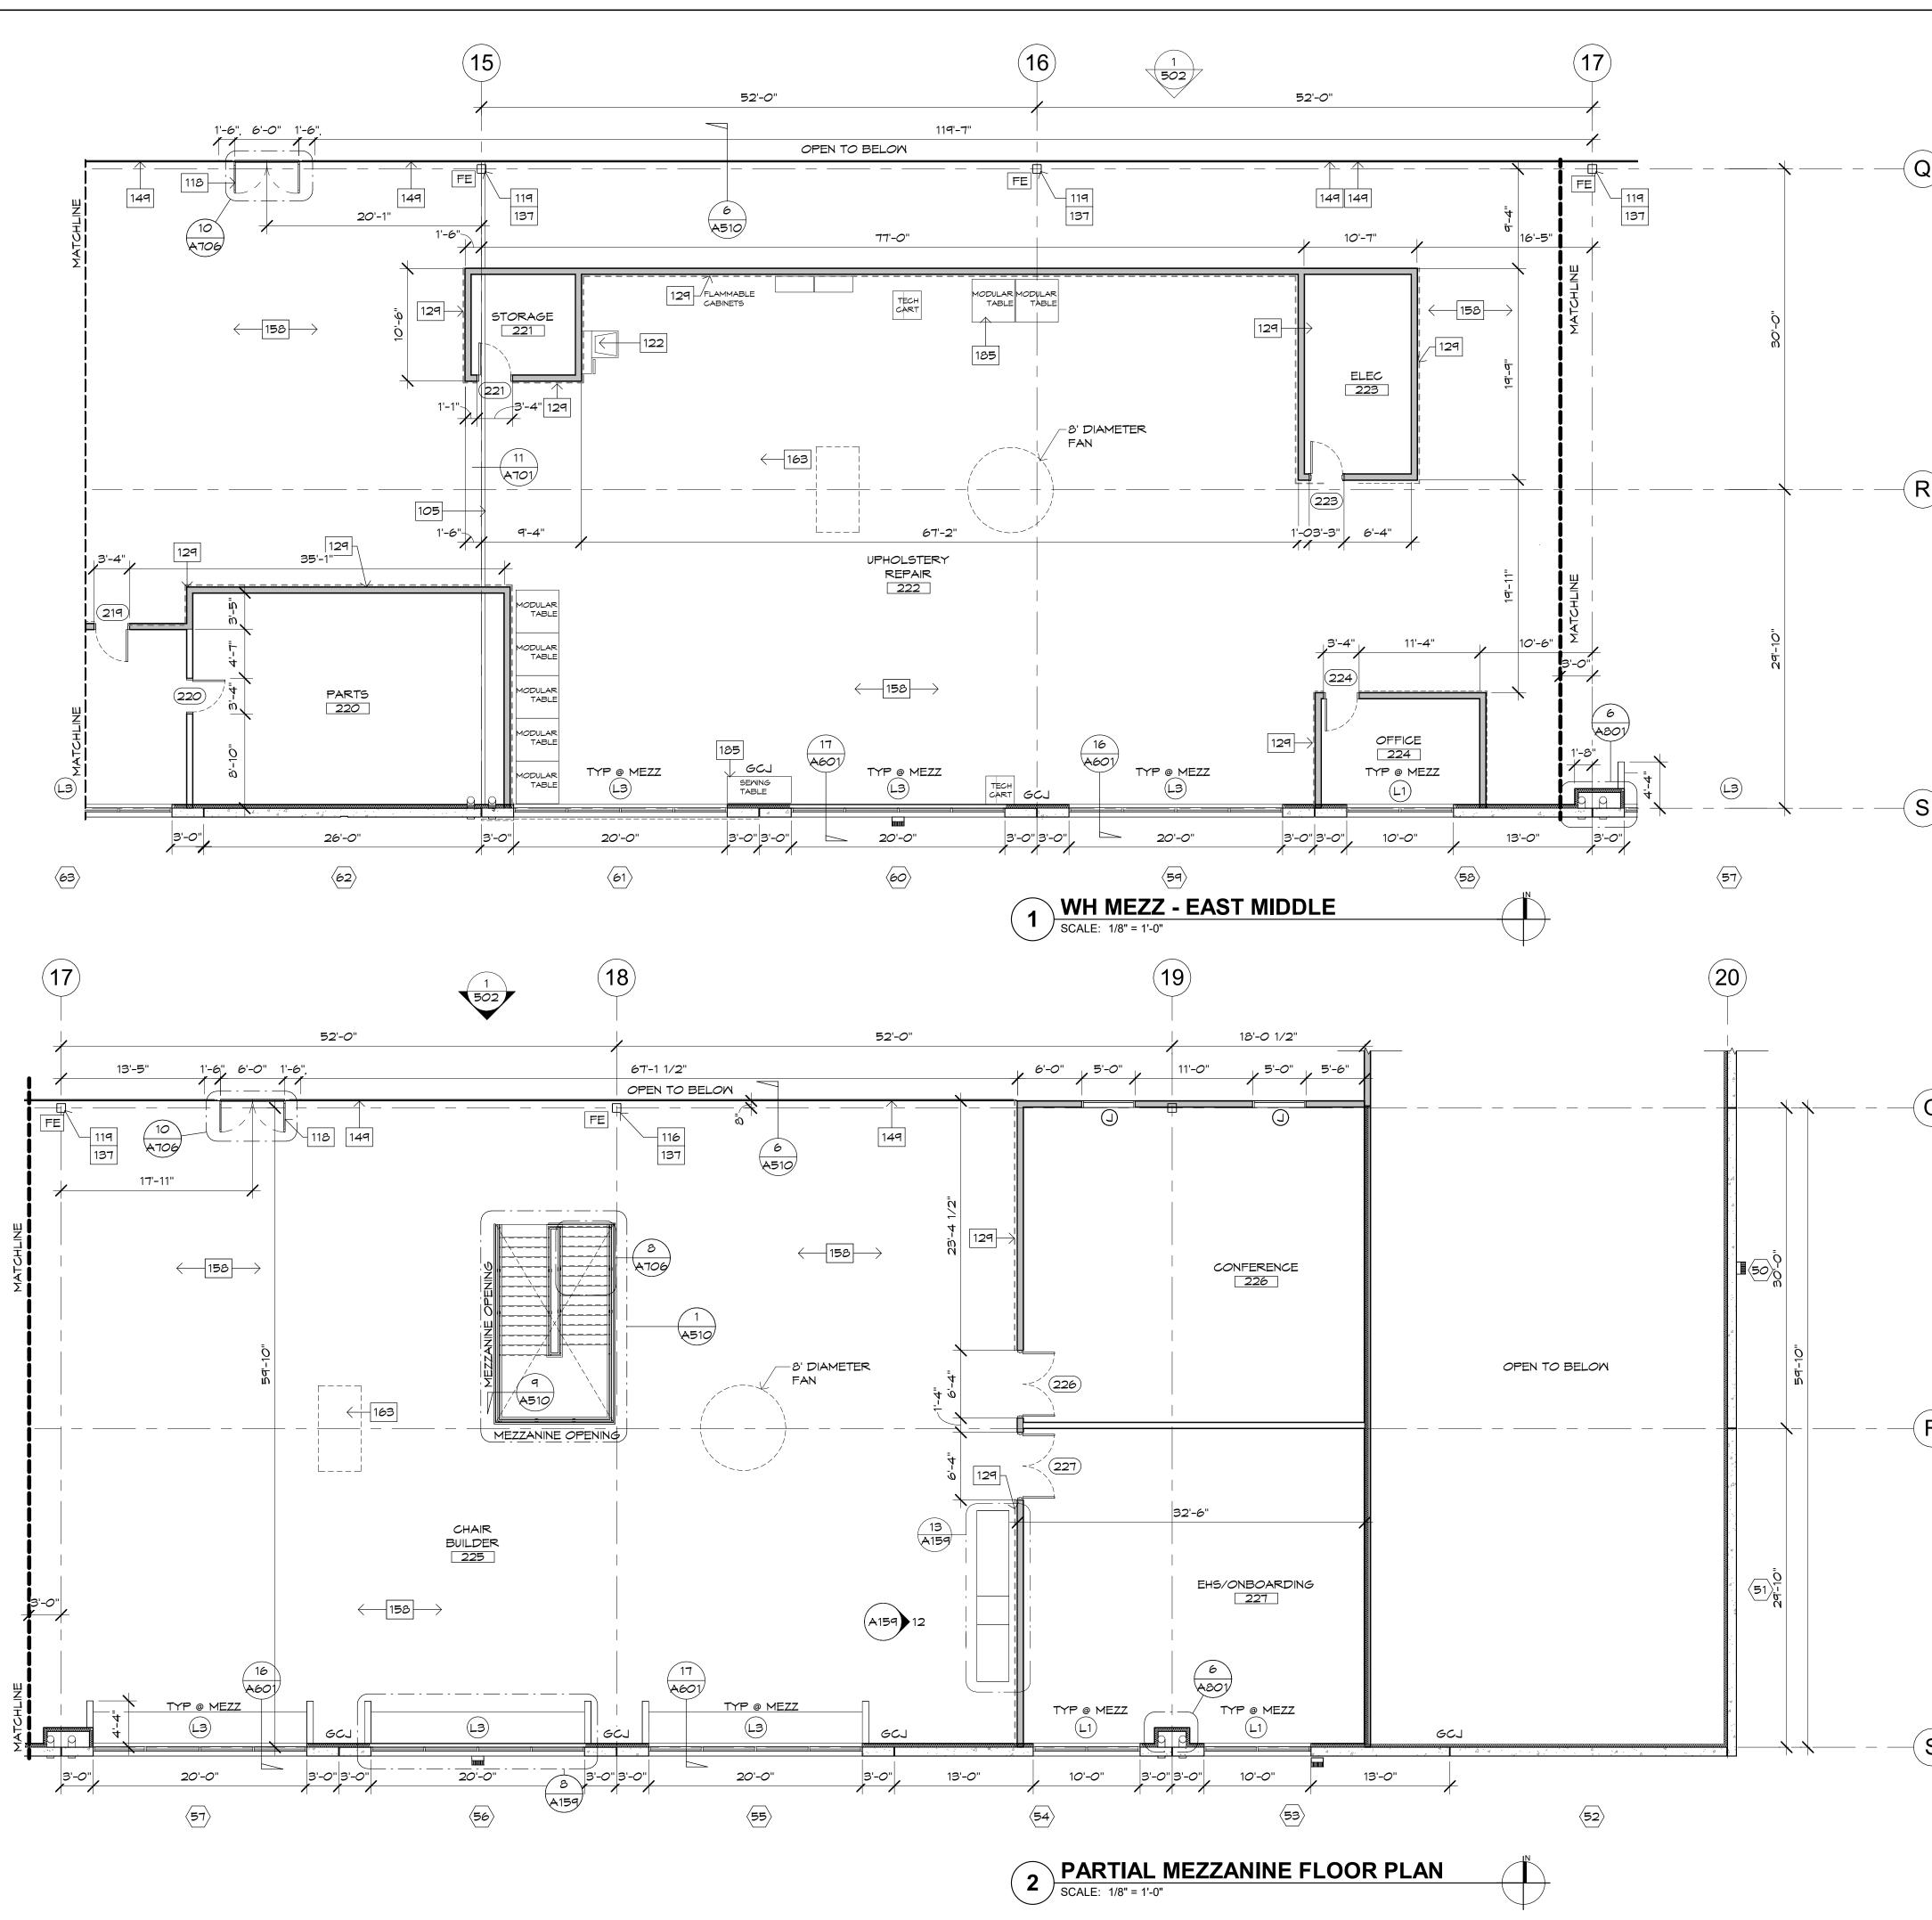


FLOOR PLAN KEYNOTES 105 EXPANSION JOINT - SEE DETAIL - SEE STRUCTURAL g SURFACE MOUNTED FIRE EXTINGUISHER- MAX 100' 116 GUIDE TRACKS AT FLOOR, ALIGN WITH MEZZANINE GATE ABOVE 118 119 STEEL COLUMN- REFER TO STRUCTURAL. PAINT COLUMNS TO 8' HIGH WARNING YELLOW. PAINT ALL COLUMNS FROM WARNING COLOR TO ROOF DECK. Butler Design Group Inc. 122 WALL MOUNTED HAND SINK, SEE PLUMBING architects & planners 129 INSTALL FRP WALL PROTECTION +8'-0" A.F.F. 137 FIRE EXTINGUISHER TYPE 2A, 20B-C 5017 East Washington St. #100 149 STEEL PIPE GUARDRAIL WITH ACCESS GATES AT MEZZANINE Phoenix, Arizona 85034 EDGE Phone 602-957-1800 158 CONCRETE FLOOR OVER MTL DECK 163 4'X8' SKYLIGHT-SEE SPECIFICATIONS AND DETAILS 185 OWNER PROVIDED EQUIPMENT PRÉLIMINARY NOT FOR CONSTRUCTION OWNERSHIP OF INSTRUMENTS OF SERVICE All reports, plans, specifications, computer files, field data, notes ar other documents and instruments prepared by the design profession as instruments of service shall remain the property of the design professional. The design professional shall retain all common law, statutory and other reserved rights, including the copyright thereto. FURNITURE & COLORAD & TUTT RINGS, D.≧ **KEY PLAN** *<i>v*LIFESTYLE പ്പെ JABS HEIGHT COLORADO 5 De A111 A113 A114 A113 A111 A112 A112 A117 Á118 Case #: Plan Check #: WALL TYPE LEGEND Date: 10/15/24 CONCRETE -TILT PANEL Revisions: INTERIOR FURRING STUD WALL 3 5/8" STEEL FURRING STUDS TO UNDERSIDE OF DECK SET IN TOP AND BOTTOM TRACKS WITH 5/8" TYPE 'X' GYPSUM BOARD ONE SIDE AND R-11 FIBERGLASS INSULATION IN STUD CAVITIES PROVIDE CONTINUOUS SEALANT BEAD BETWEEN GYPSUM AND SUB FLOOR. GYP. BOARD TO BE TAPED, SANDED AND FINISHED AS SCHEDULED. SEE DATE FOR UNITED TO AND TO BE TAPED, SANDED AND FINISHED AS SCHEDULED. (A)<u>}\_\_</u> SEE PLANS FOR HEIGHT & WIDTH OF WALL. SEE STUD SCHEDULE FOR SPACING. INTERIOR FULL HEIGHT WALL 6" STEEL STUDS TO UNDERSIDE OF DECK SET IN TOP AND BOTTOM TRACKS WITH 5/8" TYPE 'X' GYPSUM BOARD BOTH SIDES AND R-19 FIBERGLASS INSULATION IN STUD  $\langle \mathsf{B} \rangle$ CAVITIES, FULL HEIGHT. PROVIDE CONTINUOUS SEALANT BEAD BETWEEN GYPSUM AND SUBFLOOR BOTH SIDES. GYP. BOARD TO BE TAPED, SANDED AND FINISHED AS SCHEDULED. SEE STUD SCHEDULE FOR SPACING. SEE PLANS FOR HEIGHT & WIDTH OF CEILING GRID — MALL. INTERIOR PARTITION STUD WALL WITH SOUND BATTS 6" ABOVE CEILING 6" STEEL STUDS TO 6" ABOVE HIGHEST ADJACENT CEILING SET IN TOP AND BOTTOM TRACKS WITH SOUND BATT INSULATION IN WALL CAVITY. 5/8" TYPE 'X' GYPSUM BOARD  $\langle c \rangle$ BOTH SIDES PROVIDE CONTINUOUS SEALANT BEAD BETWEEN GYPSUM AND SUB FLOOR BOTH SIDES. GYP. BOARD TO BE TAPED SANDED AND FINISHED AS SCHEDULED. SEE STUD SCHEDULE FOR SPACING. INTERIOR FULL HEIGHT 1-HR RATED WALL 6" STEEL STUDS TO UNDERSIDE OF DECK SET IN TOP AND BOTTOM TRACKS WITH 5/8" TYPE 'X' GYPSUM BOARD BOTH SIDES AND R-19 FIBERGLASS INSULATION IN STUD Project Number: CAVITIES, FULL HEIGHT. PROVIDE CONTINUOUS SEALANT BEAD BETWEEN GYPSUM AND 20068.100 SUBFLOOR BOTH SIDES. GYP. BOARD TO BE TAPED, SANDED AND FINISHED AS SCHEDULED. SEE STUD SCHEDULE FOR SPACING. SEE PLANS FOR HEIGHT & WIDTH OF WALL. SEE STUD SCHEDULE FOR SPACING. Drawn By: OM, MRE CMU & METAL STUD WALL CMU WALL TO 14'-O" WITH 6" STEEL STUDS TO UNDERSIDE OF DECK SET IN TOP AND BOTTOM TRACKS WITH 5/8" TYPE 'X' GYPSUM BOARD BOTH SIDES AND R-19 FIBERGLASS INSULATION IN STUD CAVITIES, FULL HEIGHT. PROVIDE CONTINUOUS SEALANT BEAD BETWEEN GYPSUM AND SUBFLOOR BOTH SIDES. GYP. BOARD TO BE Title: (E)PARTIAL MEZZANINE PLAN TAPED, SANDED AND FINISHED AS SCHEDULED. SEE STUD SCHEDULE FOR SPACING. SEE PLANS FOR HEIGHT & WIDTH OF WALL. NOTES: MOISTURE RESISTANT GYP AT PLUMBING WALLS & CERAMIC TILE LOCATIONS
 INT SIDE OF CMU SILLS: 5/8" GYP (TAPED AND SKIM COATED) OVER 3-5/8" METAL STUDS. INFILL STUD CAVITIES WITH R-13 BATT.
 AT INT SIDE OF EXT. METAL STUD FRAMING - PROVIDE 5/8" GYP. BD. (TAPED & SKIM COATED). INFILL STUD CAVITIES WITH R-19 BATT.
 PROVIDE MOISTURE RESISTANT GYPSUM AT ALL PLUMBING WALLS AND CEMENTITIOUS BACKER BOARD AT AULTURE OCCUPIEN A118 BOARD AT ALL TILE LOCATIONS.

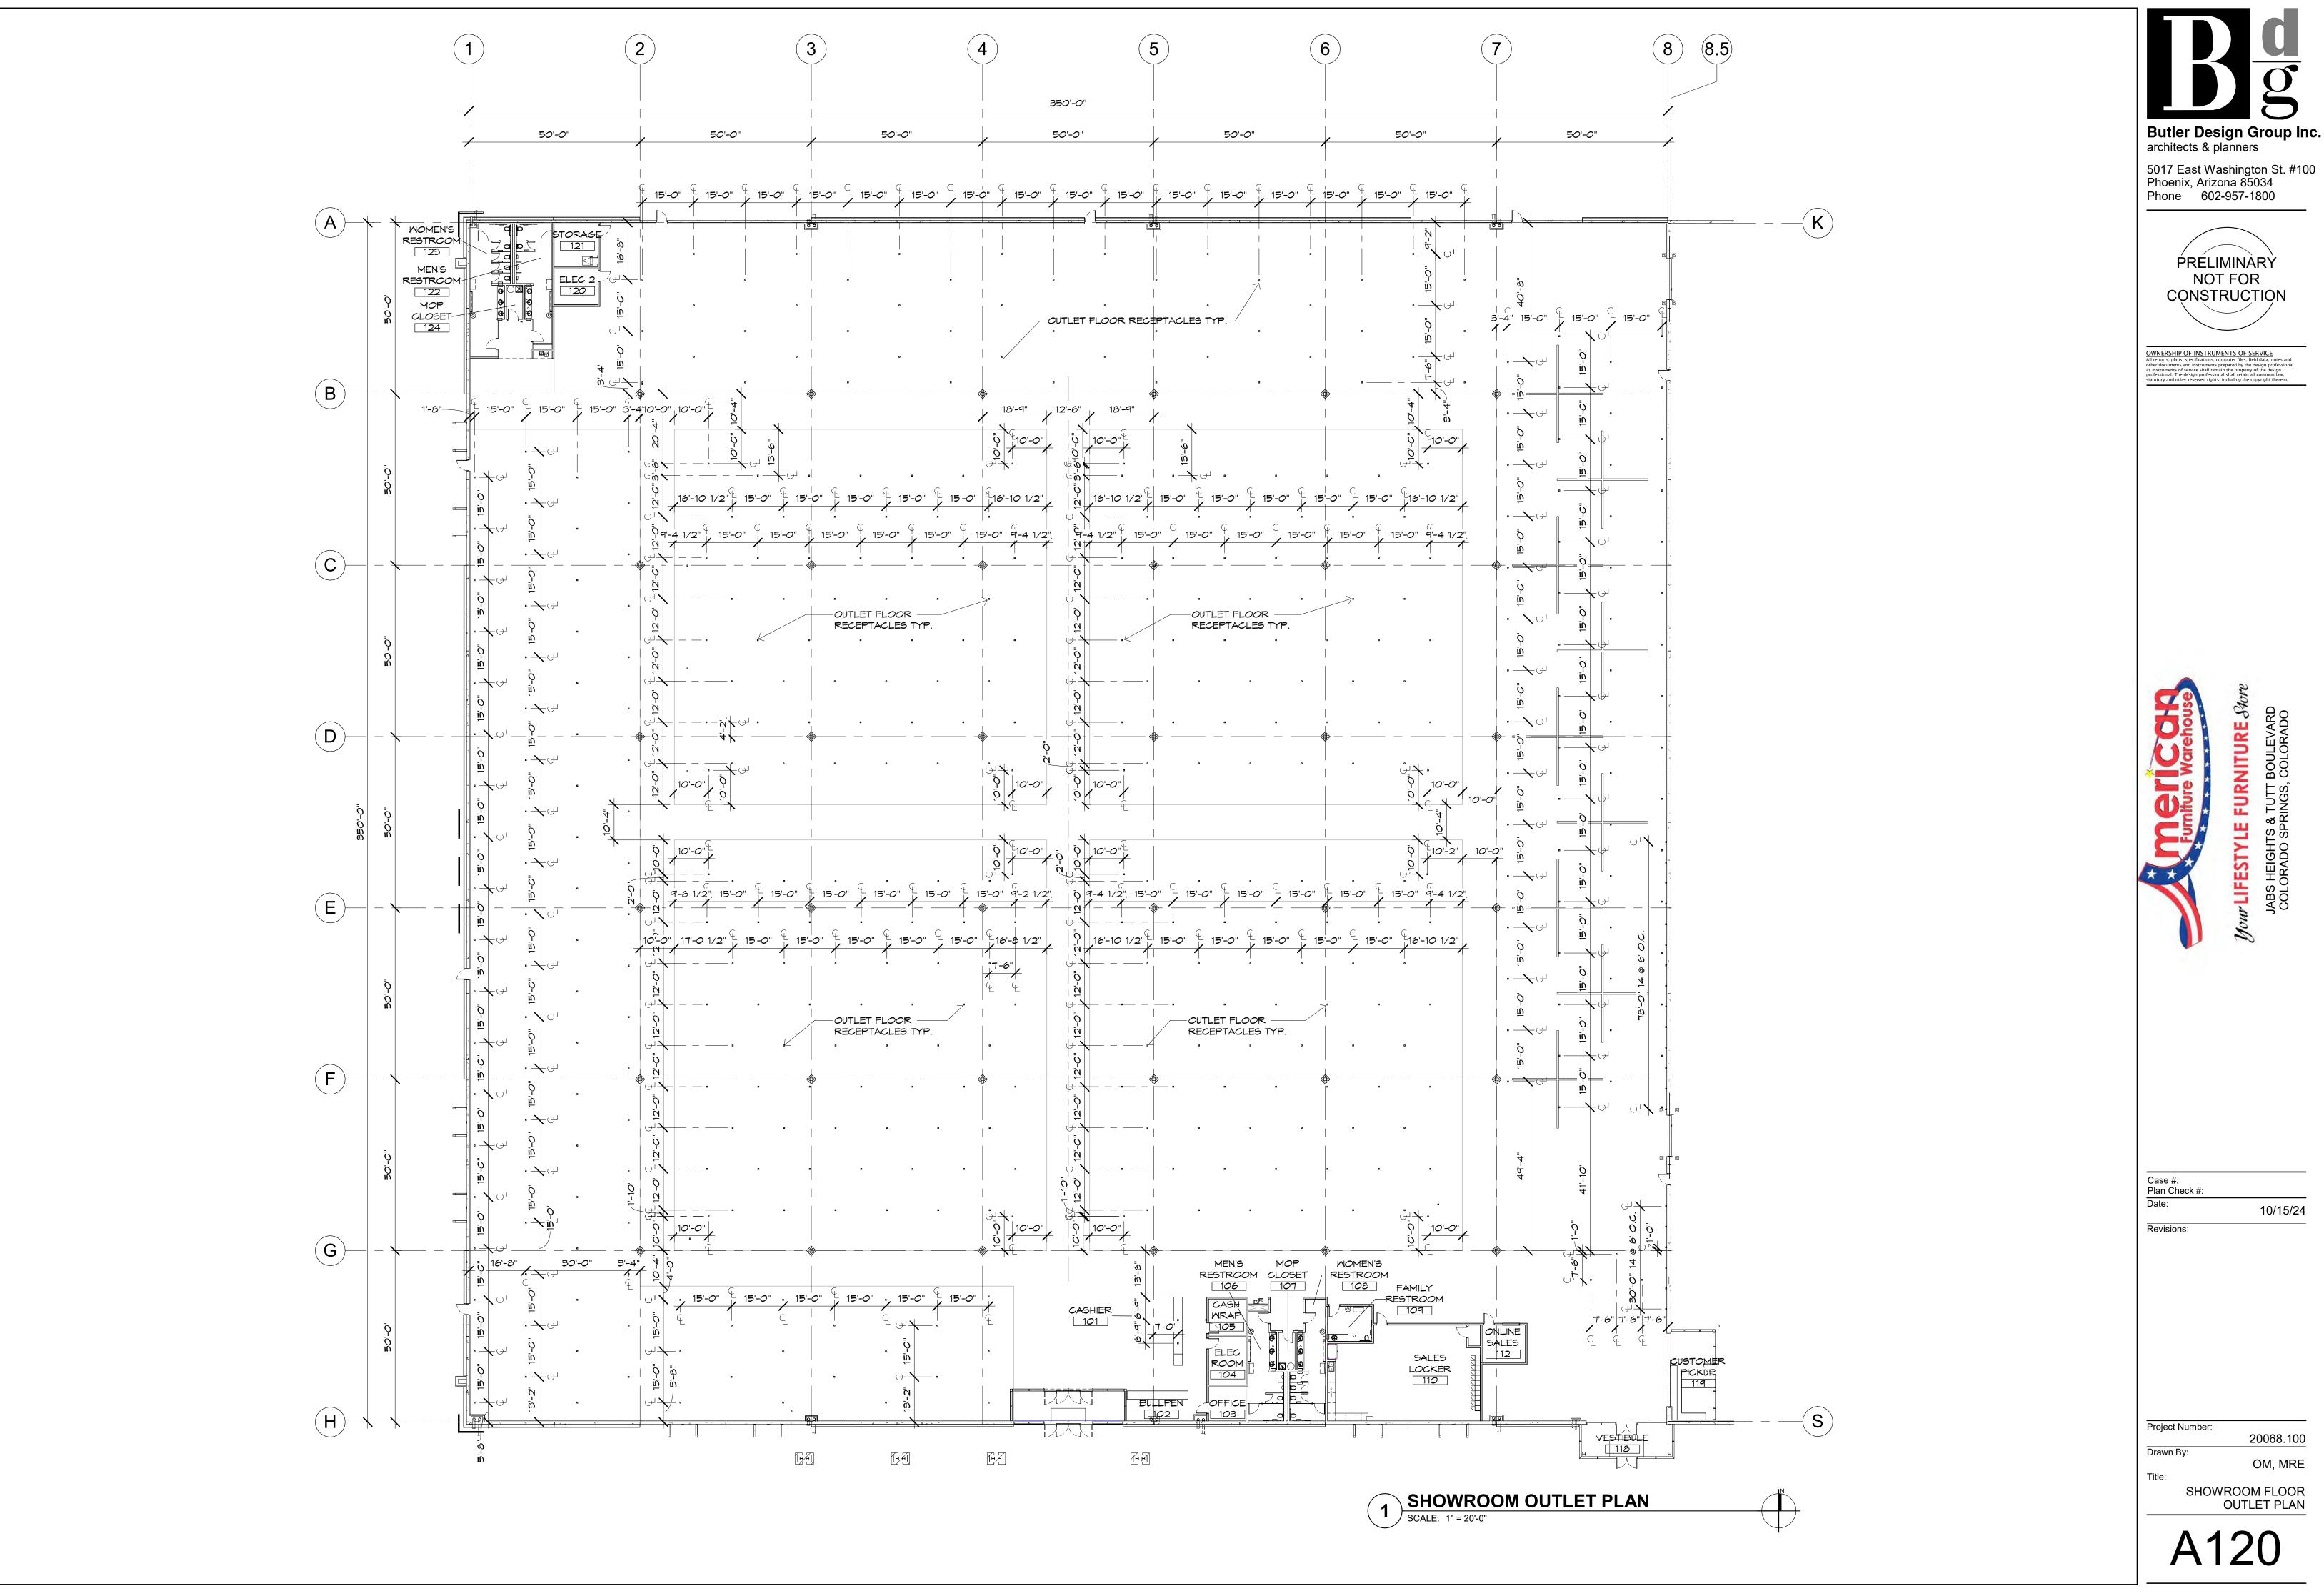


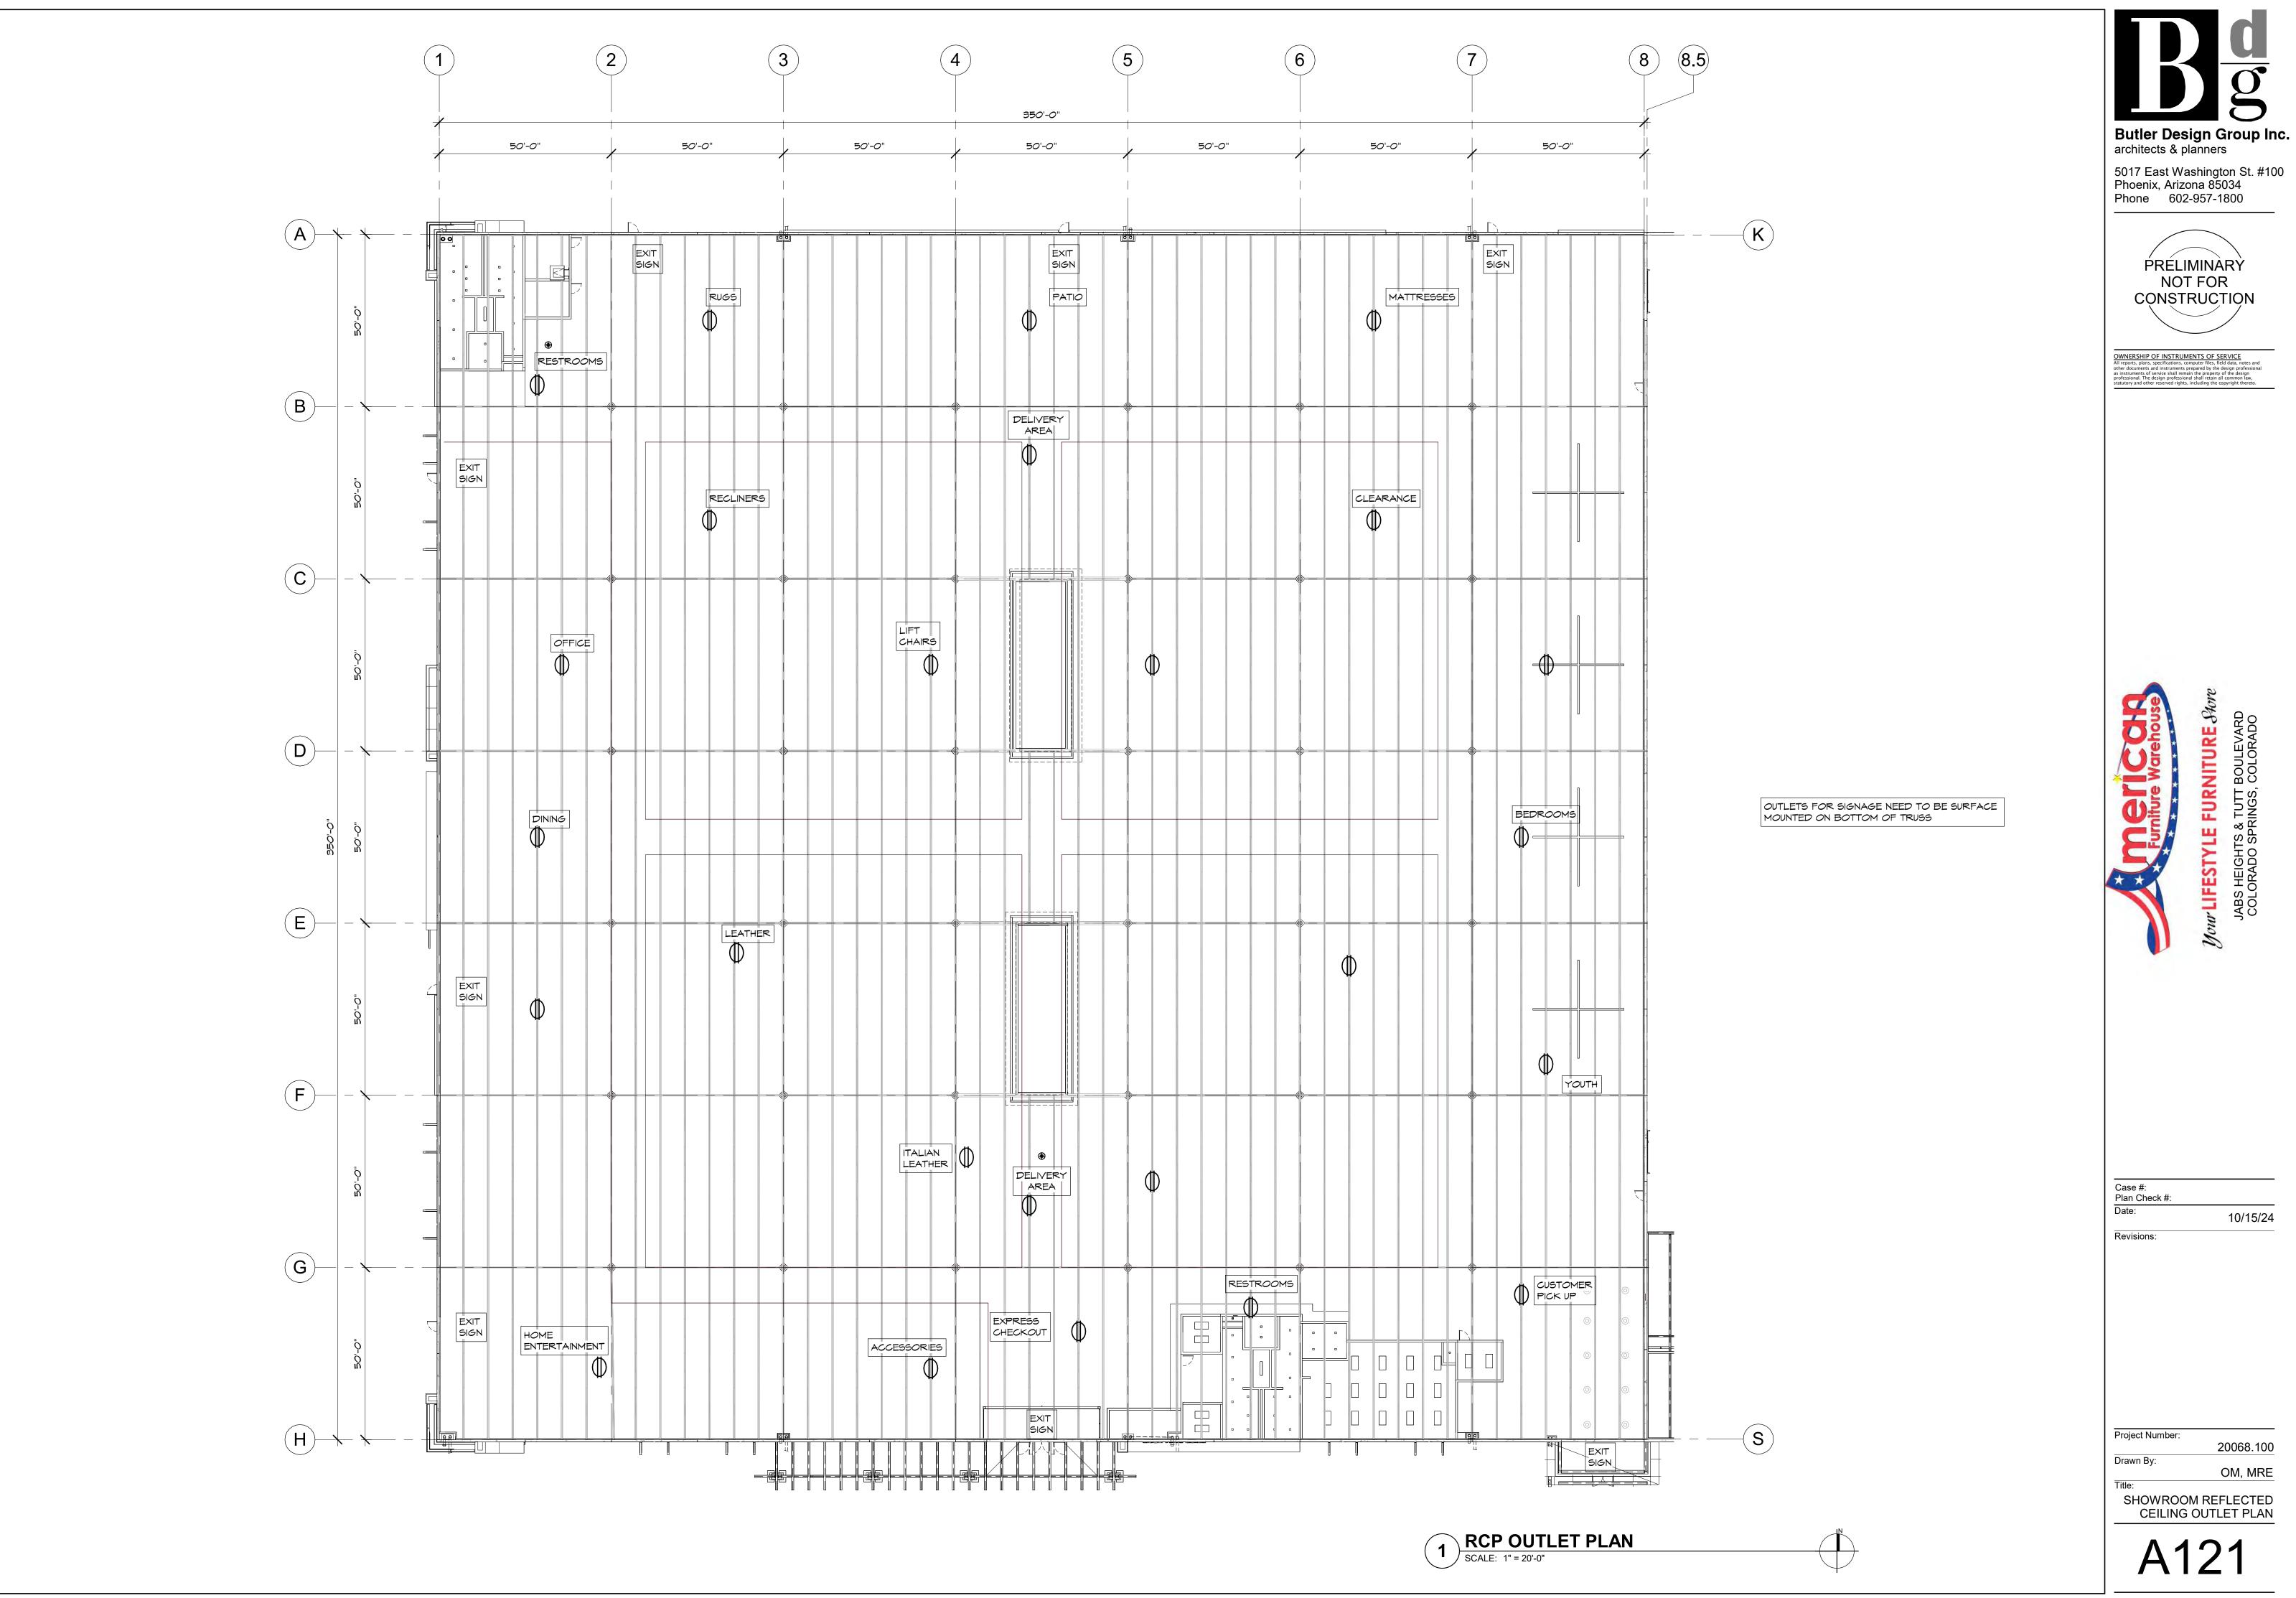

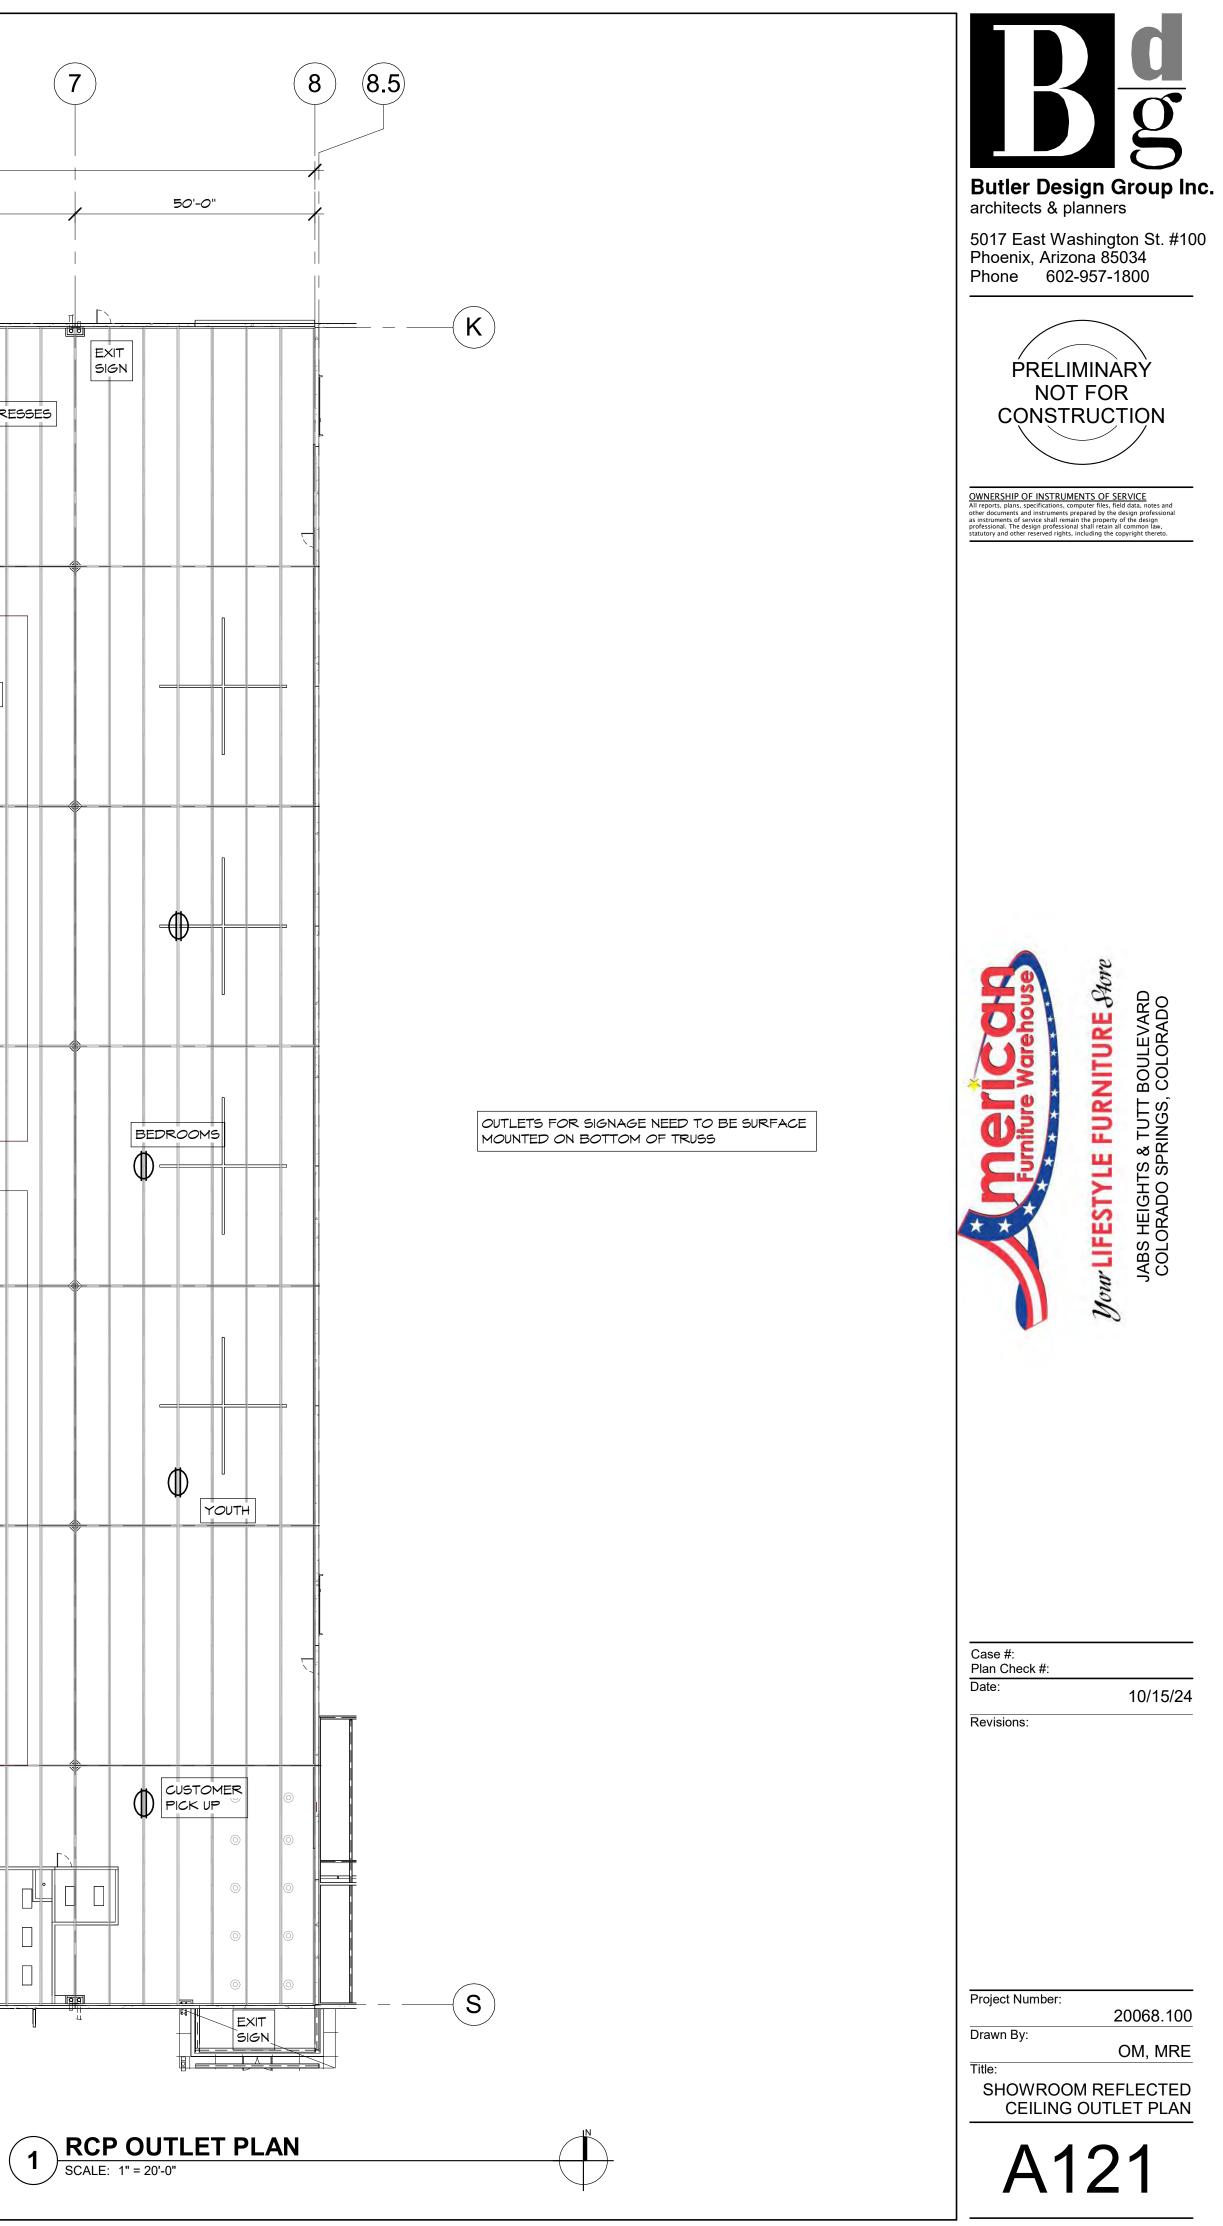


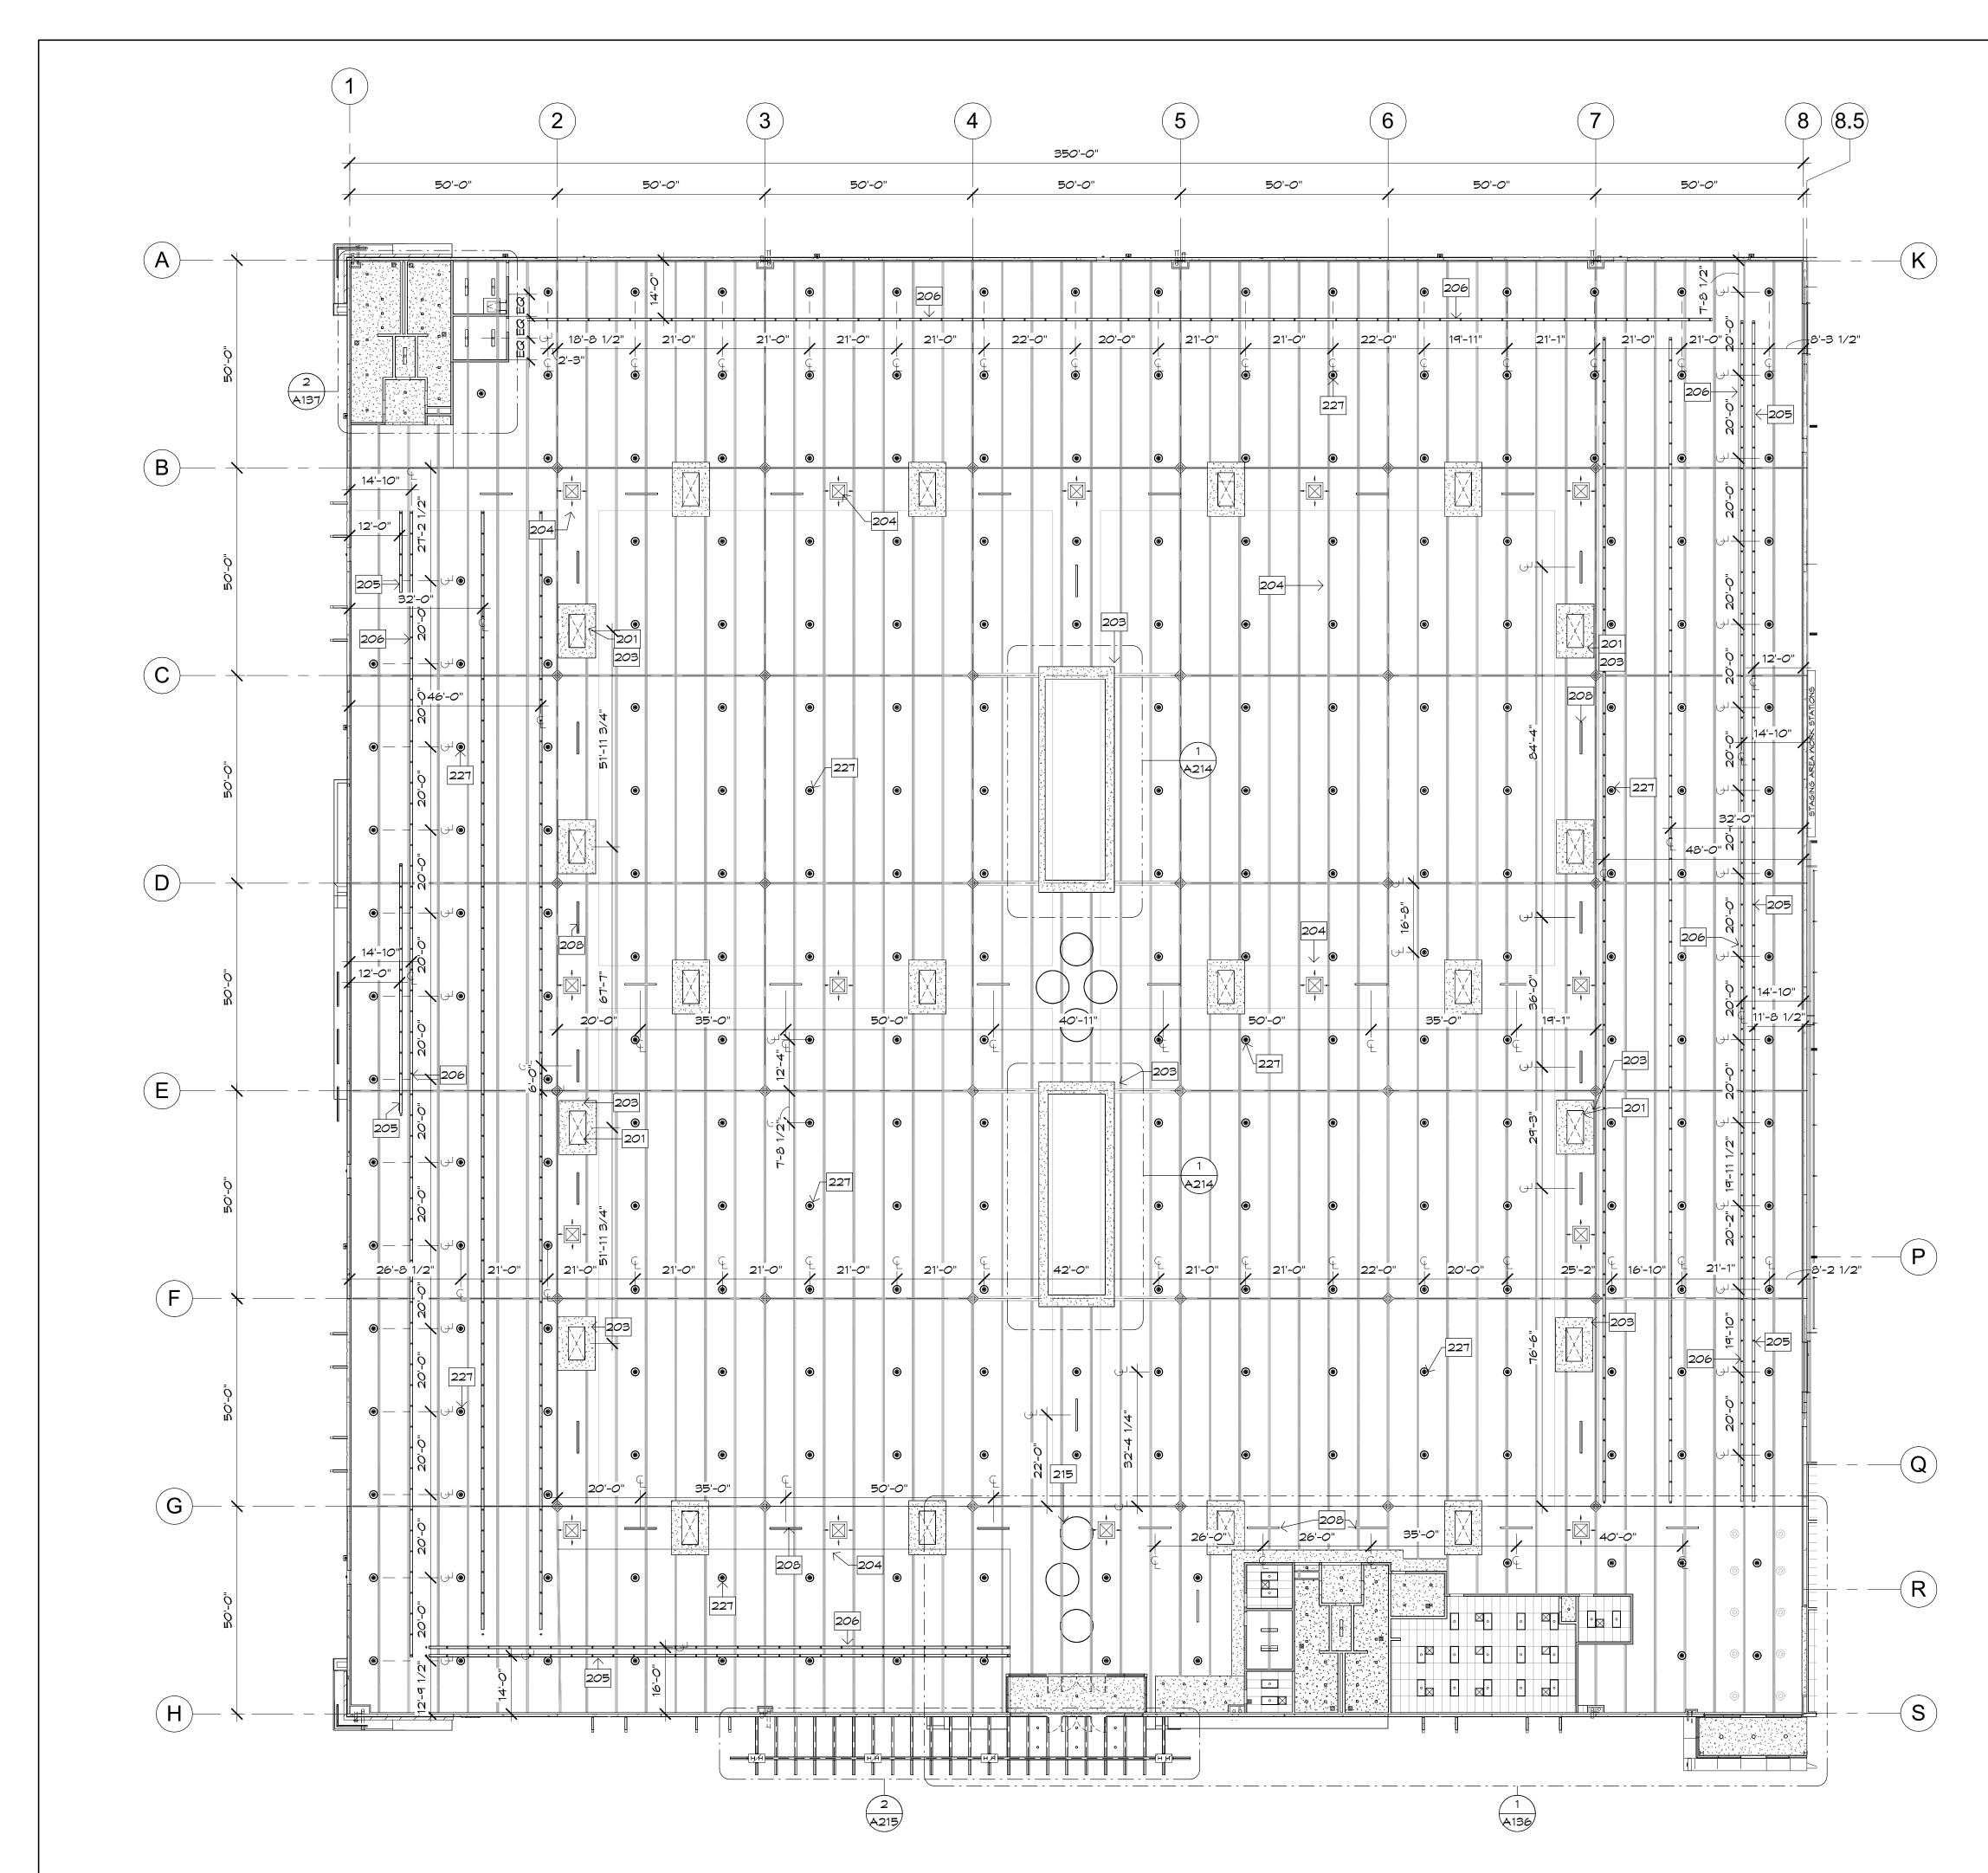


1 SHOWROOM RCP SCALE: 1" = 20'-0"

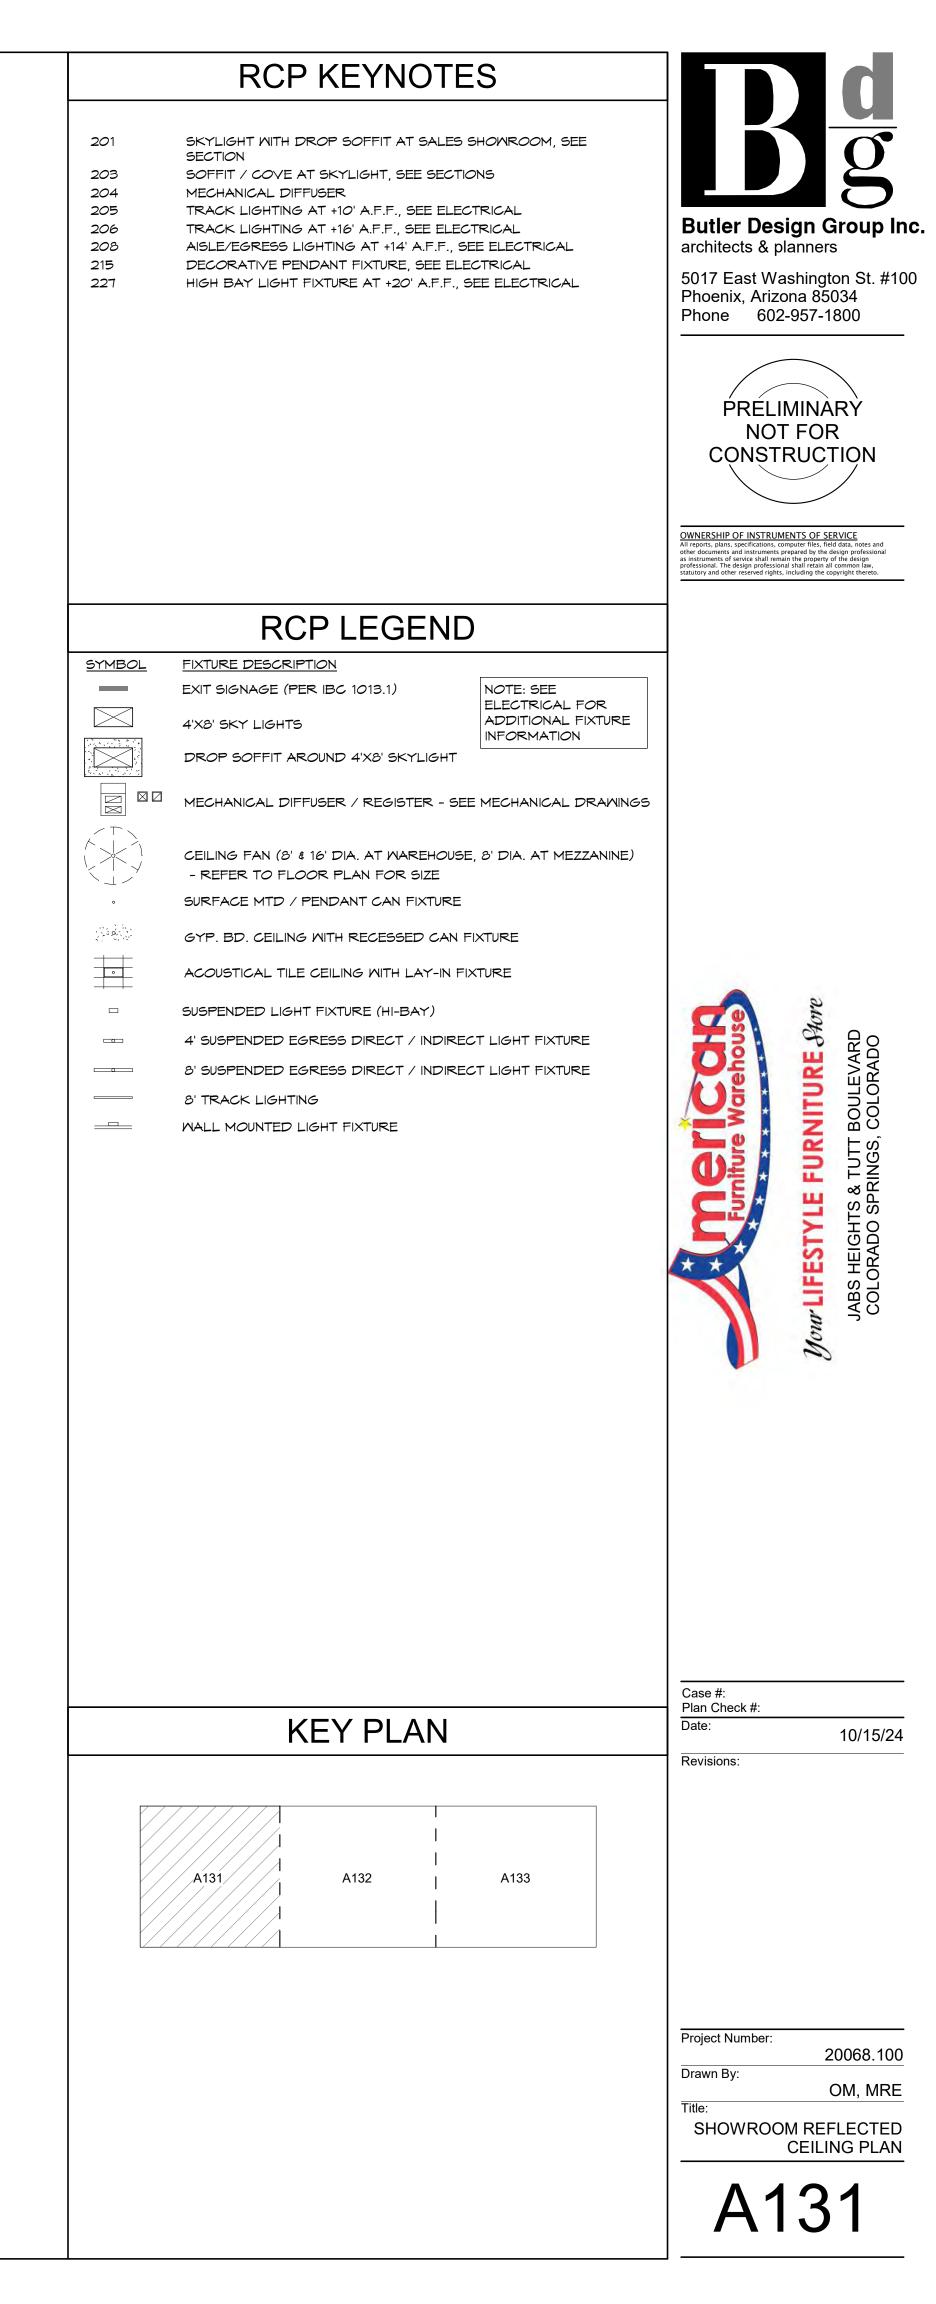


(	8 8	.5			9											1	
	2	20'- '-8 1/48	40'-0" 3" -0" <sup>+</sup> 8'-0"		3 3/2		40' 3'-0" <sup>(2</sup> 8'-		)" <sup>(-</sup> 8'-0	/ "  /		5	2'-0"	1			
		<u>ب</u> دین											218	+ - 			
		<b>۲</b> نی ب	18'-0 G	C C	24	£'-6"	G G	4'-8" (	È			13". L	<u>-5"   11'</u> C	F G Q	13'-8		13'
	- - - - - - - - - - - - - - - - - - -		+ -∑- i 204	0			0		]			]	0		9	0	
			₽ <mark>, 20</mark> 9	JI			D	ſ	ן	D		בו	D				
	-			/ 10' DIA.			0	]	]			]	0	0	<b>X</b> ;	0	
		26'-0"	Ð	D			D	[	נ	D		ב	٥	0		0	
	, , , ,			[ 	. FAN		0		]			]		0		0	
	1c	2" 7					D	ſ	ו	D		ב	K			<b></b>	
	-		- ∑ - † 204	0			0	[	]			]	0	0		0	
			£ 209	— <del>)</del> 1			D	ſ				<b>_</b>		•			F
	12'-2"					26'-	0" 20'-(		DIA. FAN -	□ ↓ ↓ ↓ ↓ ↓ ↓	<u> </u>	-0" -0"			25'-0		
		0		-													
			0 0		• • •	0	• •										
													· ·				1

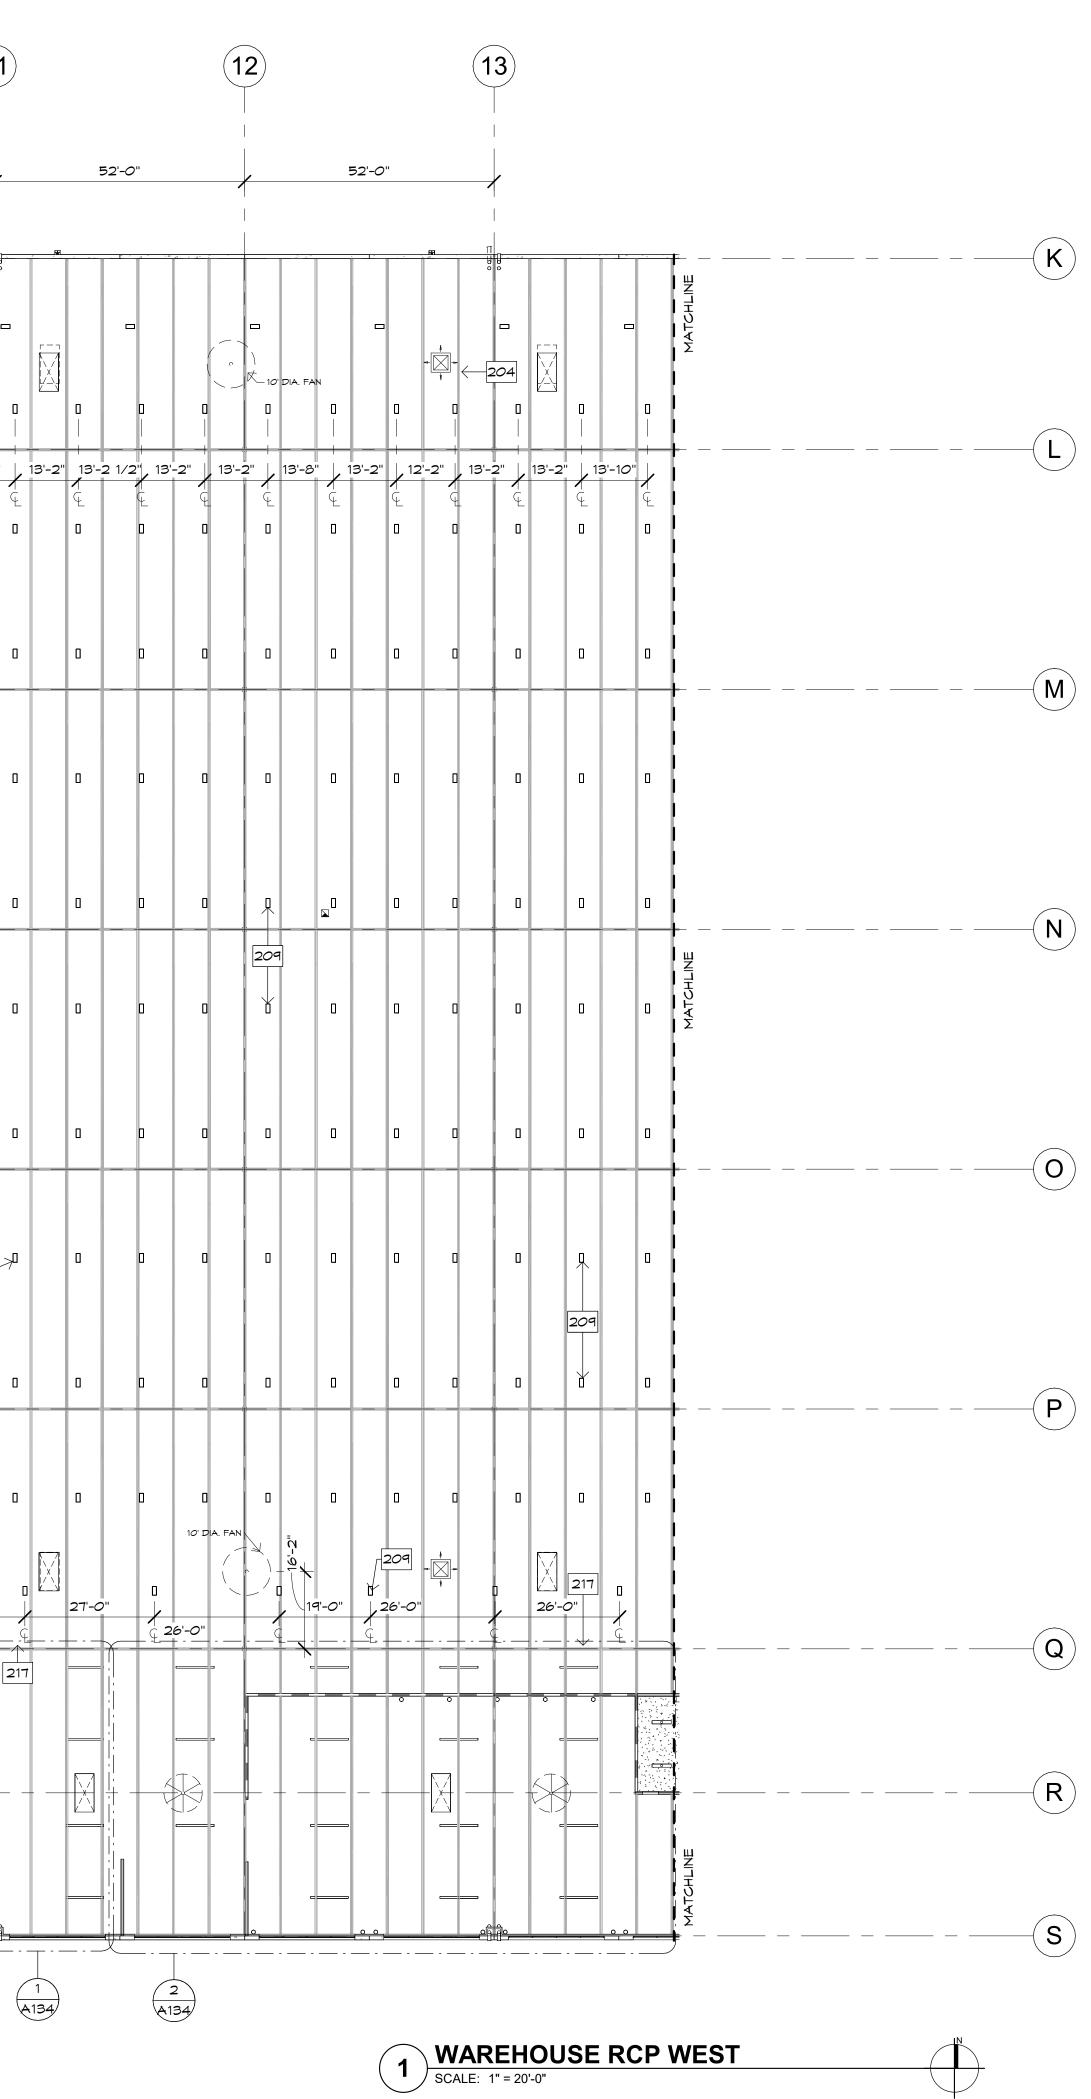



204	RCP KEYNOTES #	
209 217 218	HIGH-BAY LIGHTING, SEE ELECTRICAL FOR MOUNTING HEIGHT EDGE OF MEZZANINE ABOVE CONCENTRIC SUPPLY AND RETURN FROM RTU ABOVE - SEE MECHANICAL	<section-header><section-header><text><text><text><text></text></text></text></text></section-header></section-header>
	<section-header>          EXTURE DESCRIPTION           EXIT SIGNAGE (PER IBC 1013.1)           EXIT SIGNAGE (PER IBC 1013.1)           AX8' SKY LIGHTS           DROP SOFFIT AROUND 4X8' SKYLIGHT</section-header>	And LIFESTYLE FUNITINE March M
	<ul> <li>MECHANICAL DIFFUSER / REGISTER - SEE MECHANICAL DRAWINGS</li> <li>CEILING FAN (&amp; &amp; 16' DIA. AT WAREHOUSE, &amp; DIA. AT MEZZANINE)</li> <li>REFER TO FLOOR PLAN FOR SIZE</li> <li>SURFACE MTD / PENDANT CAN FIXTURE</li> <li>GYP. BD. CEILING WITH RECESSED CAN FIXTURE</li> <li>ACOUSTICAL TILE CEILING WITH LAY-IN FIXTURE</li> <li>SUSPENDED LIGHT FIXTURE (HI-BAY)</li> <li>4' SUSPENDED EGRESS DIRECT / INDIRECT LIGHT FIXTURE</li> <li>&amp; SUSPENDED EGRESS DIRECT / INDIRECT LIGHT FIXTURE</li> <li>&amp; TRACK LIGHTING</li> <li>WALL MOUNTED LIGHT FIXTURE</li> </ul>	
	KEY PLAN	Case #: Plan Check #: Date: 10/15/2
		Revisions:

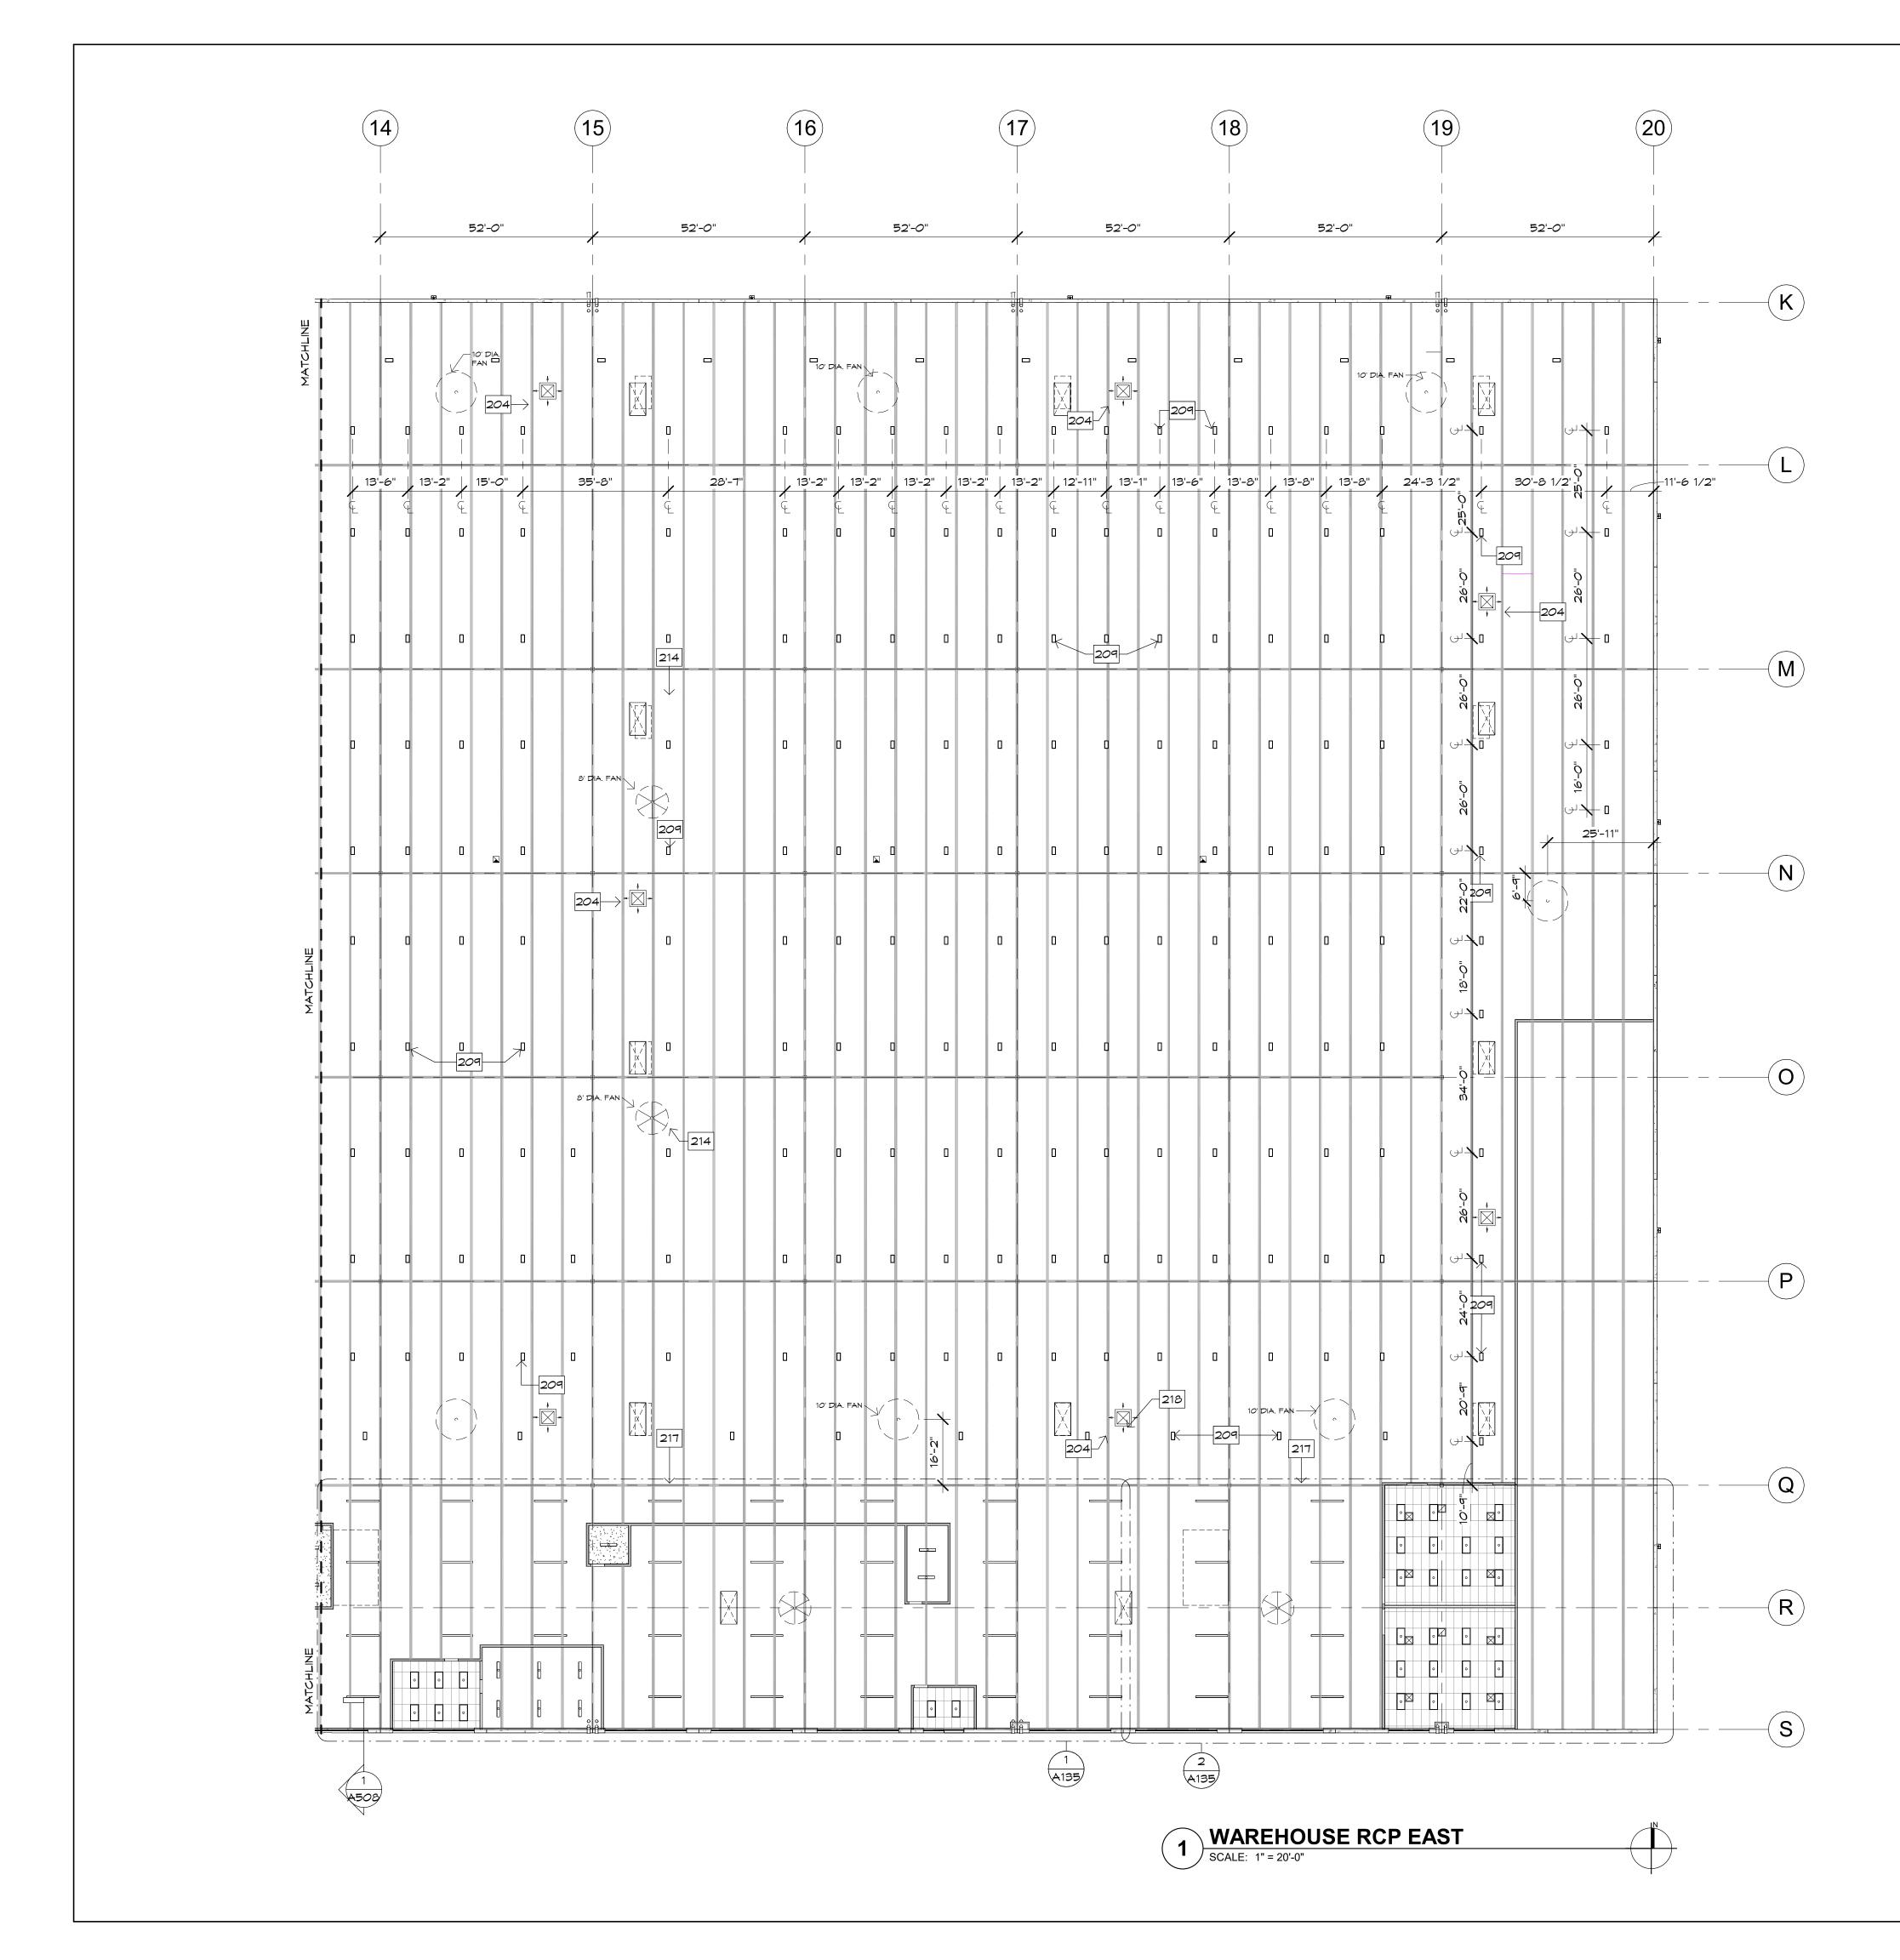


204 209 214 217 218	MECHANICAL DIFFUSER HIGH-BAY LIGHTING, SEE ELECTRICAL FOR MOUNTING HEIGHT CEILING FAN, 16' DIA AT OPEN STOCKROOM, 8' DIA AT MEZZANINE. SEE ELECTRICAL EDGE OF MEZZANINE ABOVE CONCENTRIC SUPPLY AND RETURN FROM RTU ABOVE - SEE MECHANICAL	Butler Design Group In architects & planners 5017 East Washington St. #19 Phoenix, Arizona 85034 Phone 602-957-1800
		OWNERSHIP OF INSTRUMENTS OF SERVICE         All reports, plans, specifications, computer files, field data, notes and spinstruments of service shall remain the property of the design professional. The design professional shall retain all lettin allettin all lettin all lettin all lettin all lett
	FIXTURE DESCRIPTION         EXIT SIGNAGE (PER IBC 1013.1)         4'X8' SKY LIGHTS         DROP SOFFIT AROUND 4'X8' SKYLIGHT         MECHANICAL DIFFUSER / REGISTER - SEE MECHANICAL DRAWINGS         CEILING FAN (8' & 16' DIA. AT WAREHOUSE, 8' DIA. AT MEZZANINE)         - REFER TO FLOOR PLAN FOR SIZE         SURFACE MTD / PENDANT CAN FIXTURE         GYP. BD. CEILING WITH RECESSED CAN FIXTURE         SUSPENDED LIGHT FIXTURE (HI-BAY)         4' SUSPENDED EGRESS DIRECT / INDIRECT LIGHT FIXTURE         6' SUSPENDED EGRESS DIRECT / INDIRECT LIGHT FIXTURE         6' TRACK LIGHTING         WALL MOUNTED LIGHT FIXTURE	Case #:
	FIXTURE DESCRIPTION         EXIT SIGNAGE (PER IBC 1013.1)         A'X&'SKY LIGHTS         A'X&'SKY LIGHTS         DROP SOFFIT AROUND 4'X&'SKYLIGHT         MECHANICAL DIFFUSER / REGISTER - SEE MECHANICAL DRAWINGS         CEILING FAN (&' & 16' DIA. AT WAREHOUSE, &' DIA. AT MEZZANINE)         - REFER TO FLOOR PLAN FOR SIZE         SURFACE MTD / PENDANT CAN FIXTURE         GYP. BD. CEILING WITH RECESSED CAN FIXTURE         SUSPENDED LIGHT FIXTURE (HI-BAY)         4' SUSPENDED EGRESS DIRECT / INDIRECT LIGHT FIXTURE         8' SUSPENDED EGRESS DIRECT / INDIRECT LIGHT FIXTURE         8' TRACK LIGHTING	<i>Monultest</i>
	FIXTURE DESCRIPTION         EXIT SIGNAGE (PER IBC 1013.1)       NOTE: SEE         4'X8' SKY LIGHTS       NOTE: SEE         DROP SOFFIT AROUND 4'X8' SKYLIGHT       NOTE: SEE         MECHANICAL DIFFUSER / REGISTER - SEE MECHANICAL DRAWINGS         CEILING FAN (8' & 16' DIA. AT WAREHOUSE, 8' DIA. AT MEZZANINE)         - REFER TO FLOOR PLAN FOR SIZE         SURFACE MTD / PENDANT CAN FIXTURE         GYP. BD. CEILING WITH RECESSED CAN FIXTURE         SUSPENDED LIGHT FIXTURE (HI-BAY)         4' SUSPENDED EGRESS DIRECT / INDIRECT LIGHT FIXTURE         8' SUSPENDED EGRESS DIRECT / INDIRECT LIGHT FIXTURE         8' SUSPENDED LIGHT FIXTURE         WALL MOUNTED LIGHT FIXTURE	Case #: Plan Check #: Date: 10/15/24

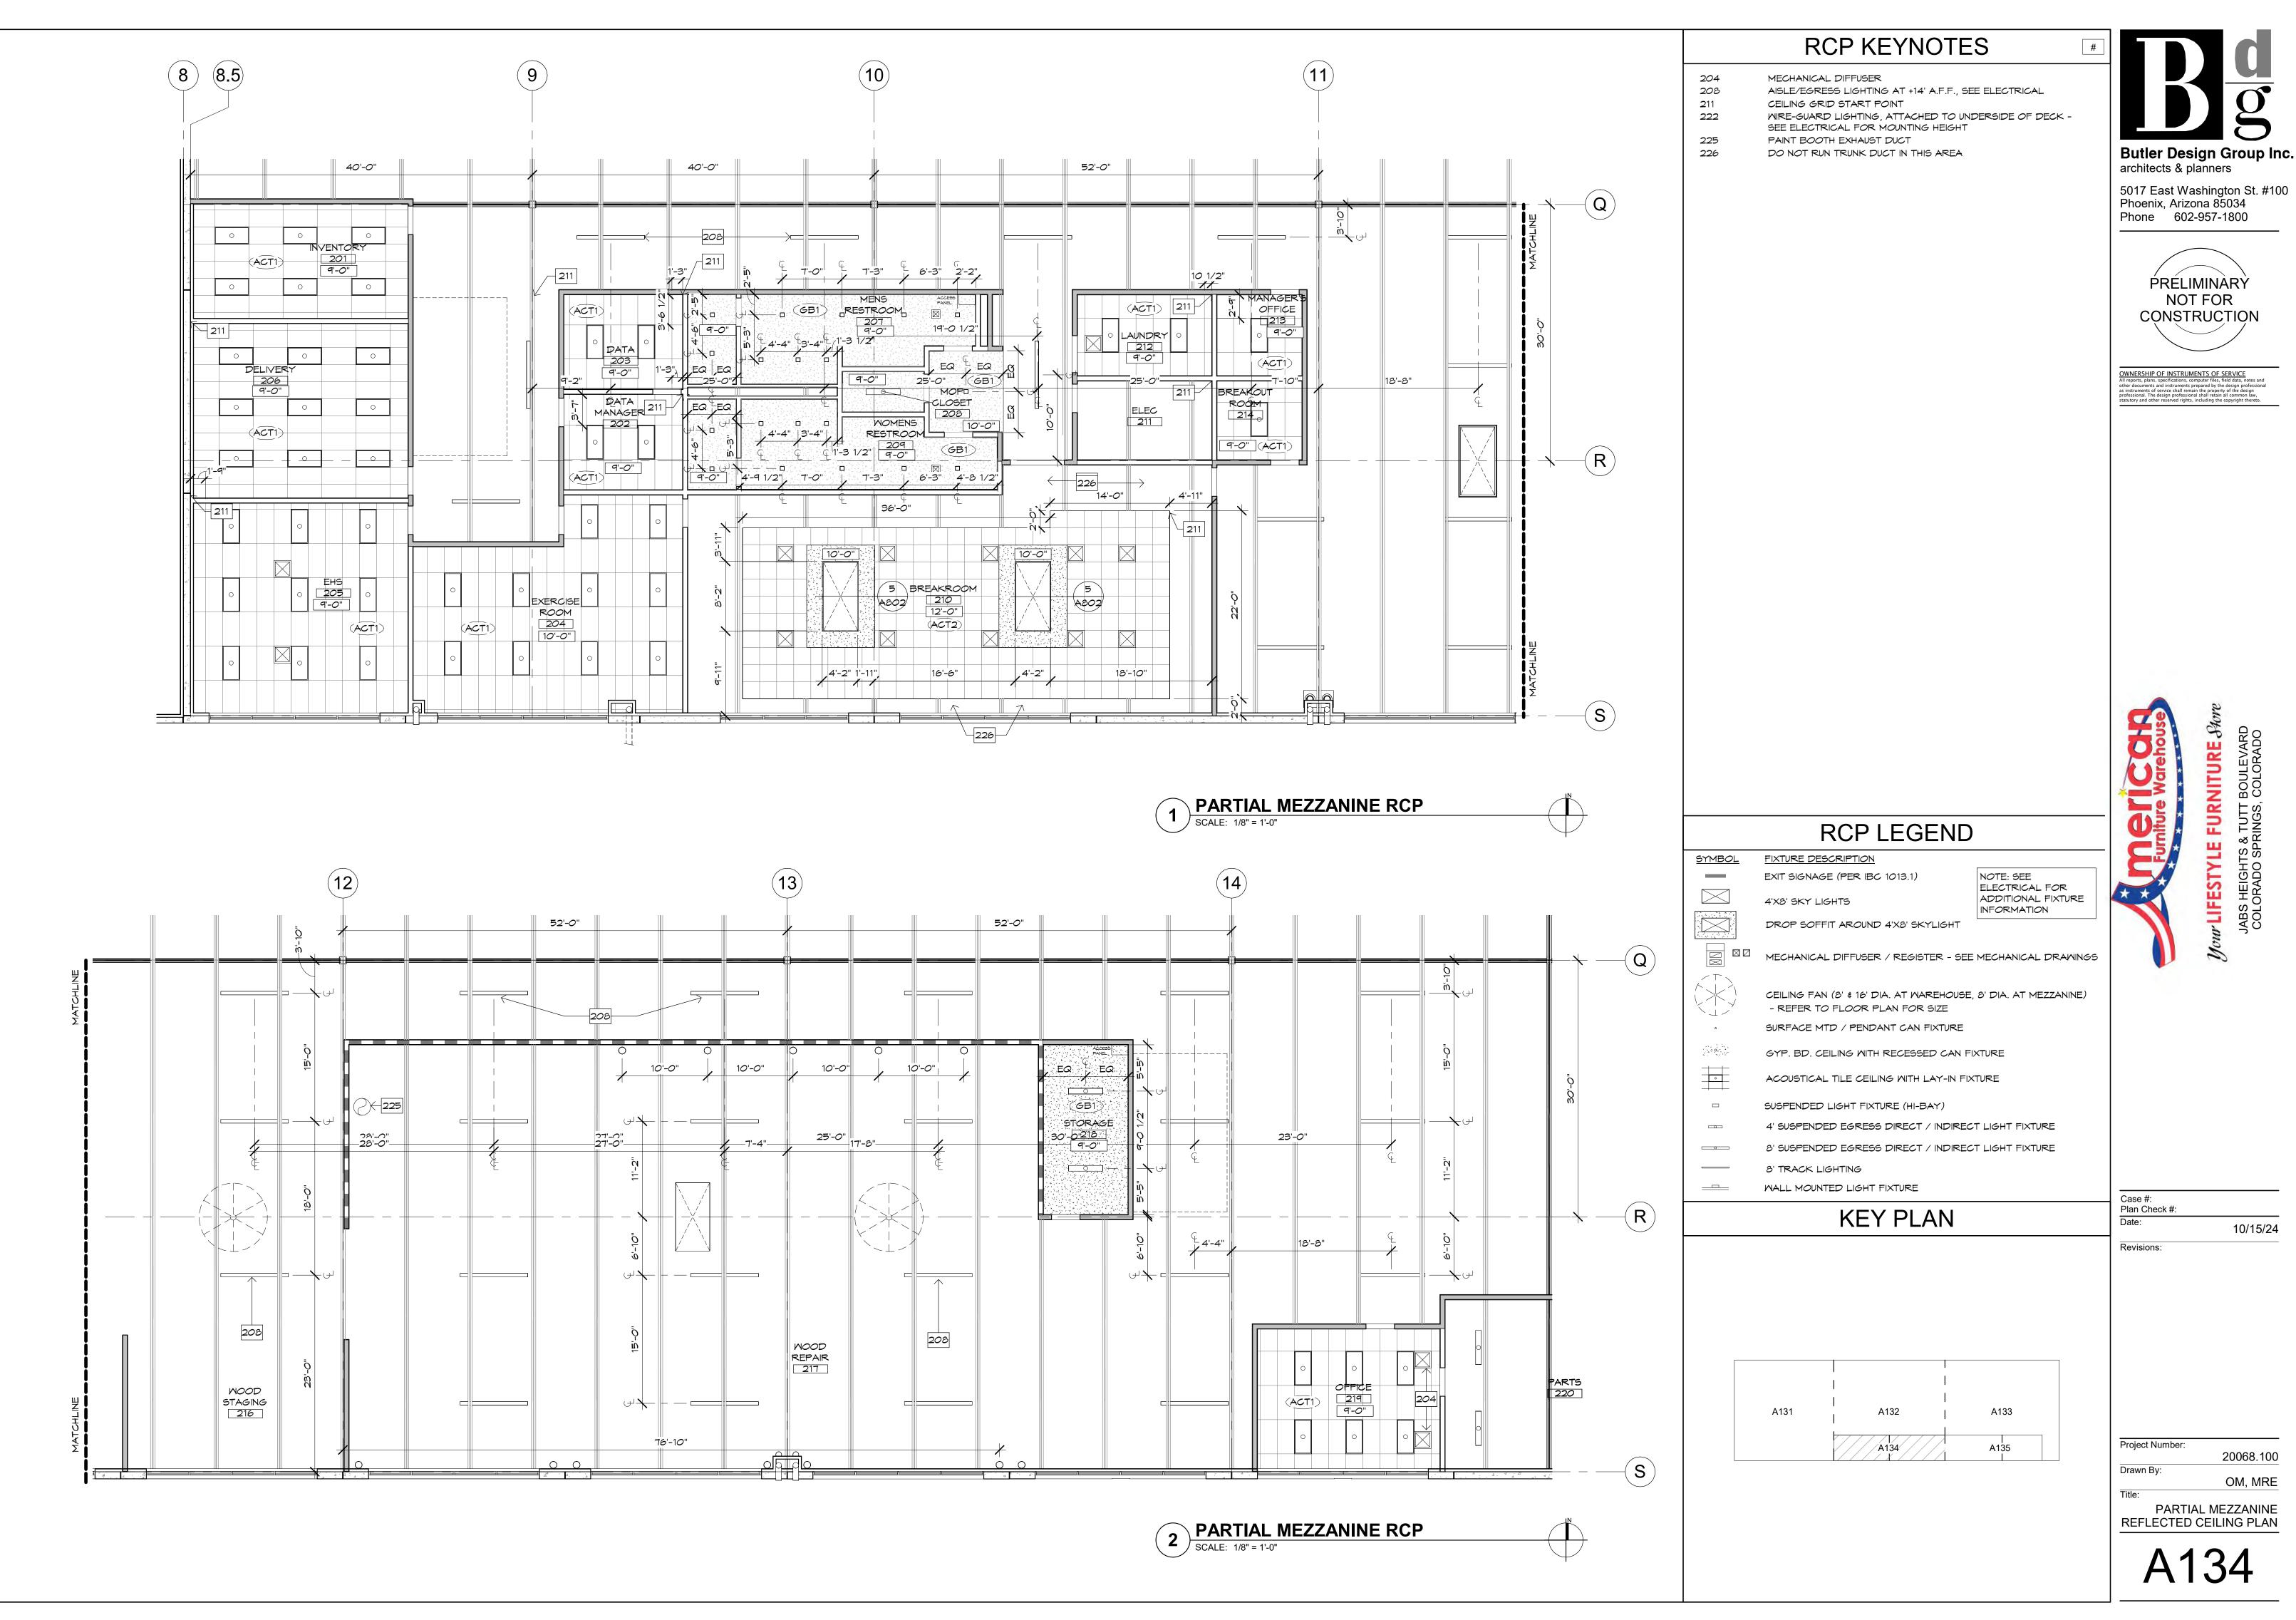


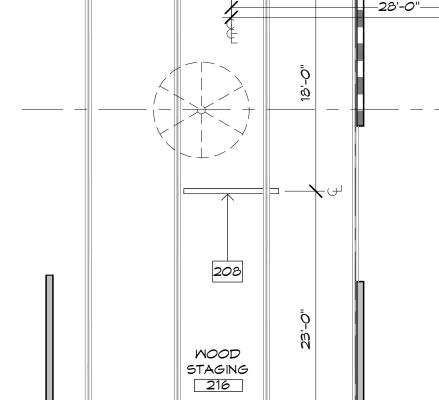


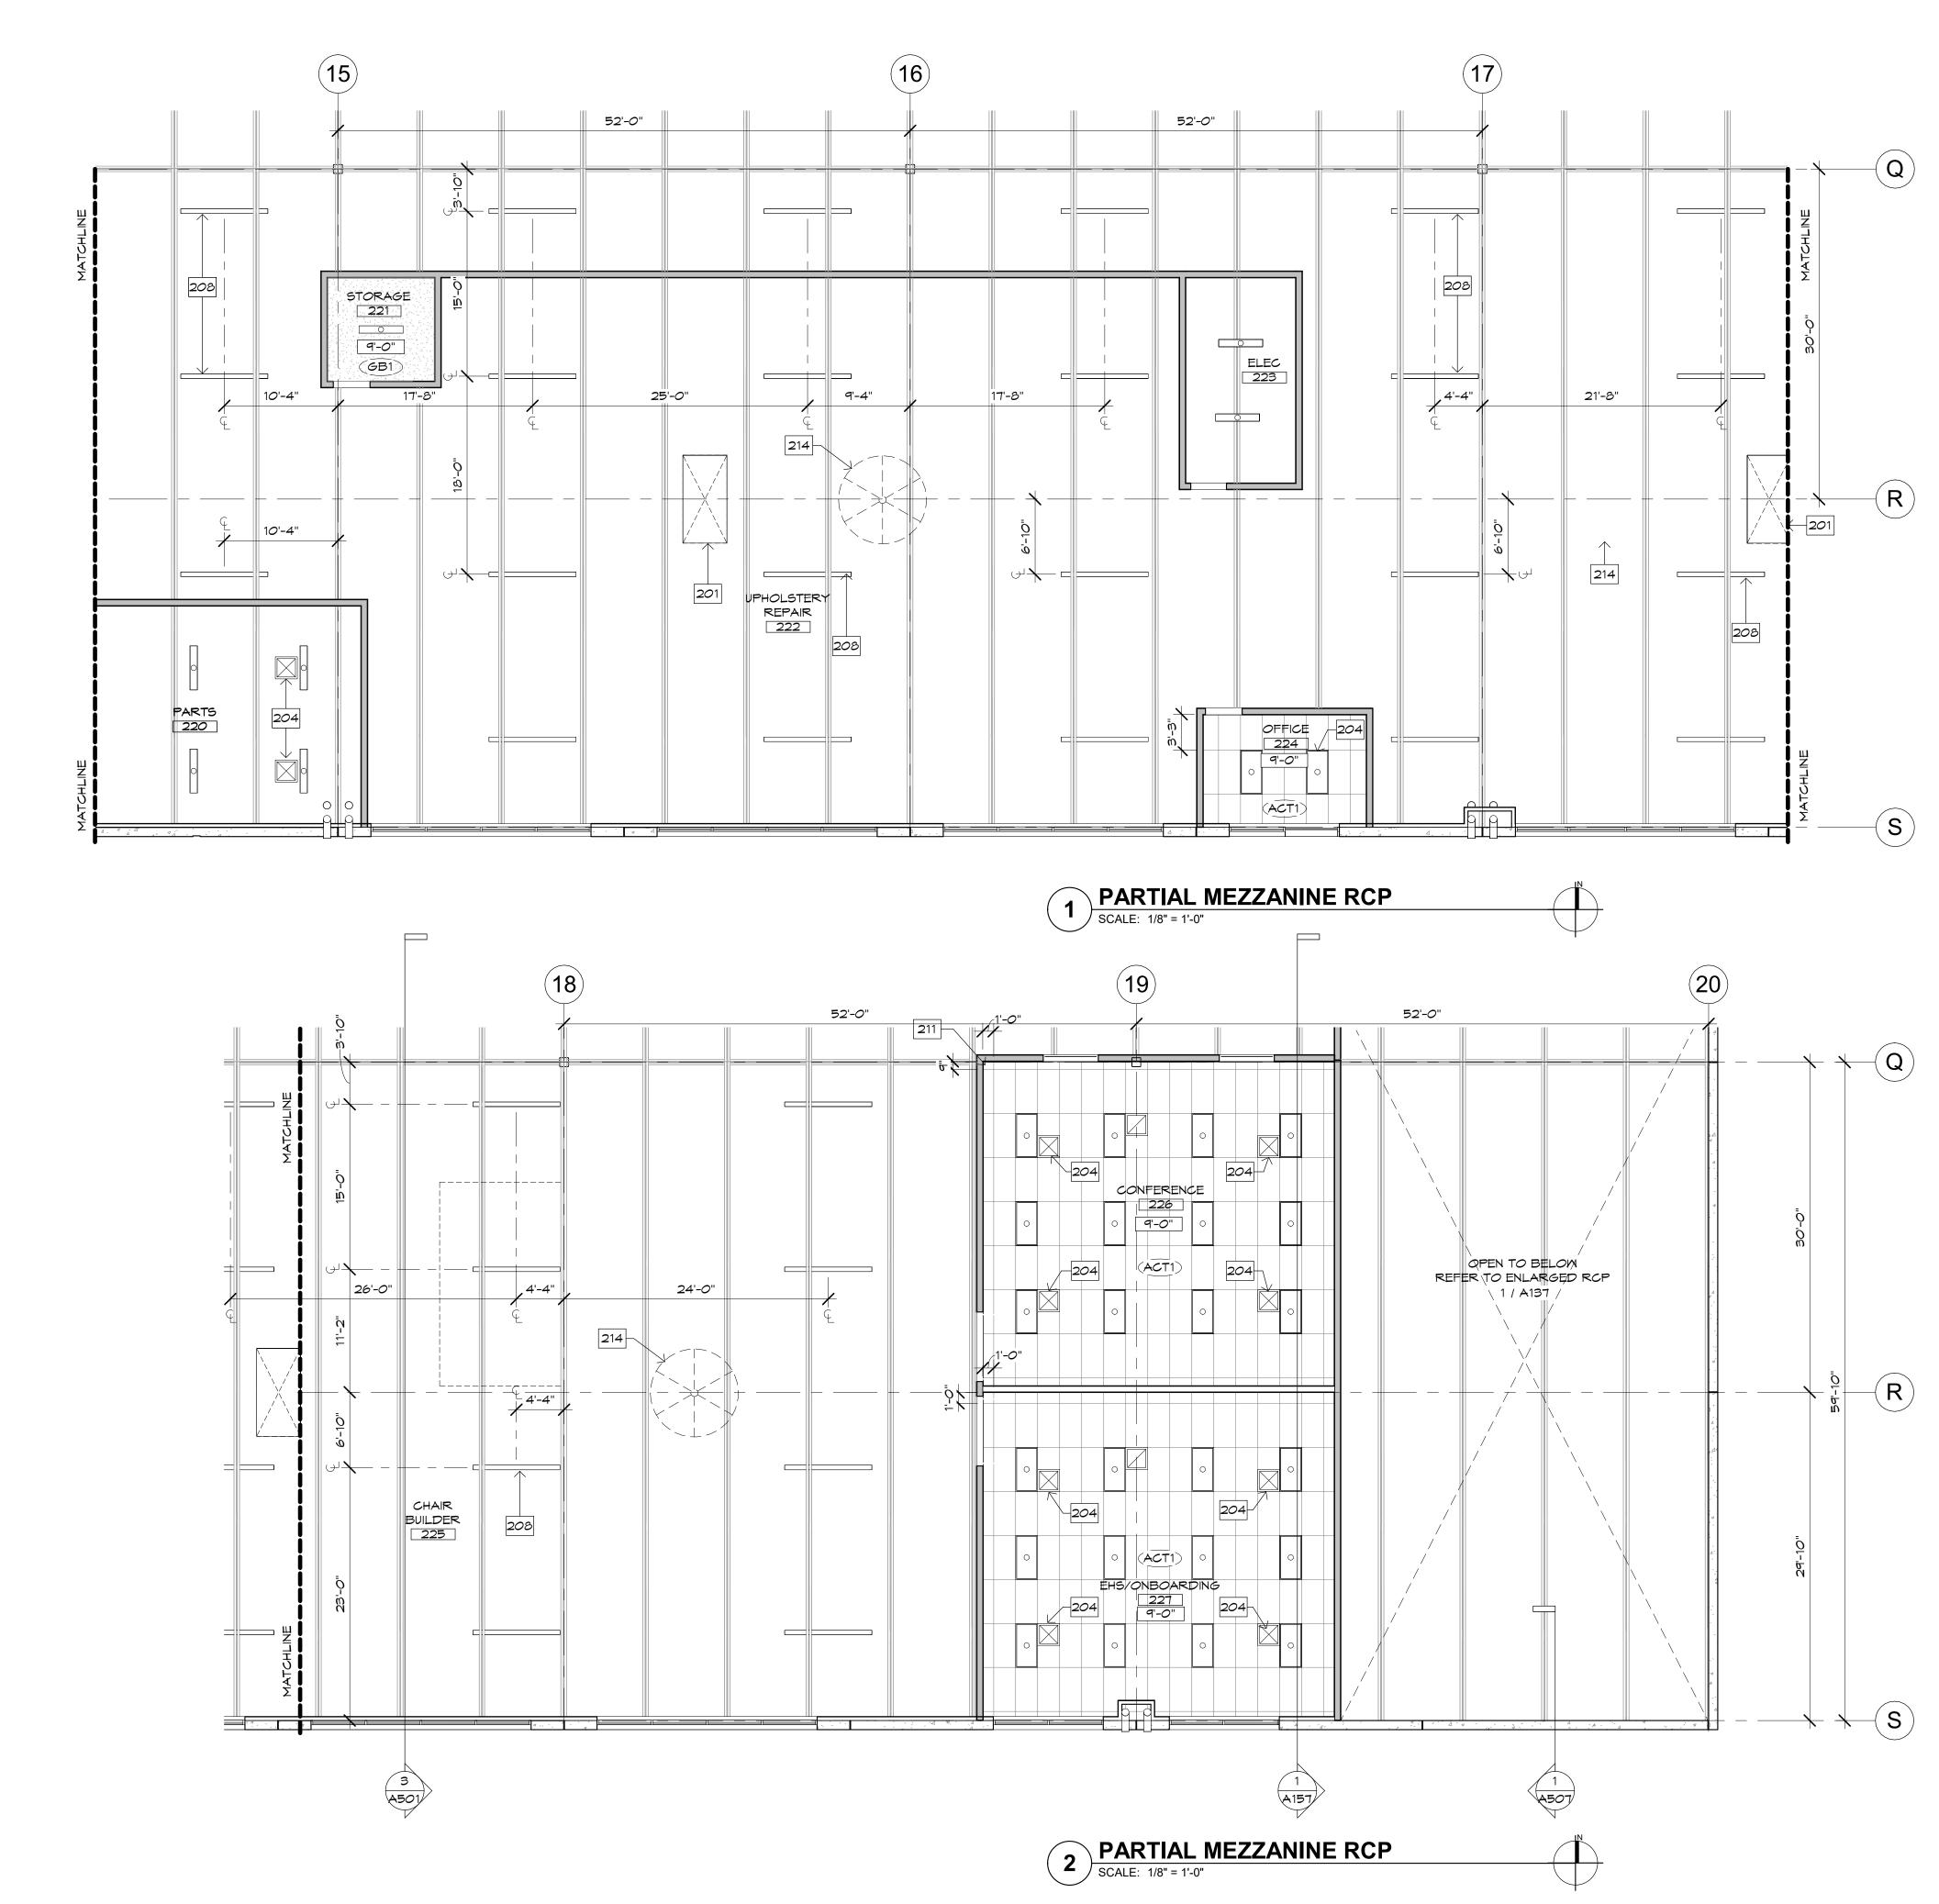

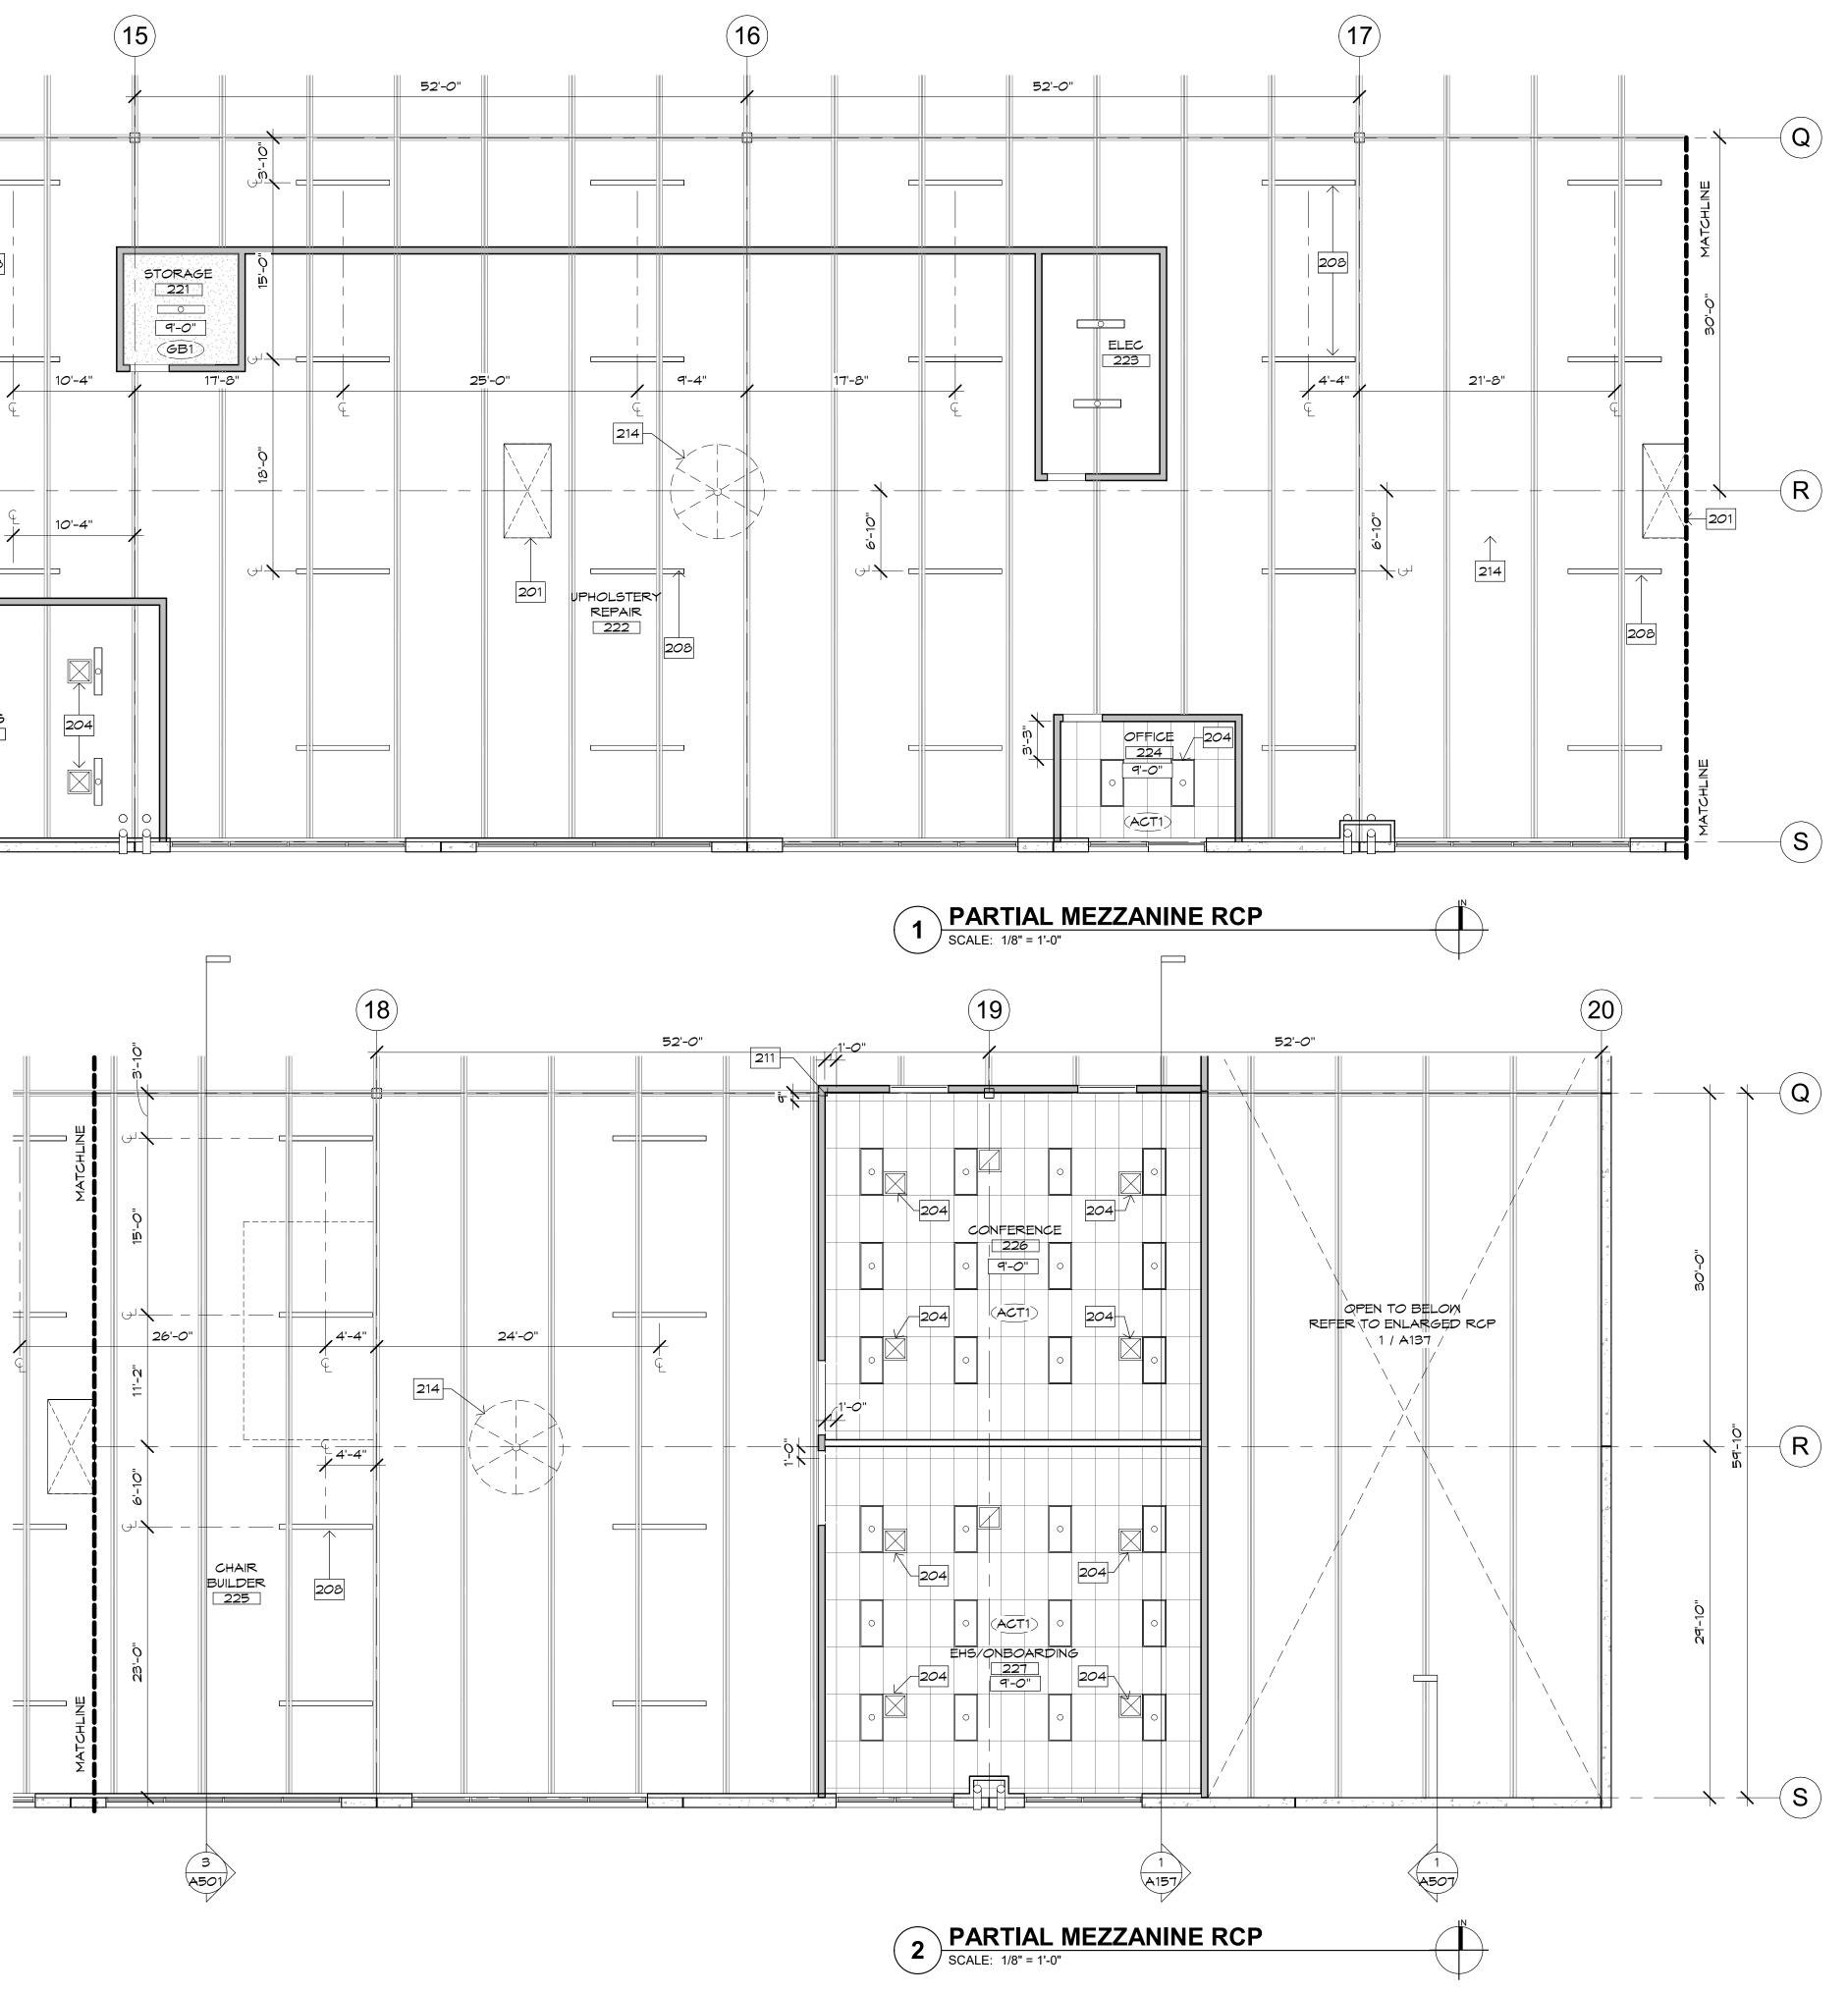


	RCP KEYNOTES #	
201 204 208 211 214	SKYLIGHT WITH DROP SOFFIT AT SALES SHOWROOM, SEE SECTION MECHANICAL DIFFUSER AISLE/EGRESS LIGHTING AT +14' A.F.F., SEE ELECTRICAL CEILING GRID START POINT CEILING FAN, 16' DIA AT OPEN STOCKROOM, 8' DIA AT MEZZANINE. SEE ELECTRICAL	<section-header><section-header><section-header><section-header><text><text><text><text></text></text></text></text></section-header></section-header></section-header></section-header>
		Jabs Heights & TUTT BOULEVARD Colorado Sprinds, Colorado
	<section-header>         EXIT SIGNAGE (PER IBC 1013.1)         4'X8' SKY LIGHTS         DROP SOFFIT AROUND 4'X8' SKYLIGHT</section-header>	Case #: Plan Check #: Date: 10/15/24 Revisions:
	MECHANICAL DIFFUSER / REGISTER - SEE MECHANICAL DRAWINGS CEILING FAN (8' & 16' DIA. AT WAREHOUSE, 8' DIA. AT MEZZANINE) - REFER TO FLOOR PLAN FOR SIZE SURFACE MTD / PENDANT CAN FIXTURE GYP. BD. CEILING WITH RECESSED CAN FIXTURE ACOUSTICAL TILE CEILING WITH LAY-IN FIXTURE SUSPENDED LIGHT FIXTURE (HI-BAY) 4' SUSPENDED EGRESS DIRECT / INDIRECT LIGHT FIXTURE 8' SUSPENDED EGRESS DIRECT / INDIRECT LIGHT FIXTURE 8' SUSPENDED EGRESS DIRECT / INDIRECT LIGHT FIXTURE 8' TRACK LIGHTING WALL MOUNTED LIGHT FIXTURE	Project Number: 20068.100 Drawn By: OMOM, MRE Title: PARTIAL MEZZANINE REFLECTED CEILING PLAN A135

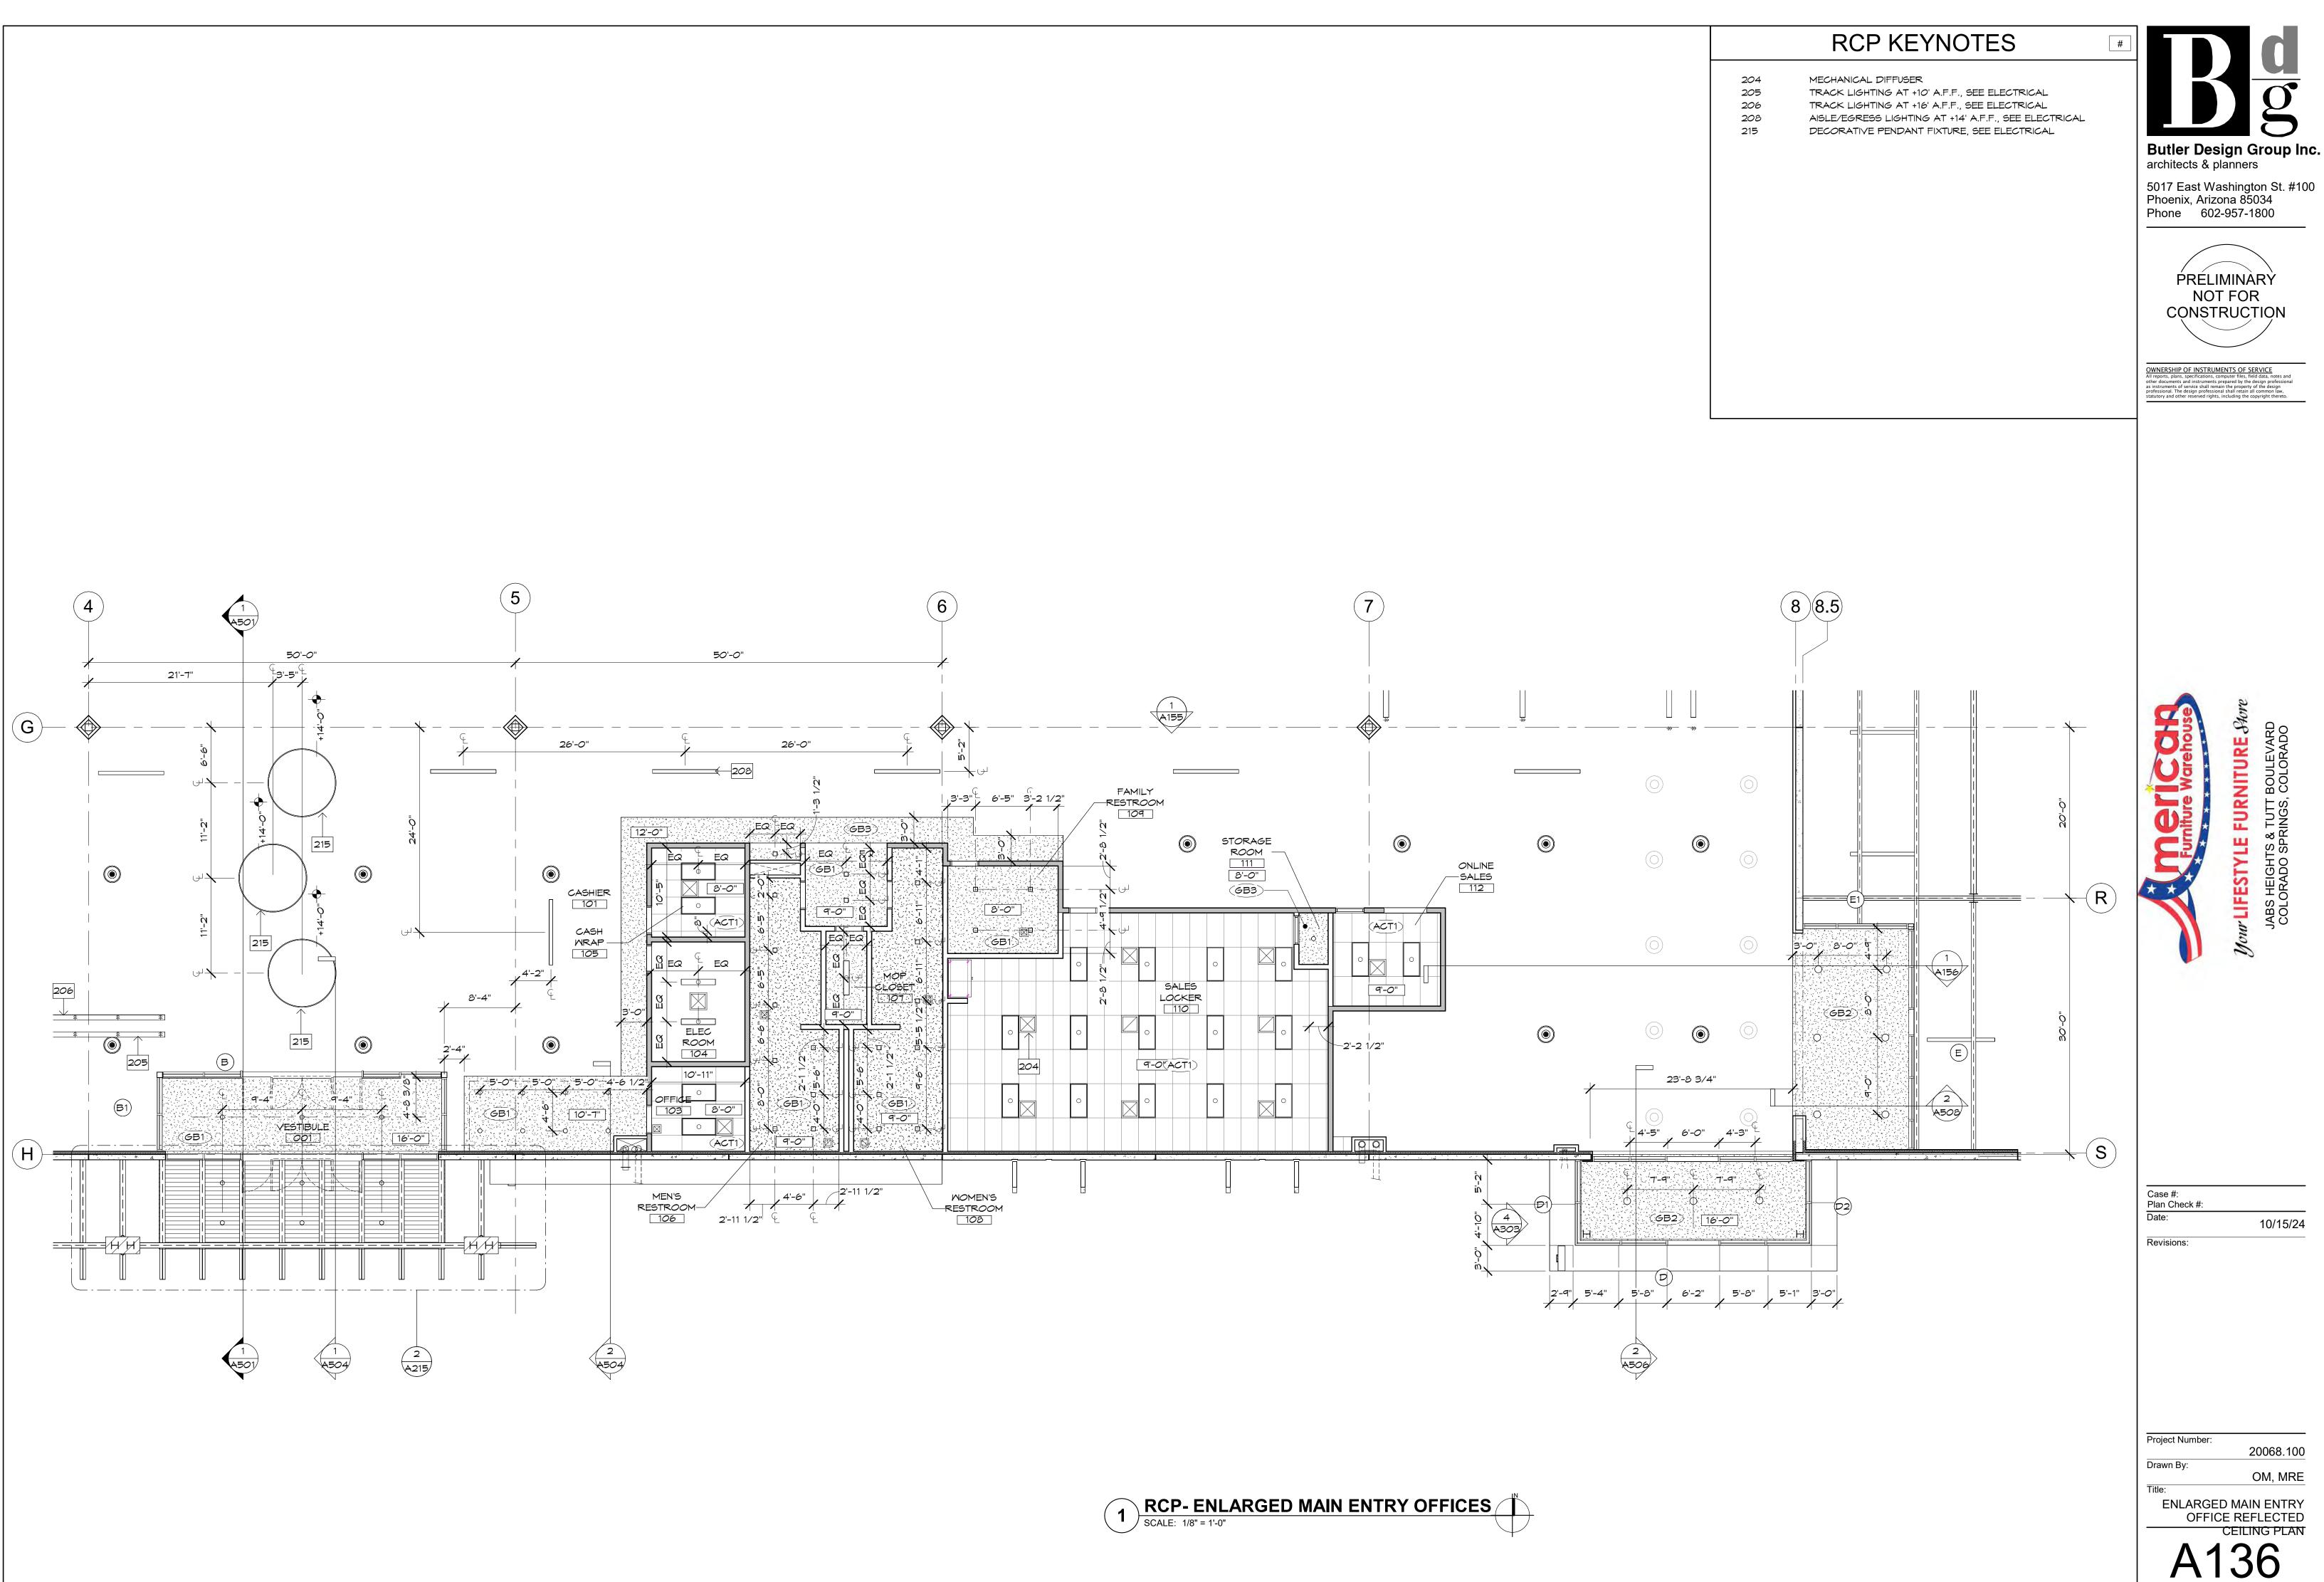

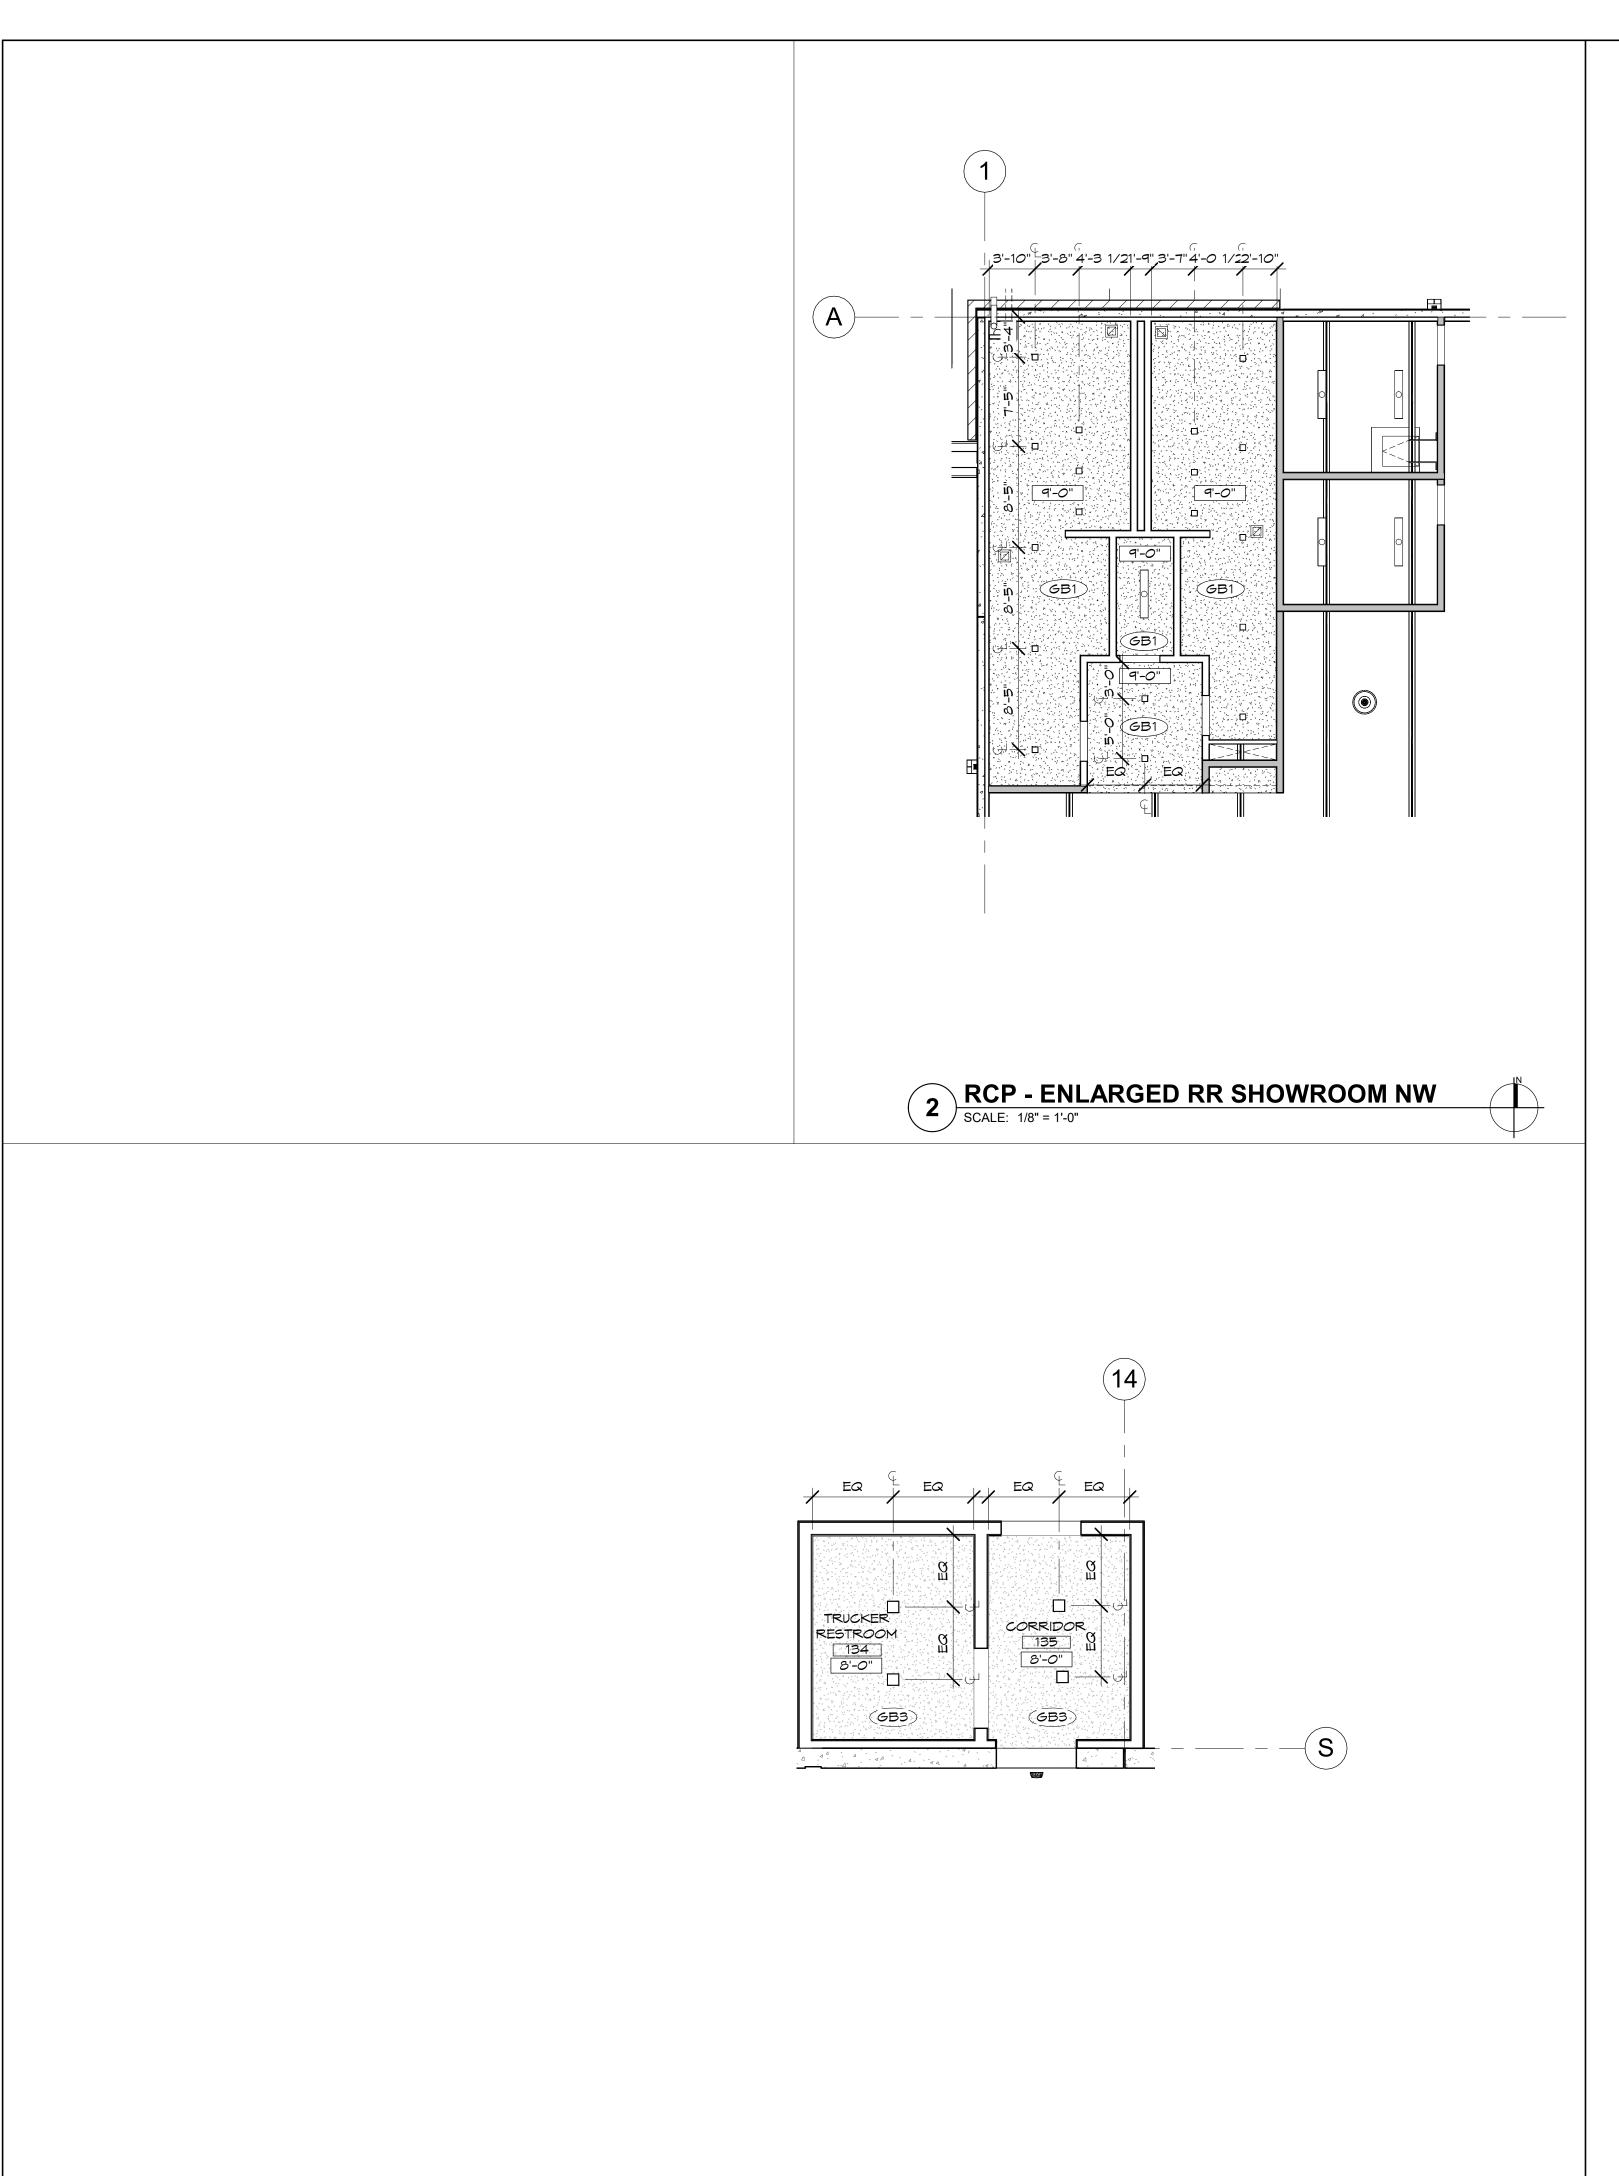




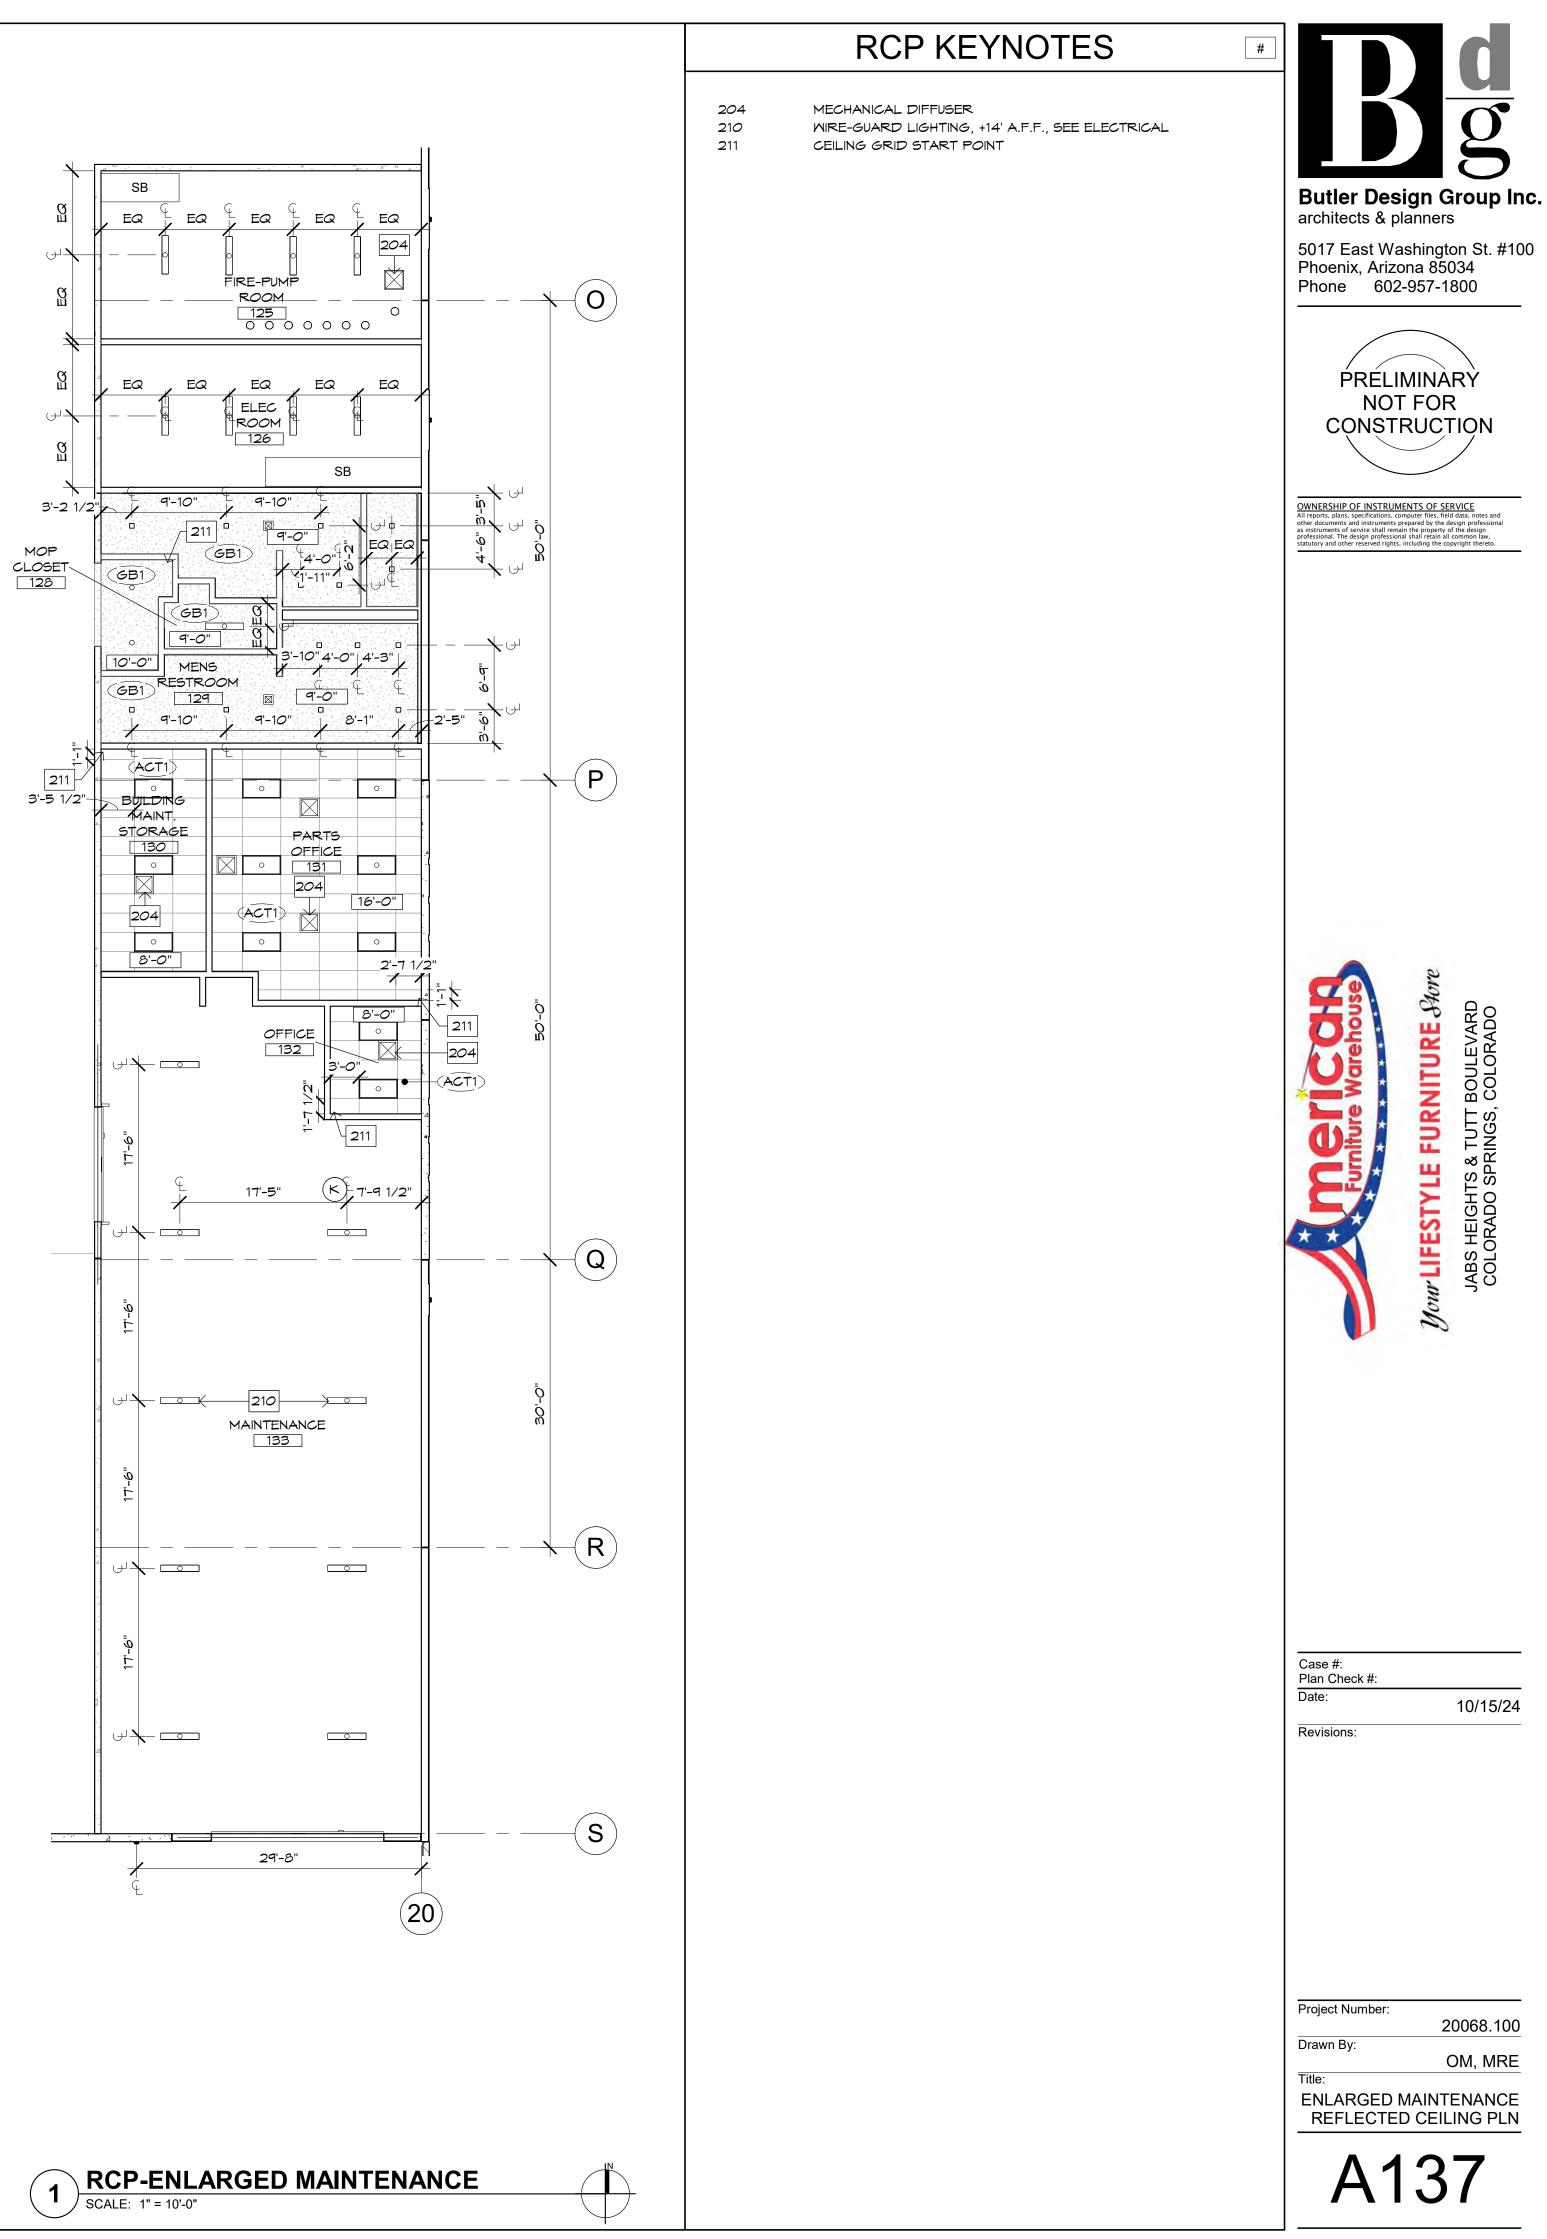



3 RCP-ENLARGED WAREHOUSE RESTROOM SCALE: 1/4" = 1'-0"



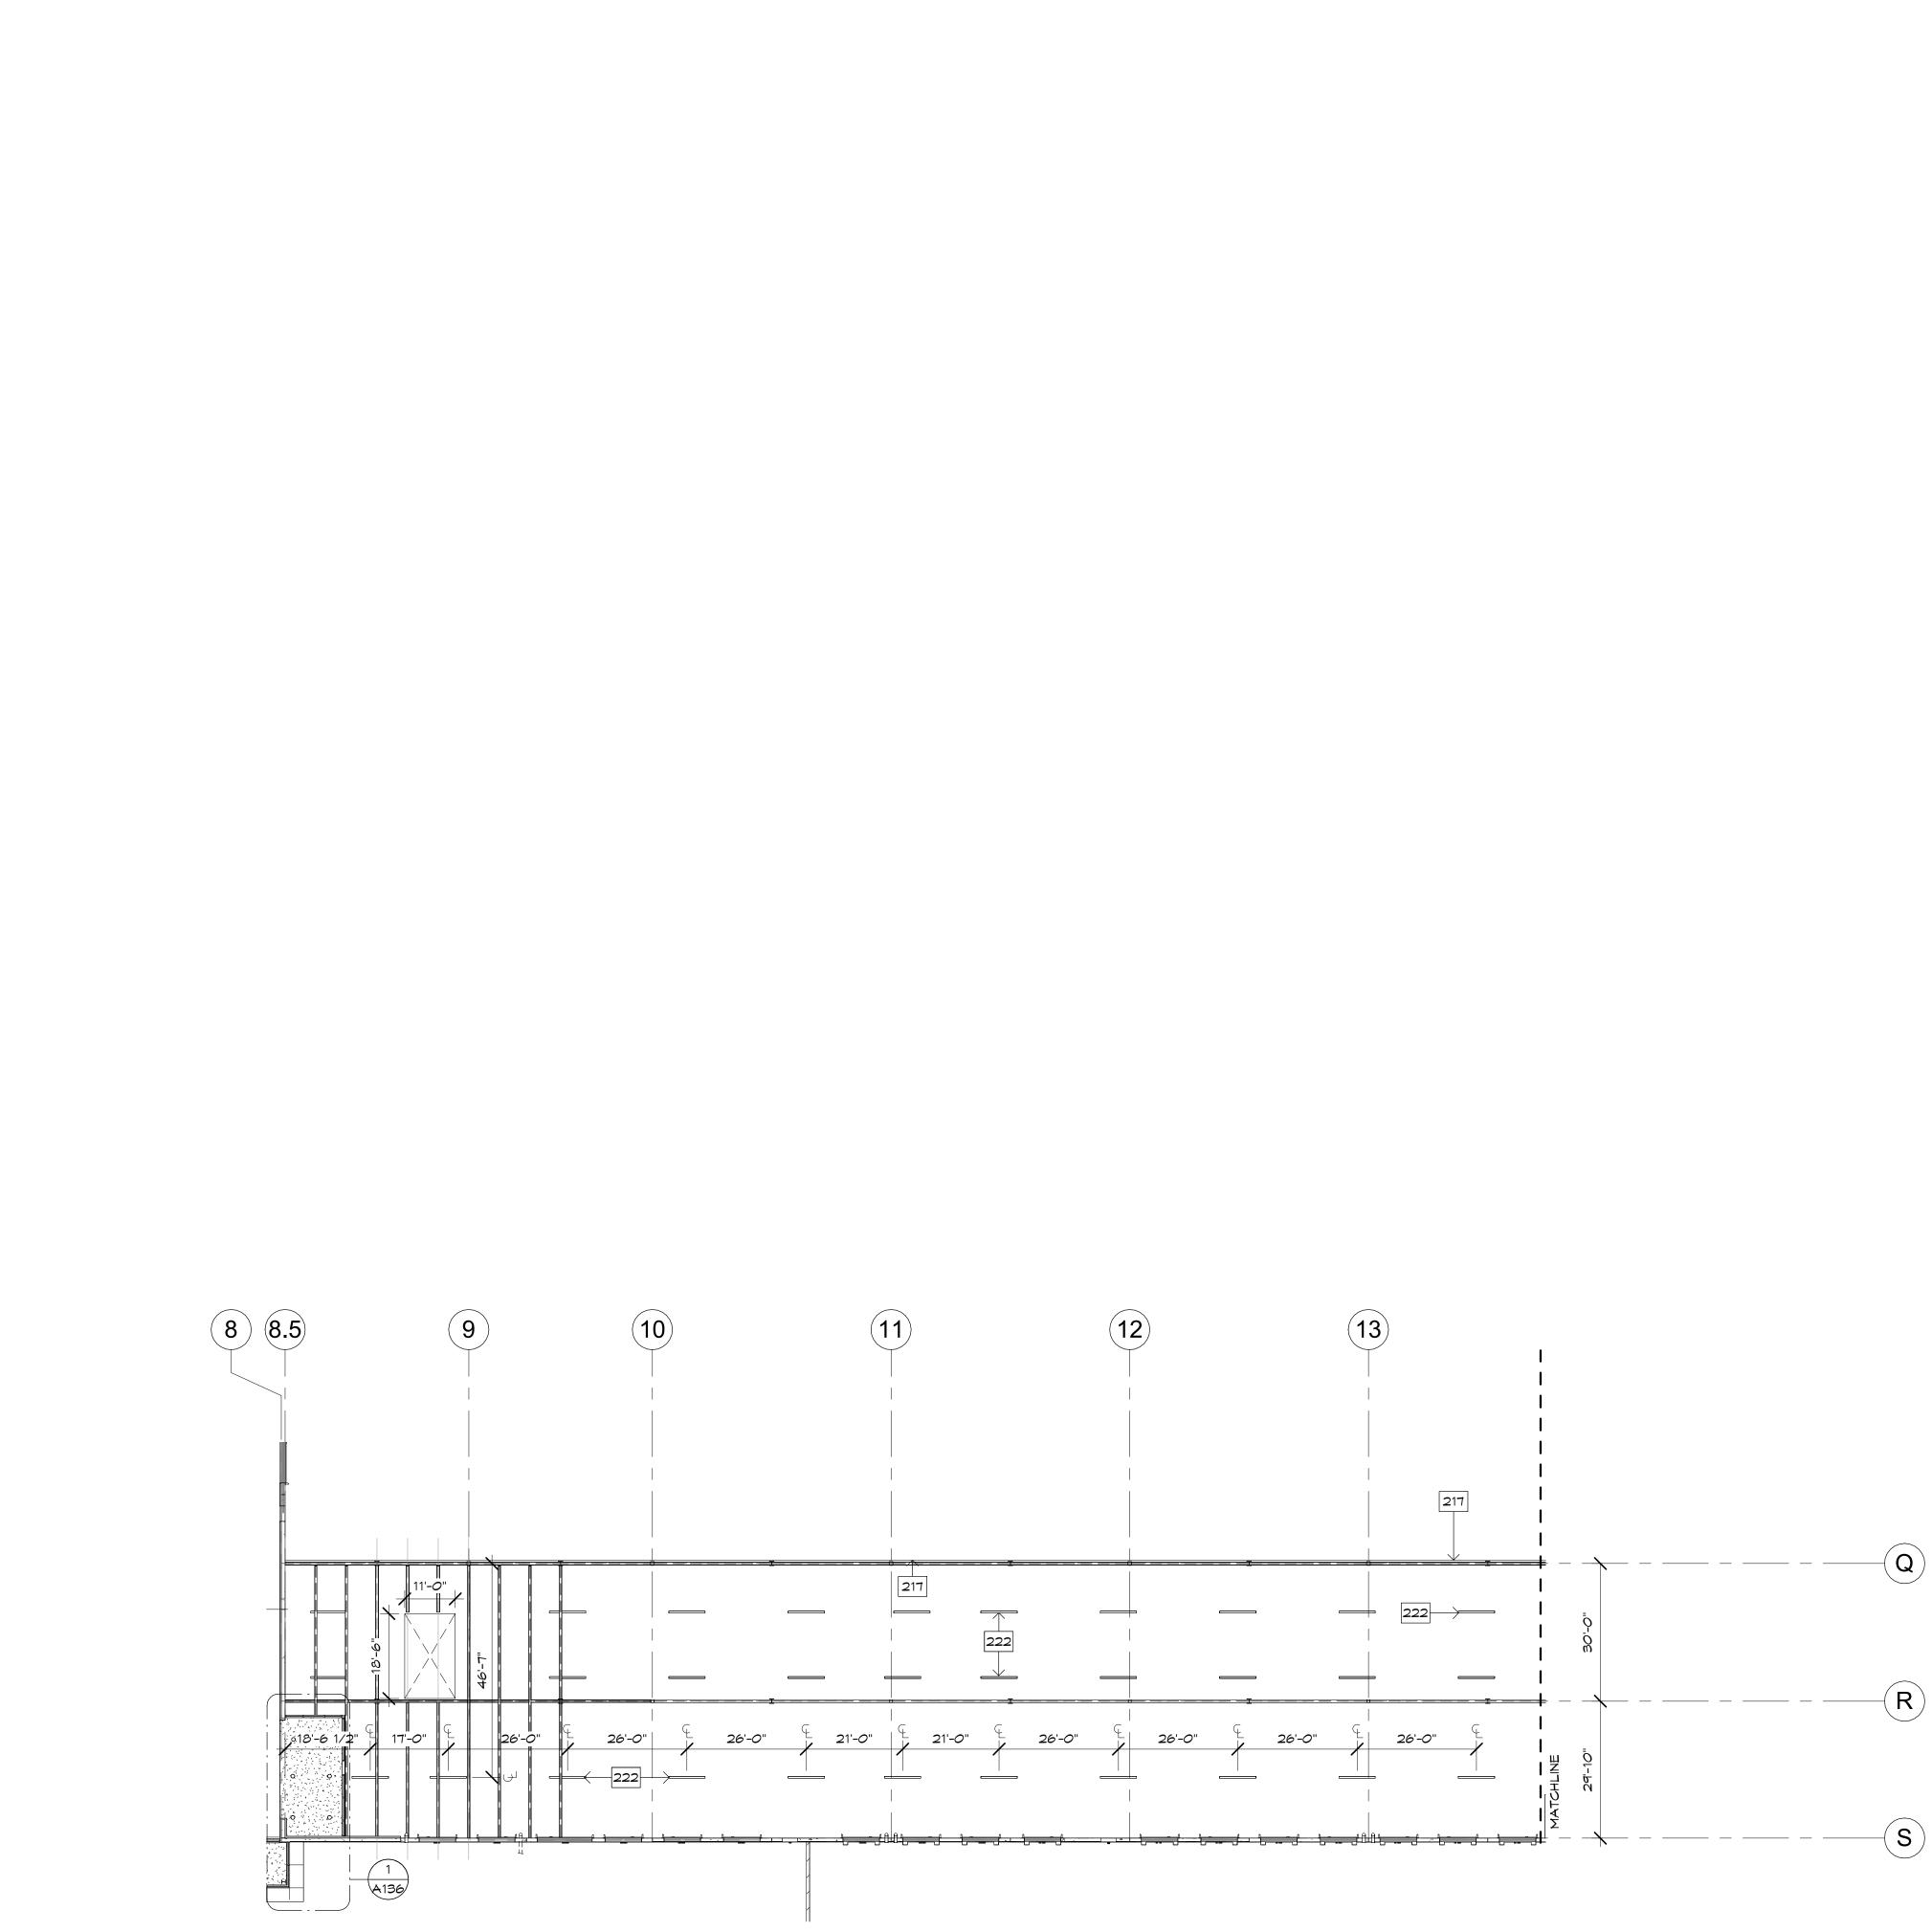




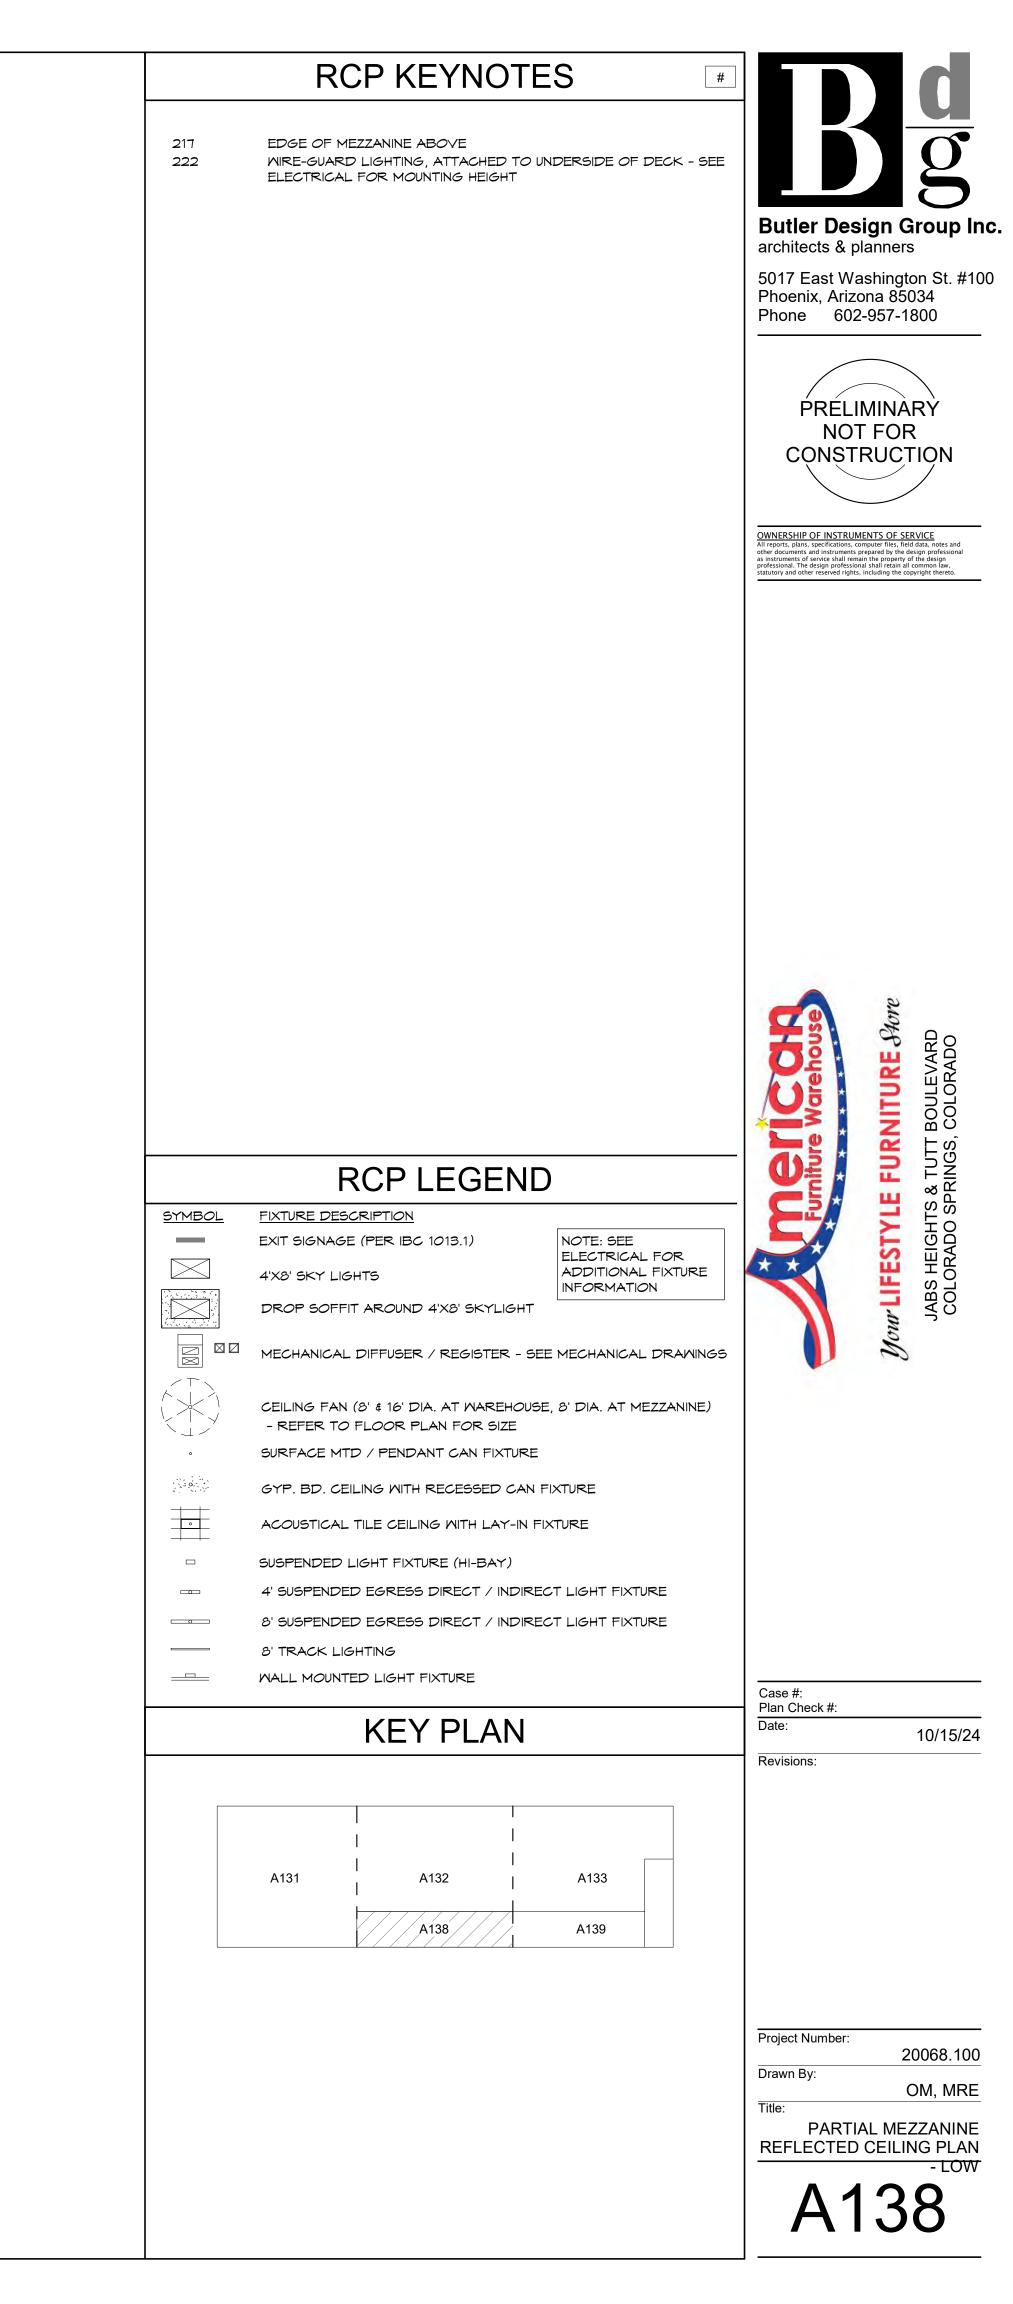


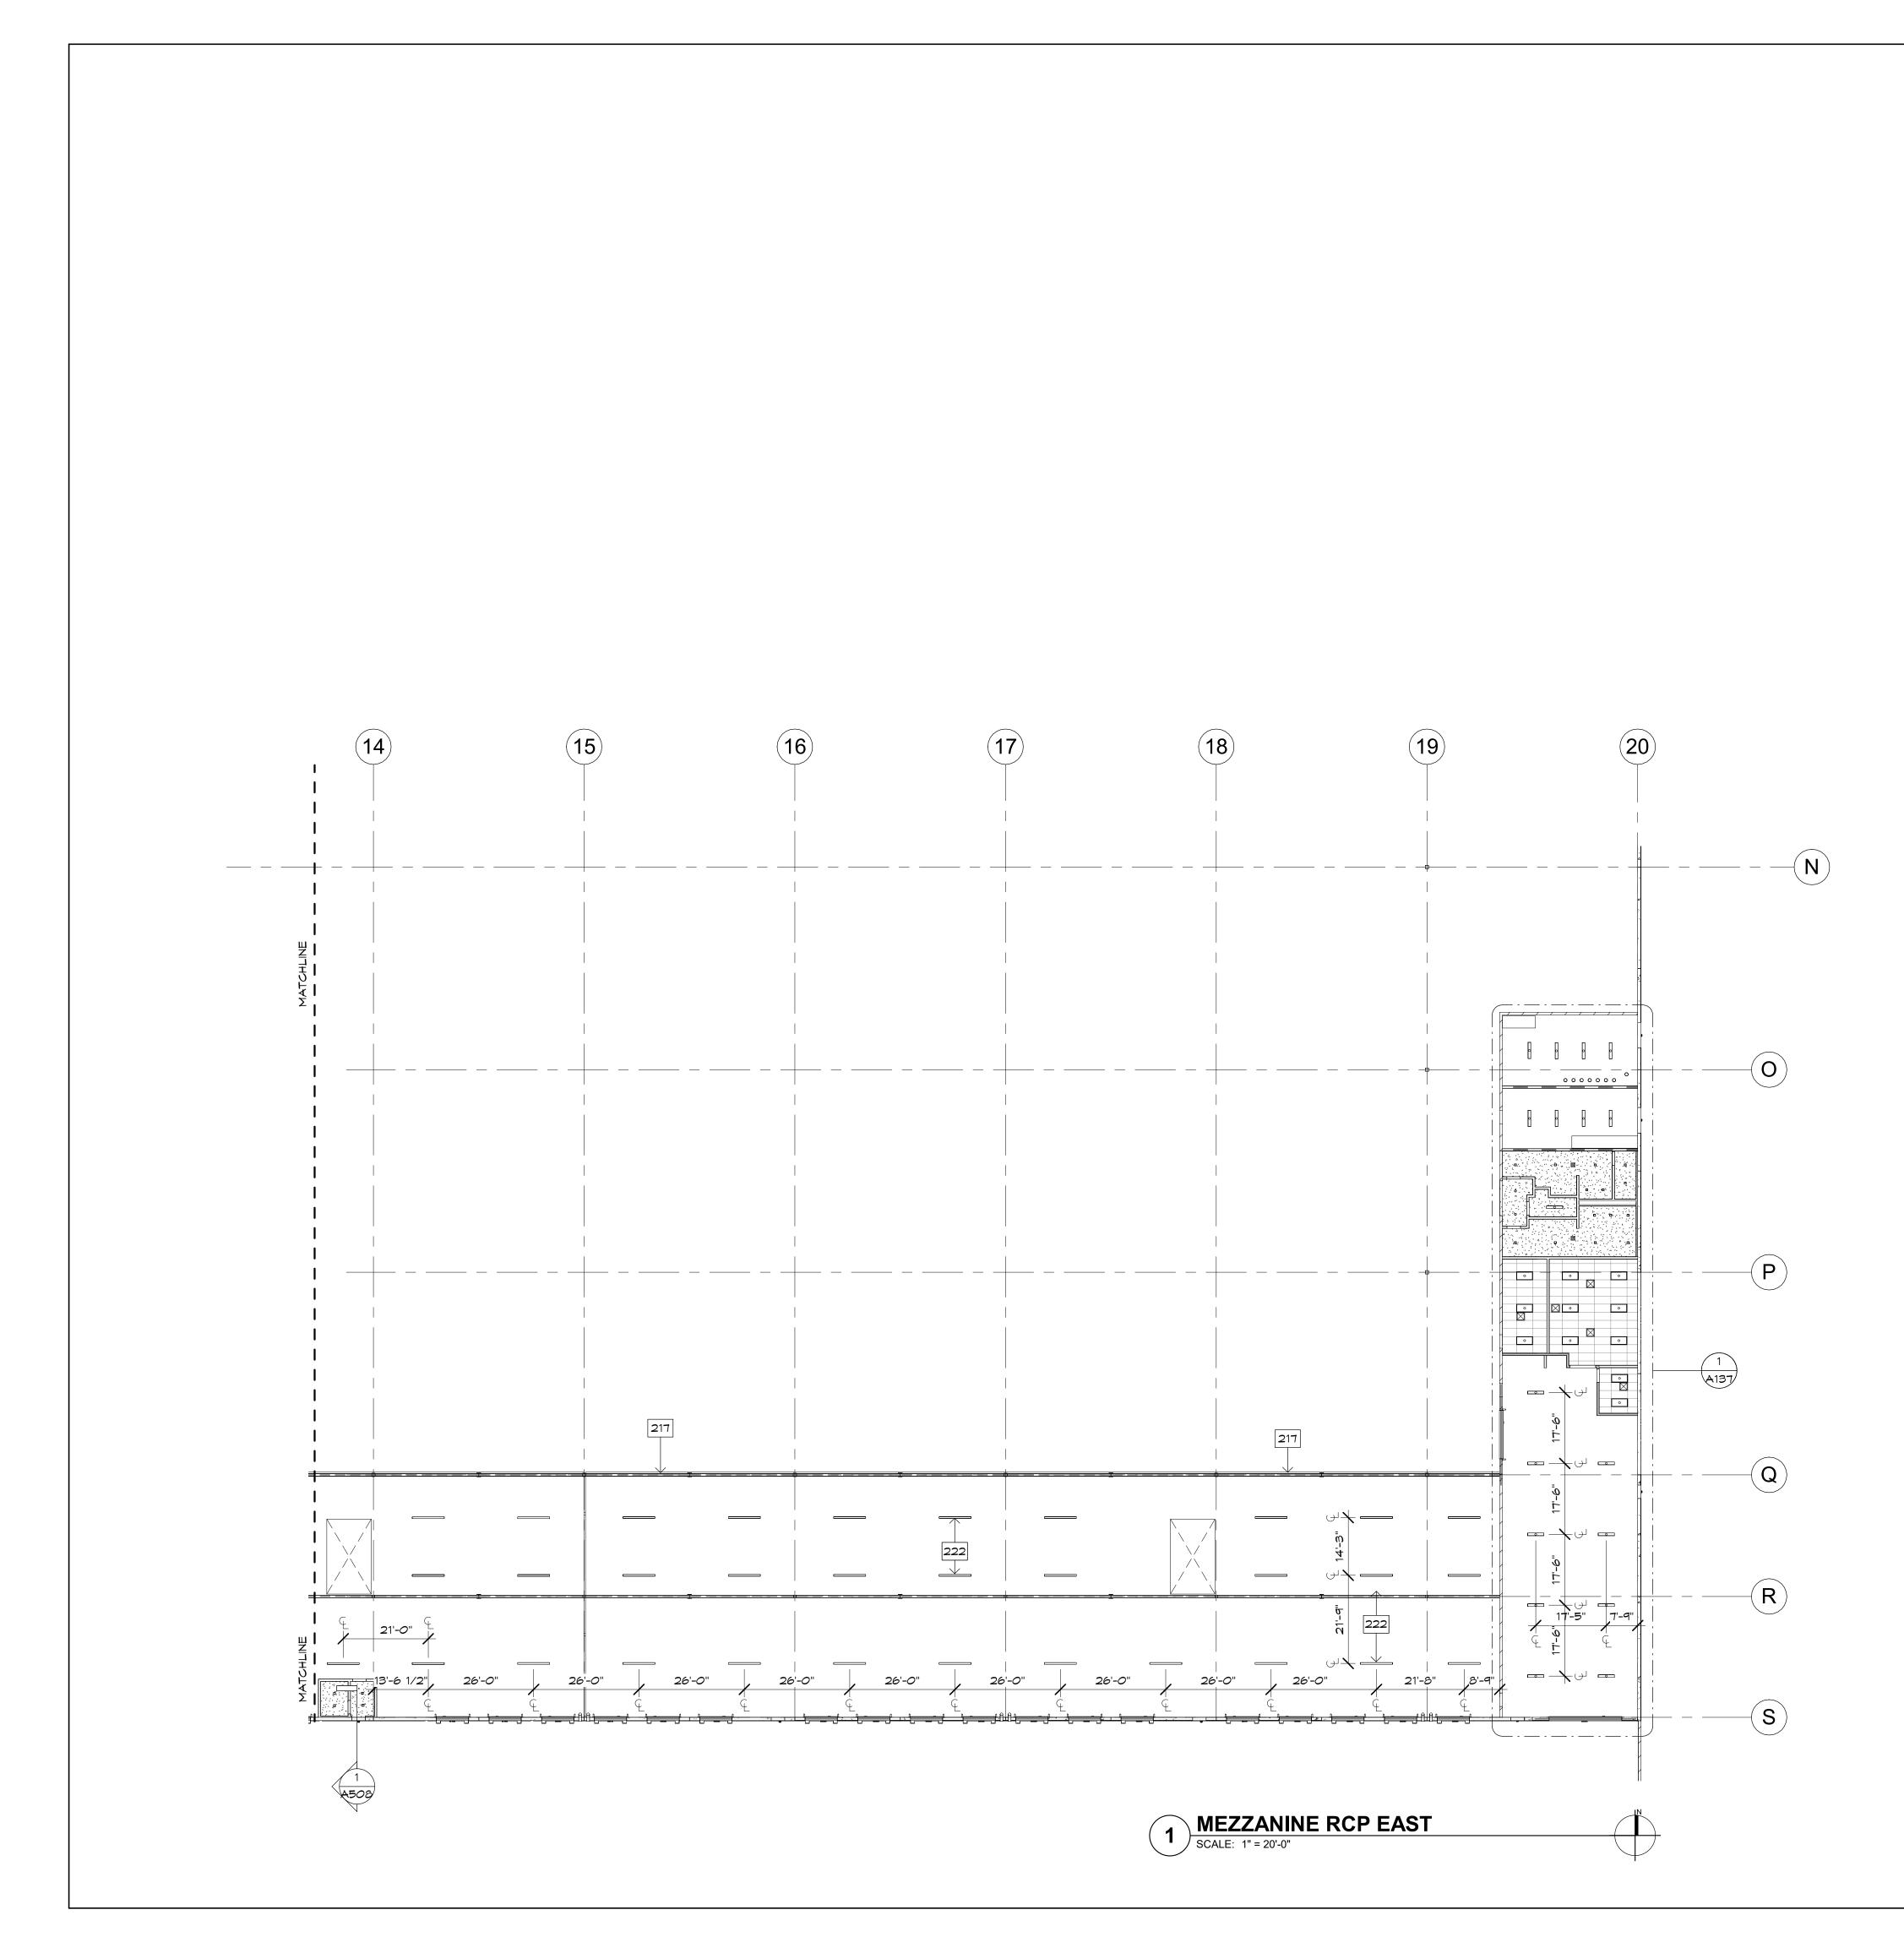

217	EDGE OF MEZZANINE ABOVE	
222	WIRE-GUARD LIGHTING, ATTACHED TO UNDERSIDE OF DECK - SEE ELECTRICAL FOR MOUNTING HEIGHT	Butler Design Group architects & planners 5017 East Washington St. Phoenix, Arizona 85034
		Phone 602-957-1800
		PRELIMINARY NOT FOR CONSTRUCTION
		OWNERSHIP OF INSTRUMENTS OF SERVICE All reports, plans, specifications, computer files, field data, notes ar other documents and instruments prepared by the design professio as instruments of service shall remain the property of the design professional. The design professional shall retain all common law, statutory and other reserved rights, including the copyright thereto.
		Store Store
		LE FURNITURE Store S& TUTT BOULEVARD SPRINGS, COLORADO
	RCP LEGEND	LE FUR
<u>SYMBOL</u>	FIXTURE DESCRIPTION         EXIT SIGNAGE (PER IBC 1013.1)         NOTE: SEE         ELECTRICAL FOR	WLIFESTYLE JABS HEIGHTS COLORADO SF
	4'X8' SKY LIGHTS DROP SOFFIT AROUND 4'X8' SKYLIGHT	
	MECHANICAL DIFFUSER / REGISTER - SEE MECHANICAL DRAWINGS	Nour JA
	CEILING FAN (8' & 16' DIA. AT WAREHOUSE, 8' DIA. AT MEZZANINE) - REFER TO FLOOR PLAN FOR SIZE SURFACE MTD / PENDANT CAN FIXTURE	
	GYP. BD. CEILING WITH RECESSED CAN FIXTURE	
	ACOUSTICAL TILE CEILING WITH LAY-IN FIXTURE SUSPENDED LIGHT FIXTURE (HI-BAY)	
	4' SUSPENDED EGRESS DIRECT / INDIRECT LIGHT FIXTURE	
	8' SUSPENDED EGRESS DIRECT / INDIRECT LIGHT FIXTURE 8' TRACK LIGHTING WALL MOUNTED LIGHT FIXTURE	Case #:
	KEY PLAN	Plan Check #: Date: 10/15
		Revisions:
	A131 A132 A133 A139	
		Project Number:
		20068. Drawn By:

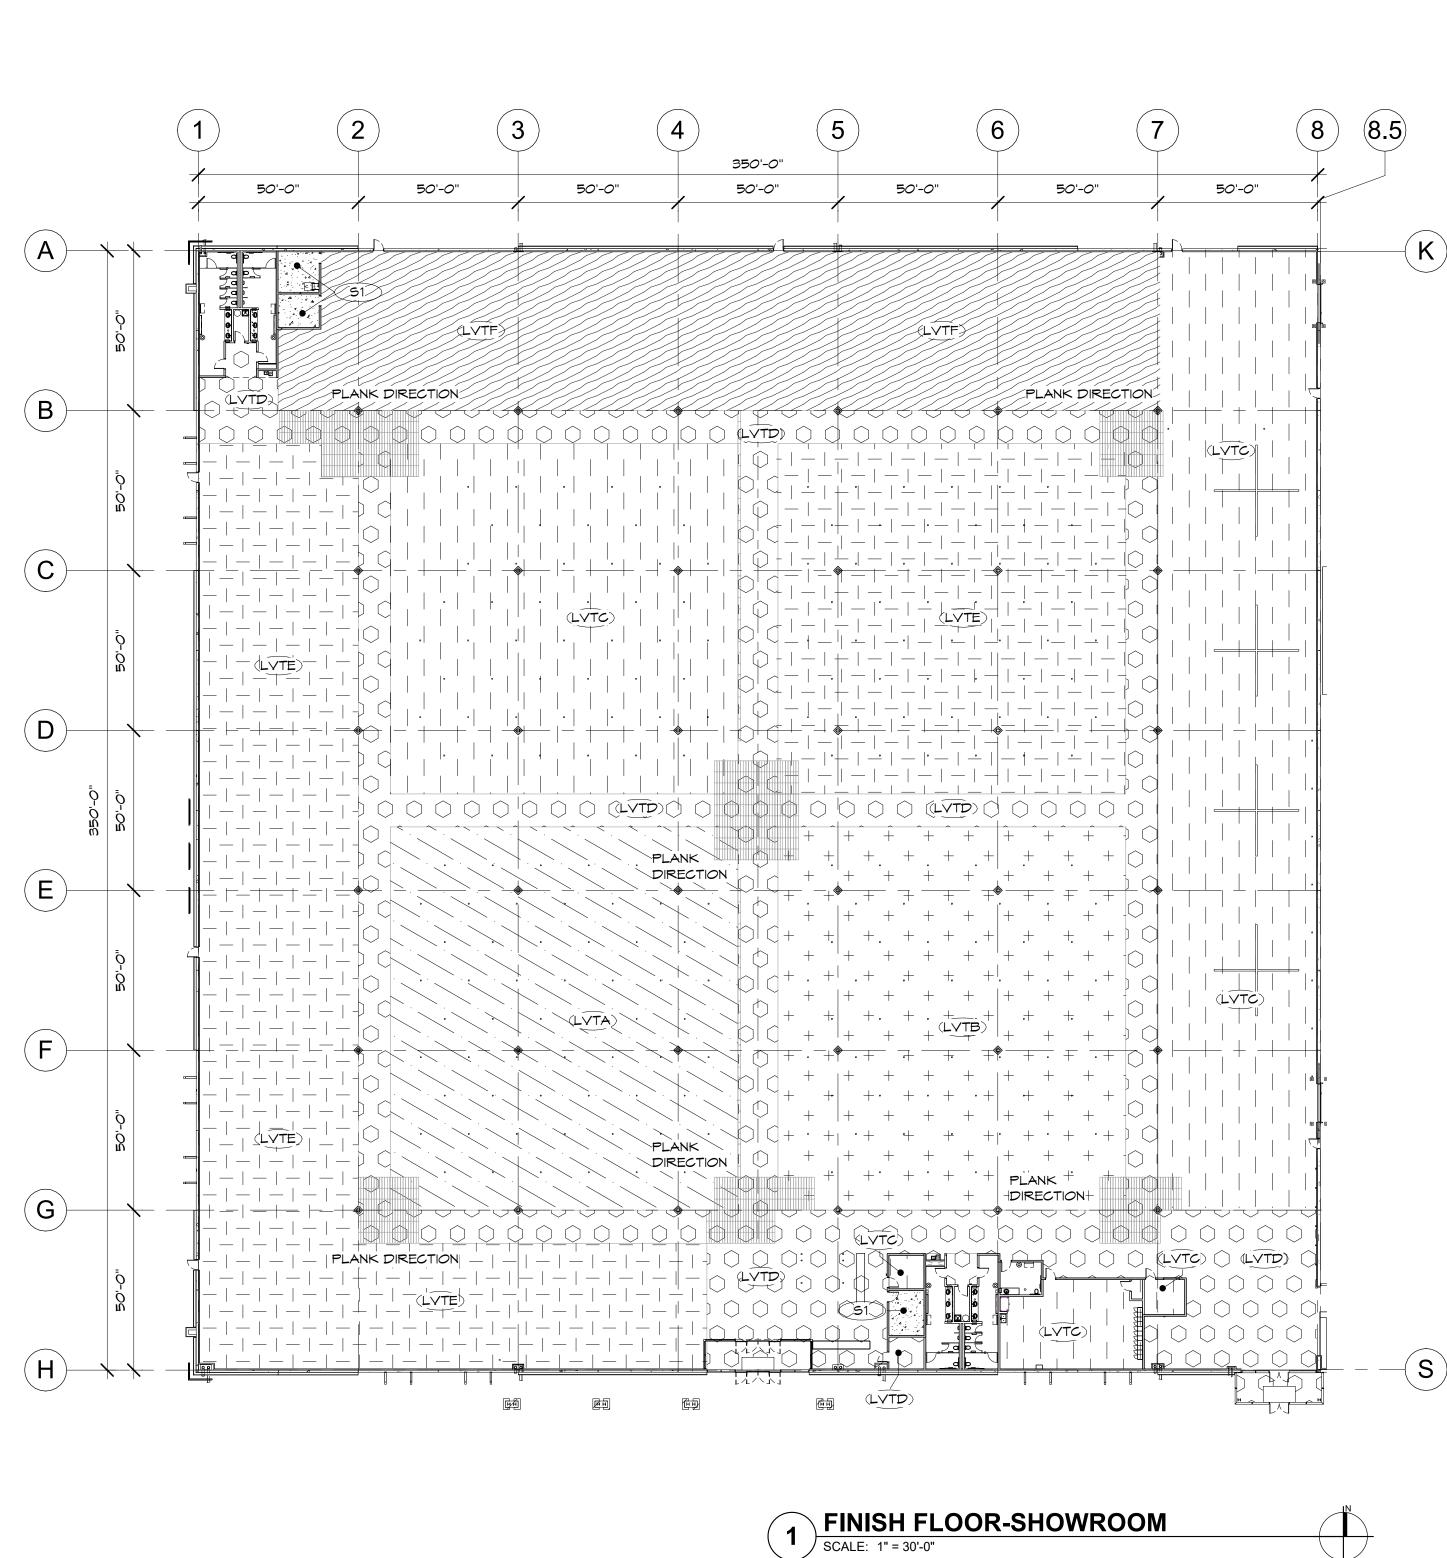

			FINISH MAT	ERIAL LEC	GEND		
FLOOR COVE CONCRETE F		-	LATICRETE L&M SEAL HARD	TILE GROUT G1	MANUFACTURER: PRODUCT: COLOR:	LATICRETE EPOXY GROUT 78 - STERLING SILVER	
		COLOR:	CLEAR	62	MANUFACTURER: PRODUCT: COLOR:	LATICRETE EPOXY GROUT	Butler Design Group Inc
LVTA		MANUFACTURER: STYLE:	KARNDEAN COMMERCIAL LOOSELAY			89 - SMOKE GRAY	architects & planners 5017 East Washington St. #100
		COLOR: SIZE: MANUFACTURER:	COUNTRY OAK - LLP92 9.85"x41.3" KARNDEAN COMMERCIAL		MANUFACTURER: LOCATION: COLOR:	DUNN EDWARDS WALLS DE6204 - TRITE WHITE	Phoenix, Arizona 85034 Phone 602-957-1800
+	+ +	STYLE: COLOR: SIZE:	LOOSELAY LINOSA-LLP148 9.85"x41.3"	P2	FINISH: MANUFACTURER: LOCATION:	FLAT DUNN EDWARDS CEILINGS	PRELIMINARY
		MANUFACTURER: STYLE: COLOR: SIZE:	KARNDEAN COMMERCIAL LOOSELAY ATHENS-LLP121 9.85"x41.3"	P3	COLOR: FINISH: MANUFACTURER:	DE6204 - TRITE WHITE FLAT DUNN EDWARDS	NOT FOR CONSTRUCTION
		MANUFACTURER: STYLE: COLOR: SIZE:	KARNDEAN COMMERCIAL LOOSELAY COLORADO LLT201 9.7"x24"	WALL PANELING	LOCATION: COLOR: FINISH:	TBD	OWNERSHIP OF INSTRUMENTS OF SERVICE All reports, plans, specifications, computer files, field data, notes and other documents and instruments prepared by the design professional as instruments of service shall remain the property of the design.
	⊤—] —   ·	MANUFACTURER: STYLE:	KARNDEAN COMMERCIAL LOOSELAY	FRP1	MANUFACTURER: PRODUCT:	MARLITE FIBERGLASS PANEL	professional. The design professional shall retain all common law, statutory and other reserved rights, including the copyright thereto.
	—	COLOR: SIZE:	SICILIA LLP142 9.85"x41.3"		COLOR: FINISH:	MHITE EMBOSSED	
LVTF		MANUFACTURER: STYLE: COLOR: SIZE:	KARNDEAN COMMERCIAL LOOSELAY INDIANA LLT202 9.7"x24"	LAY-IN CEILING TIL ACT1	MANUFACTURER: STYLE: COLOR:	ARMSTRONG COMMERCIAL 1733 - FINE FISSURED TEGULAR WHITE BRELLIDE 15 (16)	
	TILE	MANUFACTURER:	RAGNO USA		SUSPENSION GRID: SIZE:	24" X 48" X 5/8"	
		STYLE: COLOR: SIZE:	ALTAMERE SUMMIT GRAY - AL47 12"X24"	ACT2	MANUFACTURER: STYLE: COLOR: SUSPENSION GRID:		
PT2		MANUFACTURER: STYLE: COLOR:	EMERSON TILE UPTOWN HAMILTON	HARDLID CEILING	SIZE:	24" X 24" X 5/8"	
PT3		SIZE: MANUFACTURER: STYLE:	CRYSTAL STONE II	GB1	MANUFACTURER: FRAMING: FINISH: COLOR:	5/8" GYPSUM BOARD 6" - 18 GA STUDS at 24" O.C. SMOOTH LEVEL 5 - PAINTED DE6204 - TRITE WHITE	
		COLOR: SIZE/PATTERN:	PEARL - UL94 12"X12" - LINEAR MOSAIC	GB2	MANUFACTURER: FRAMING: FINISH:	5/8" GYPSUM BOARD 12" - 18 GA STUDS at 24" O.C. SMOOTH LEVEL 5 - PAINTED	
CARPET TILE		MANUFACTURER:	PHILADELPHIA COMMERCIAL	 	COLOR: MANUFACTURER:	DE6204 - TRITE WHITE 5/8" GYPSUM BOARD	
		STYLE: COLOR: SIZE:	QUEEN - CHANGE IN ATTITUDE - JO111 LIGHTEN UP - 12205 24"X24"		FRAMING: FINISH: COLOR:	3 5/8" - 25 GA STUDS at 16" O.C. SMOOTH LEVEL 5 - PAINTED DE6204 - TRITE WHITE	RNITURE & COLORADO
RESILIENT TIL		MANUFACTURER: STYLE: COLOR: SIZE:	ARMSTRONG COMMERCIAL EXCELON - STATIC DISSAPATIVE RIDGE - 51957 12"X12"				ICHTS & TUTT PADO SPRINGS,
ECO1		MANUFACTURER: STYLE: COLOR: SIZE:	ECOSURFACES ECONIGHTS MR. SLATE 20/601 23"X23" INTERLOCKING TILE	1. ALL EXPOSE	D SURFACES IN AREAS	SENERAL NOTES	
RESILIENT BA	ASE			OTHER TRAD	ES PRIOR TO PAINTING	BURFACE TREATMENTS PROVIDED BY G. BE DONE IN ACCORDANCE WITH THE	
B1		MANUFACTURER: STYLE: COLOR: SIZE:	JOHNSONITE TARKETT VINYL - COVE BLACK - 40 4"	MANUFACTUR 3. ALL PAINTED AND TWO AD SMOOTH AND	ER'S PRODUCT DATA SURFACES, EXCLUDIN DITIONAL COATS OF C EVEN IN COLOR, AND	LITERATURE AND LABEL INSTRUCTIONS G CEILING, MUST HAVE ONE COAT PRIN COLOR. FINISH SHOULD BE CLEAN, DRY D FREE OF ANY DIRT OR ADDITIONAL G AND SANDING SHOULD NOT TAKE PLA	IER 7,
B2		STYLE: COLOR:	JOHNSONITE TARKETT VINYL - TOP SET EXPRESSO - 132	SETTLE OVER 4. ALL PAINTED PUNCHLIST M	RNIGHT PRIOR TO BEG SURFACES MUST HAV ALK OR THEY WILL BE	MUST BE COMPLETED AND DUST MUST BINNING PAINTING. E A SMOOTH, CLEAN APPEARANCE DUR E REQUIRED TO BE REPAINTED AT NO	RING
PLASTIC LAN		SIZE:	·	AND FURNITUI	TRIP FOR TOUCH UP F	PAINT AFTER FLOORING INSTALLATION UP PAINT SHOULD BE LEFT IN THE OWN ED.	ERS
PL1		MANUFACTURER: COLOR: FINISH:	FORMICA STORM SOLIDZ 3505 SCULPTED	6. CONCRETE F CONCRETE T AND PROTRU 7. NO PIECE OF	LOORS ARE TO BE LE O A SMOOTH MONOLI JSIONS. BASE TO BE LESS TH	AN 12" LONG AND SEAMS ARE NOT USE PREMOULDED CORNERS -TYPICAL	
PL2		MANUFACTURER: COLOR: FINISH:	LAMIN-ART WILSONART LUNAR SANDSTORM 241-T TEXTURE	TRANSITION S INSTALL ADA DESIGNER FO 9. FLOORING IS	STRIP. WHERE TWO MA COMPLIANT REDUCER OR SELECTION. TO BE INSTALLED PA	ISITIONS PROVIDE ADA COMPLIANT ITERIALS OF DIFFERING HEIGHTS MEET, R STRIP. SUBMIT COLOR CHOICE TO IRALLEL TO SURROUNDING WALLS UNLE	Date: 10/15/24
PL3		MANUFACTURER: COLOR: FINISH:	PIONITE - PANOLAM SABLE AGO21 - SD TEXTURED SUEDE	OCCUR DIREC POSITION. 11. AT CASED OF DISSIMILAR M	PENINGS, TRANSITION E CTLY AT THE CENTERL PENING LOCATIONS, TH 1ATERIALS IS TO OCCU	BETWEEN DISSIMILAR MATERIALS IS TO INE OF THE DOOR IN THE CLOSED RANSITION BETWEEN CARPET AND JR AT THE CENTERLINE OF THE OPENING TO OCCUR AT INSIDE CORNERS ONLY.	G.
PL4		MANUFACTURER: COLOR: FINISH:	LAMIN-ART WILSONART LUNAR SANDSTORM - 241C CORREGATED	DISCREPANC 13. CONTRACTO DISSIMILAR M SUBMITTED F	IES ARE TO BE REVIEW R TO PROVIDE ALL NE 1ATERIALS. TRANSITIO OR APPROVAL.	NED WITH THE ARCHITECT. ECESSARY TRANSITION STRIPS BETWEE N STRIP MATERIALS ARE TO BE	
COUNTERTOR SS1	P SURF	ACE MATERIAL: GRADE:	STAINLESS STEEL 304	EDGES		PLAN	
		GAUGE: FINISH:	16 GA. NO. 4 BRUSHED				Project Number:
552		MANUFACTURER MATERIAL: COLOR: FINISH:	AVONITE 12mm ACRYLIC RESIN CLOUDBURST - 7746 SEMIGLOSS	A144	A142 A142 A142	46 A147	20068.100 Drawn By: OM, MRE Title:
		MANUFACTURER	AVONITE		A143 /		SHOWROOM FINISHES FLOOR PLAN

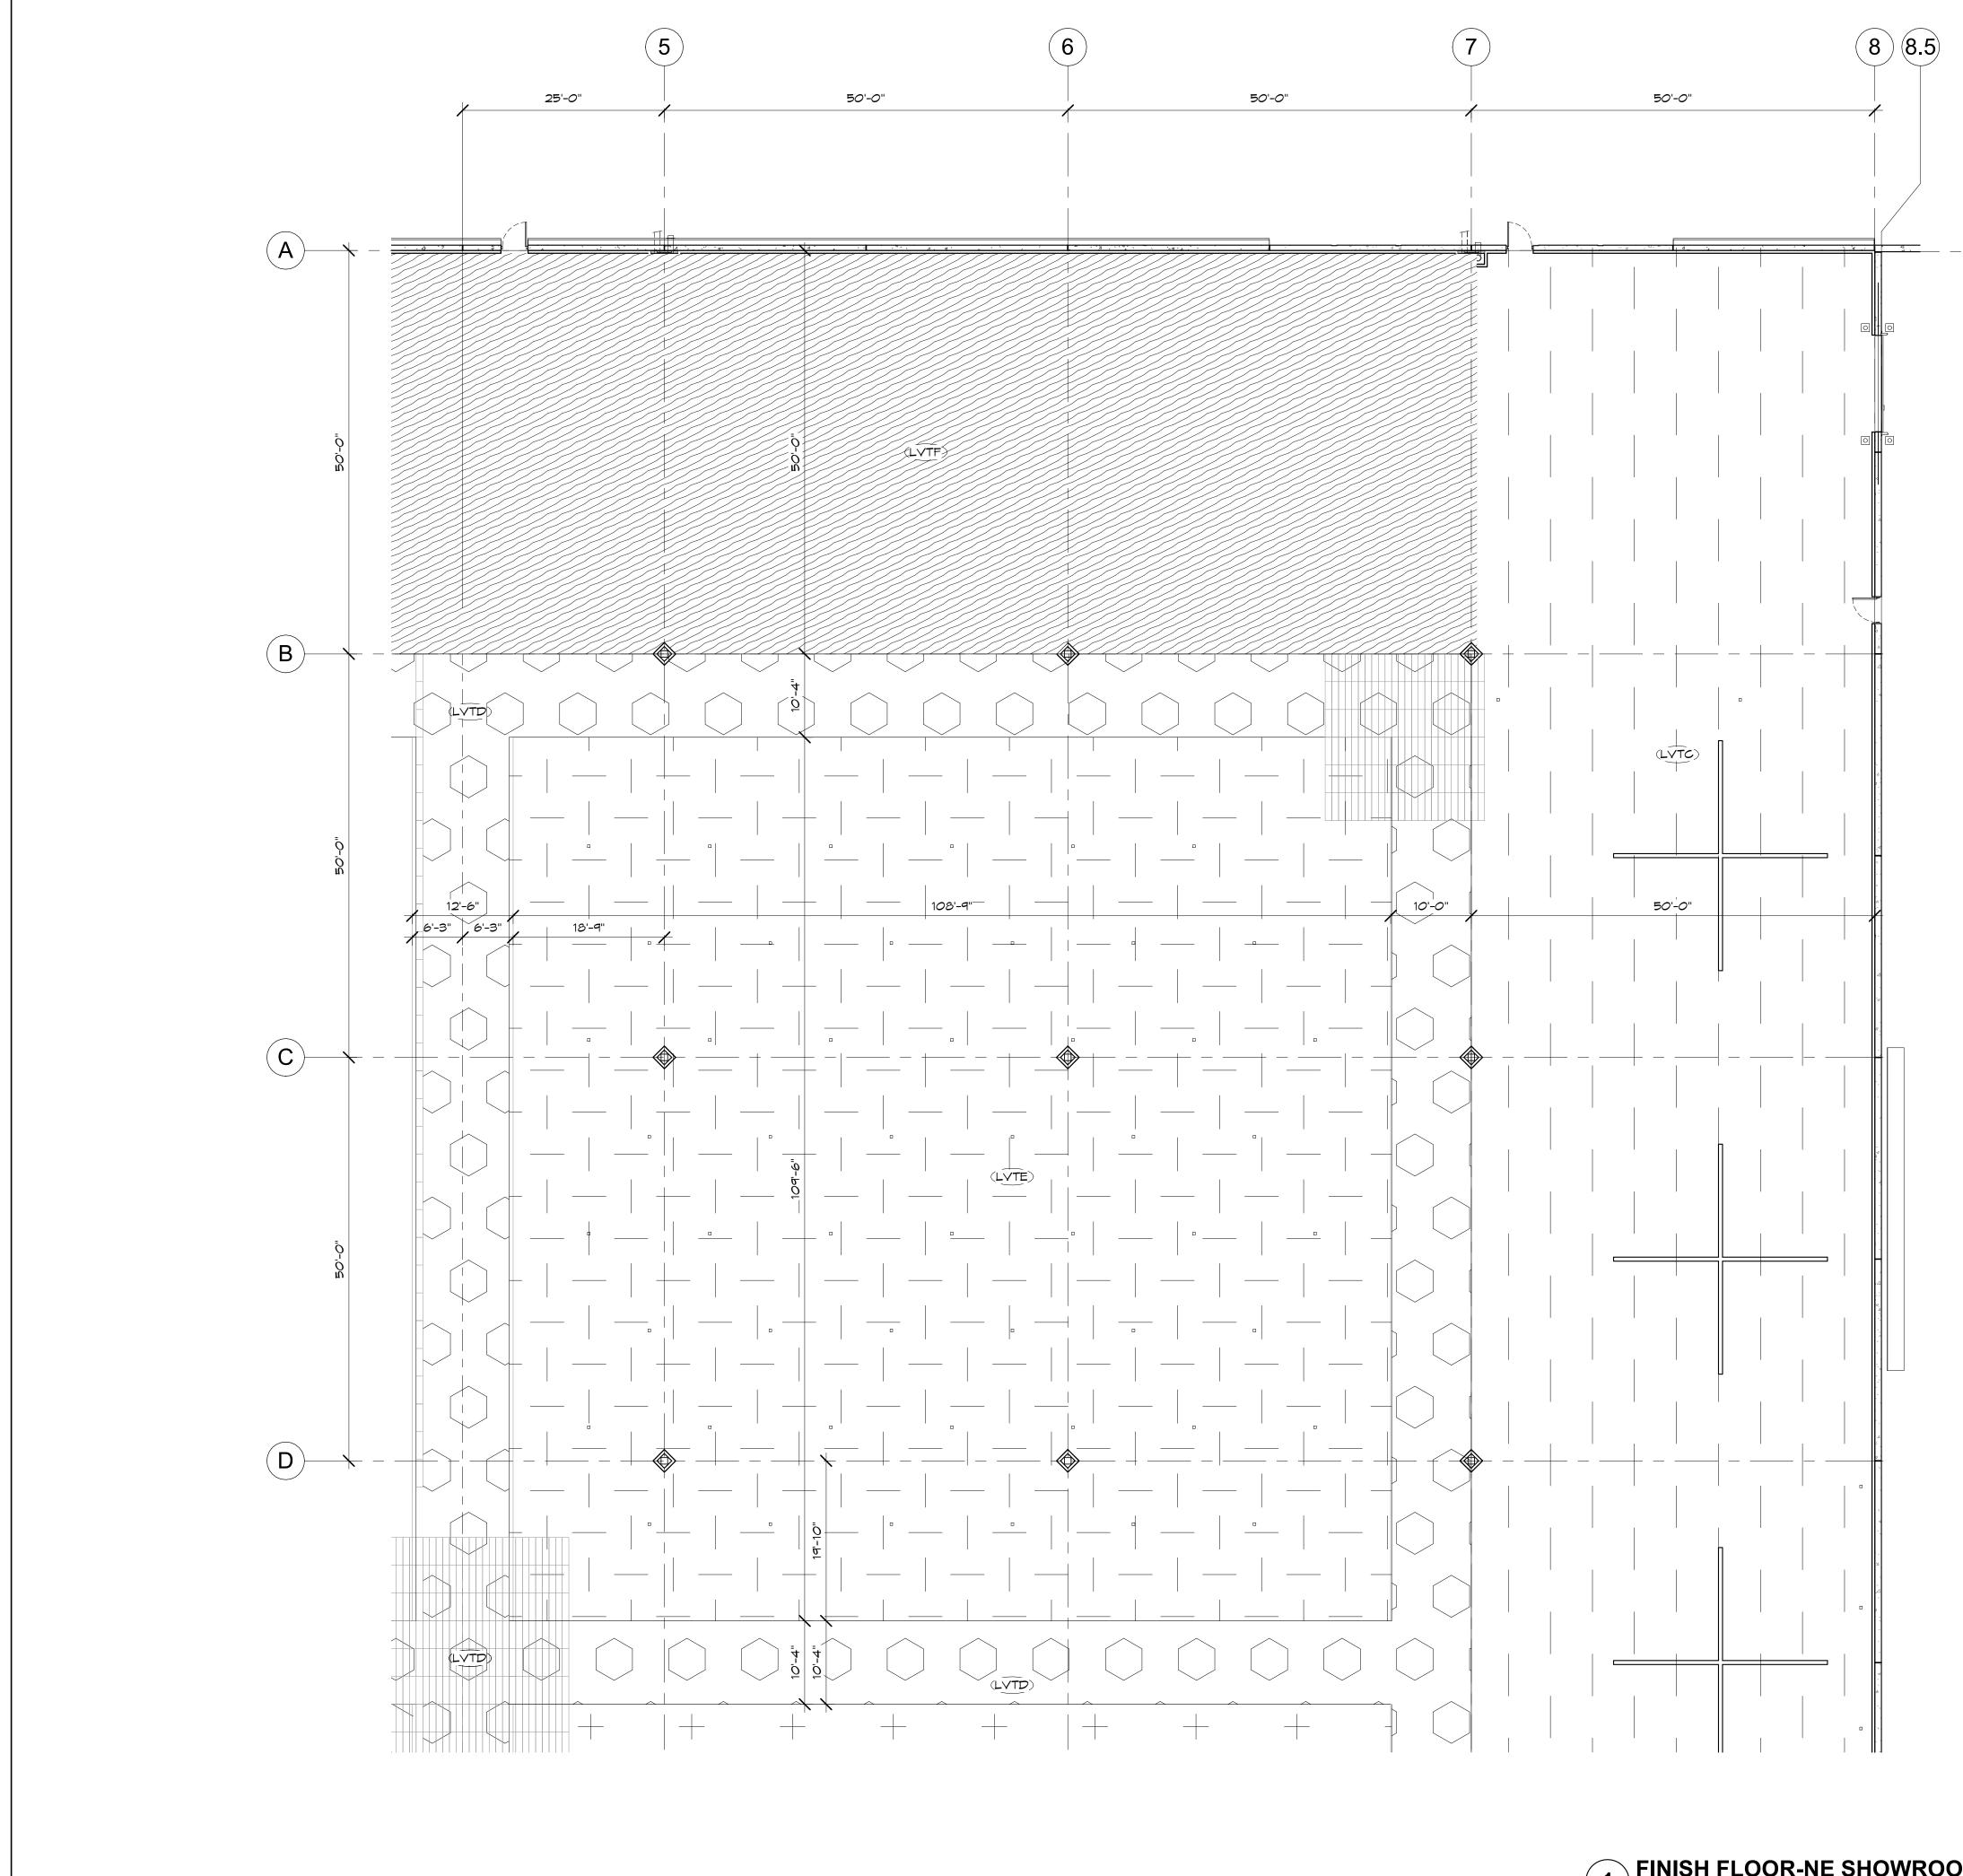


1 FINISH FLOOR-NE SHOWROOM SCALE: 3/32" = 1'-0"





5017 East Washington St. #100 Phoenix, Arizona 85034 Phone 602-957-1800

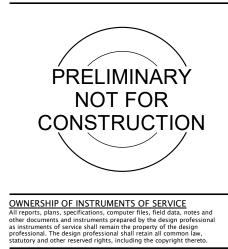







Case #: Plan Check #: Date: 10/15/24 Revisions:

Project Number:	
	20068.100
Drawn By:	
	OM
Title:	
SHOWROC	OM FINISHES
ENLARGED F	FLOOR PLAN
	_
A1	42

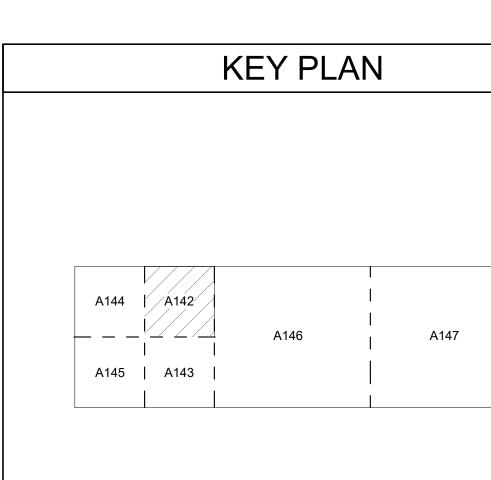




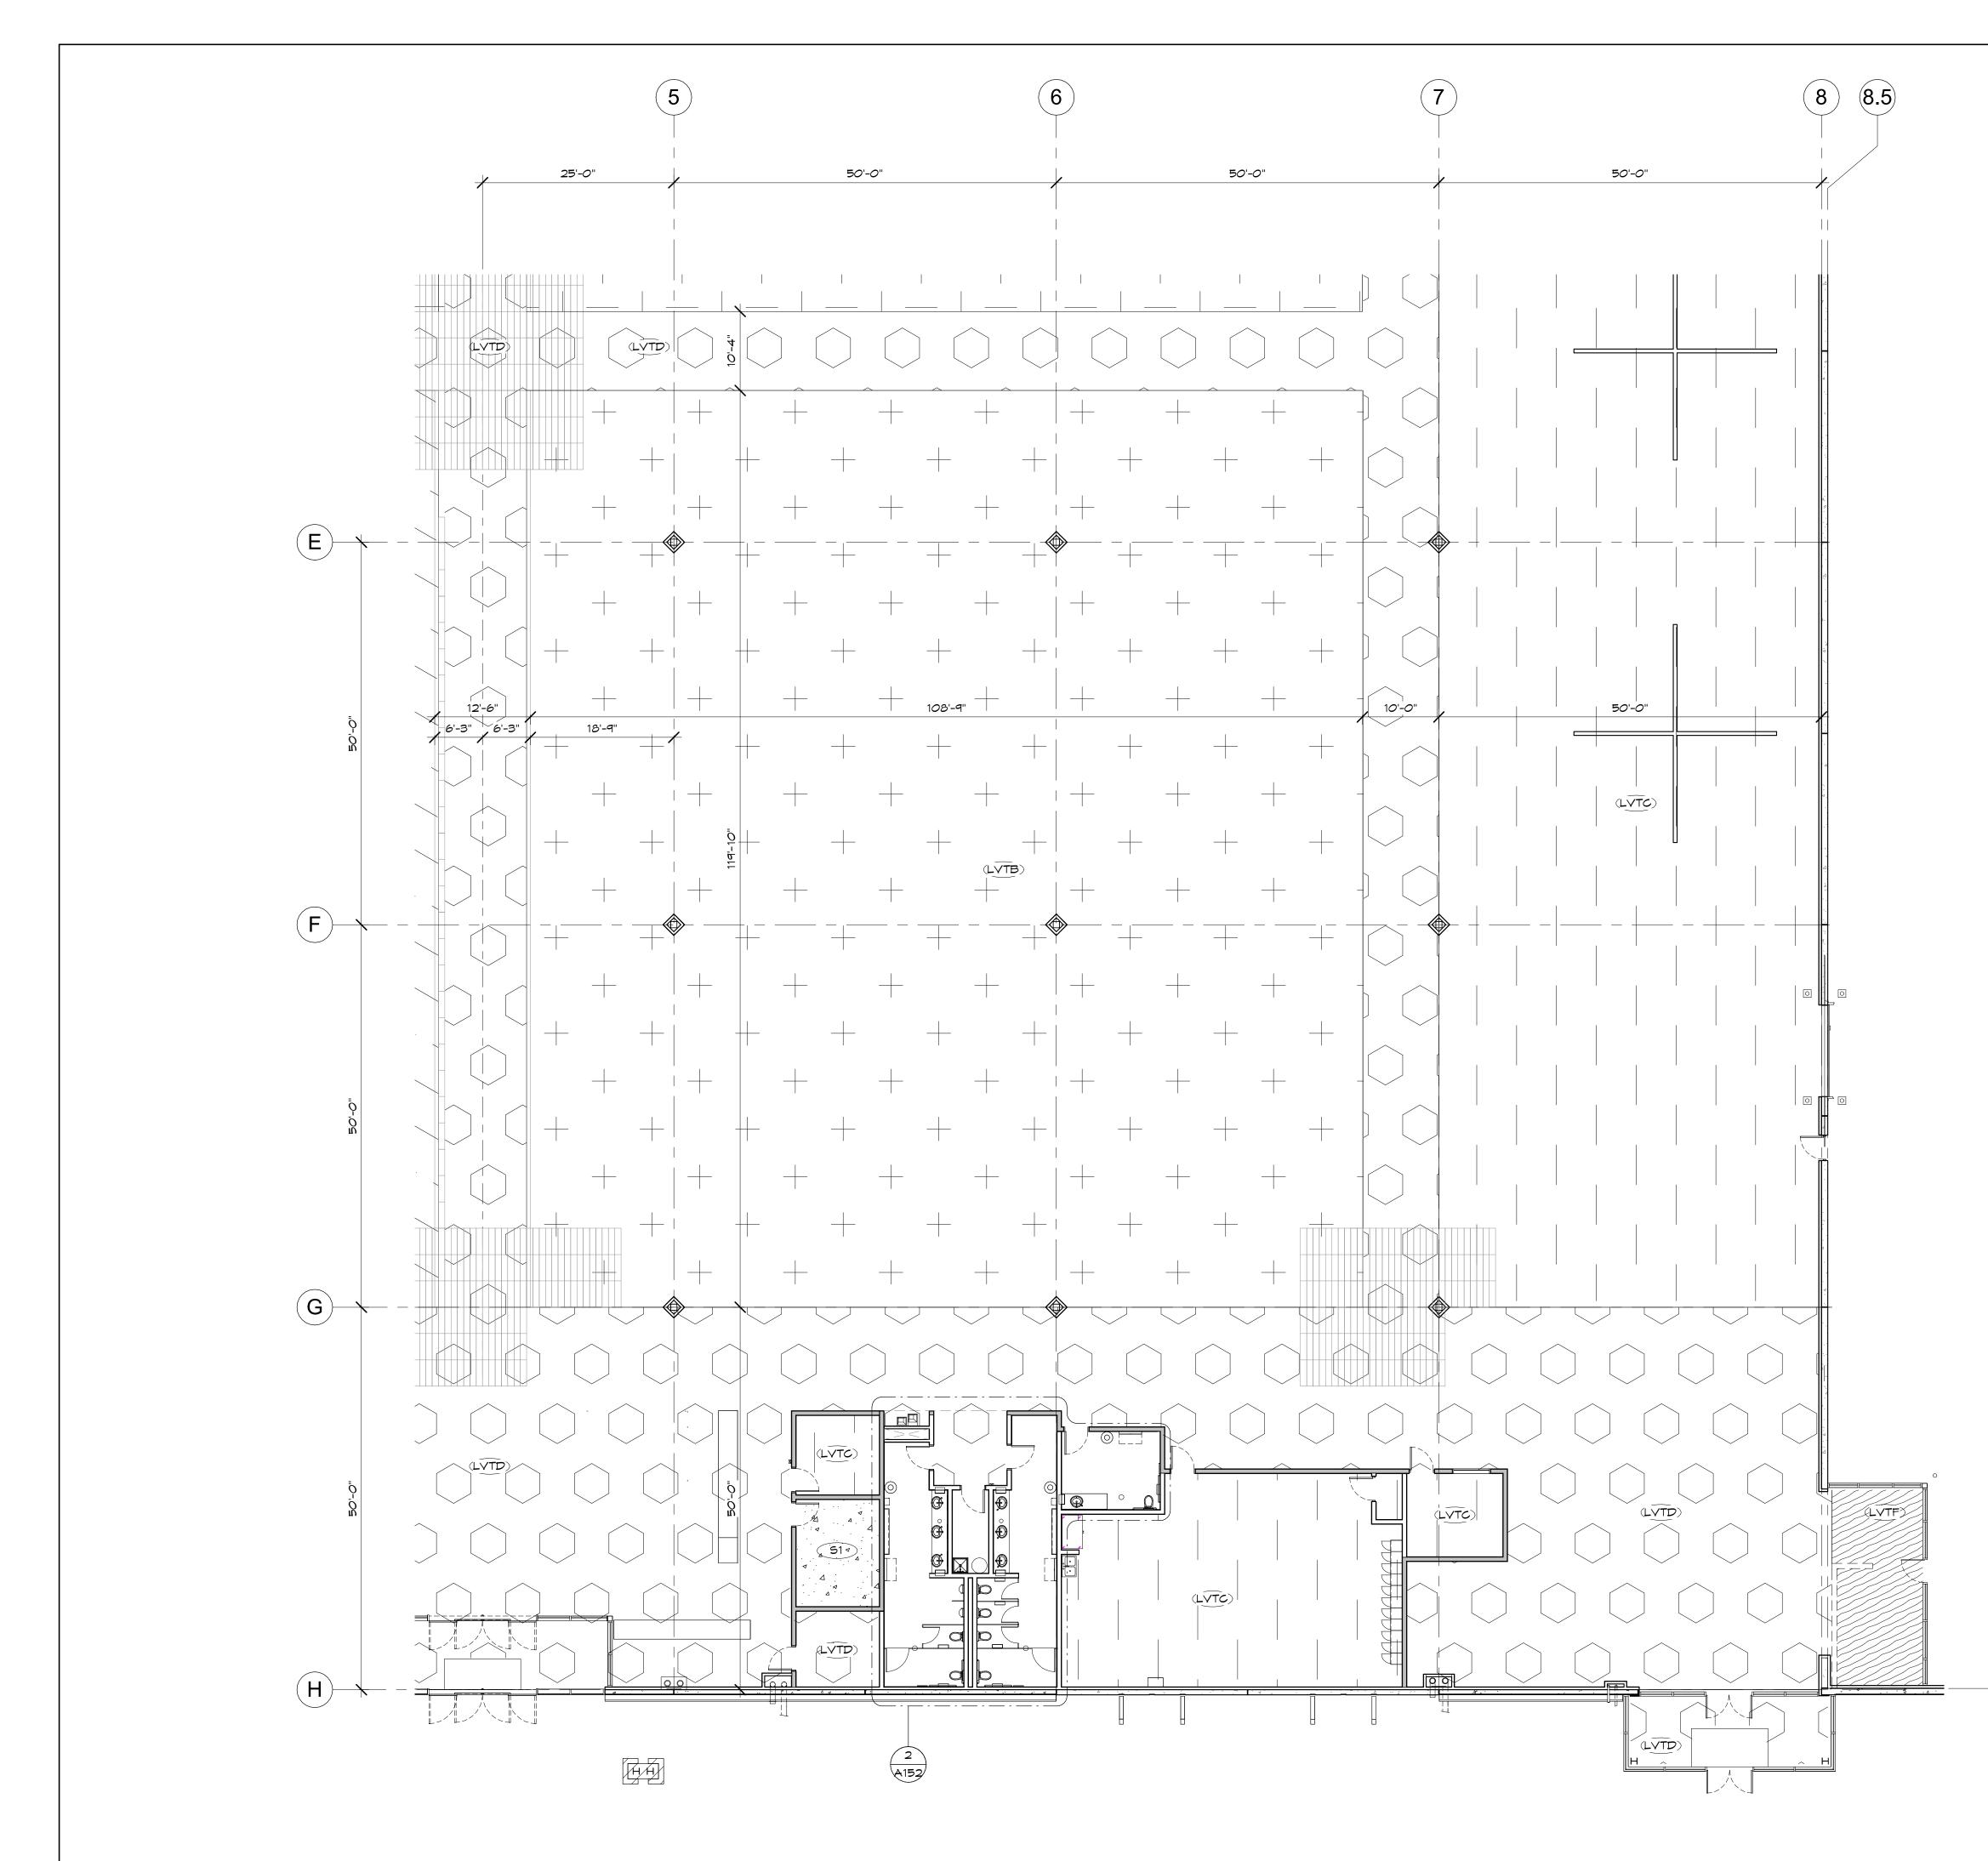




 $\square$ 



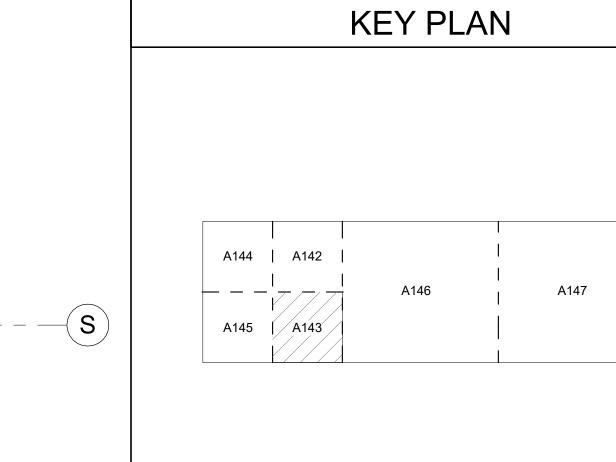



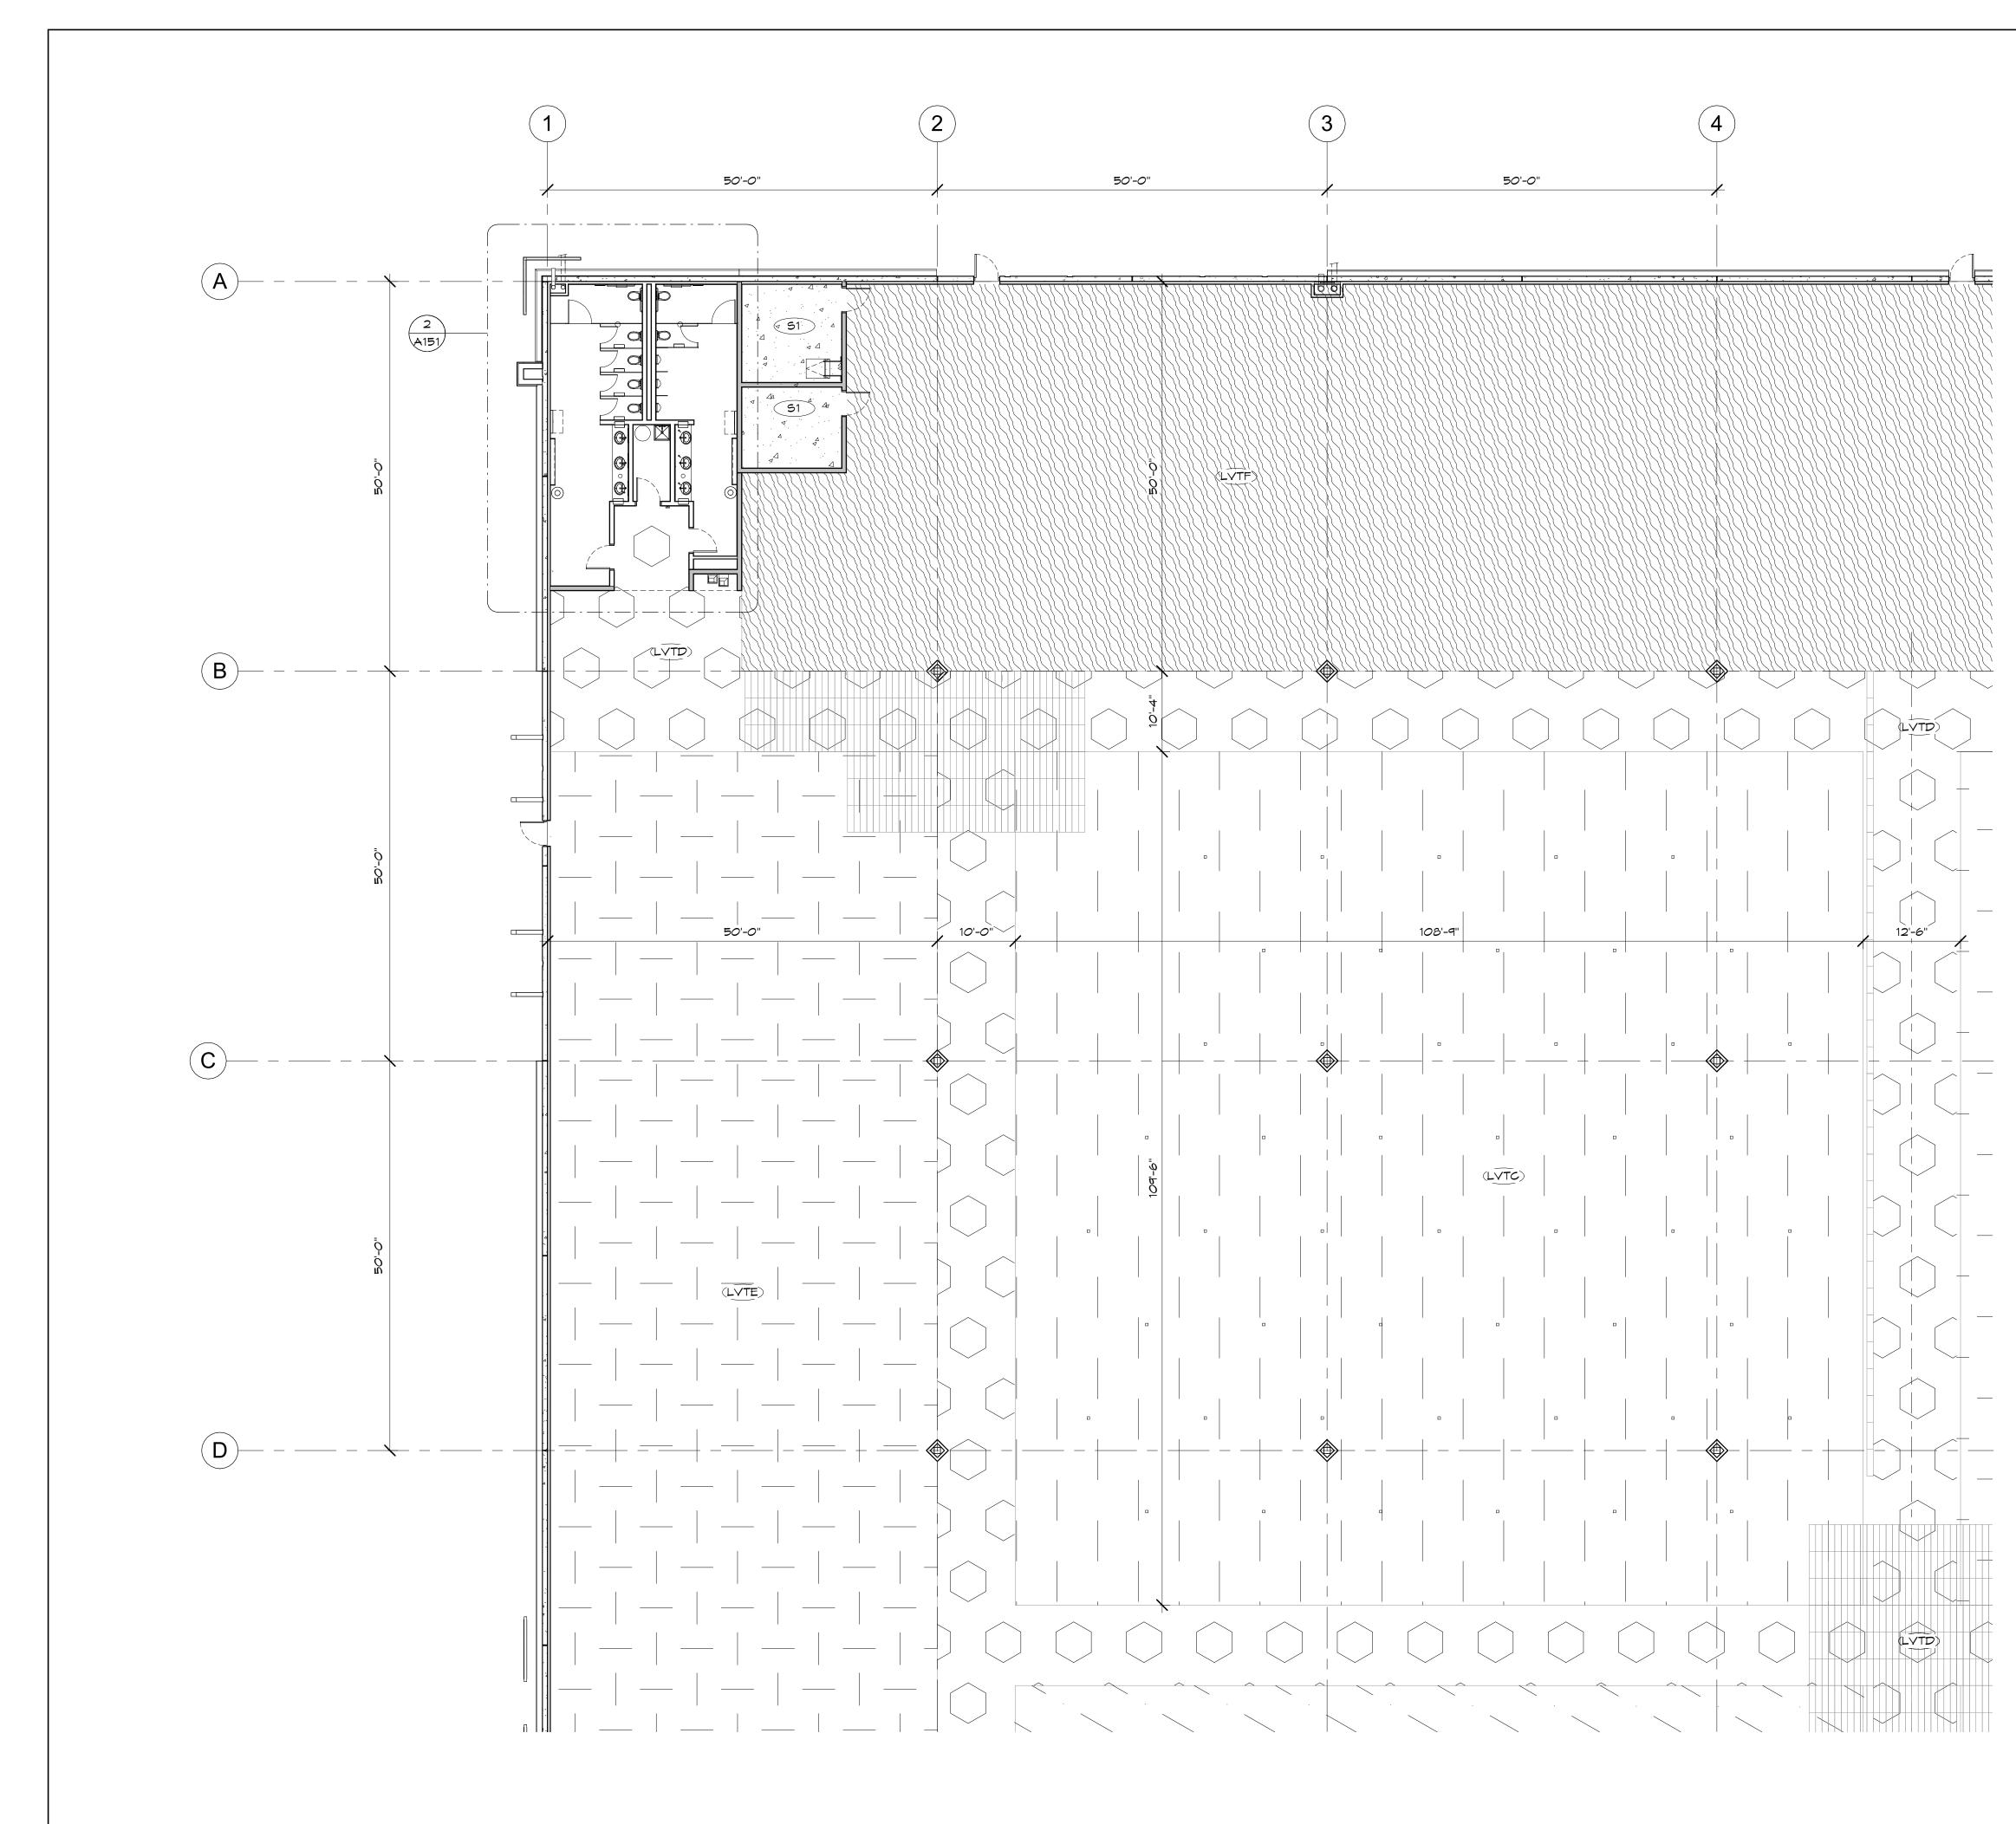

1 FINISH FLOOR-NW SHOWROOM SCALE: 3/32" = 1'-0"




5017 East Washington St. #100 Phoenix, Arizona 85034 Phone 602-957-1800









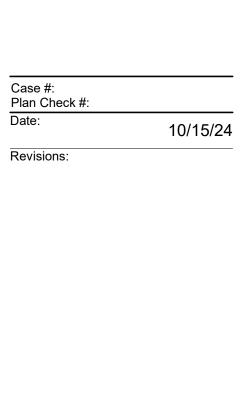

_	
Project Number:	
	20068.100
Drawn By:	
	OM
Title:	
	OM FINISHES
ENLARGED	FLOOR PLAN
A1	44



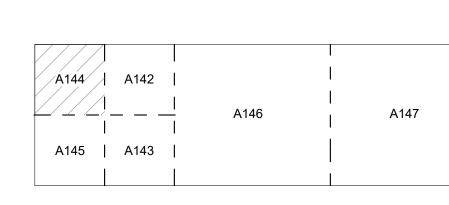


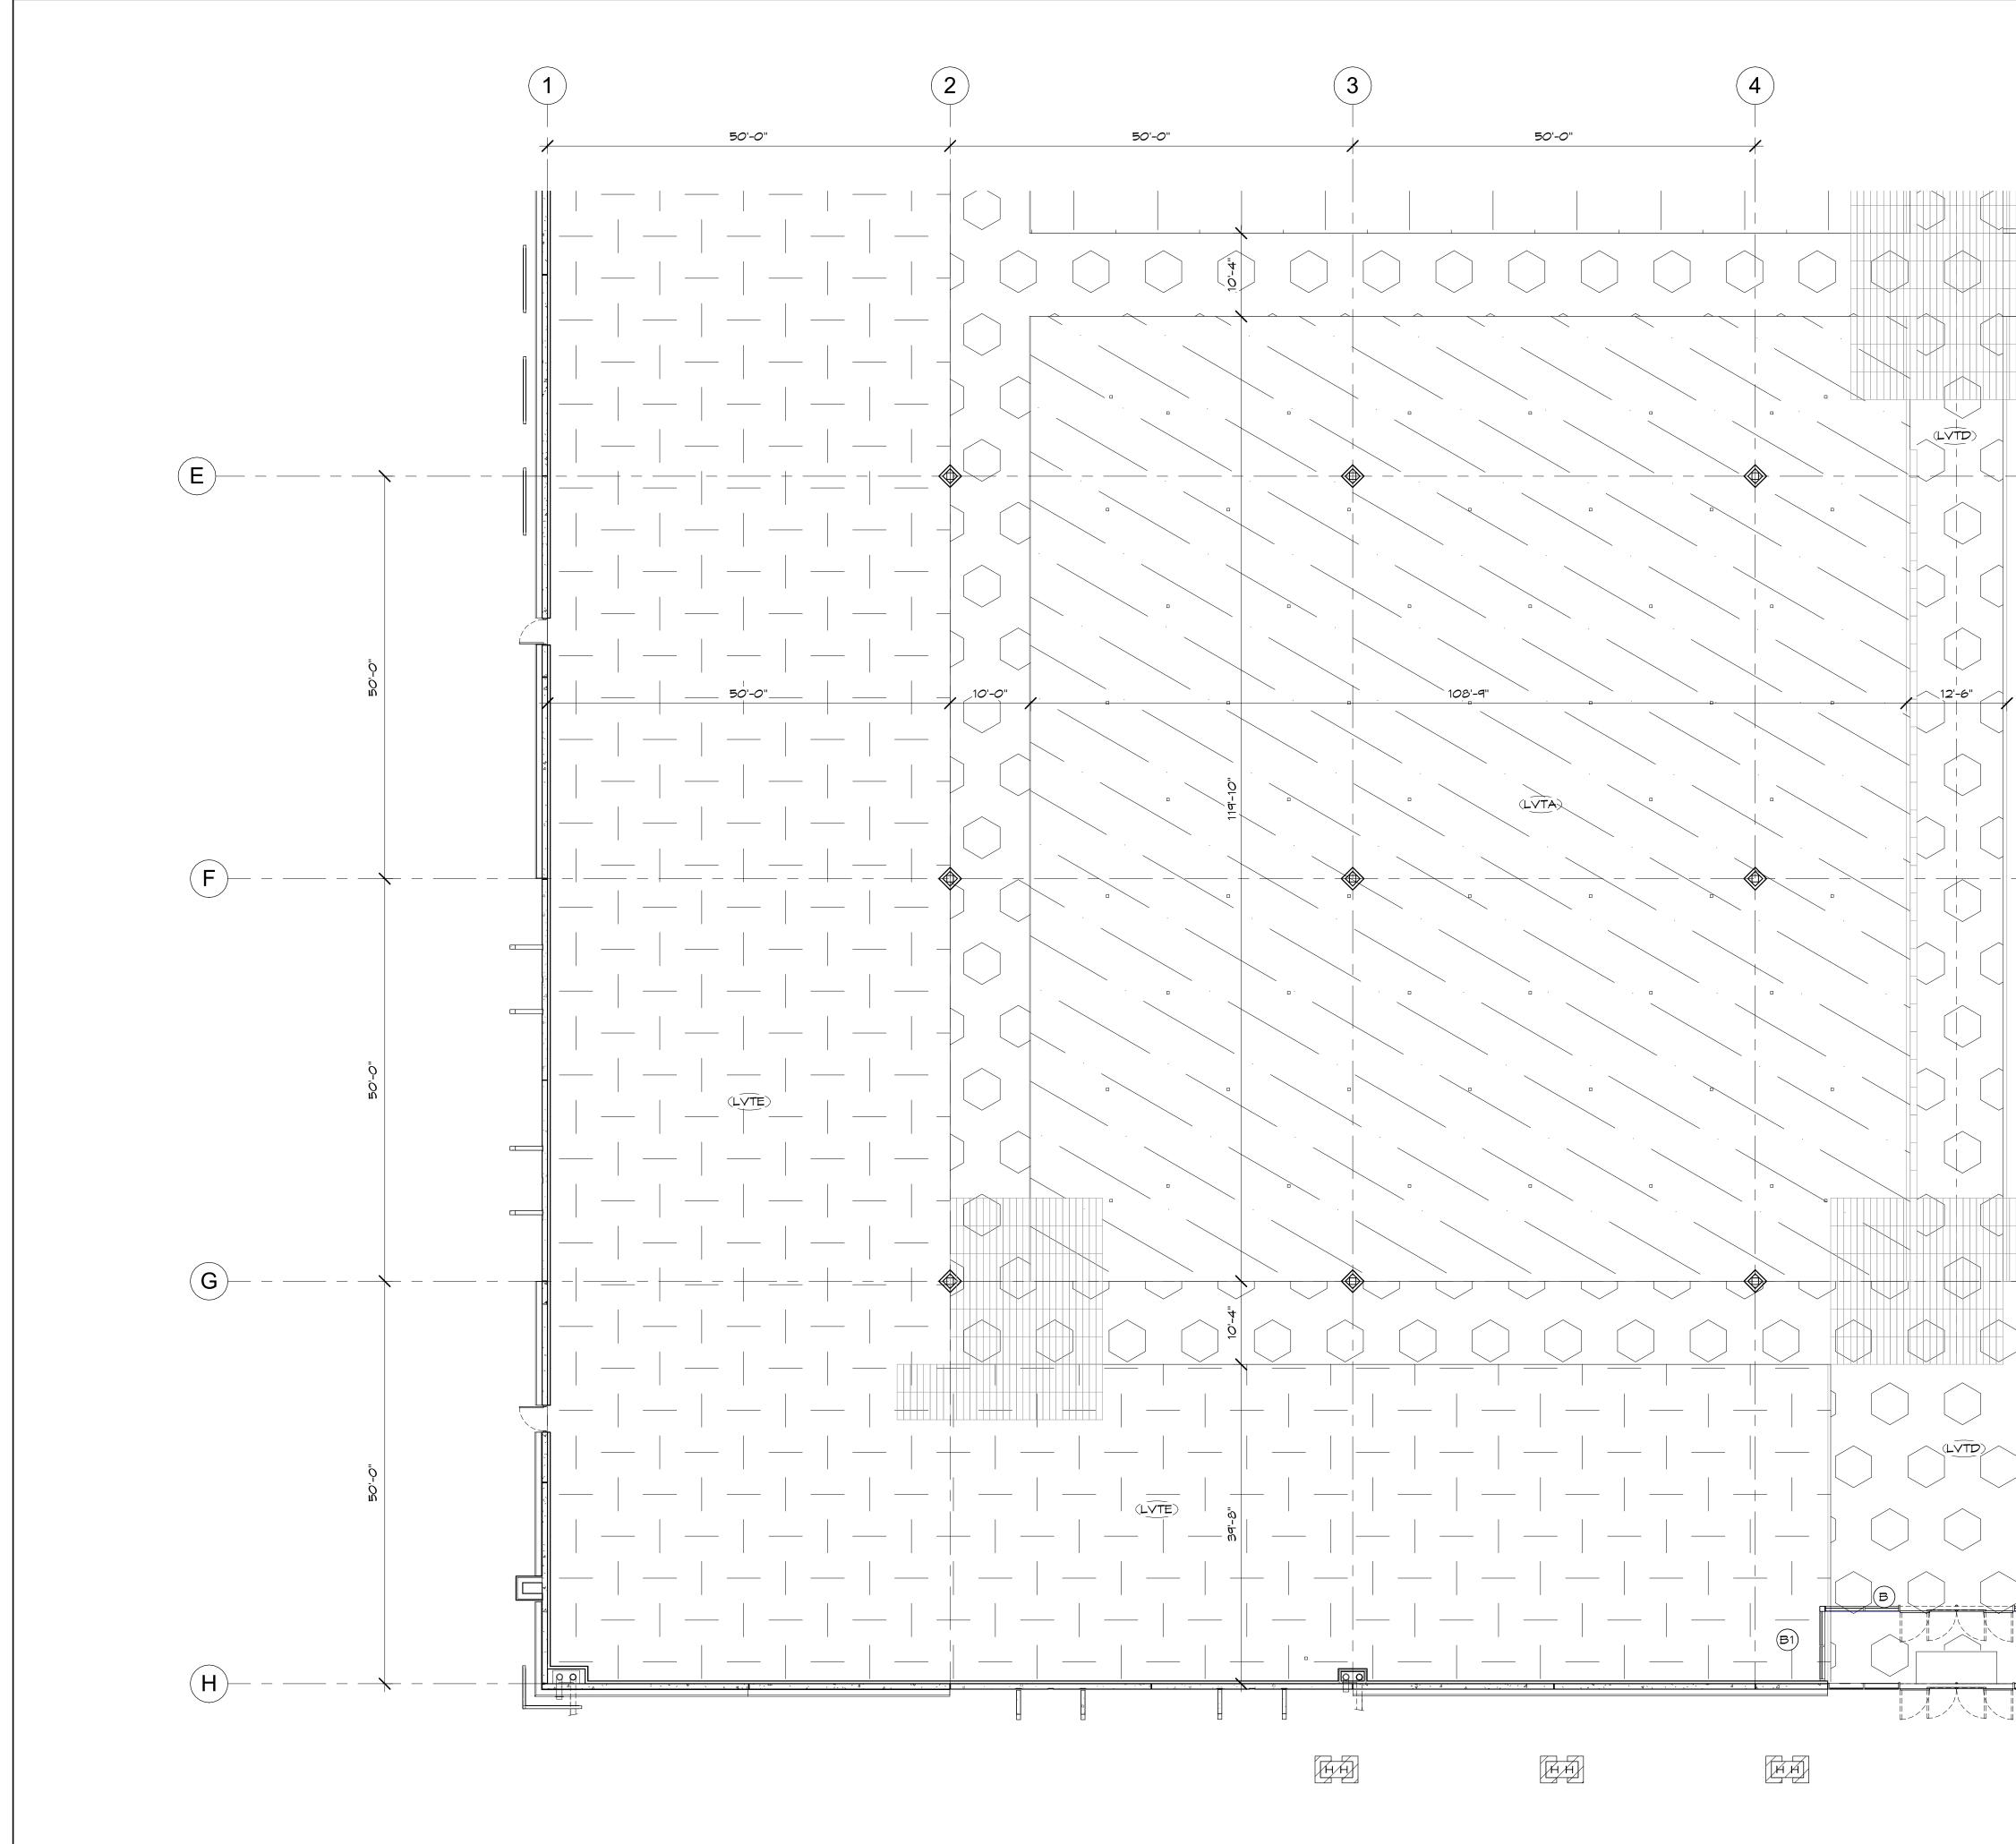



1 FINISH FLOOR-SW SHOWROOM SCALE: 3/32" = 1'-0"






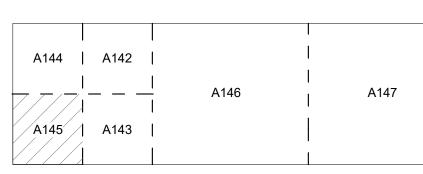


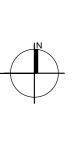

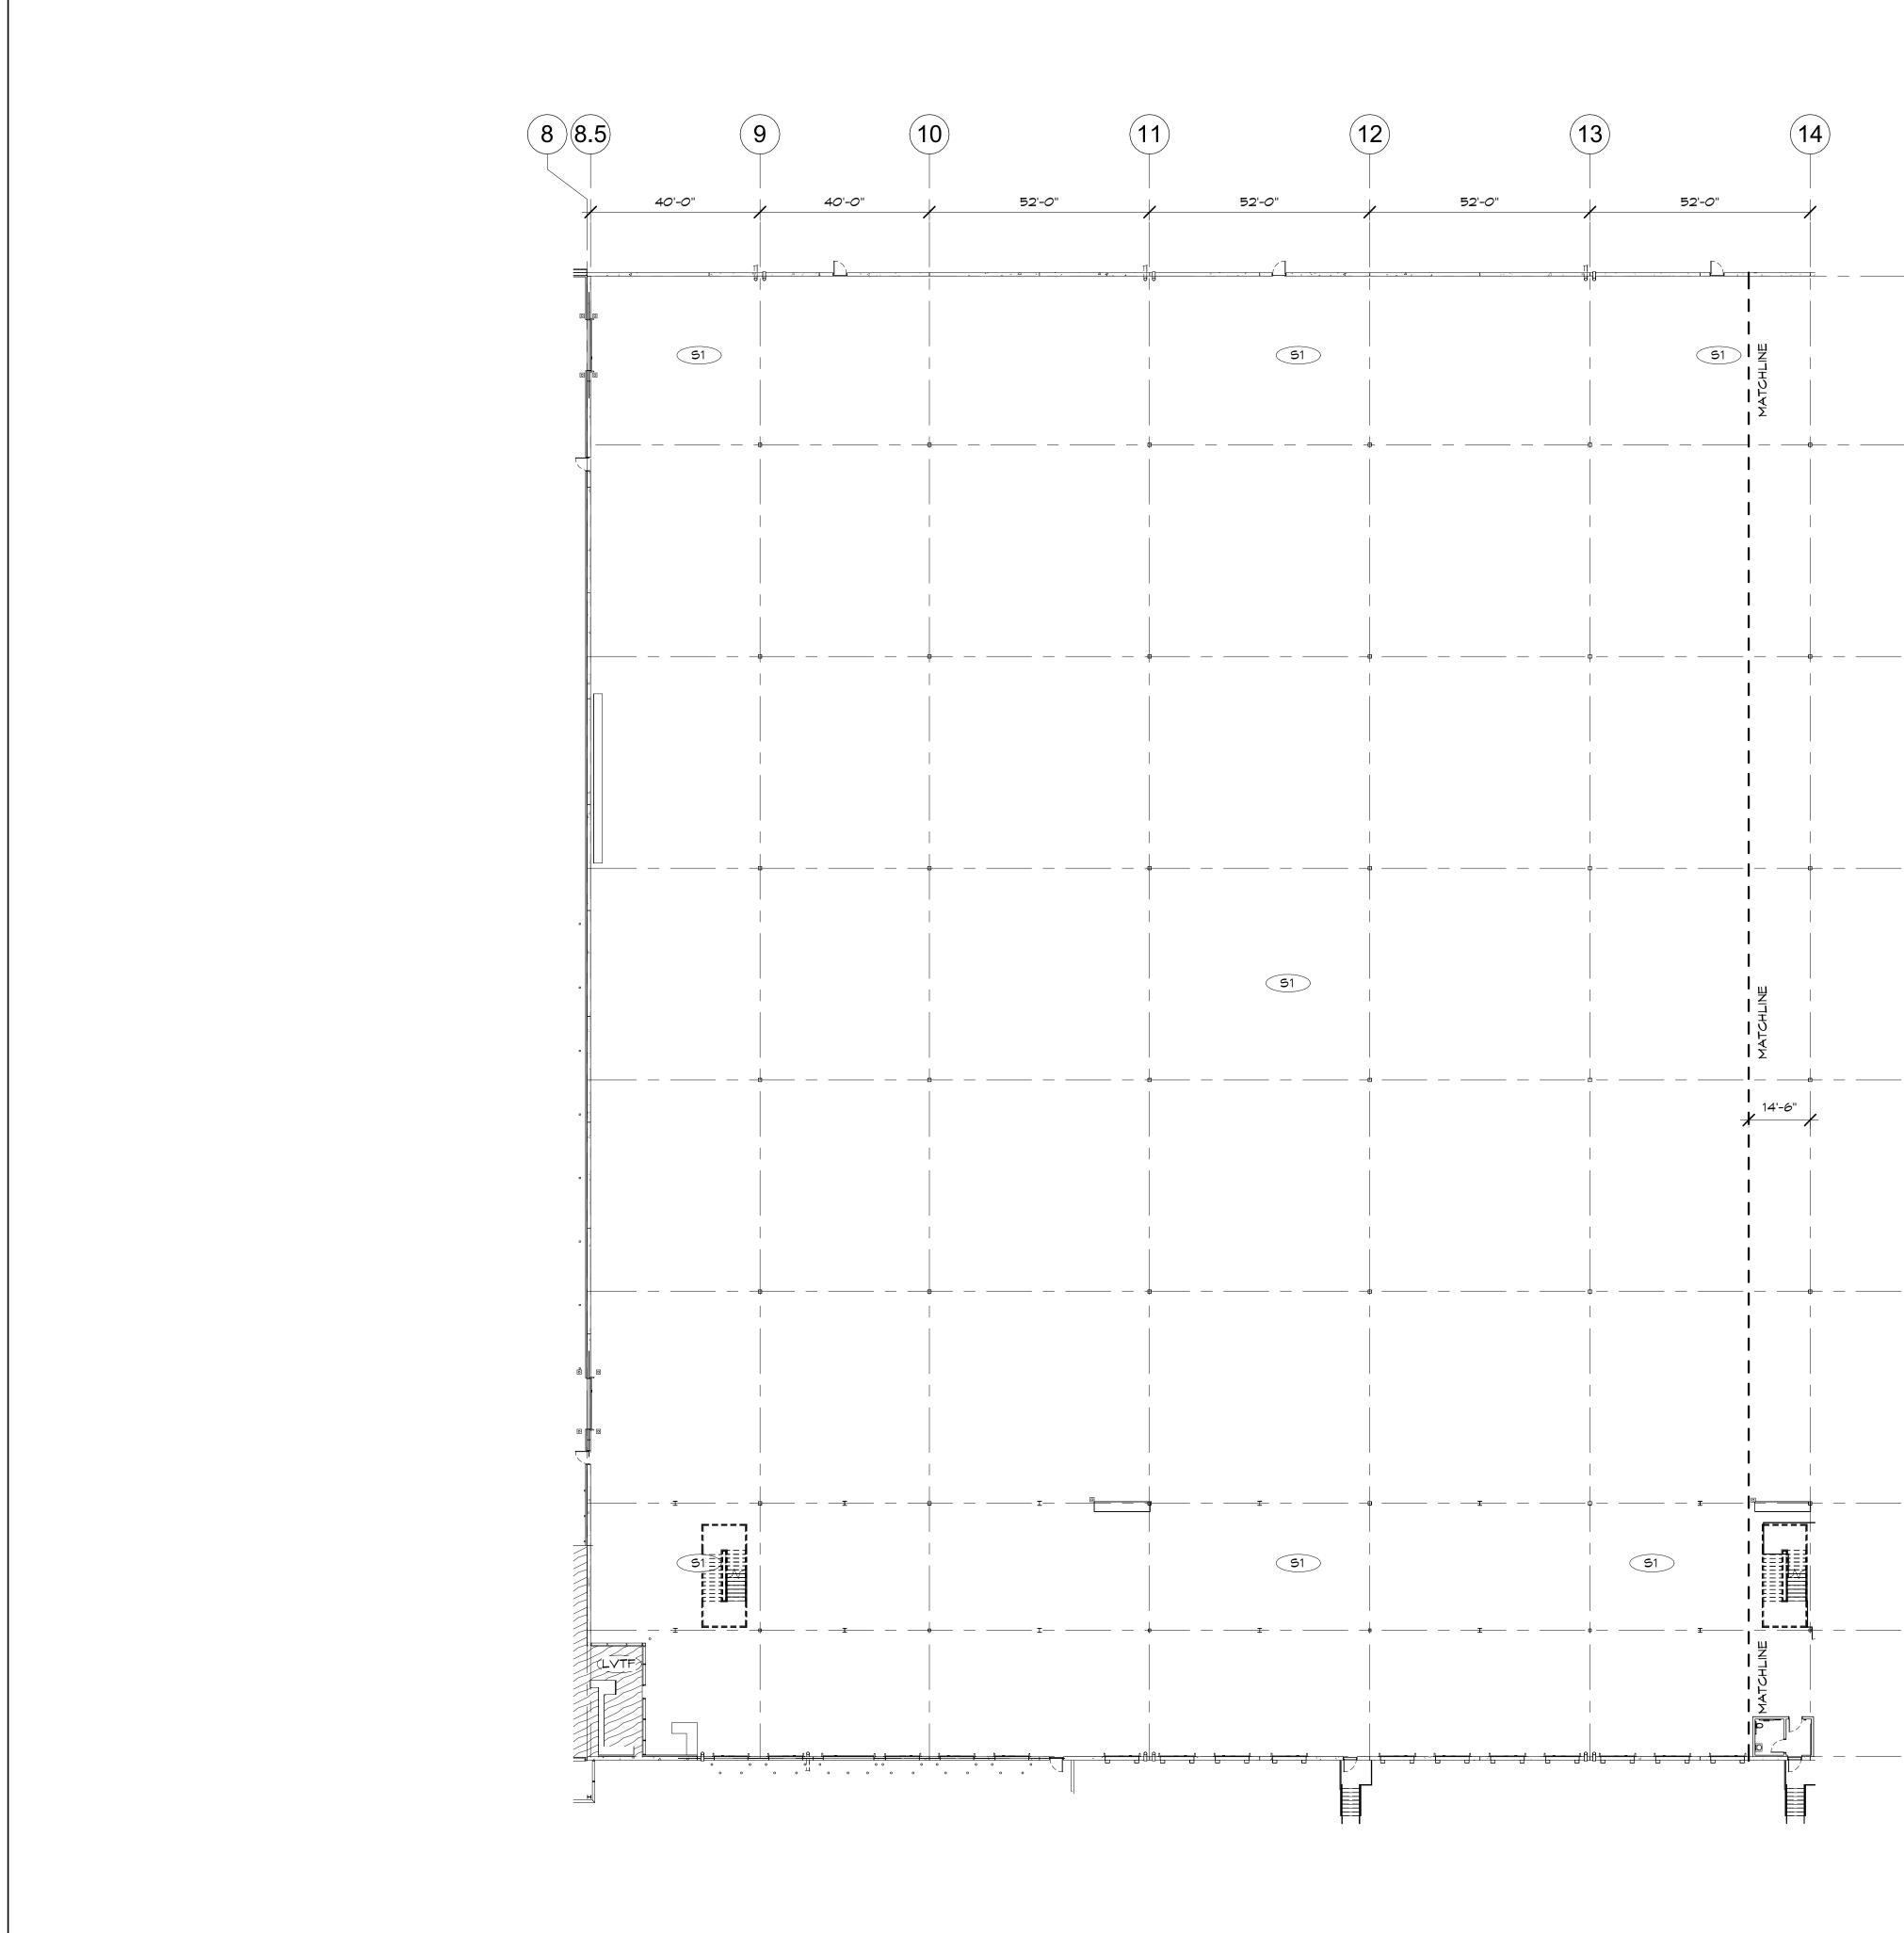




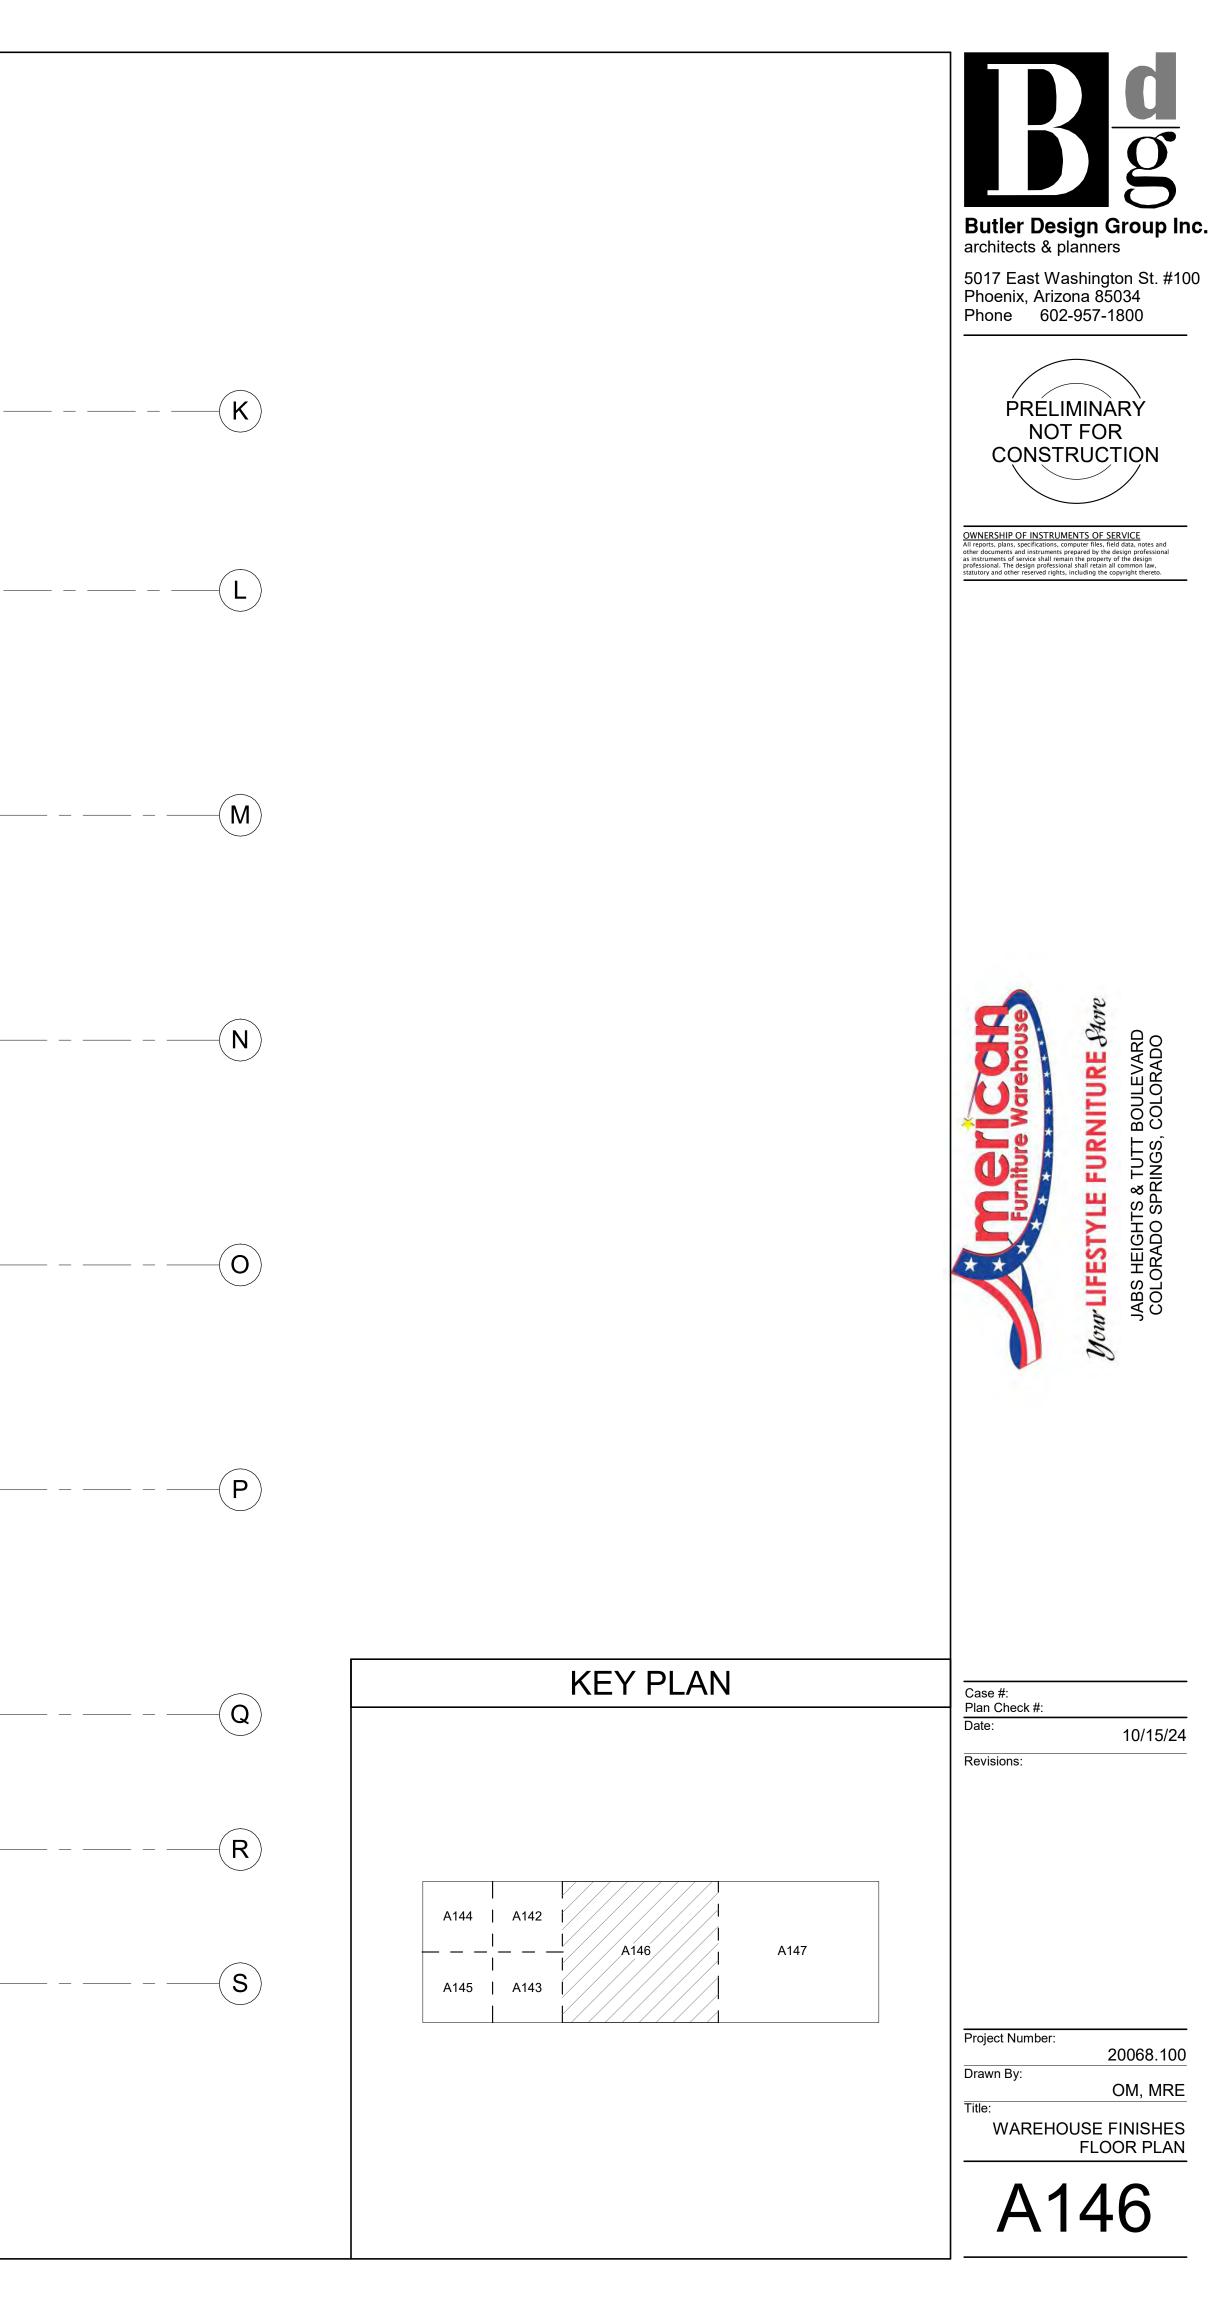


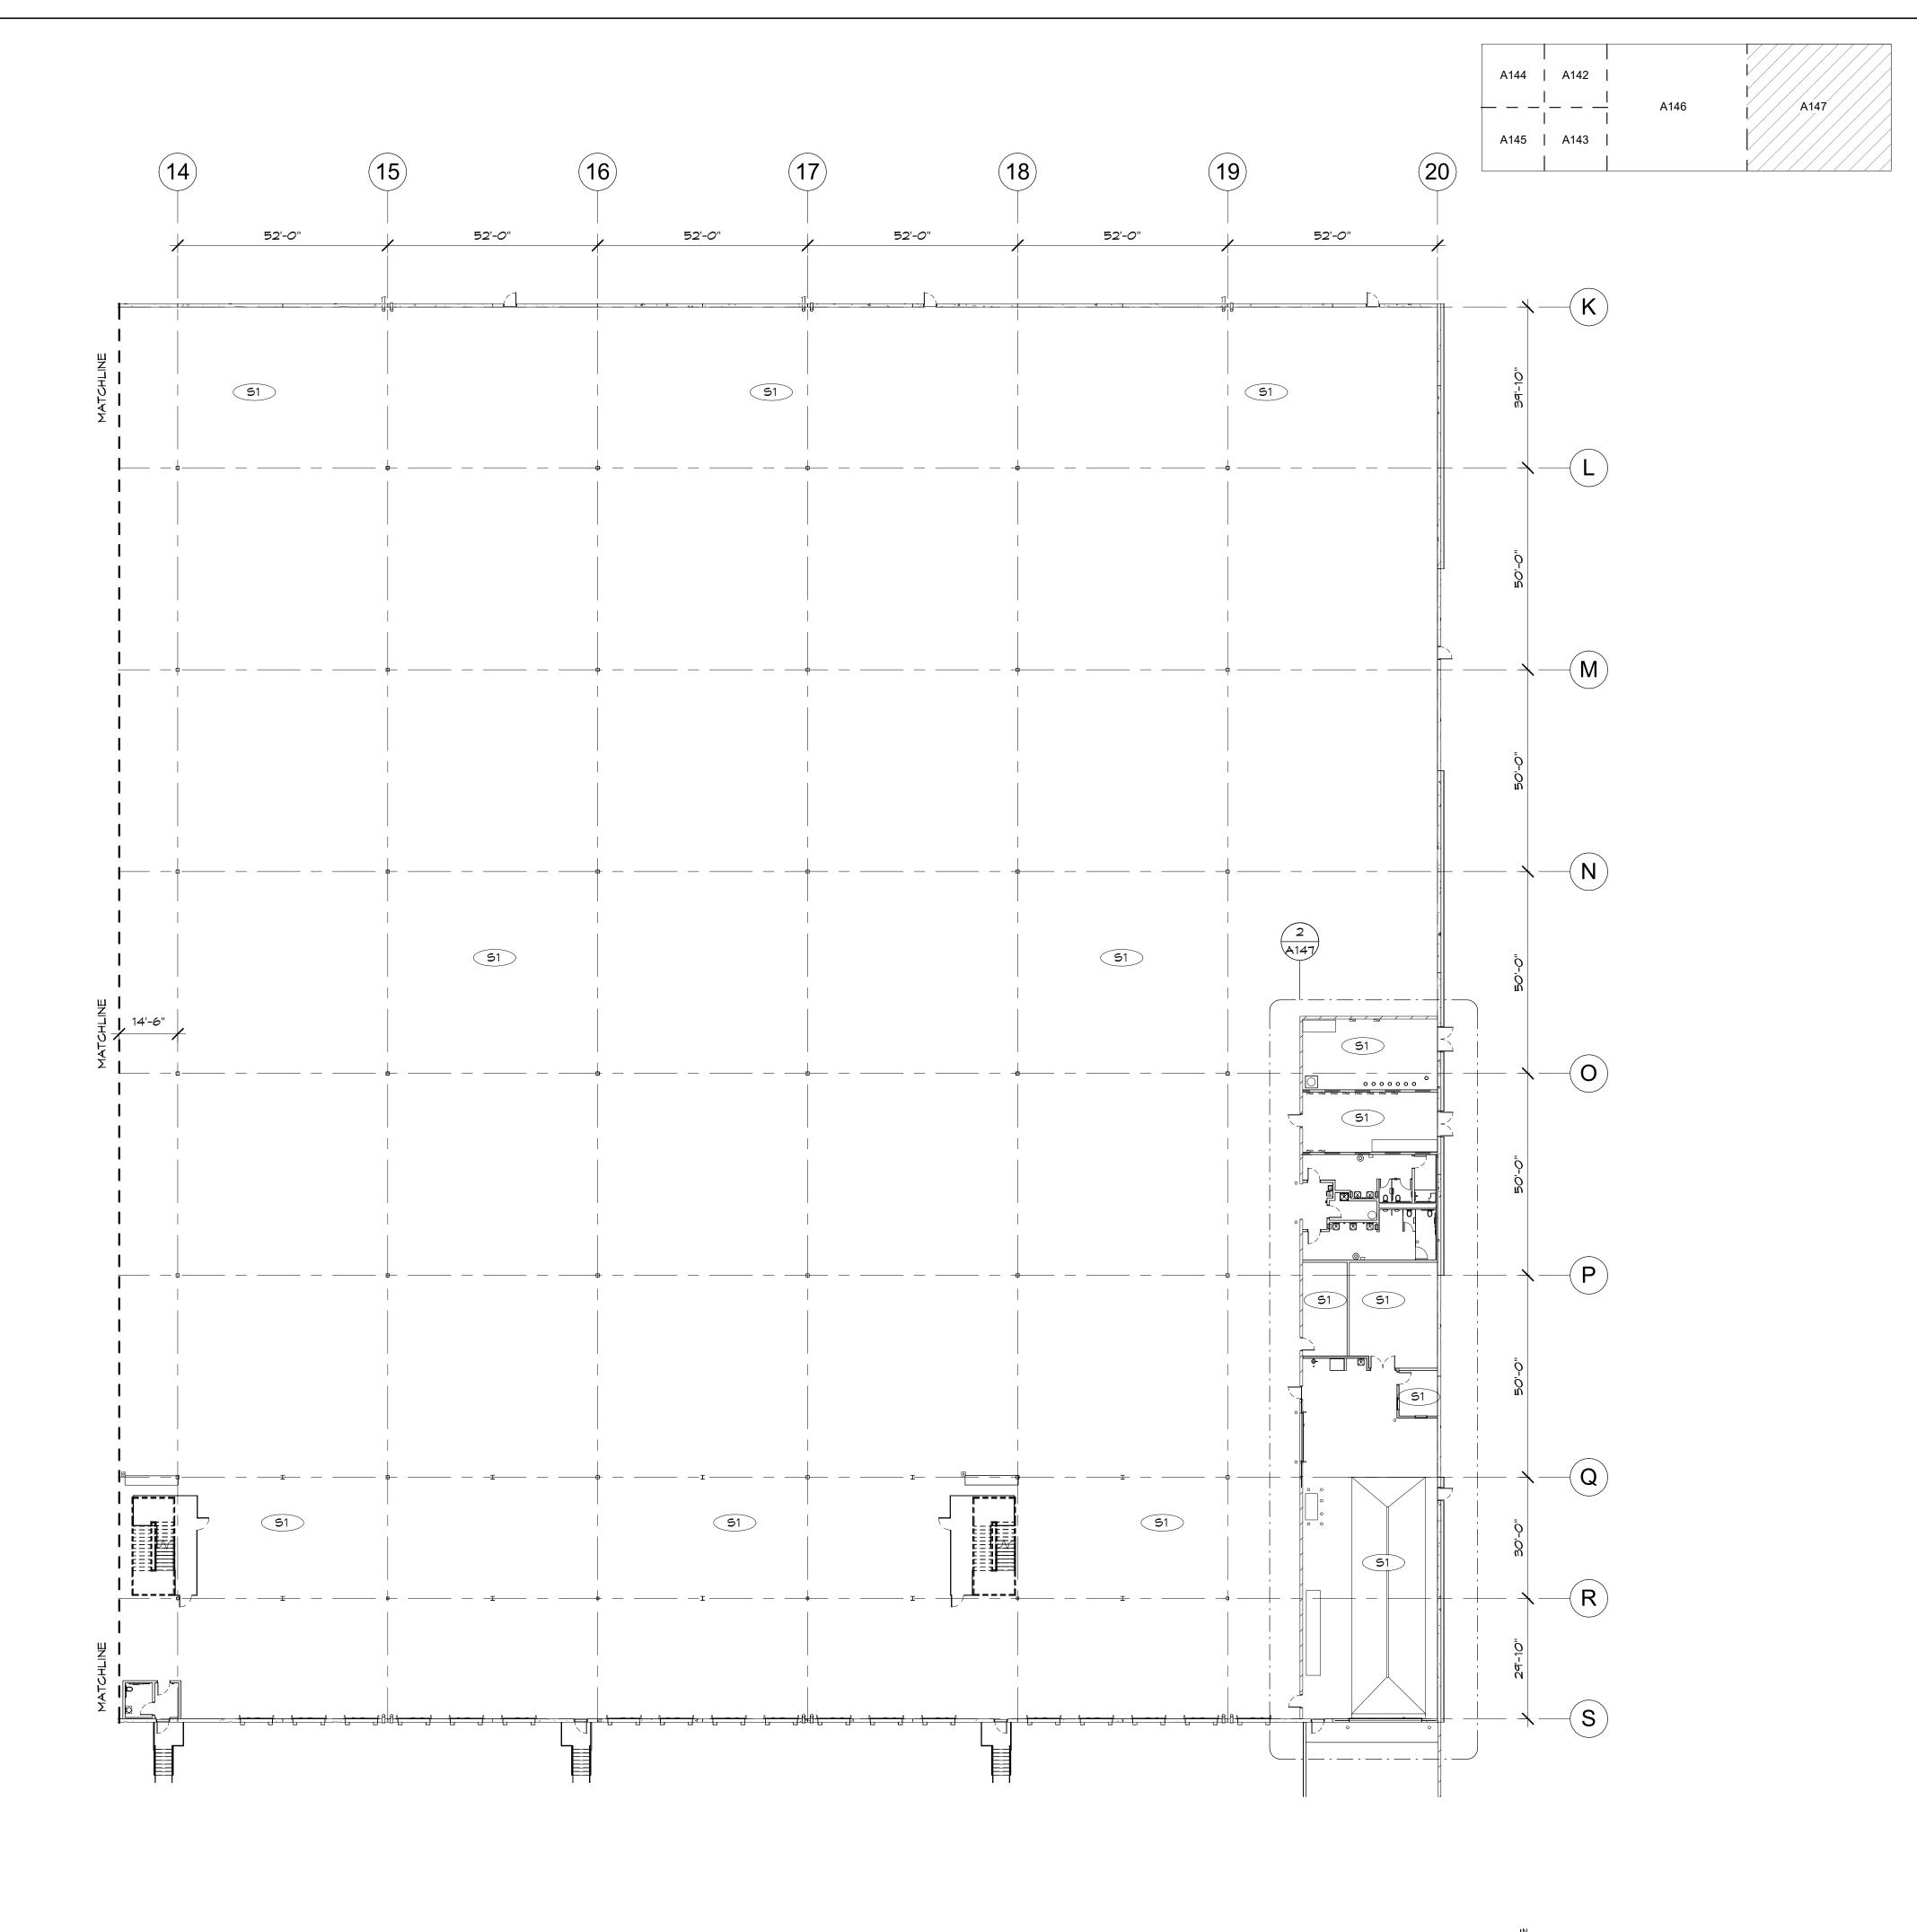


1 FLOOR FINISH PLAN -WAREHOUSE EAST

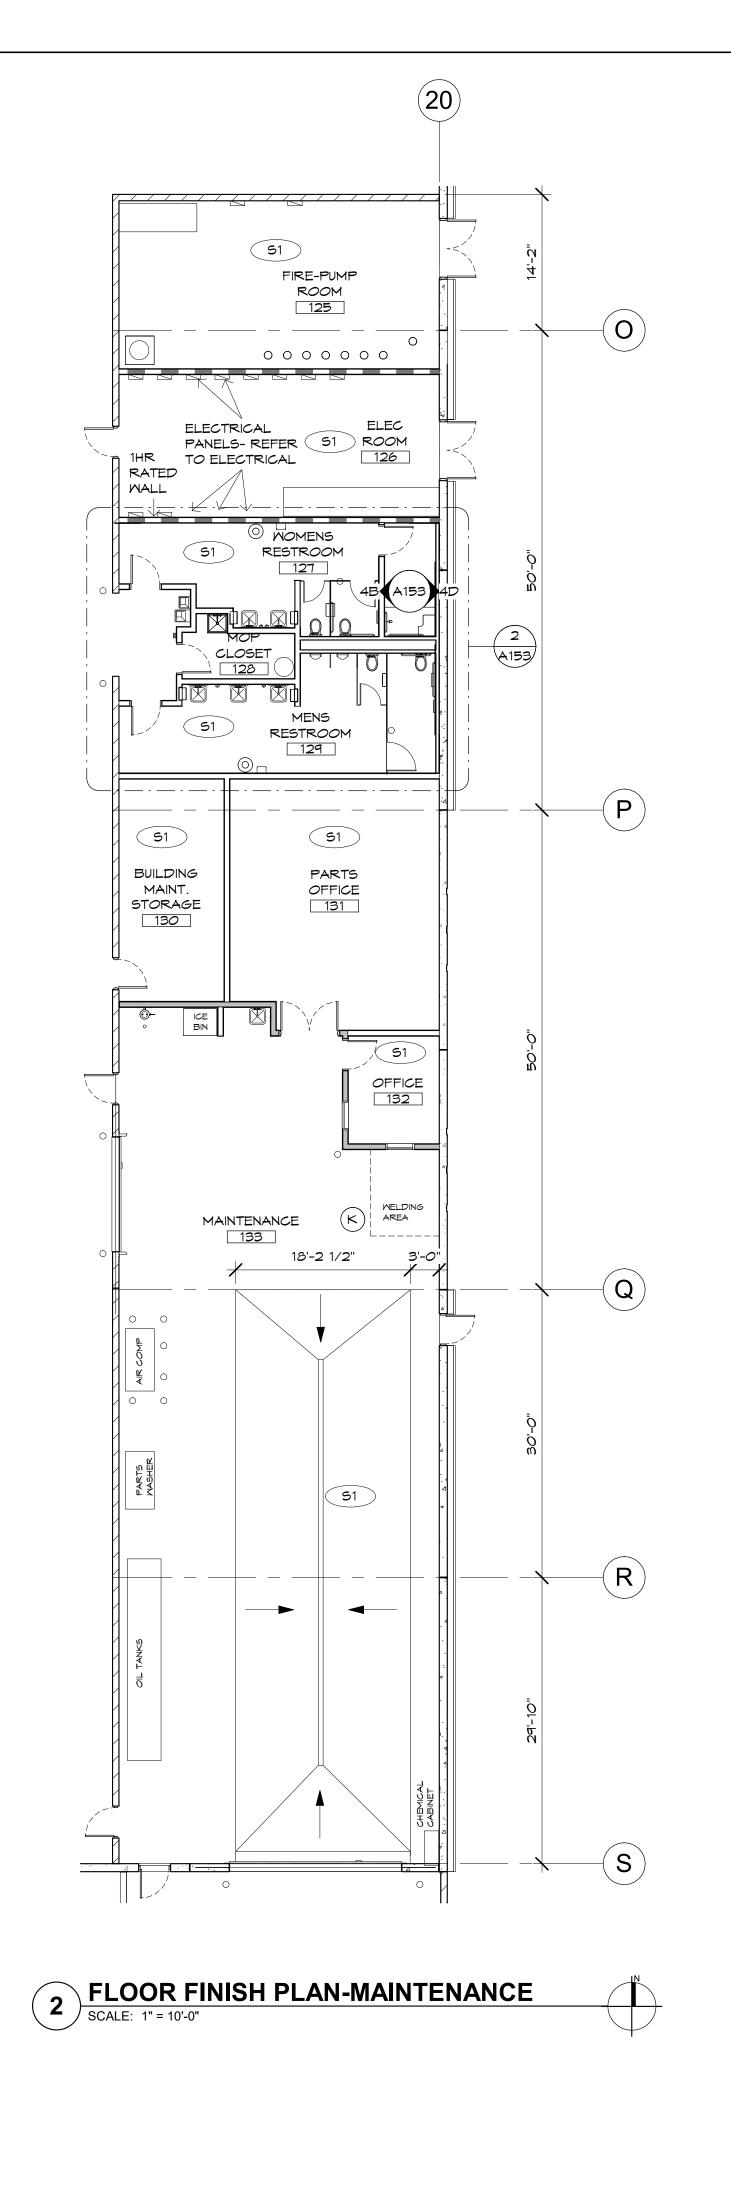



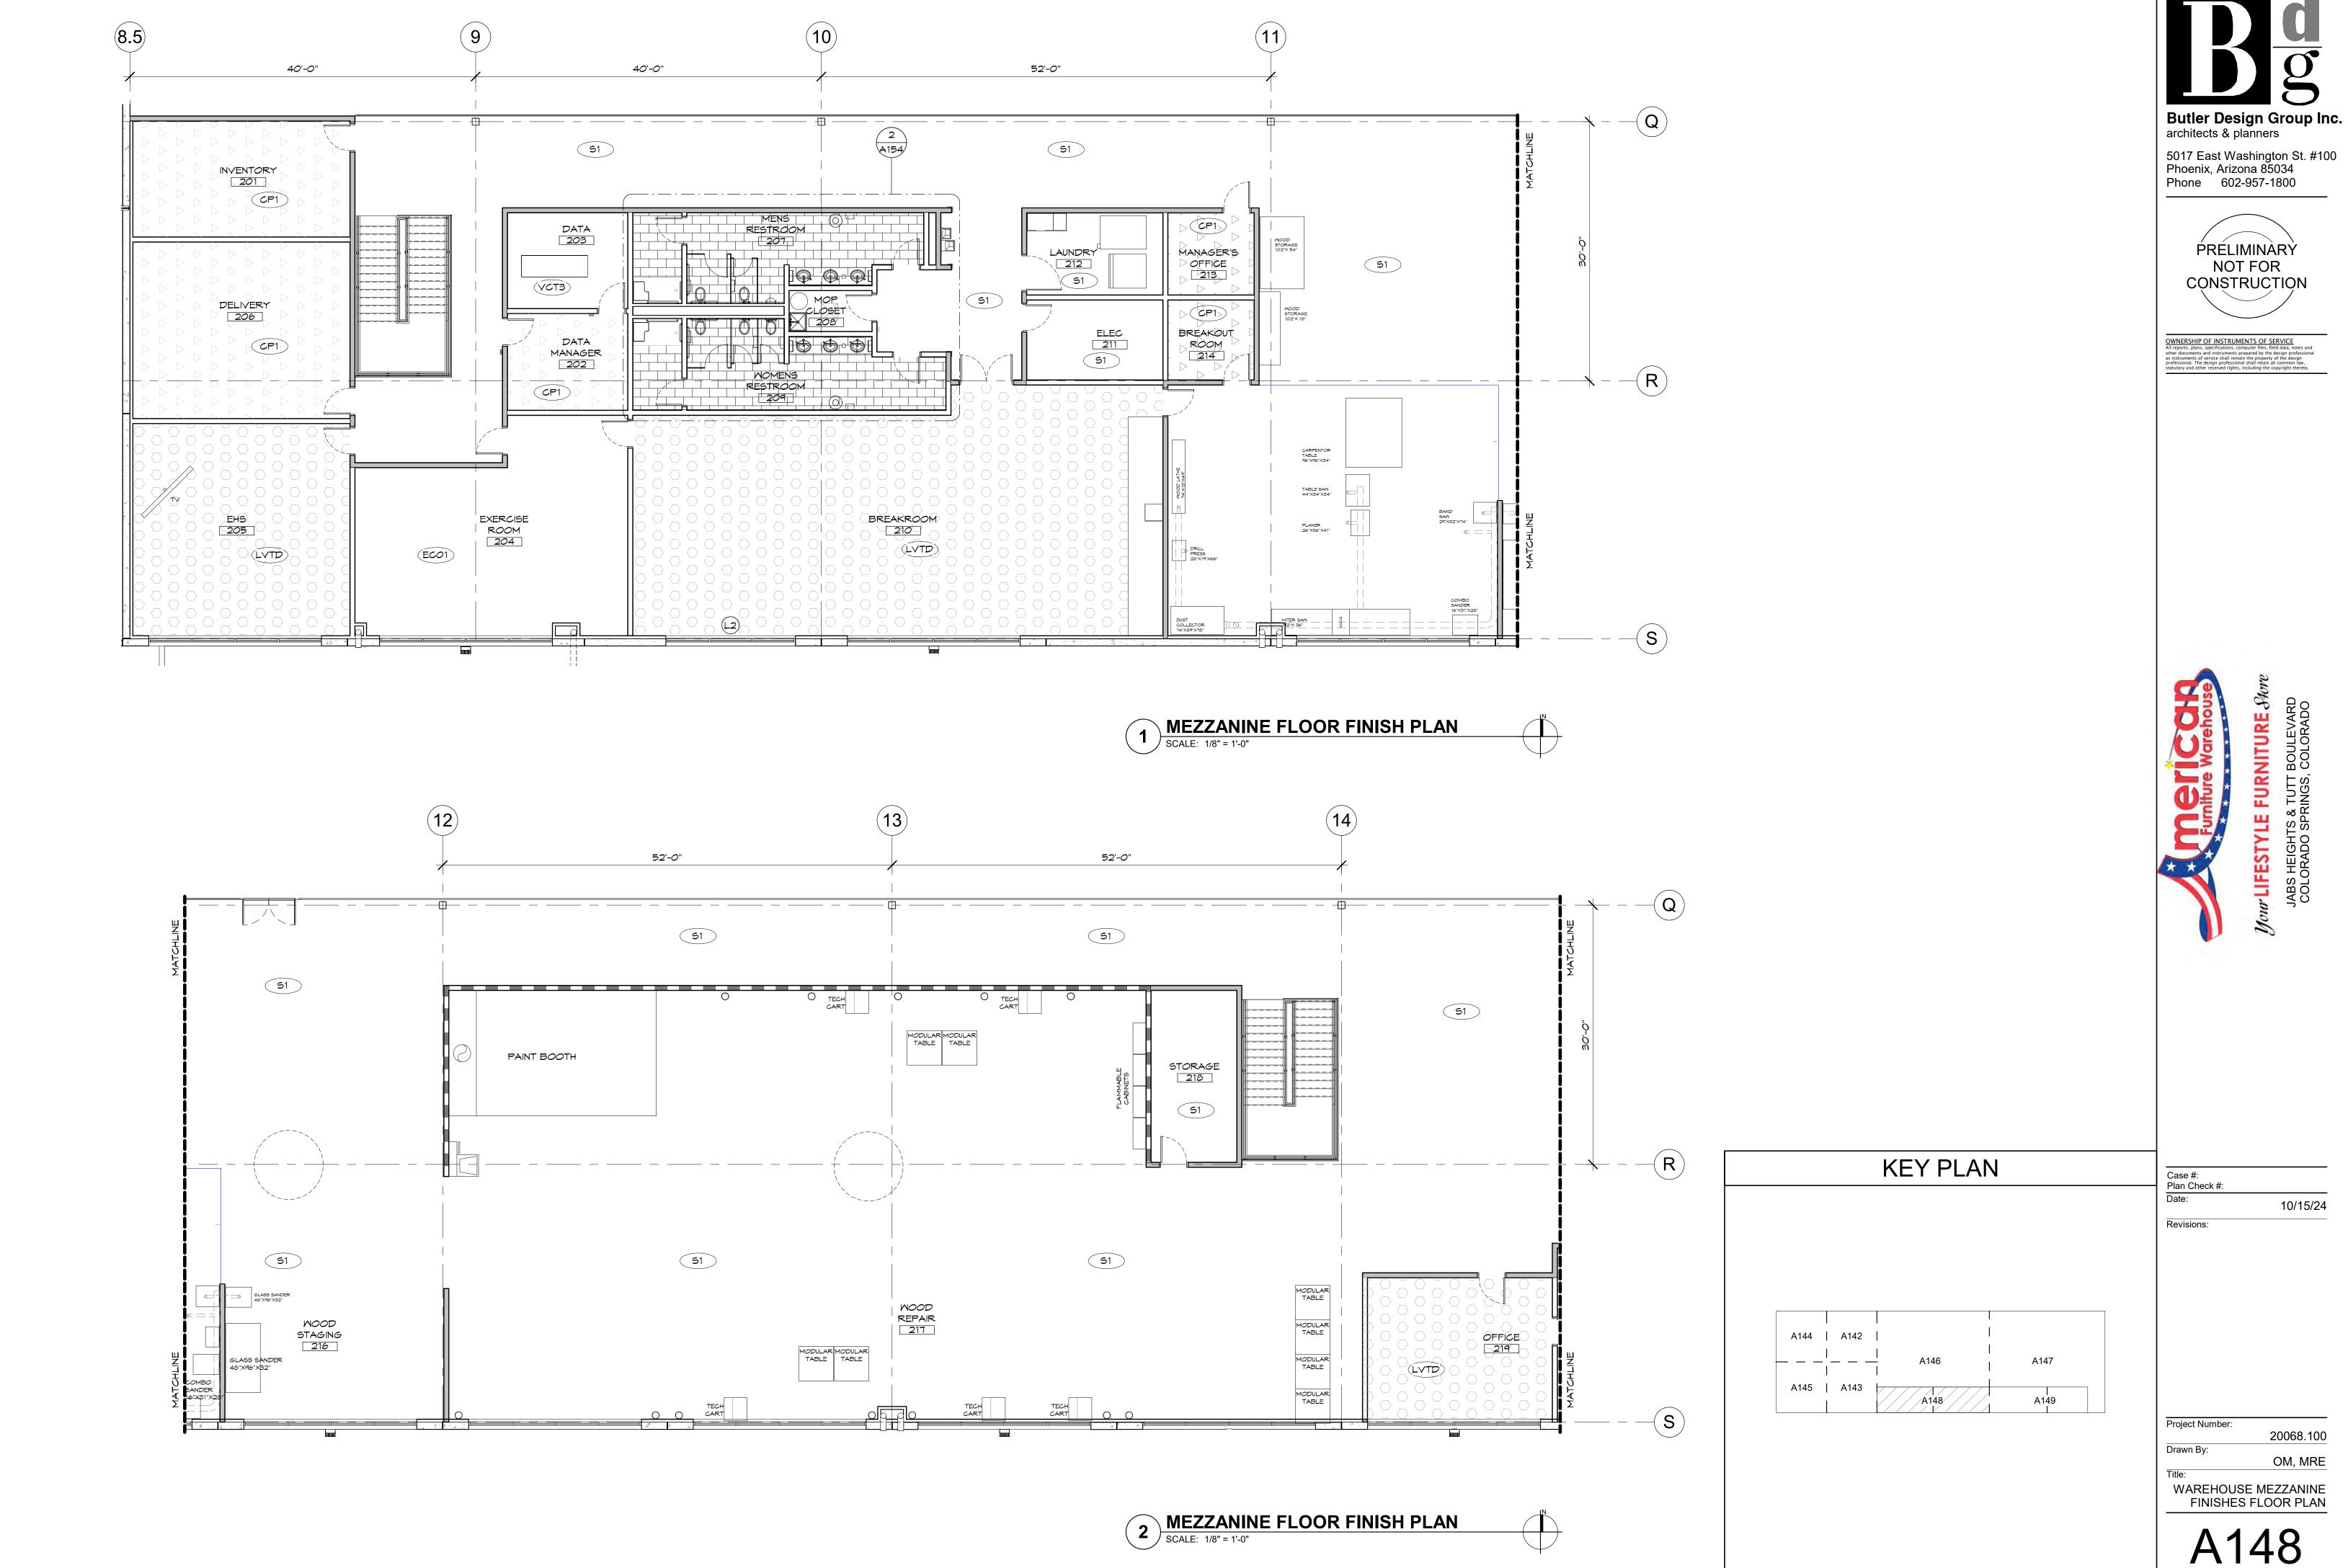





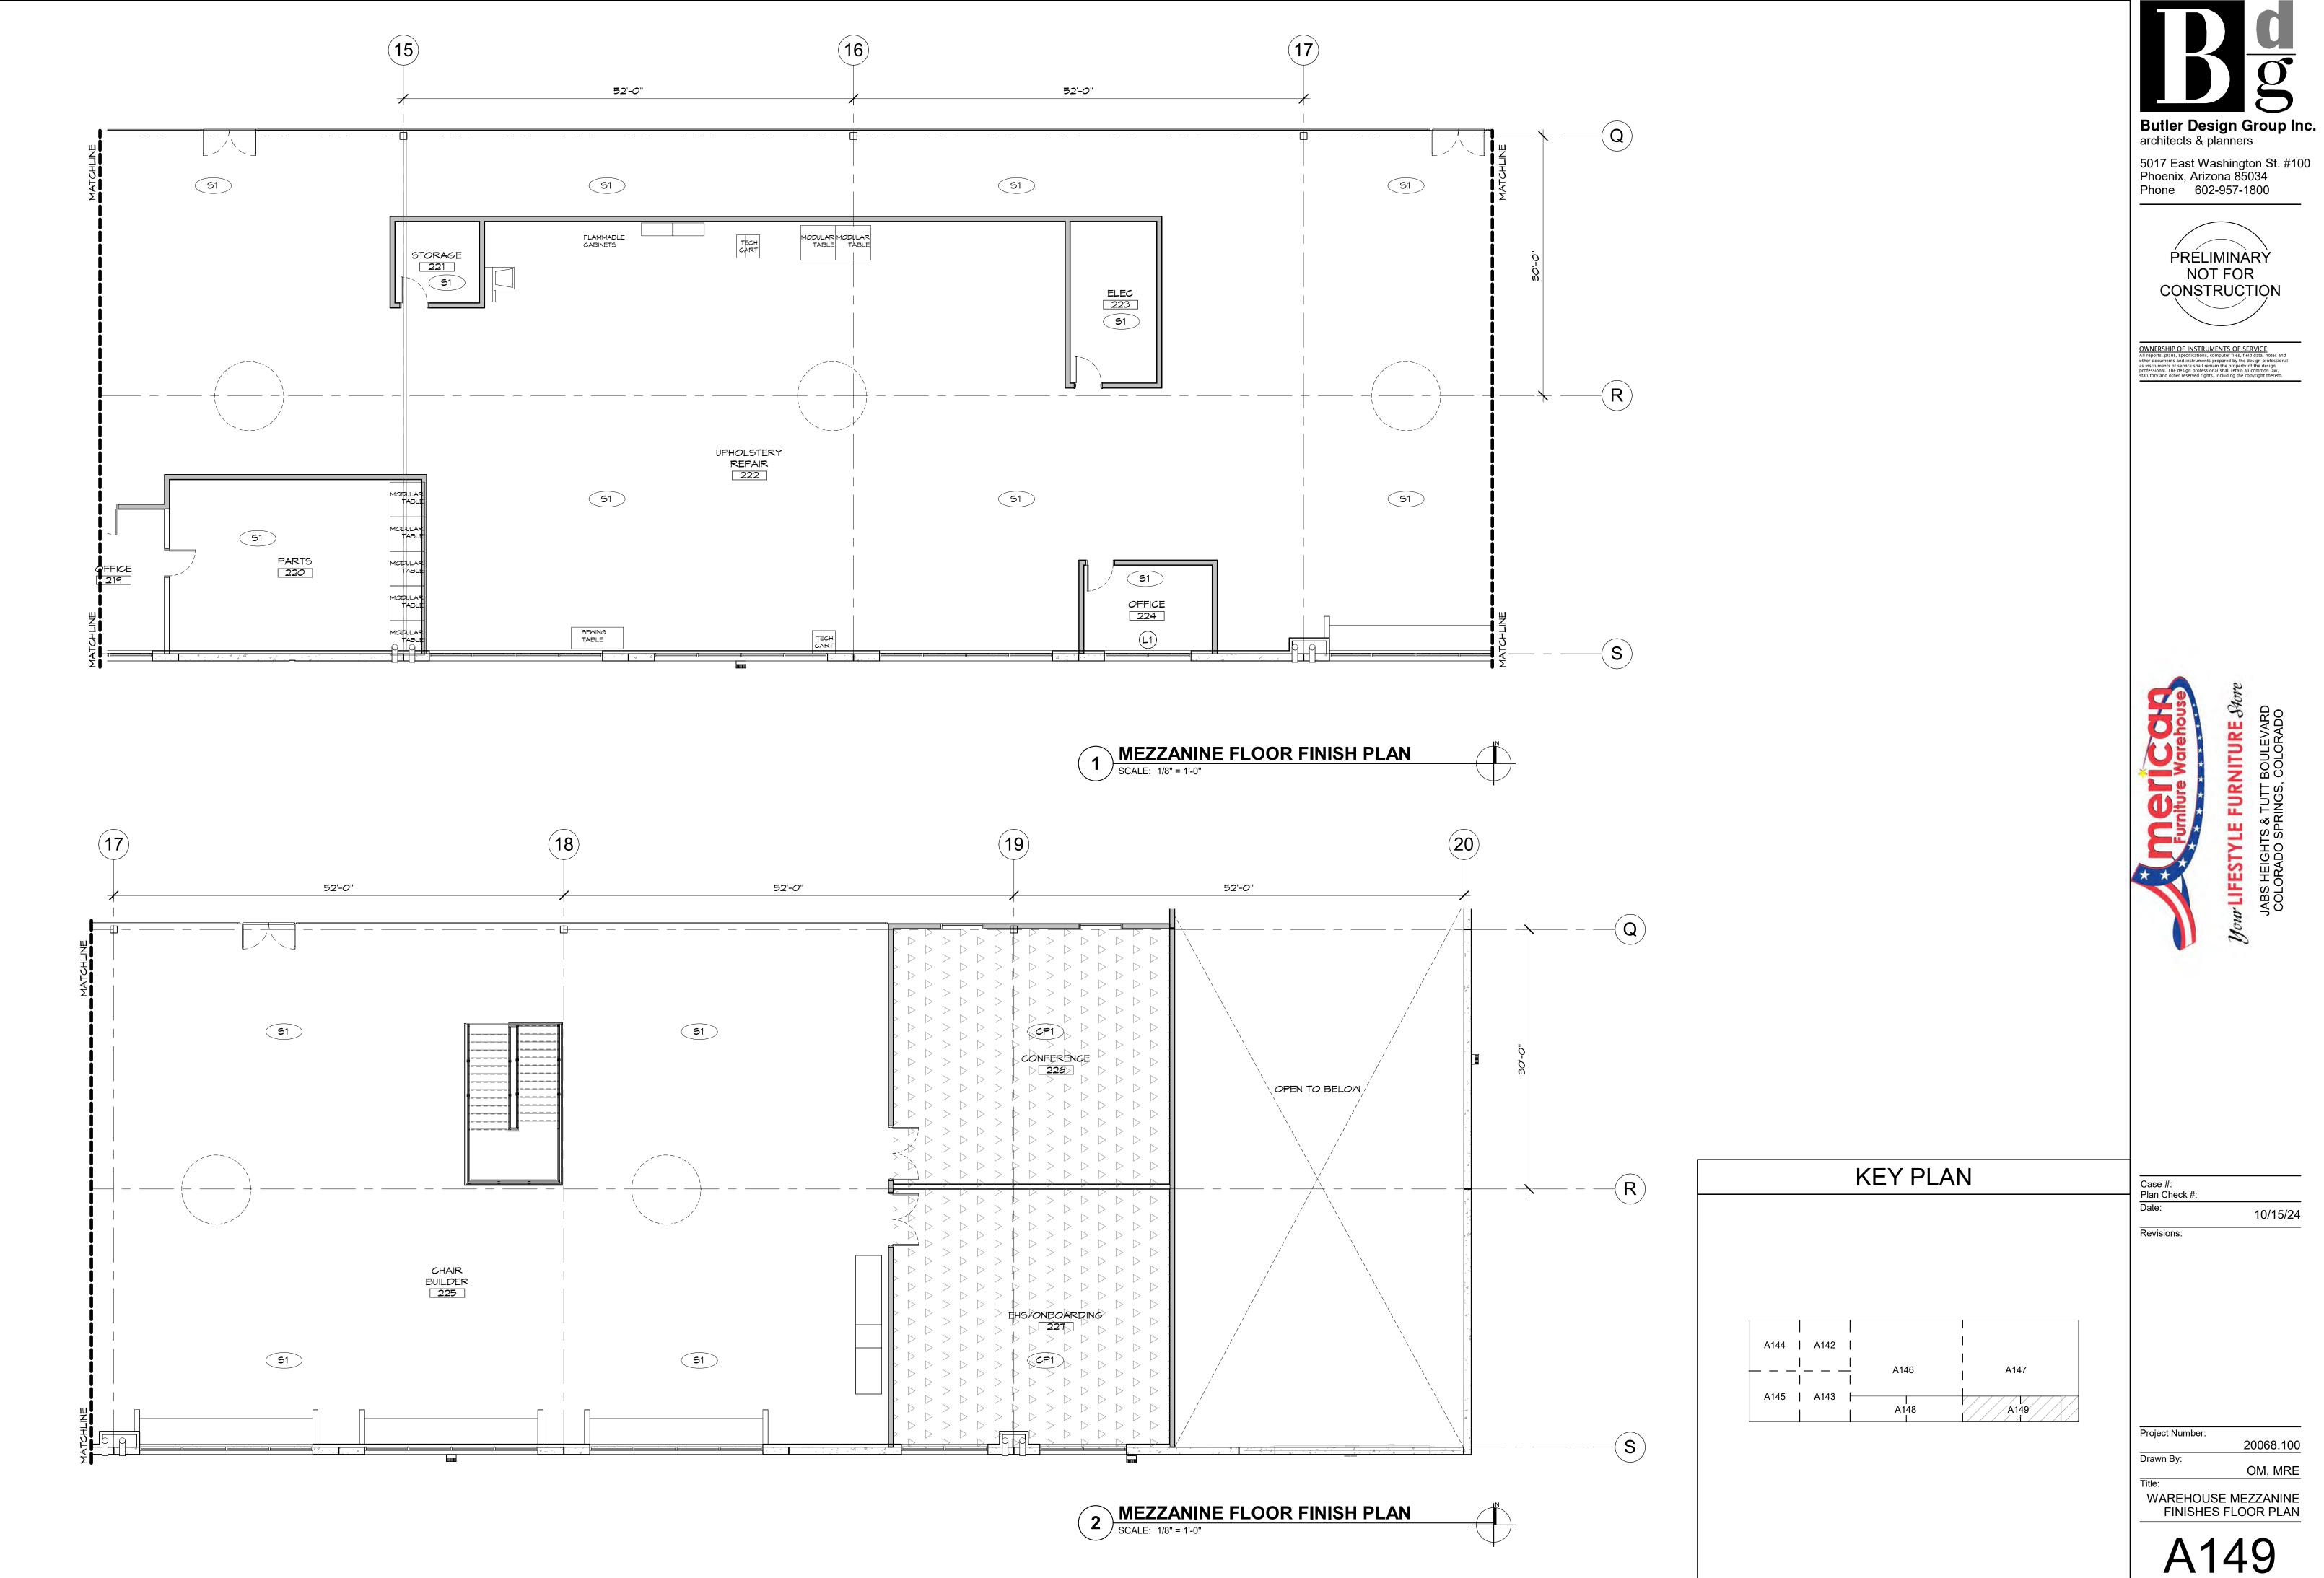








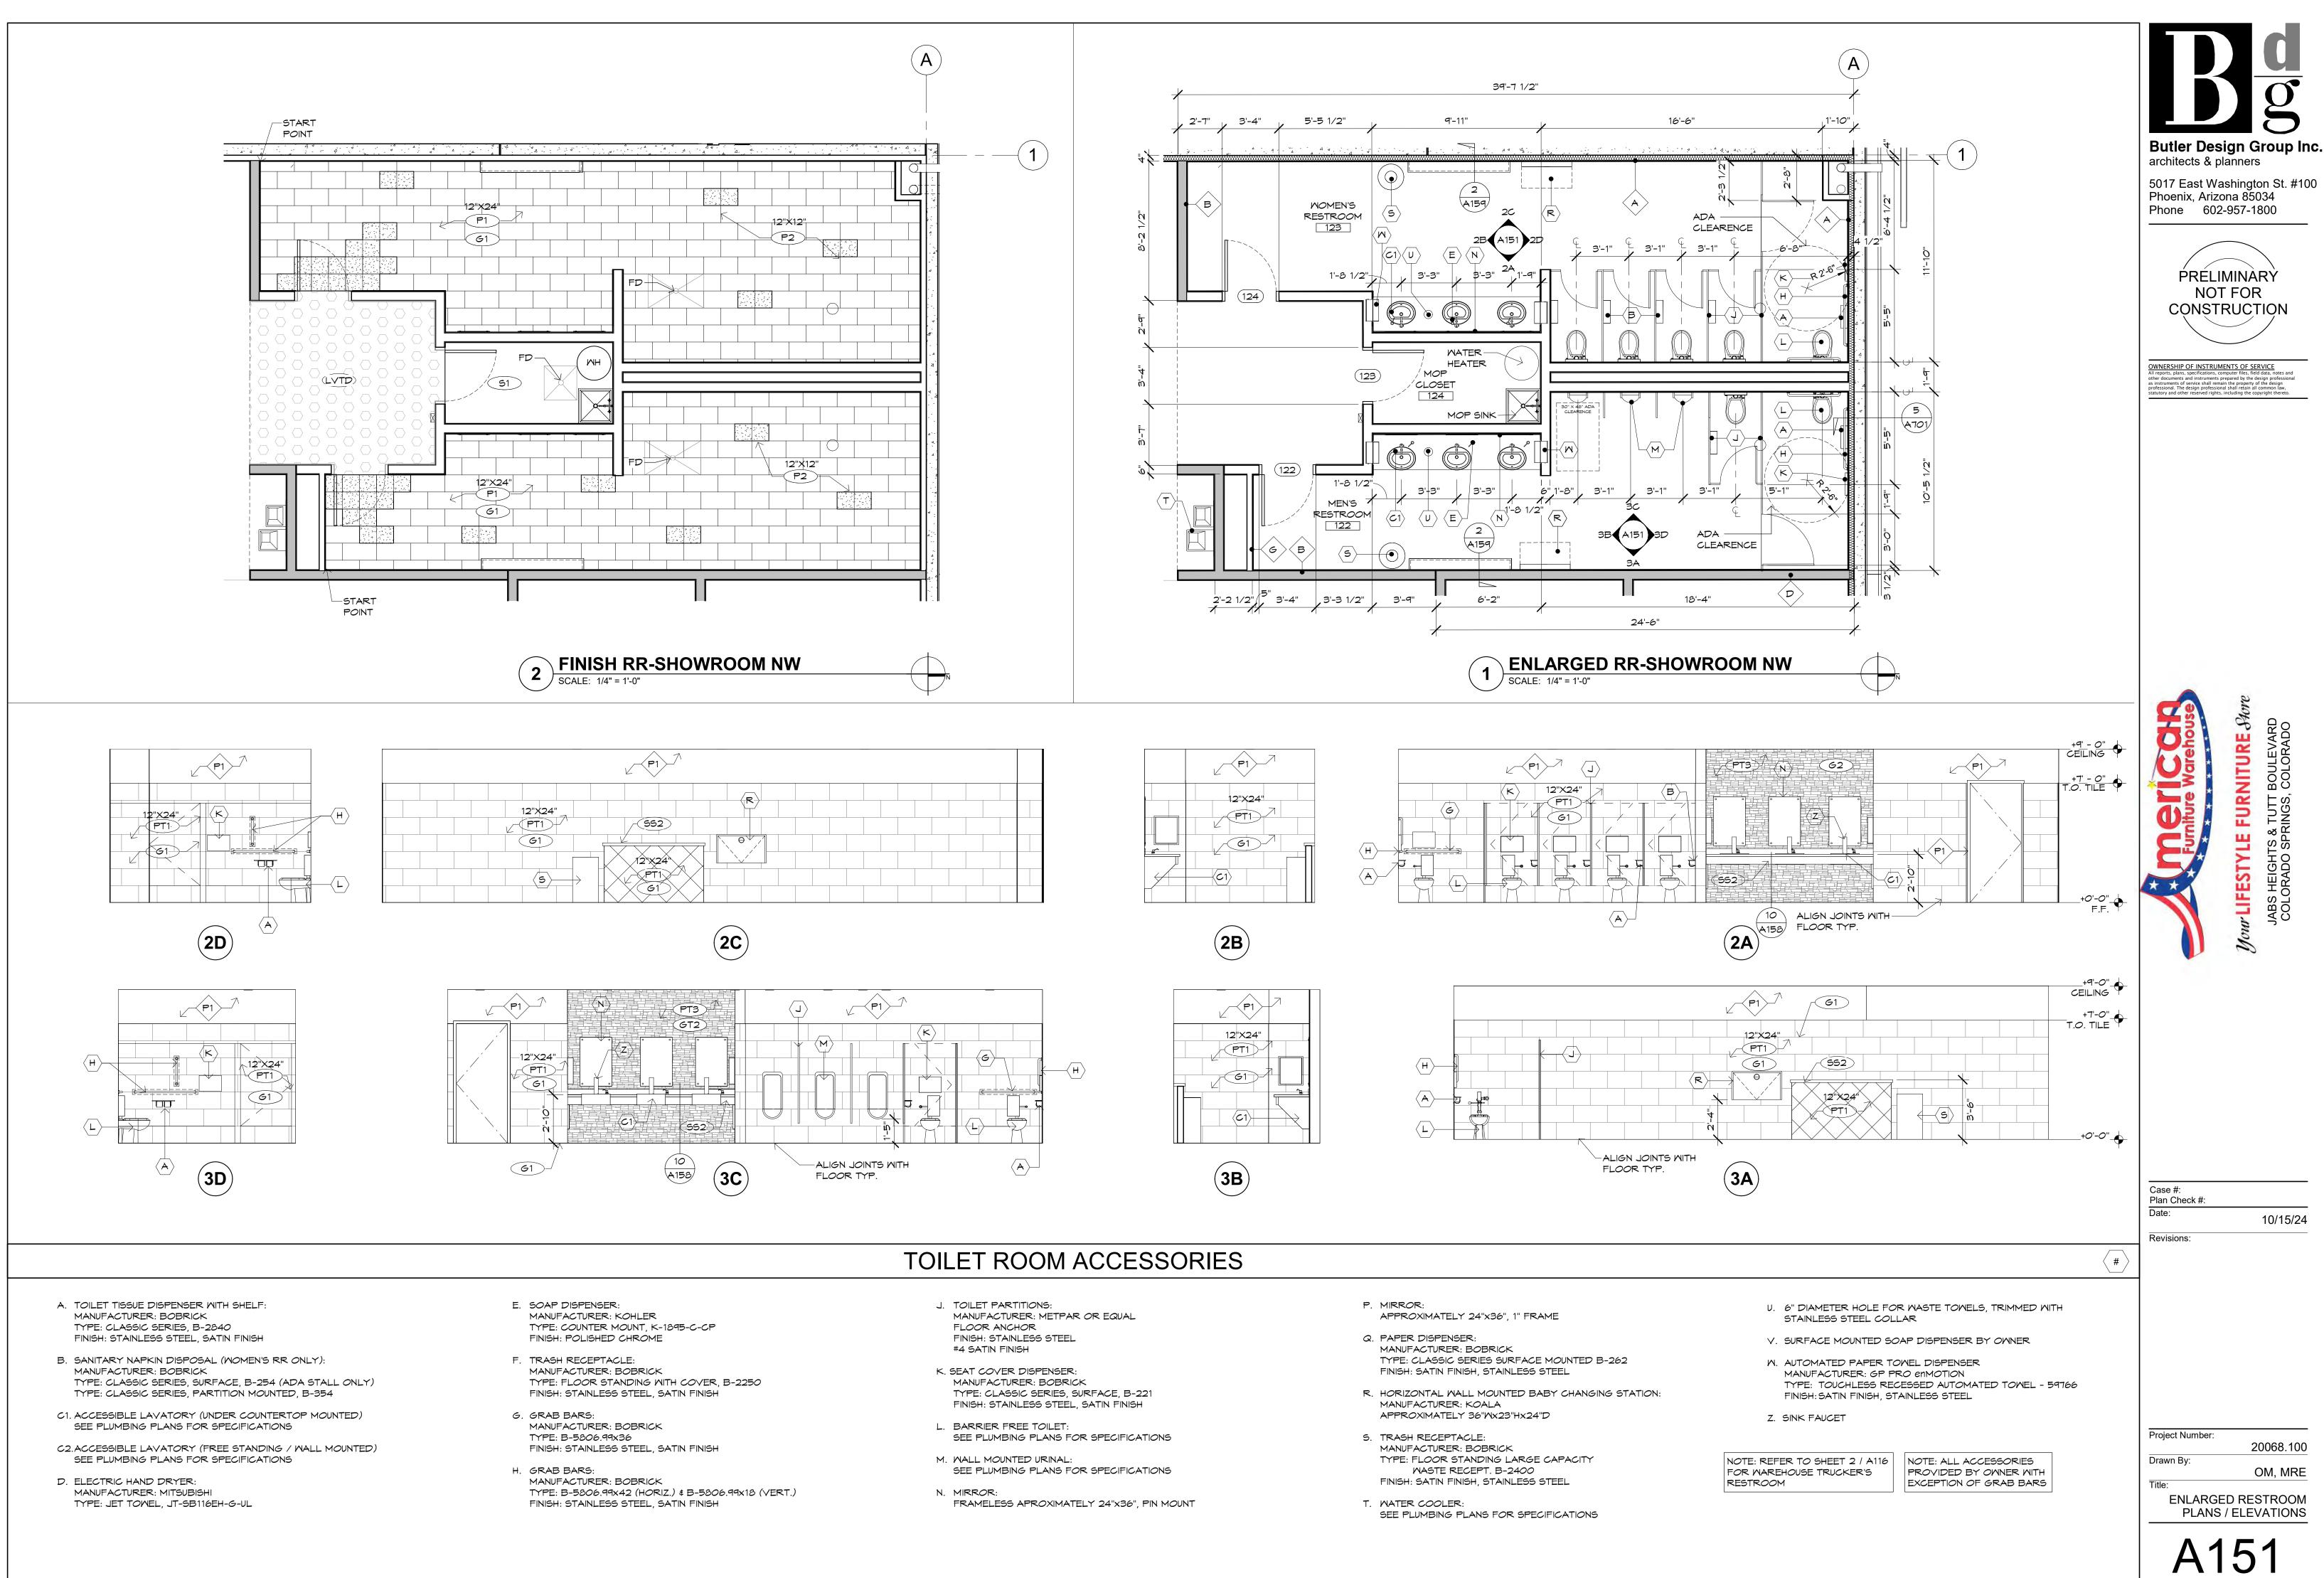


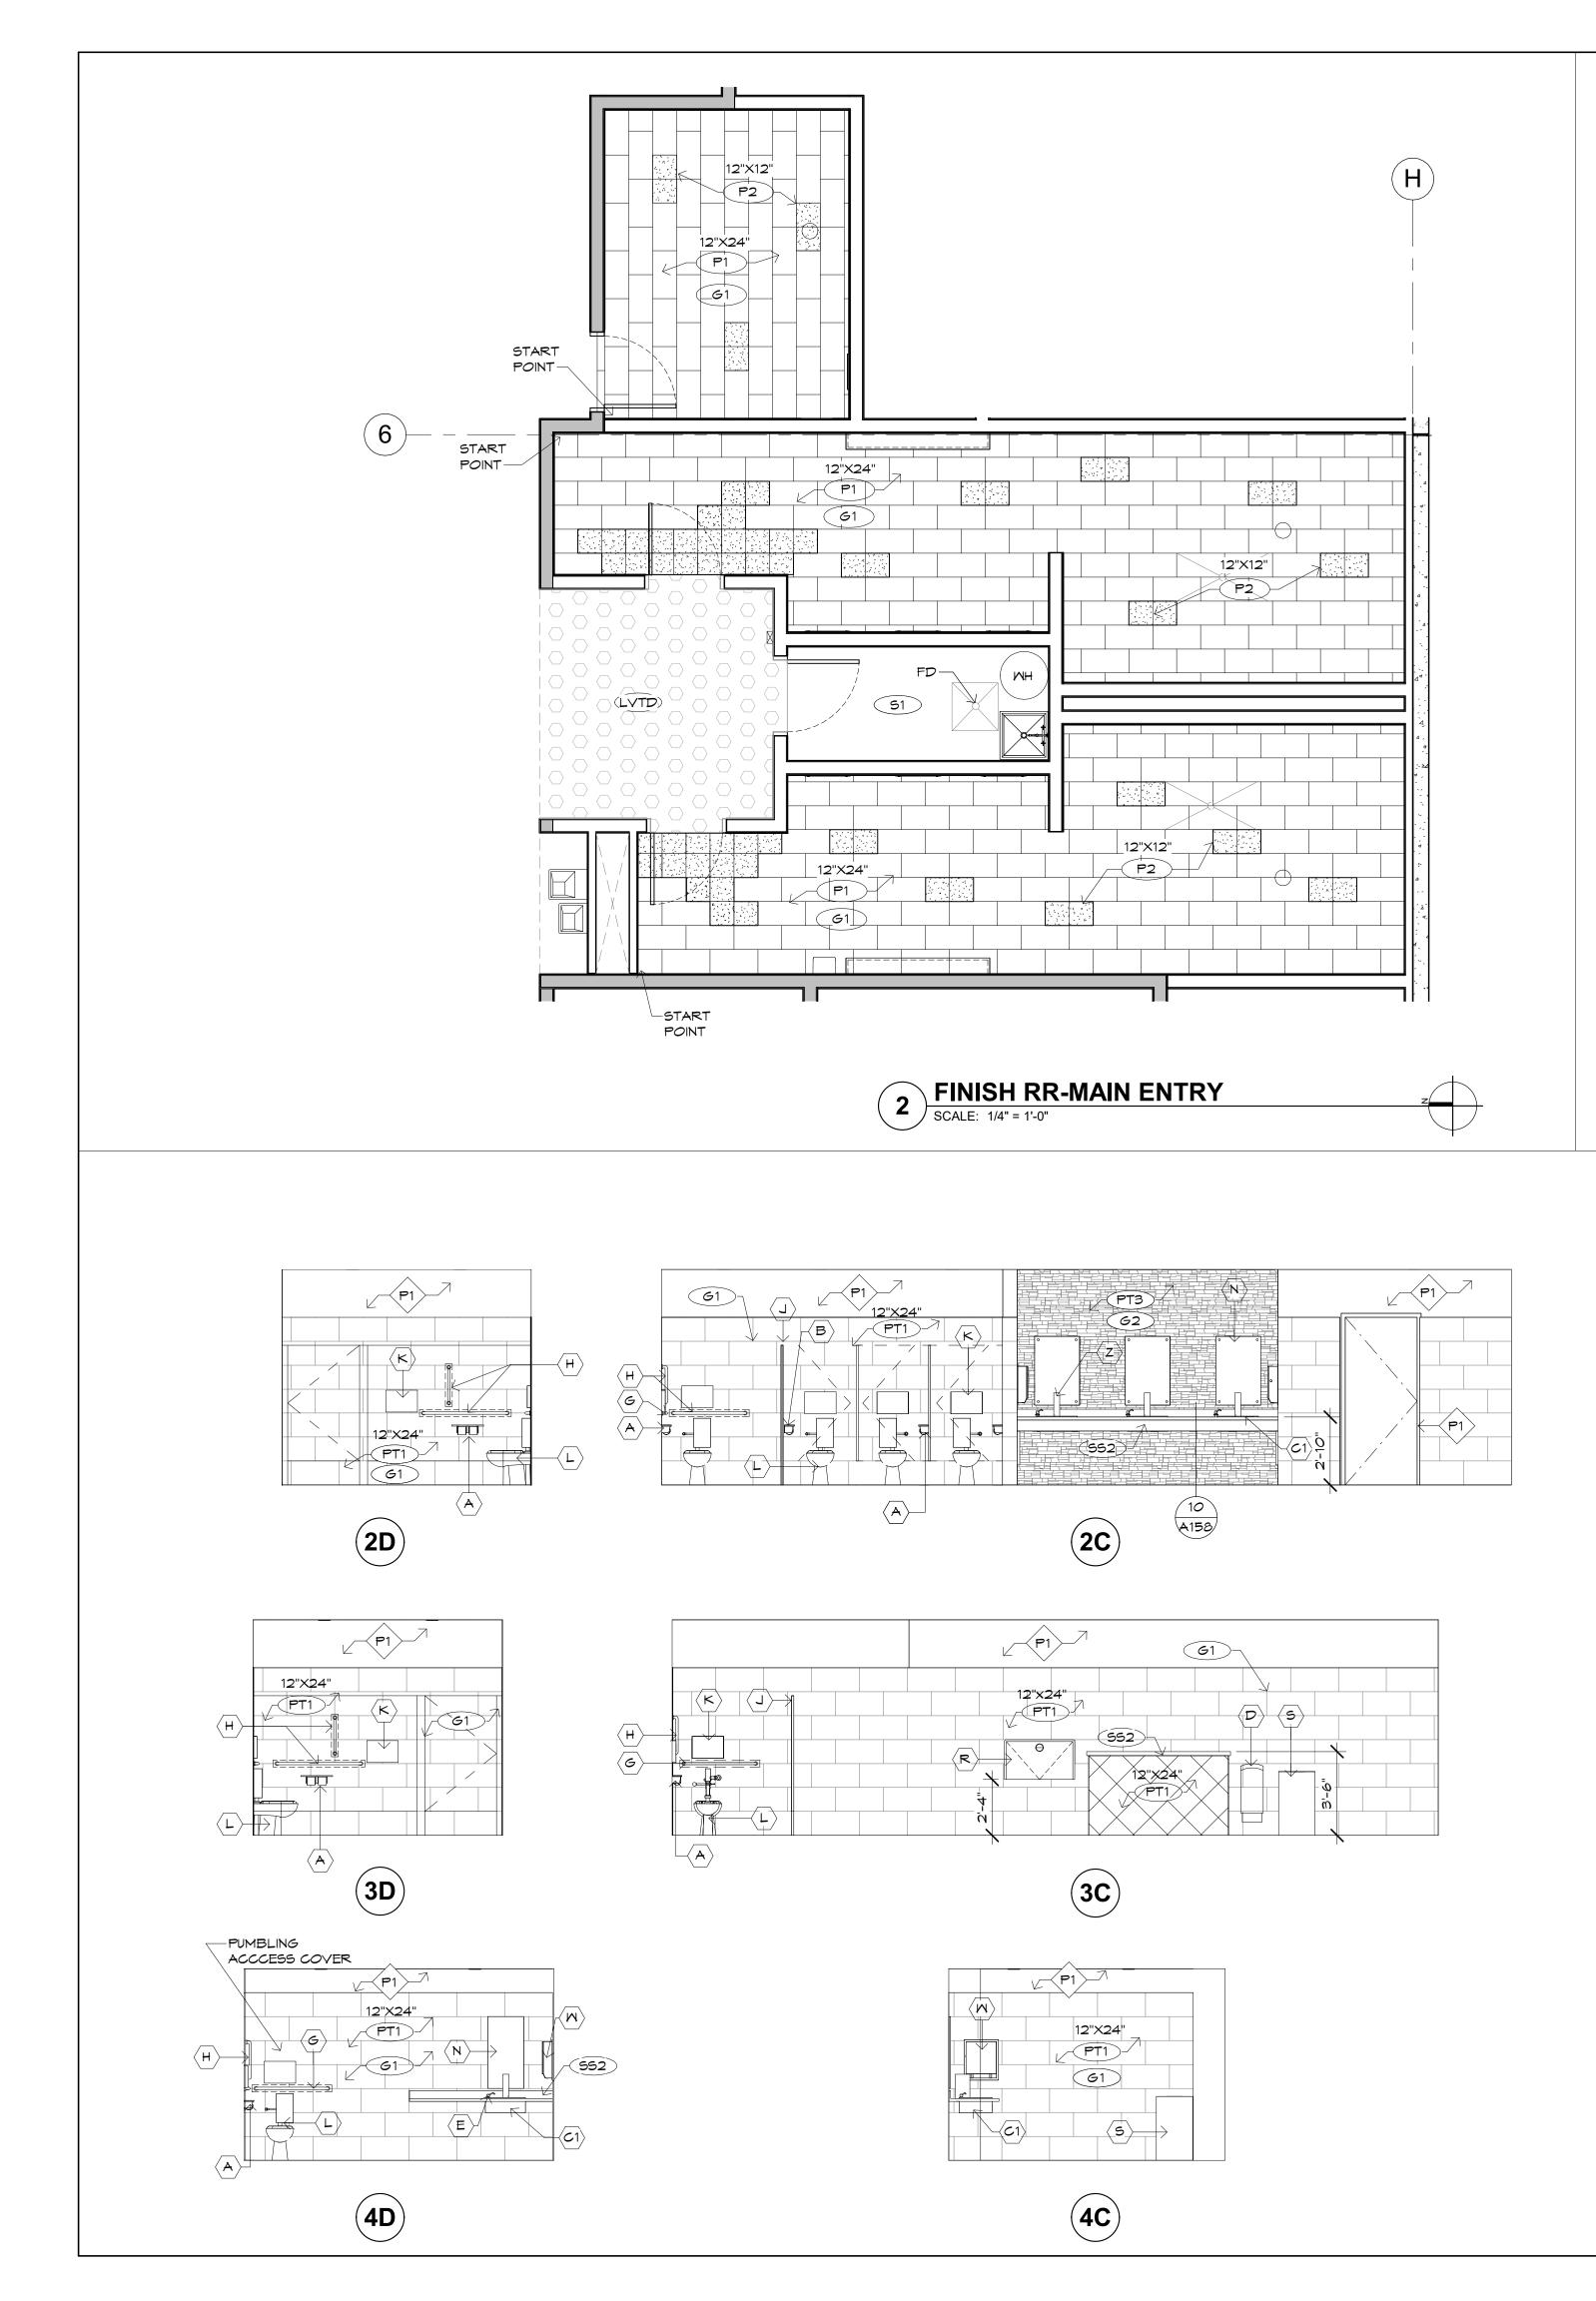


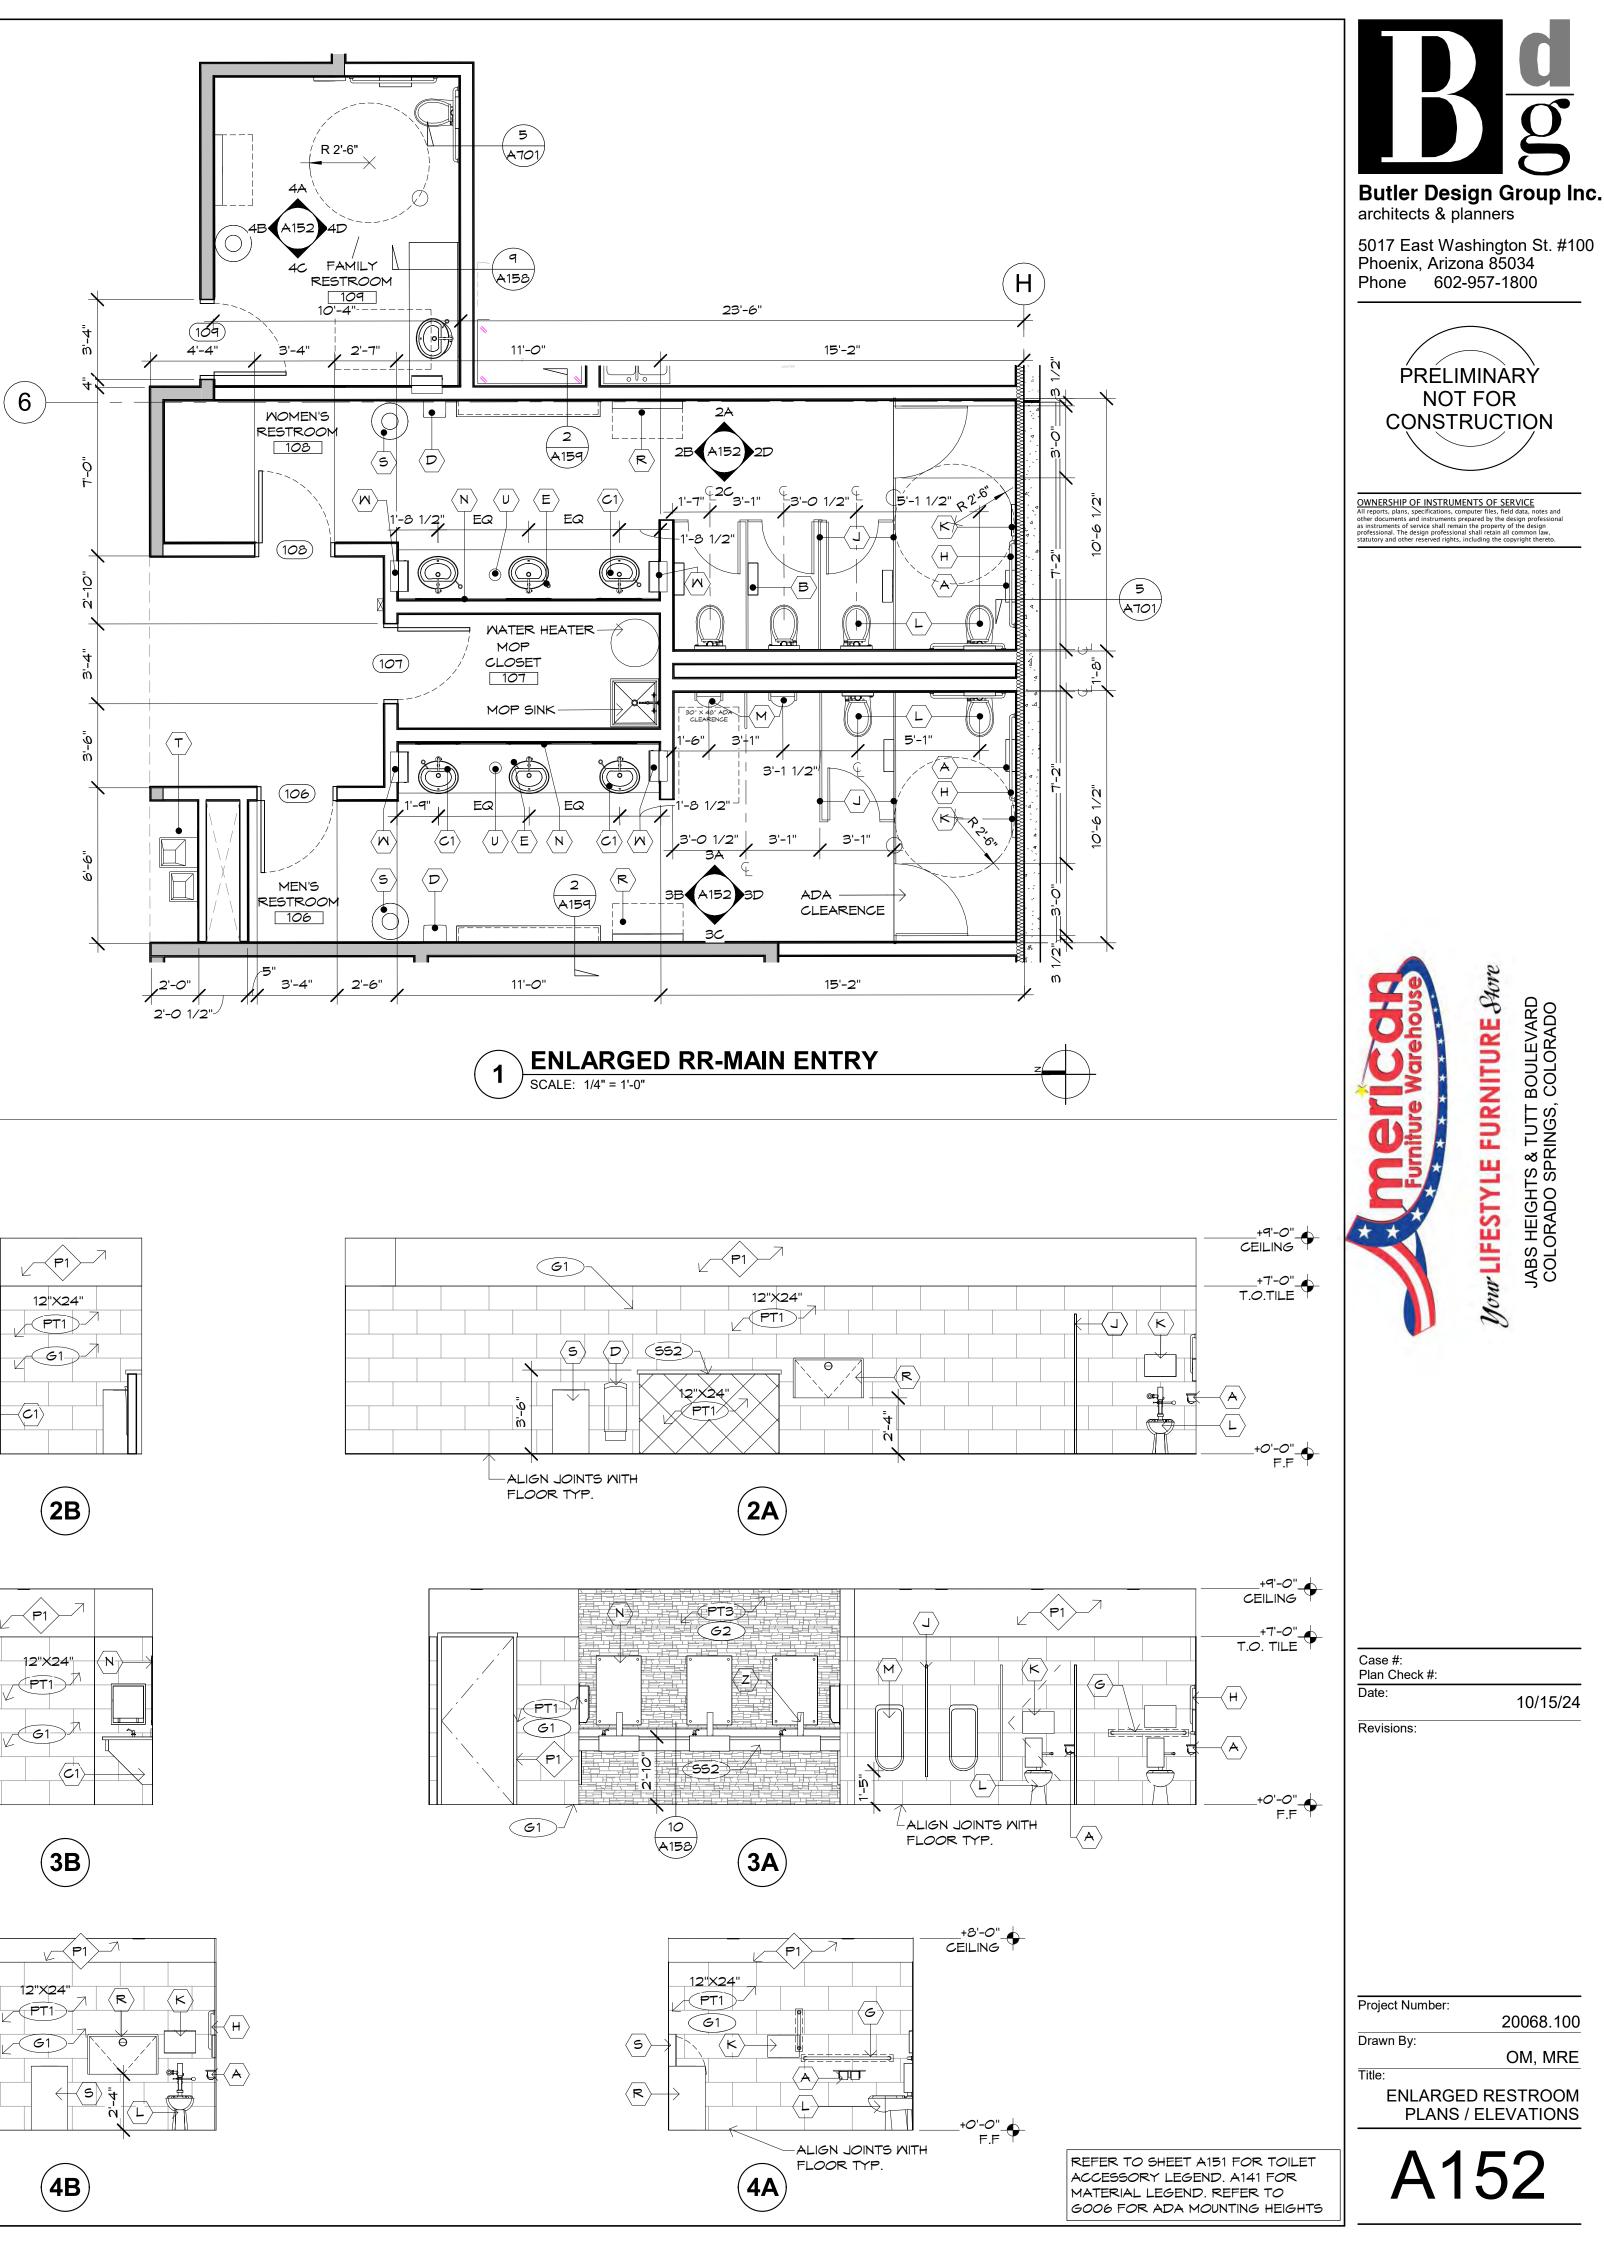


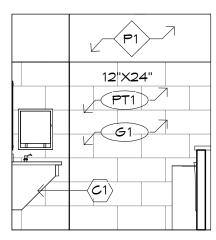


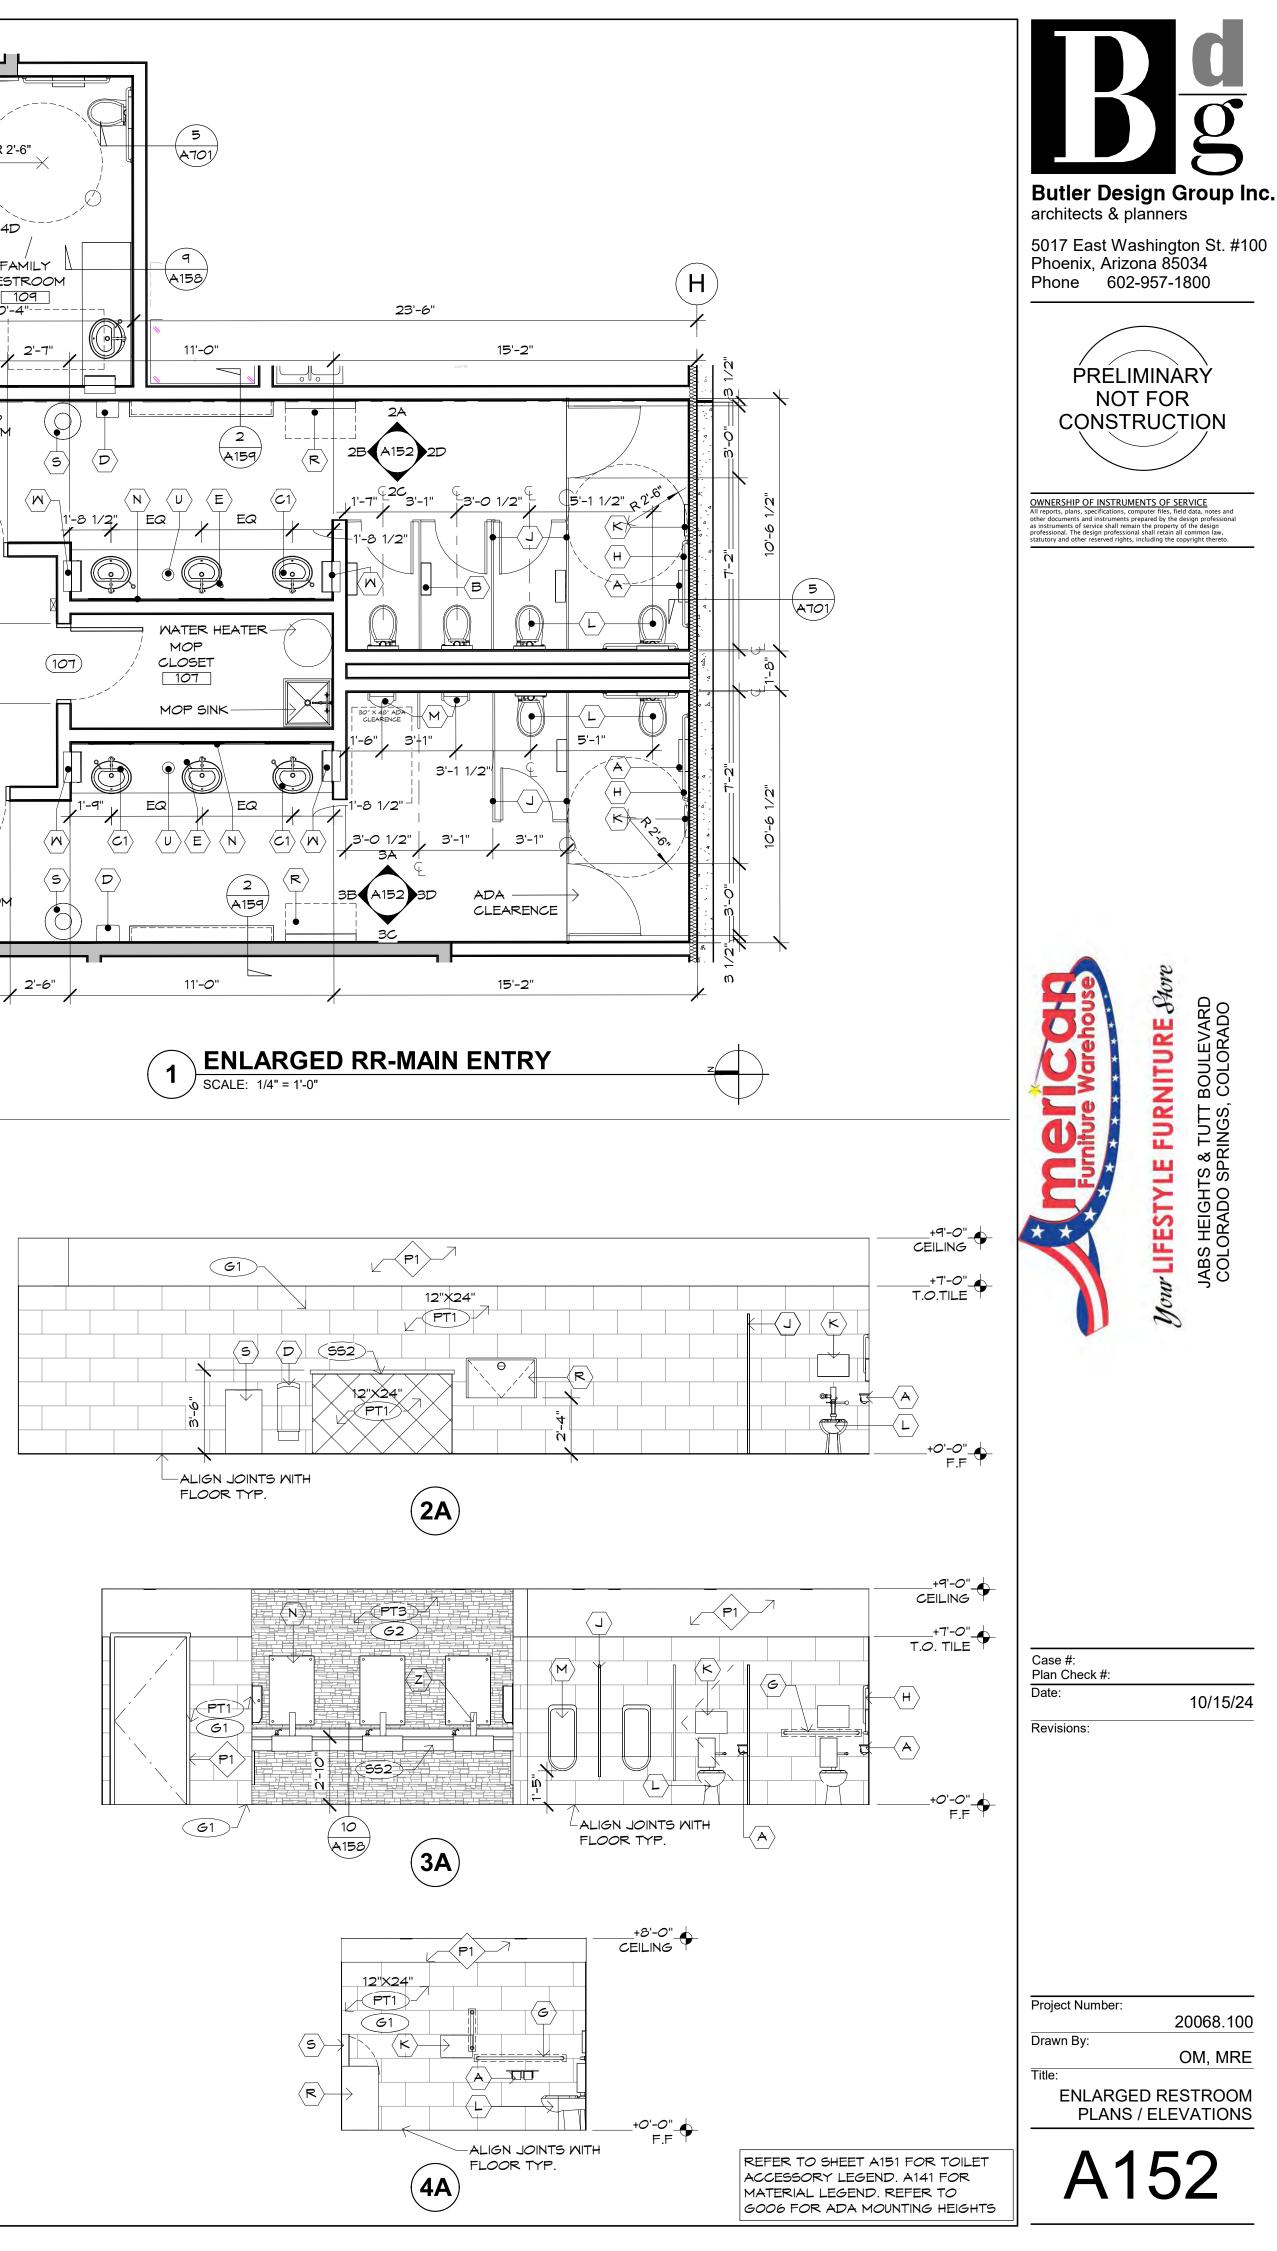


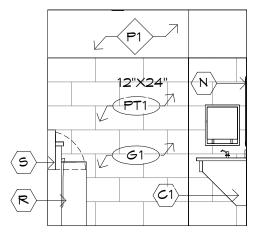


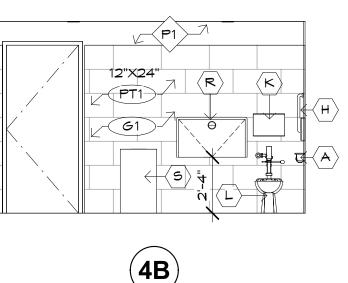


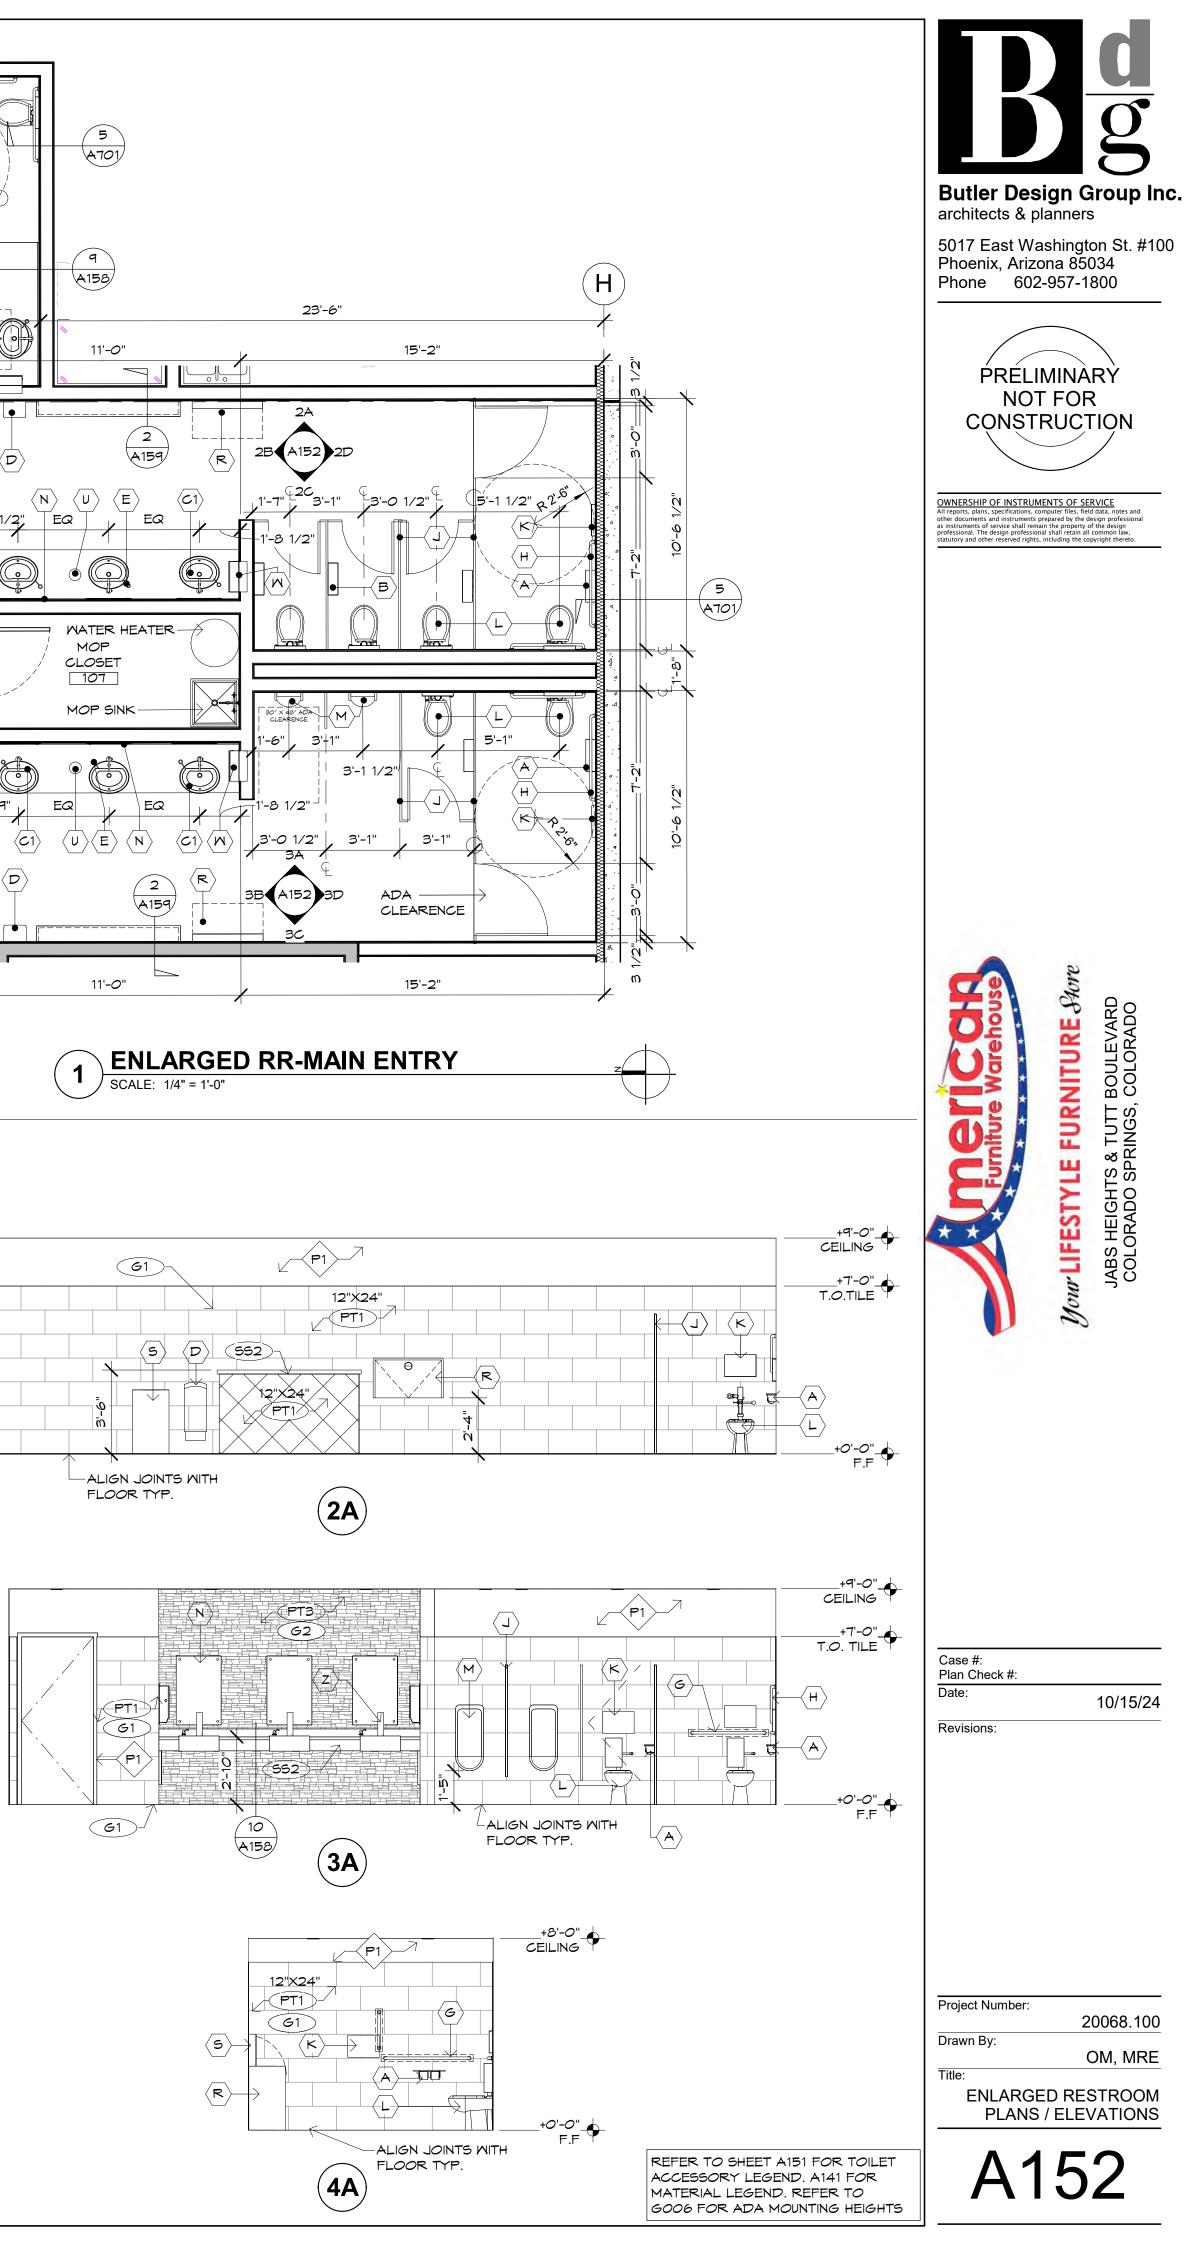


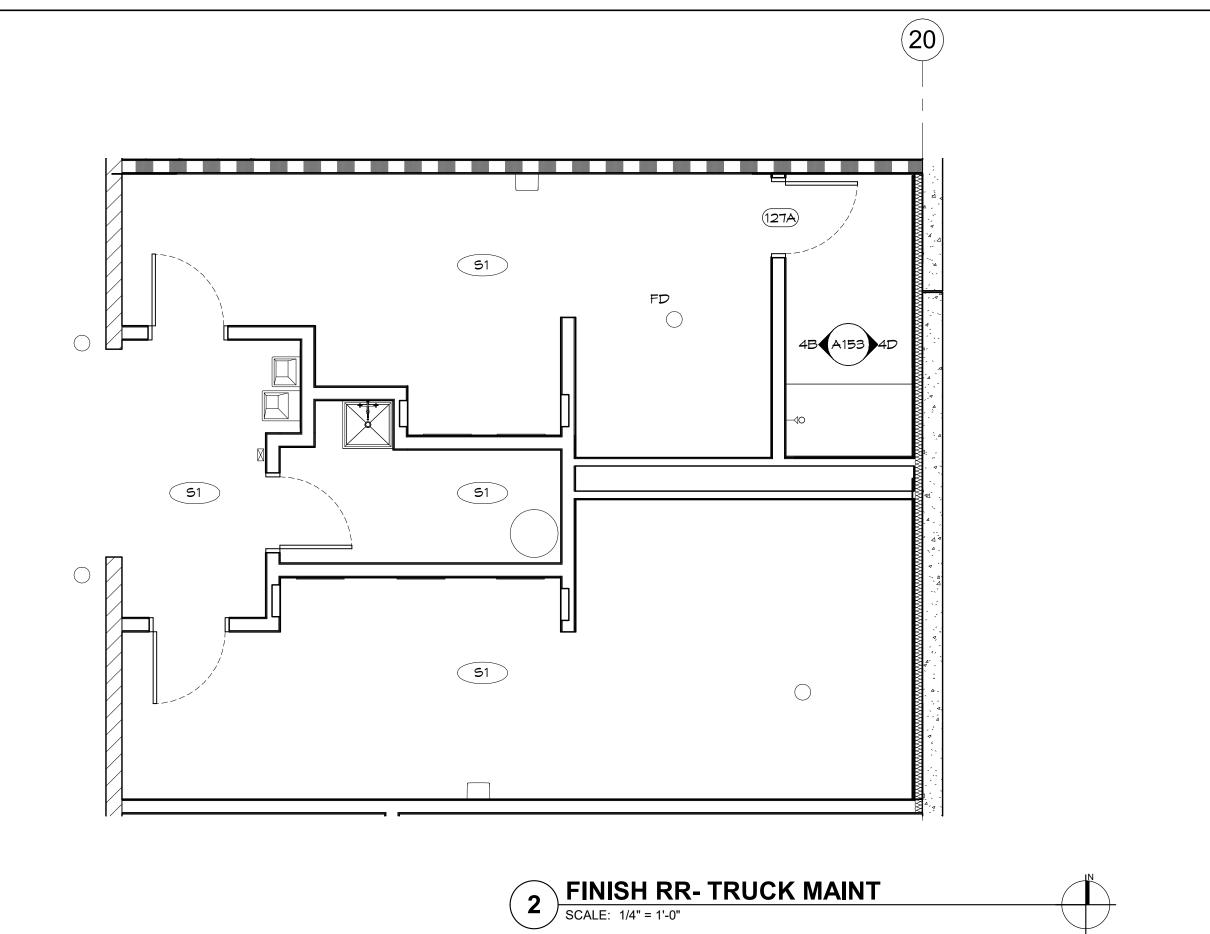


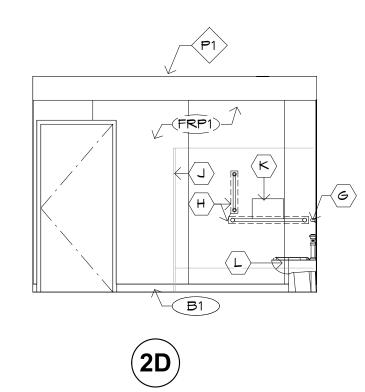


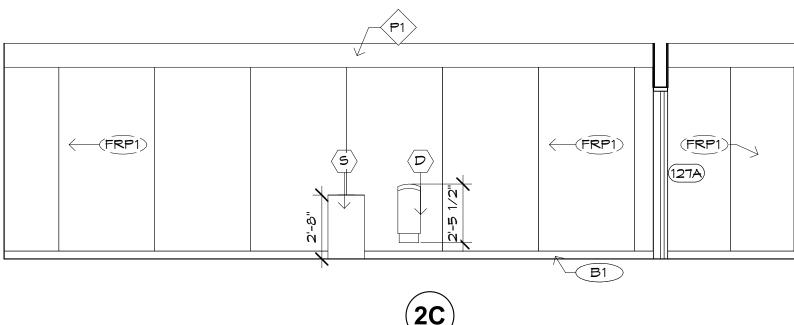


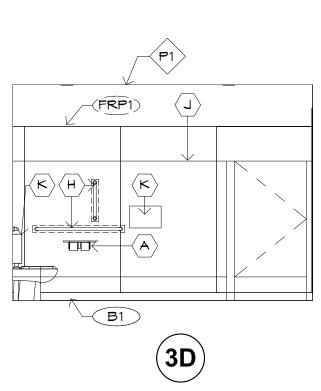


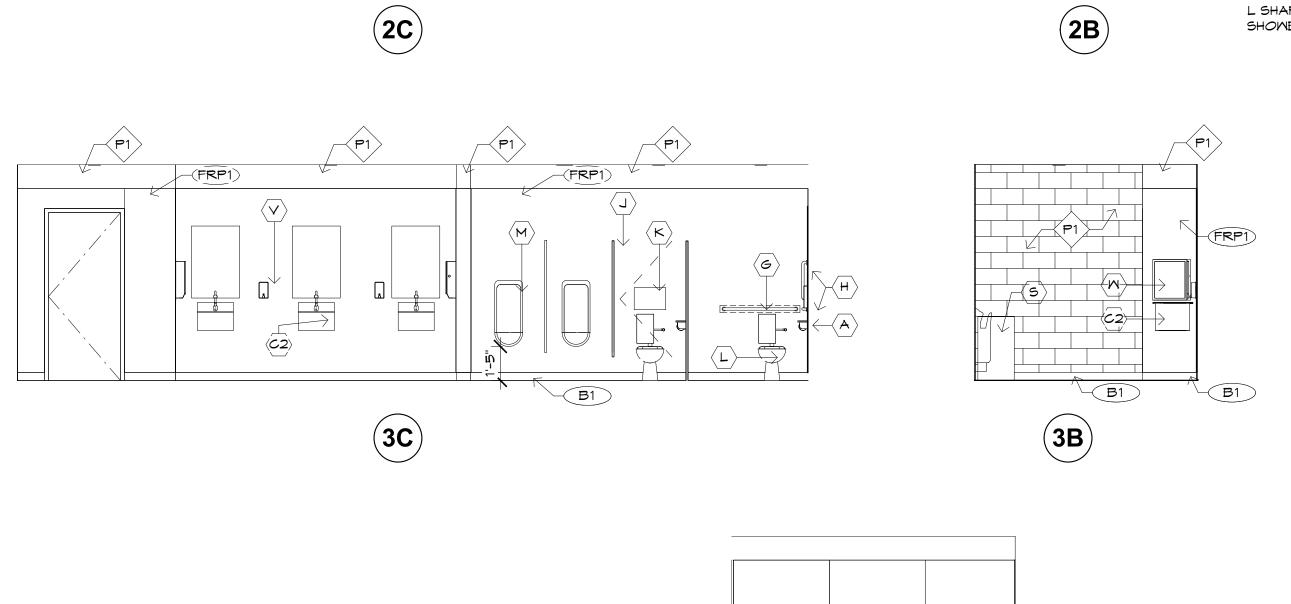


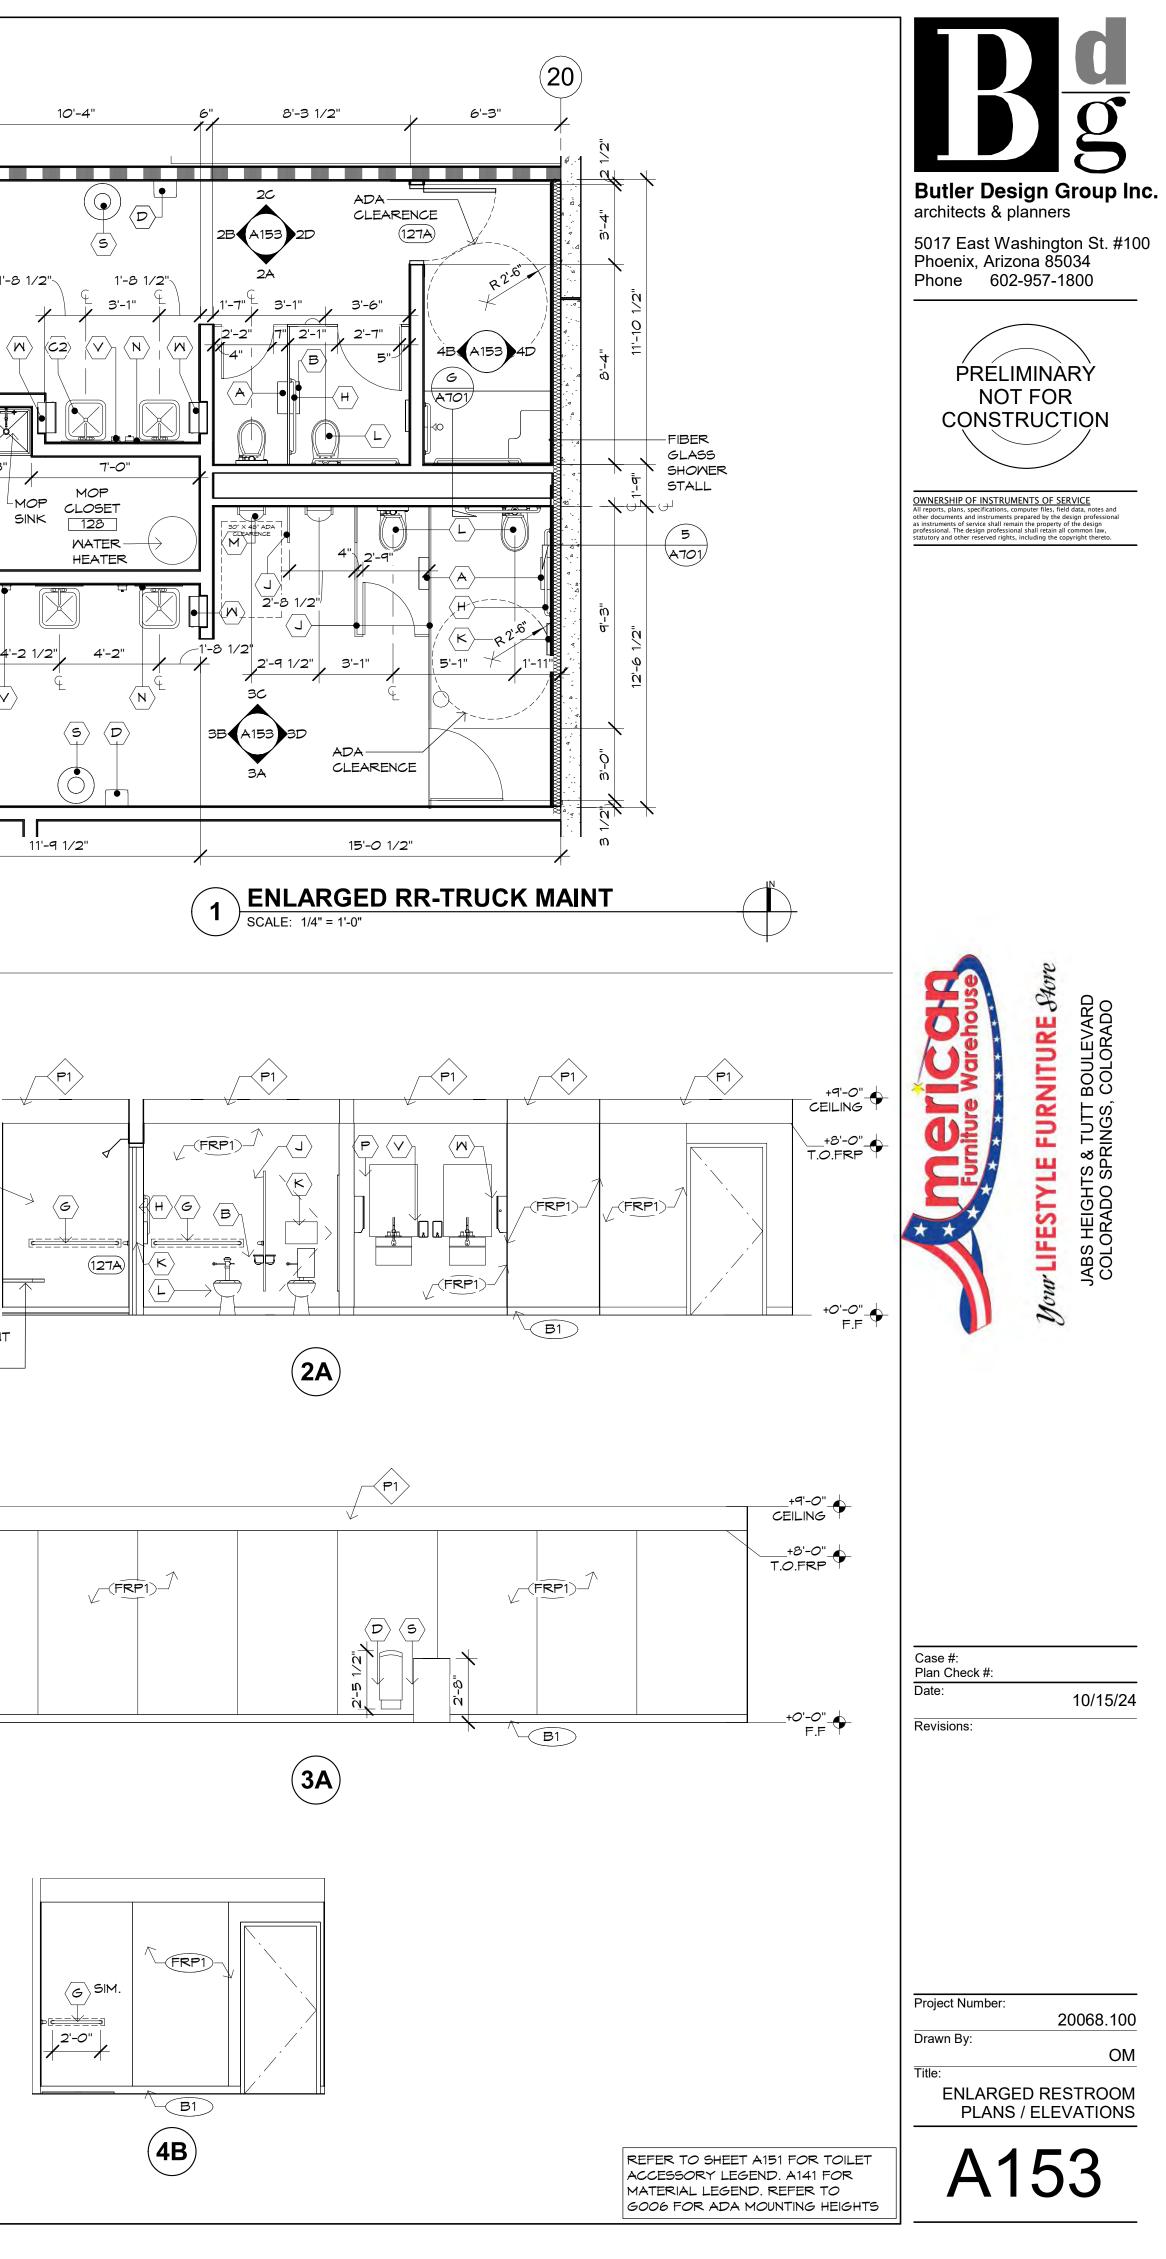

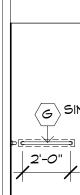


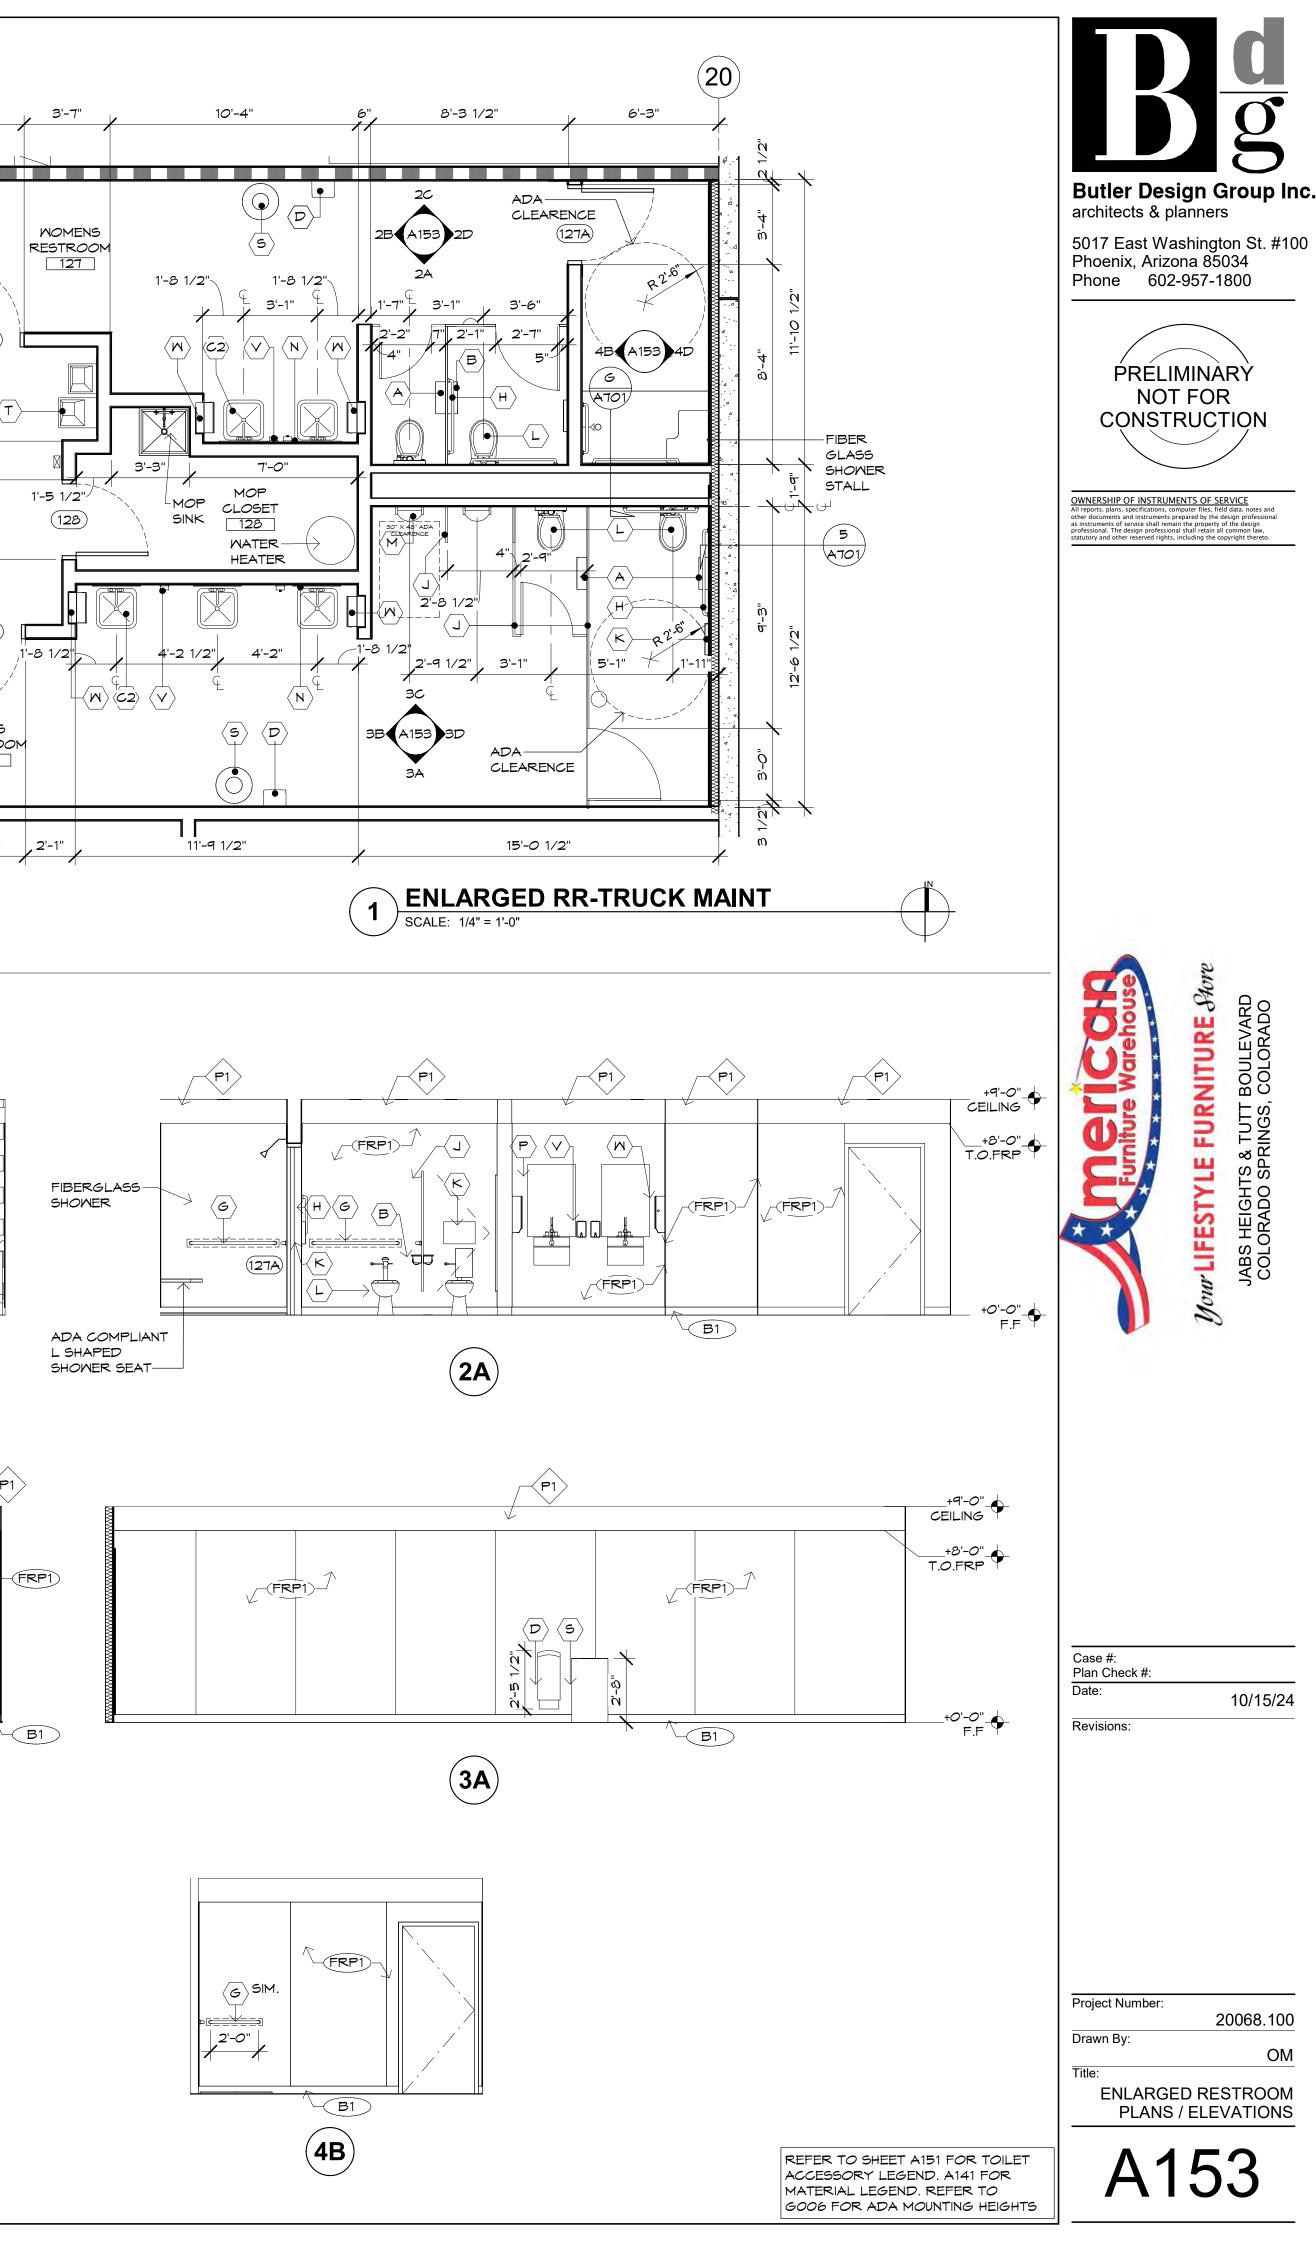


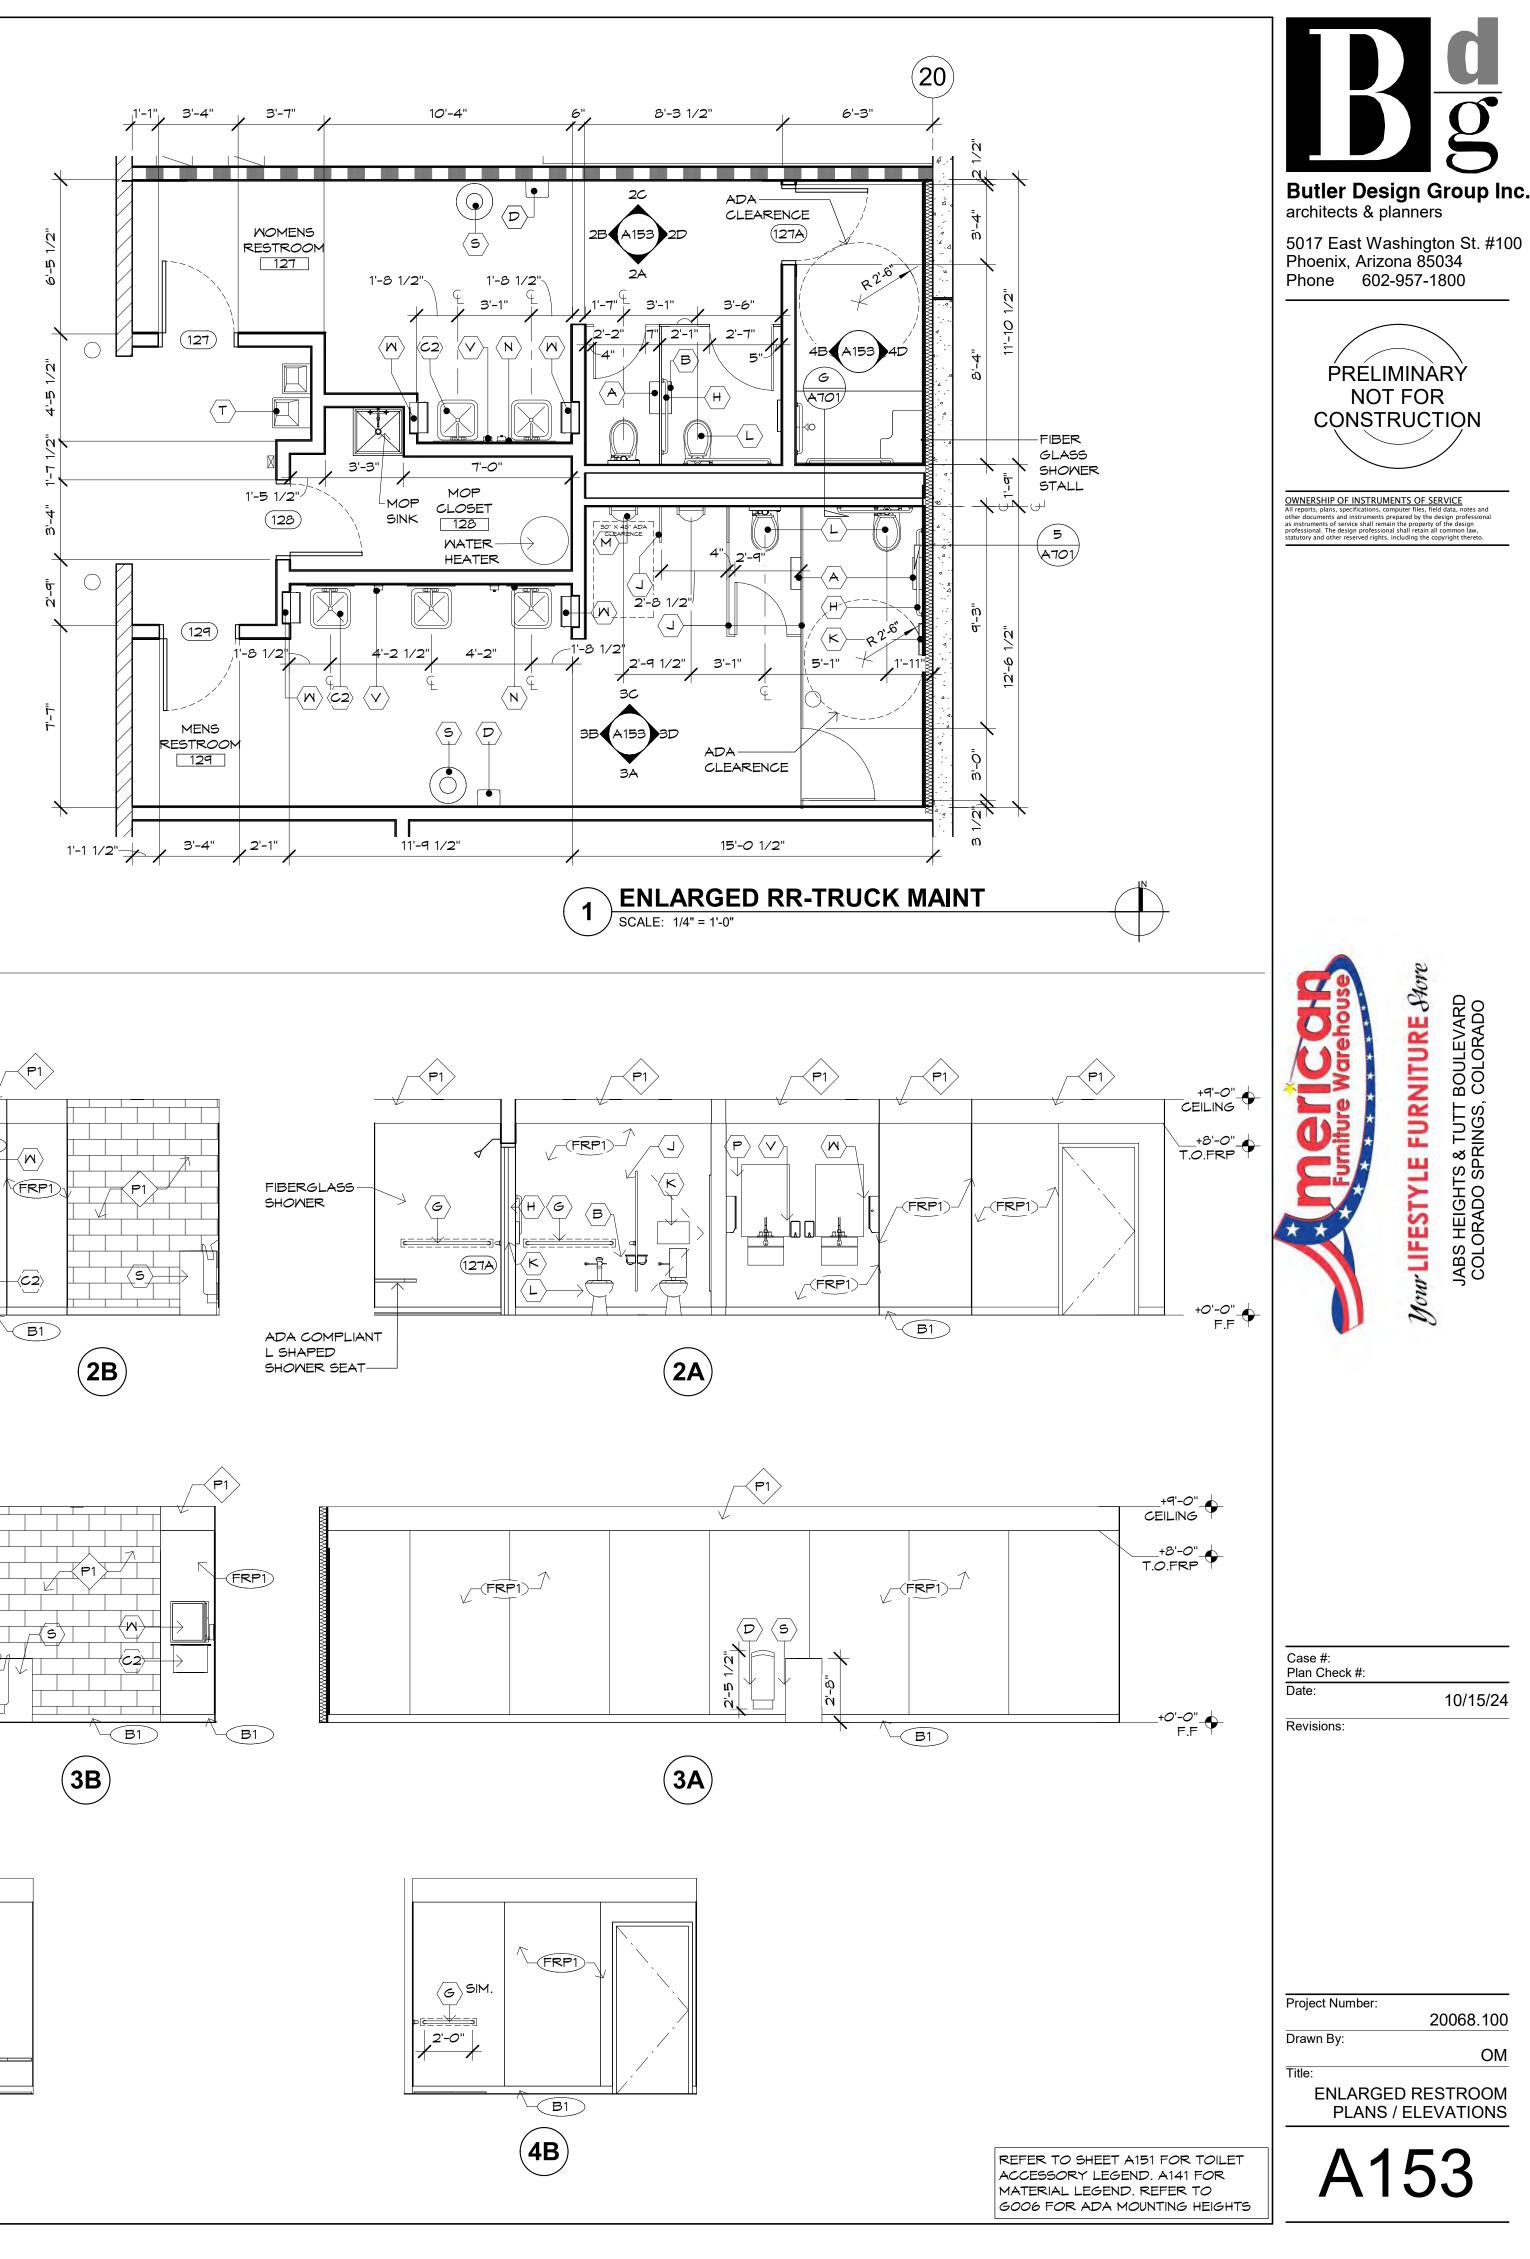


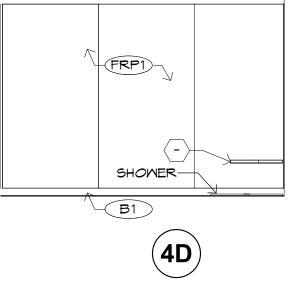



(FRP1

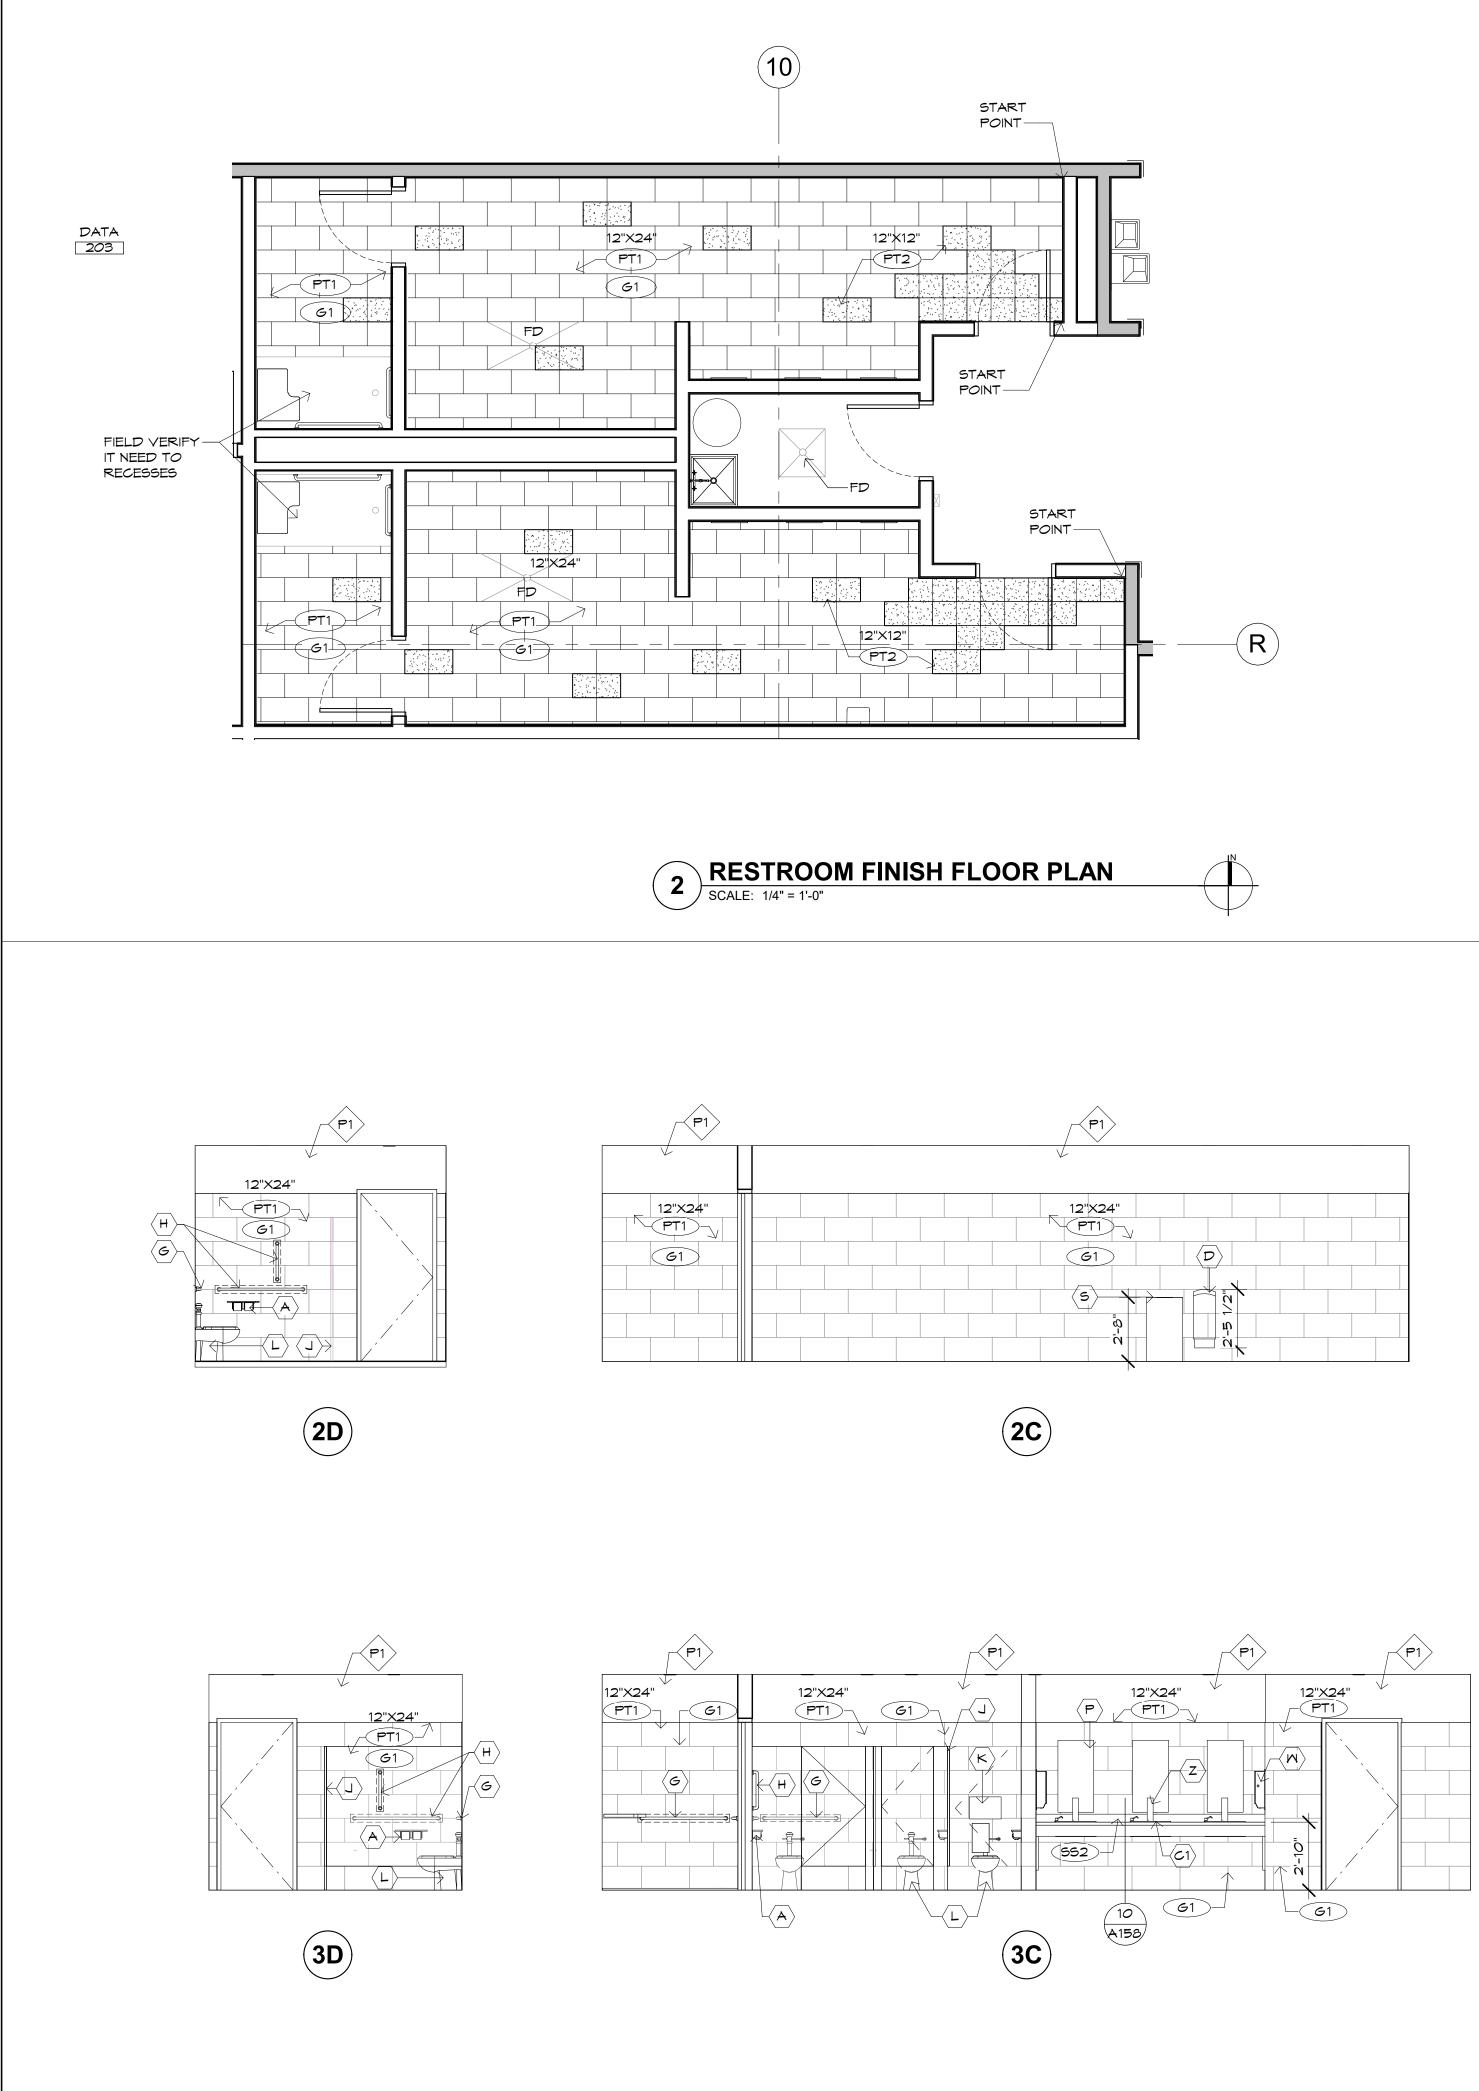


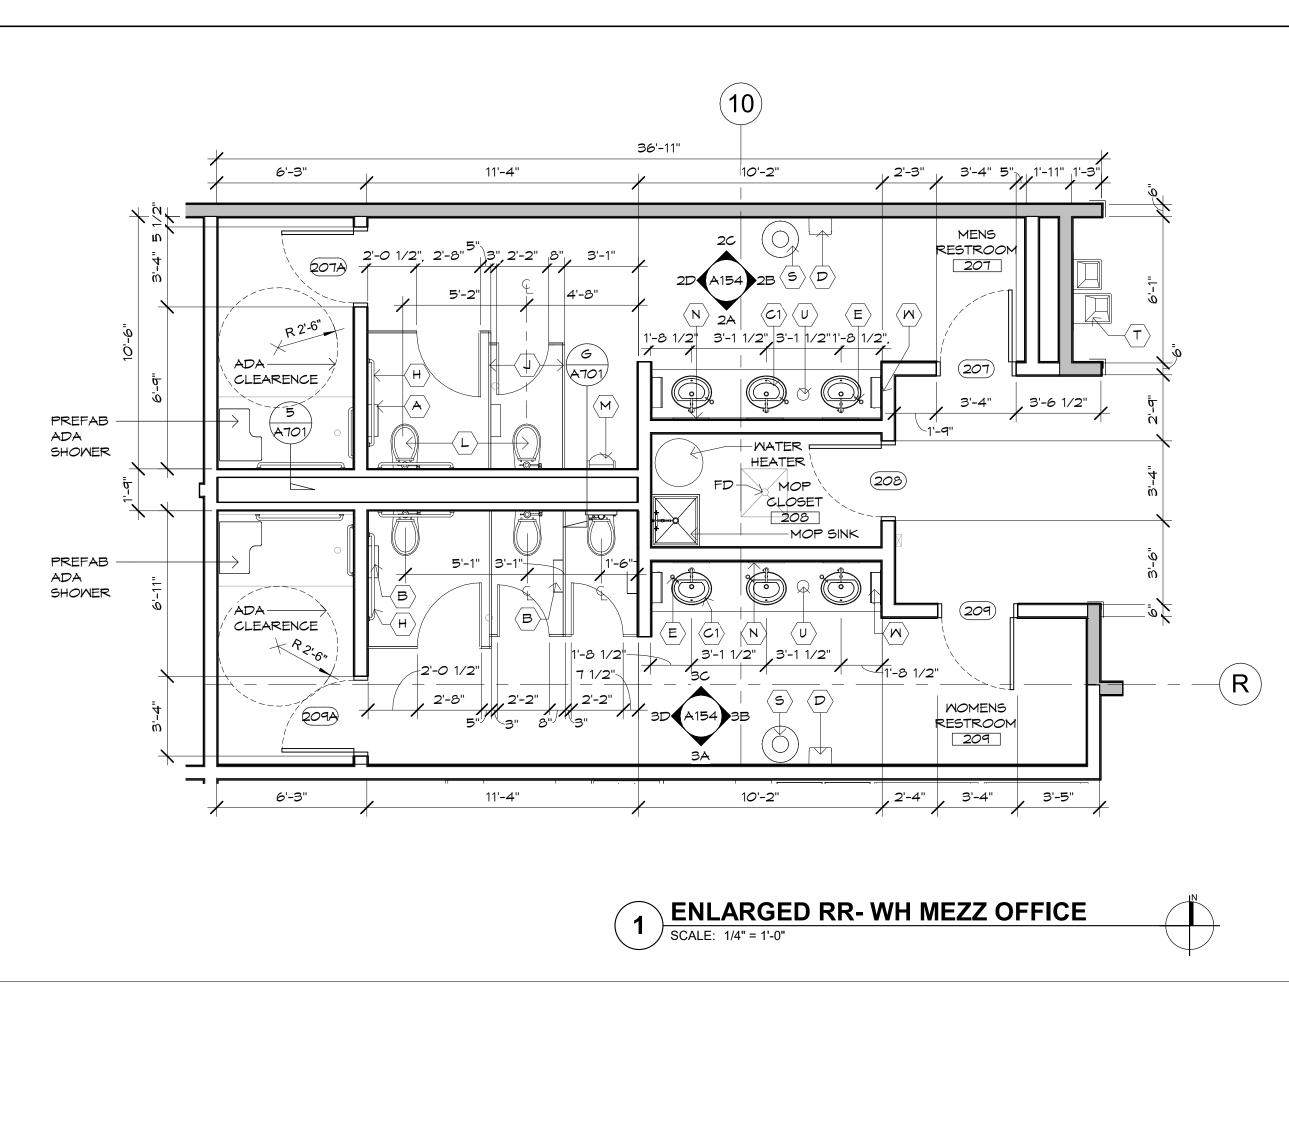

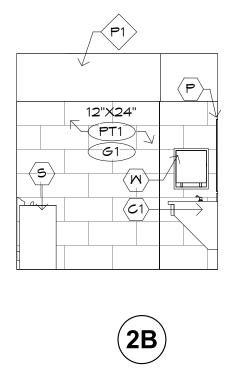

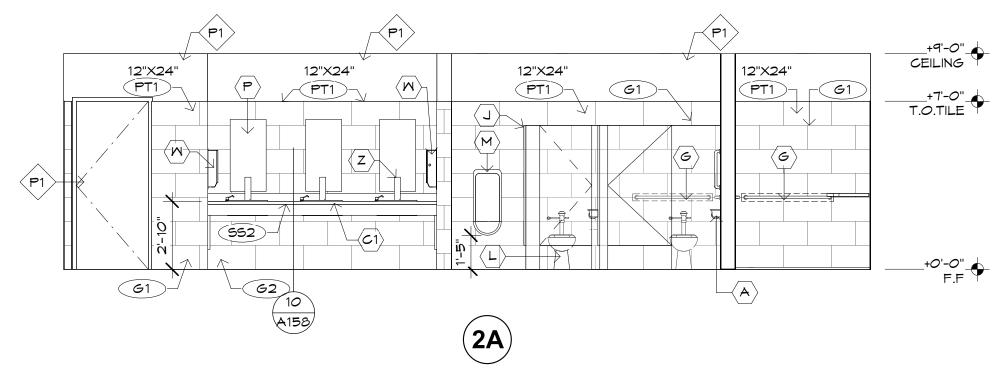


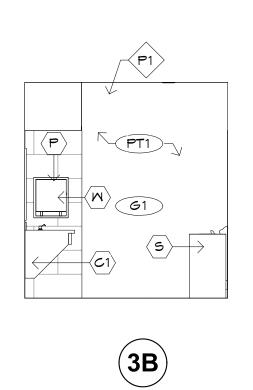


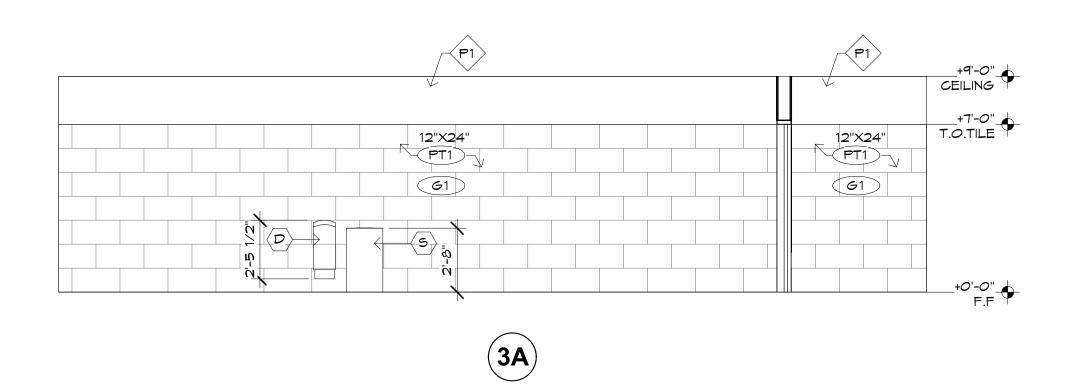





A15	54
ENLARGED F PLANS / E	RESTROOM LEVATIONS
Title:	OM, MRE
Drawn By:	
Project Number:	20068.100

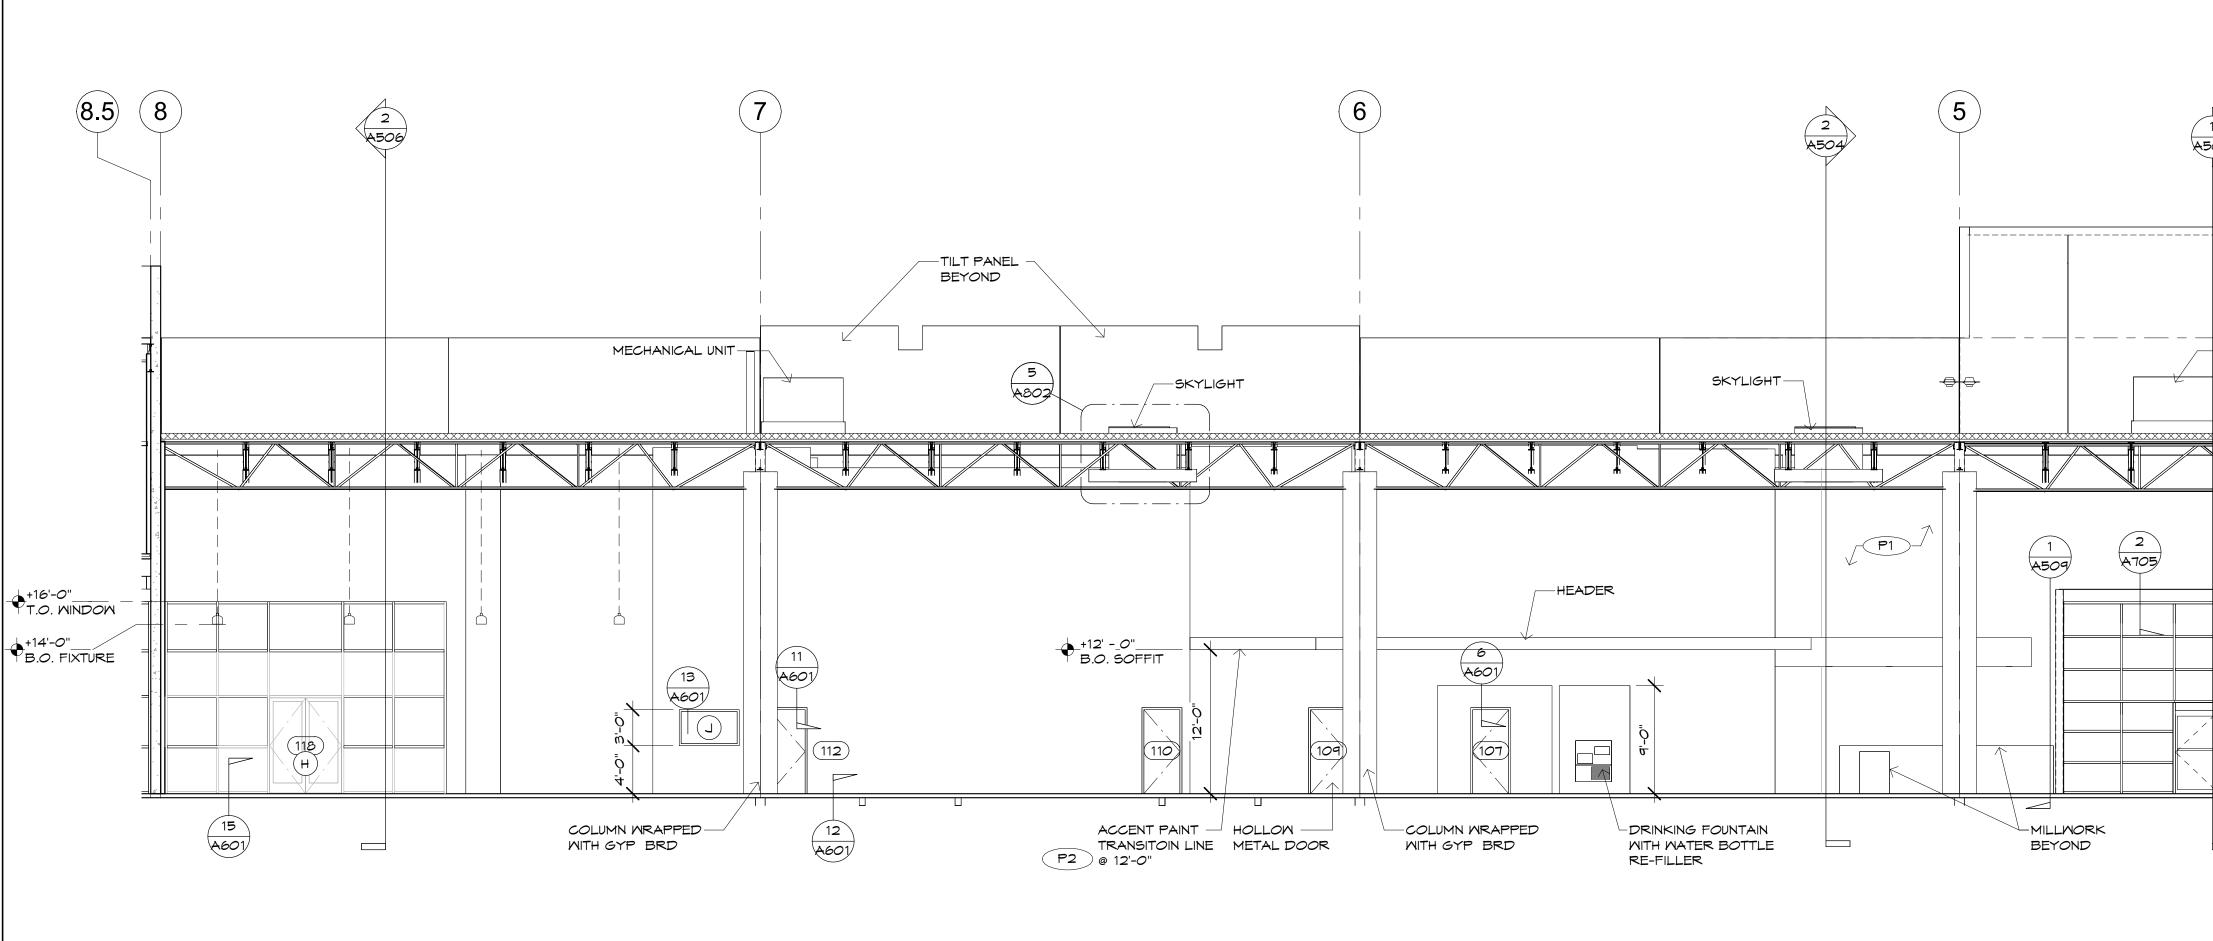

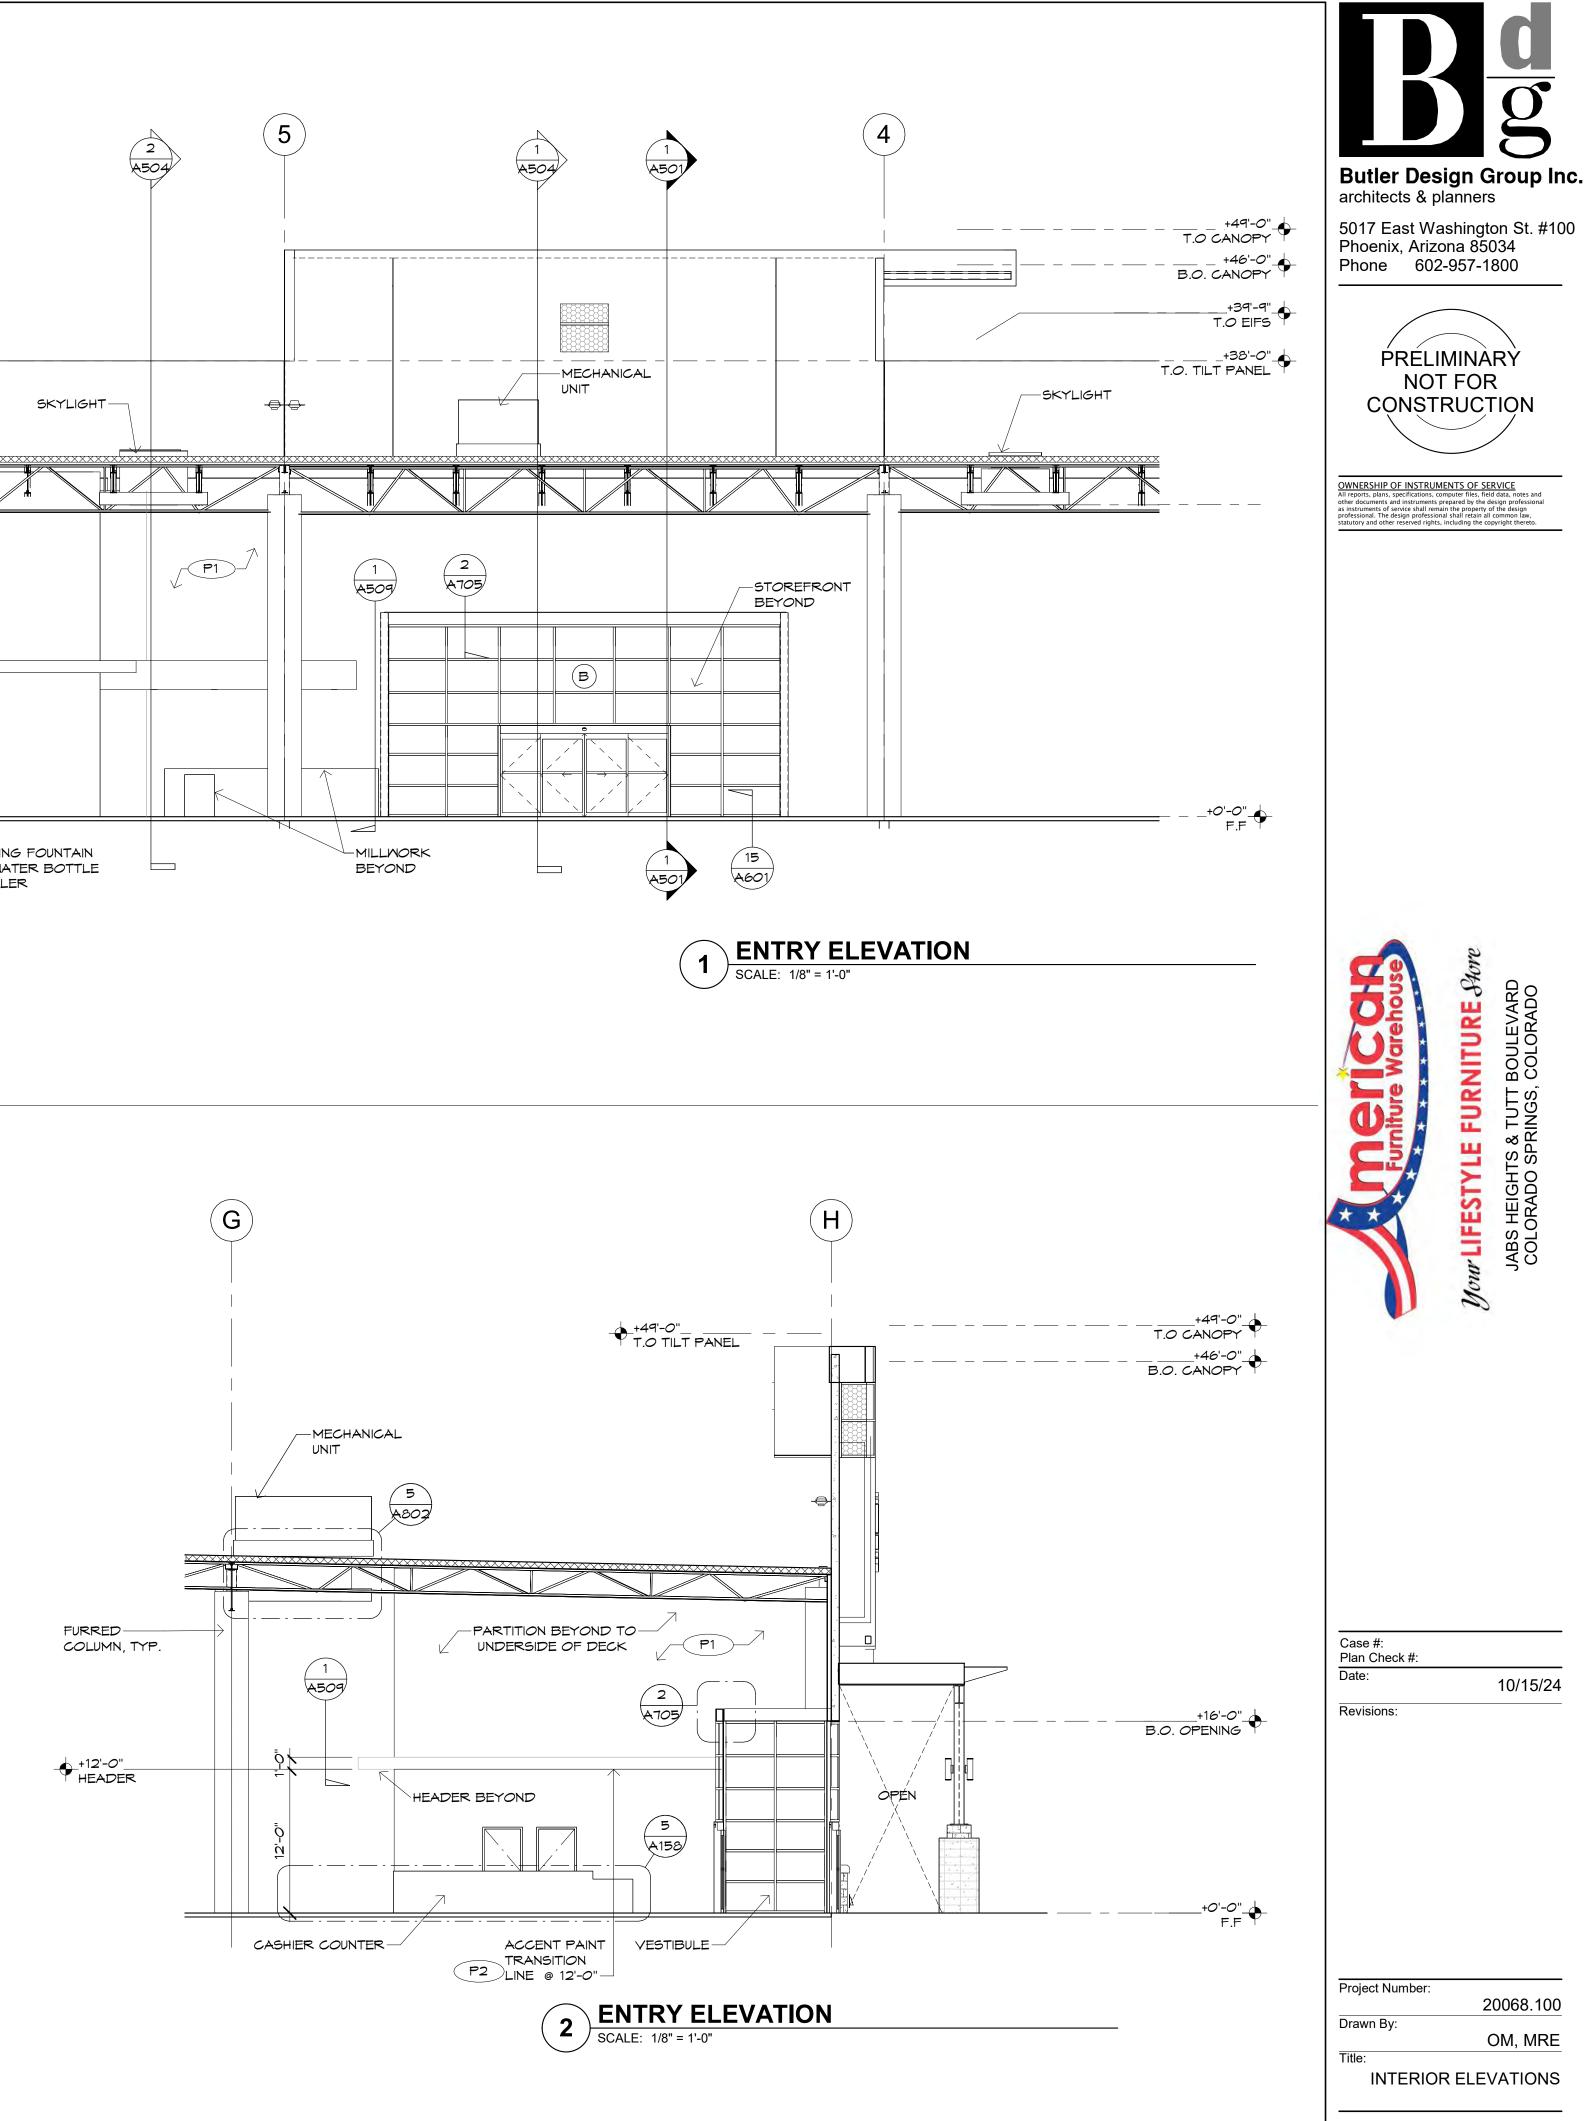


A155

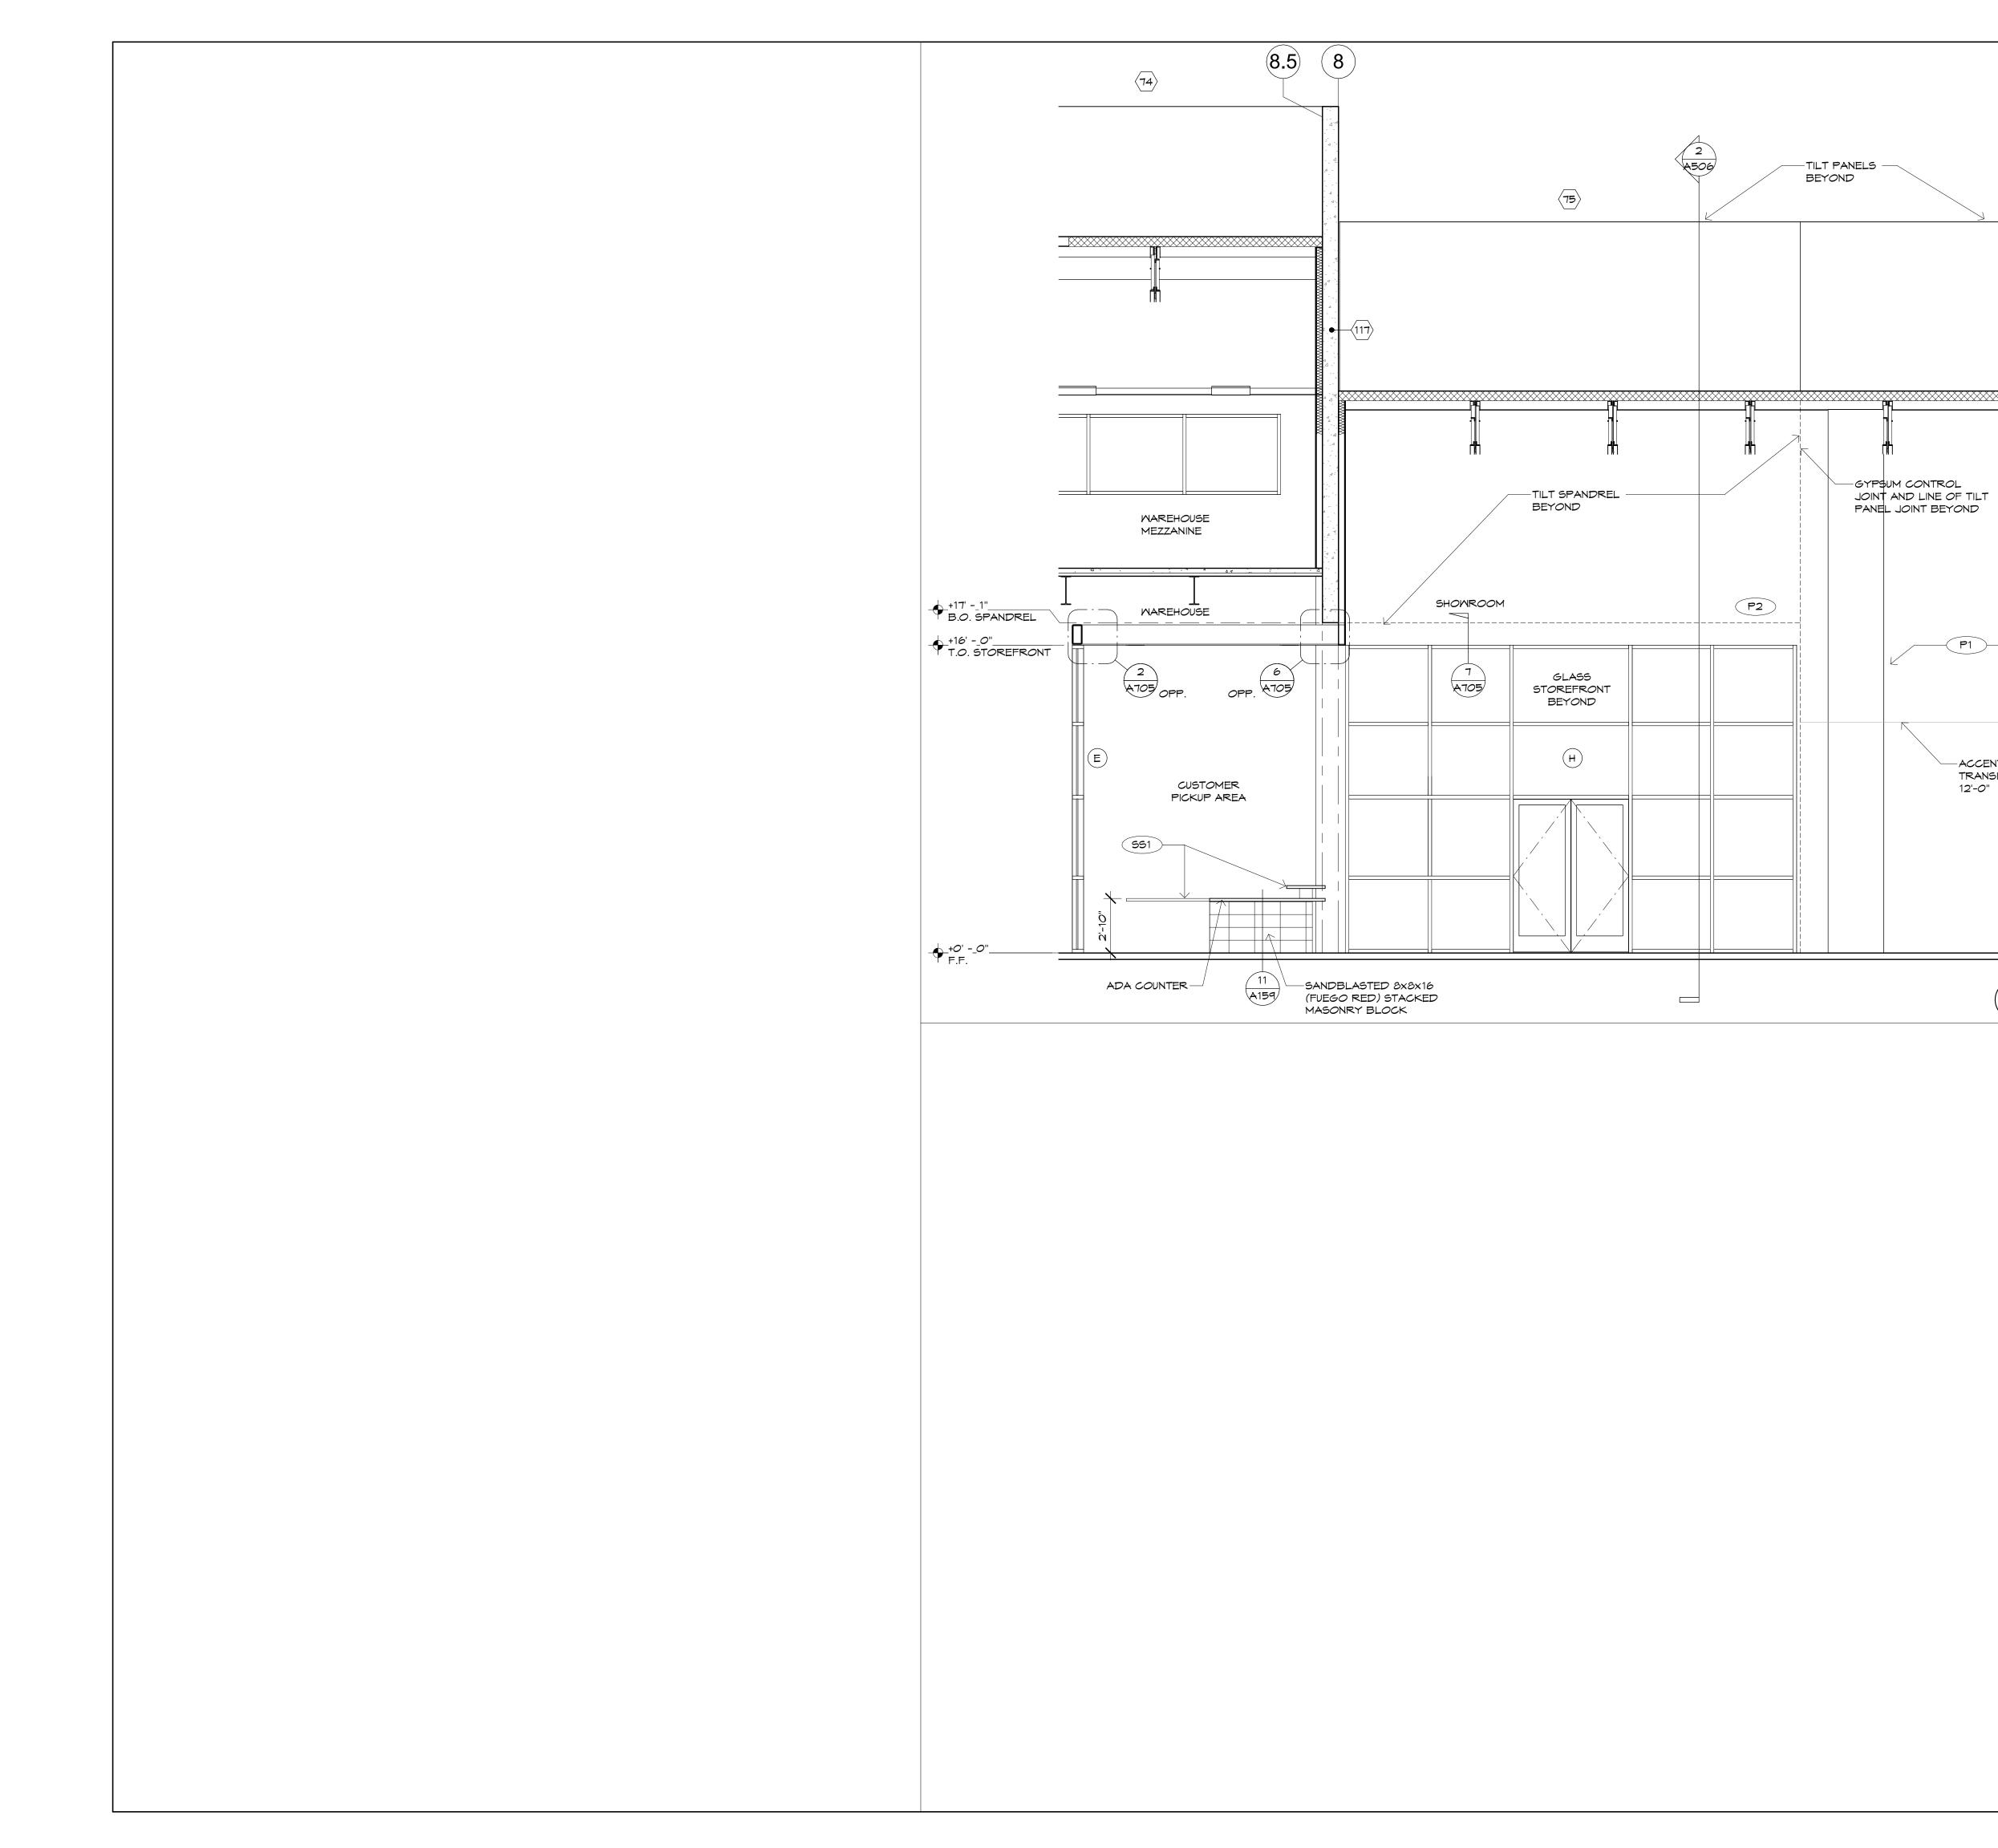


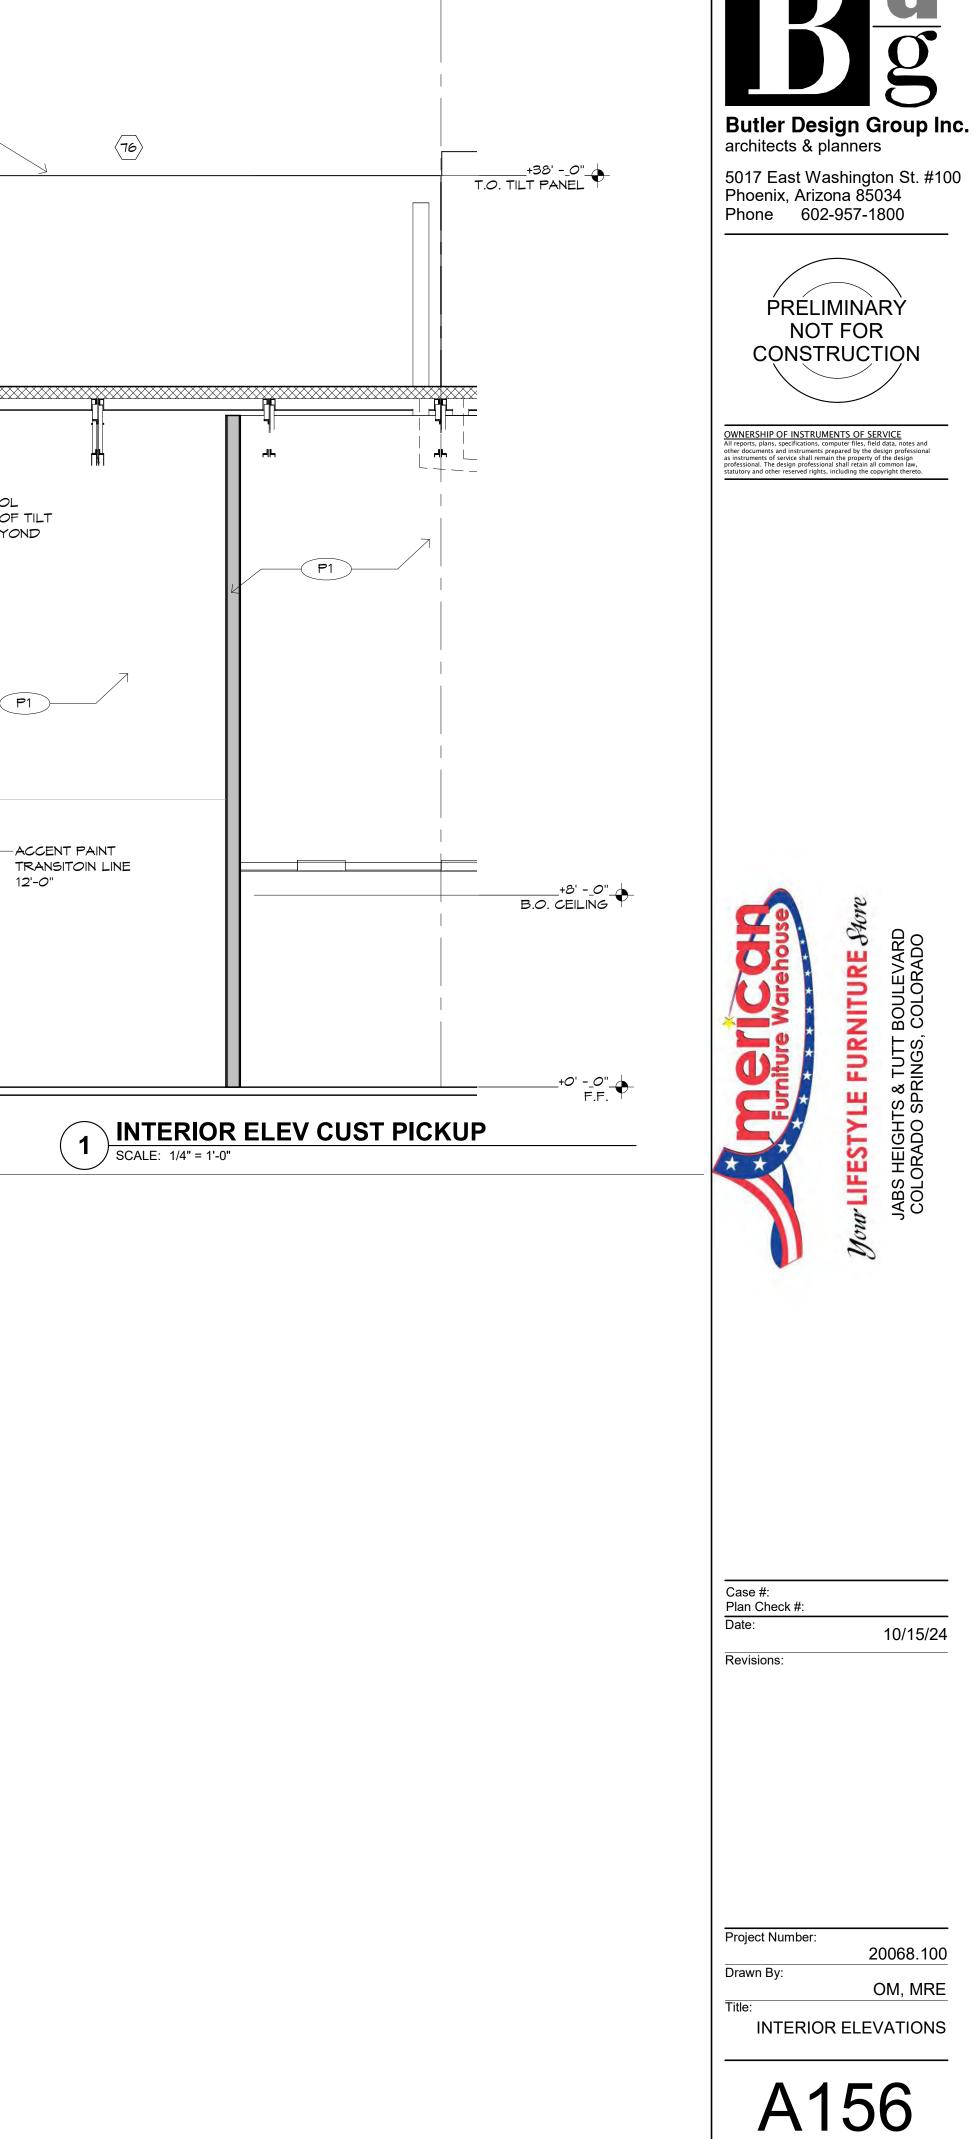

(7)

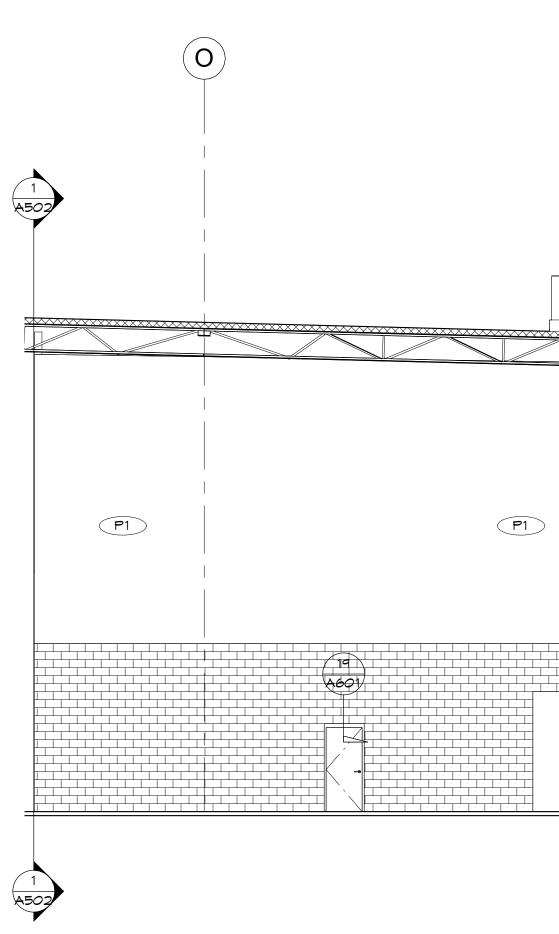

			F
3 A509	P1		P1
		$\vec{4}$	

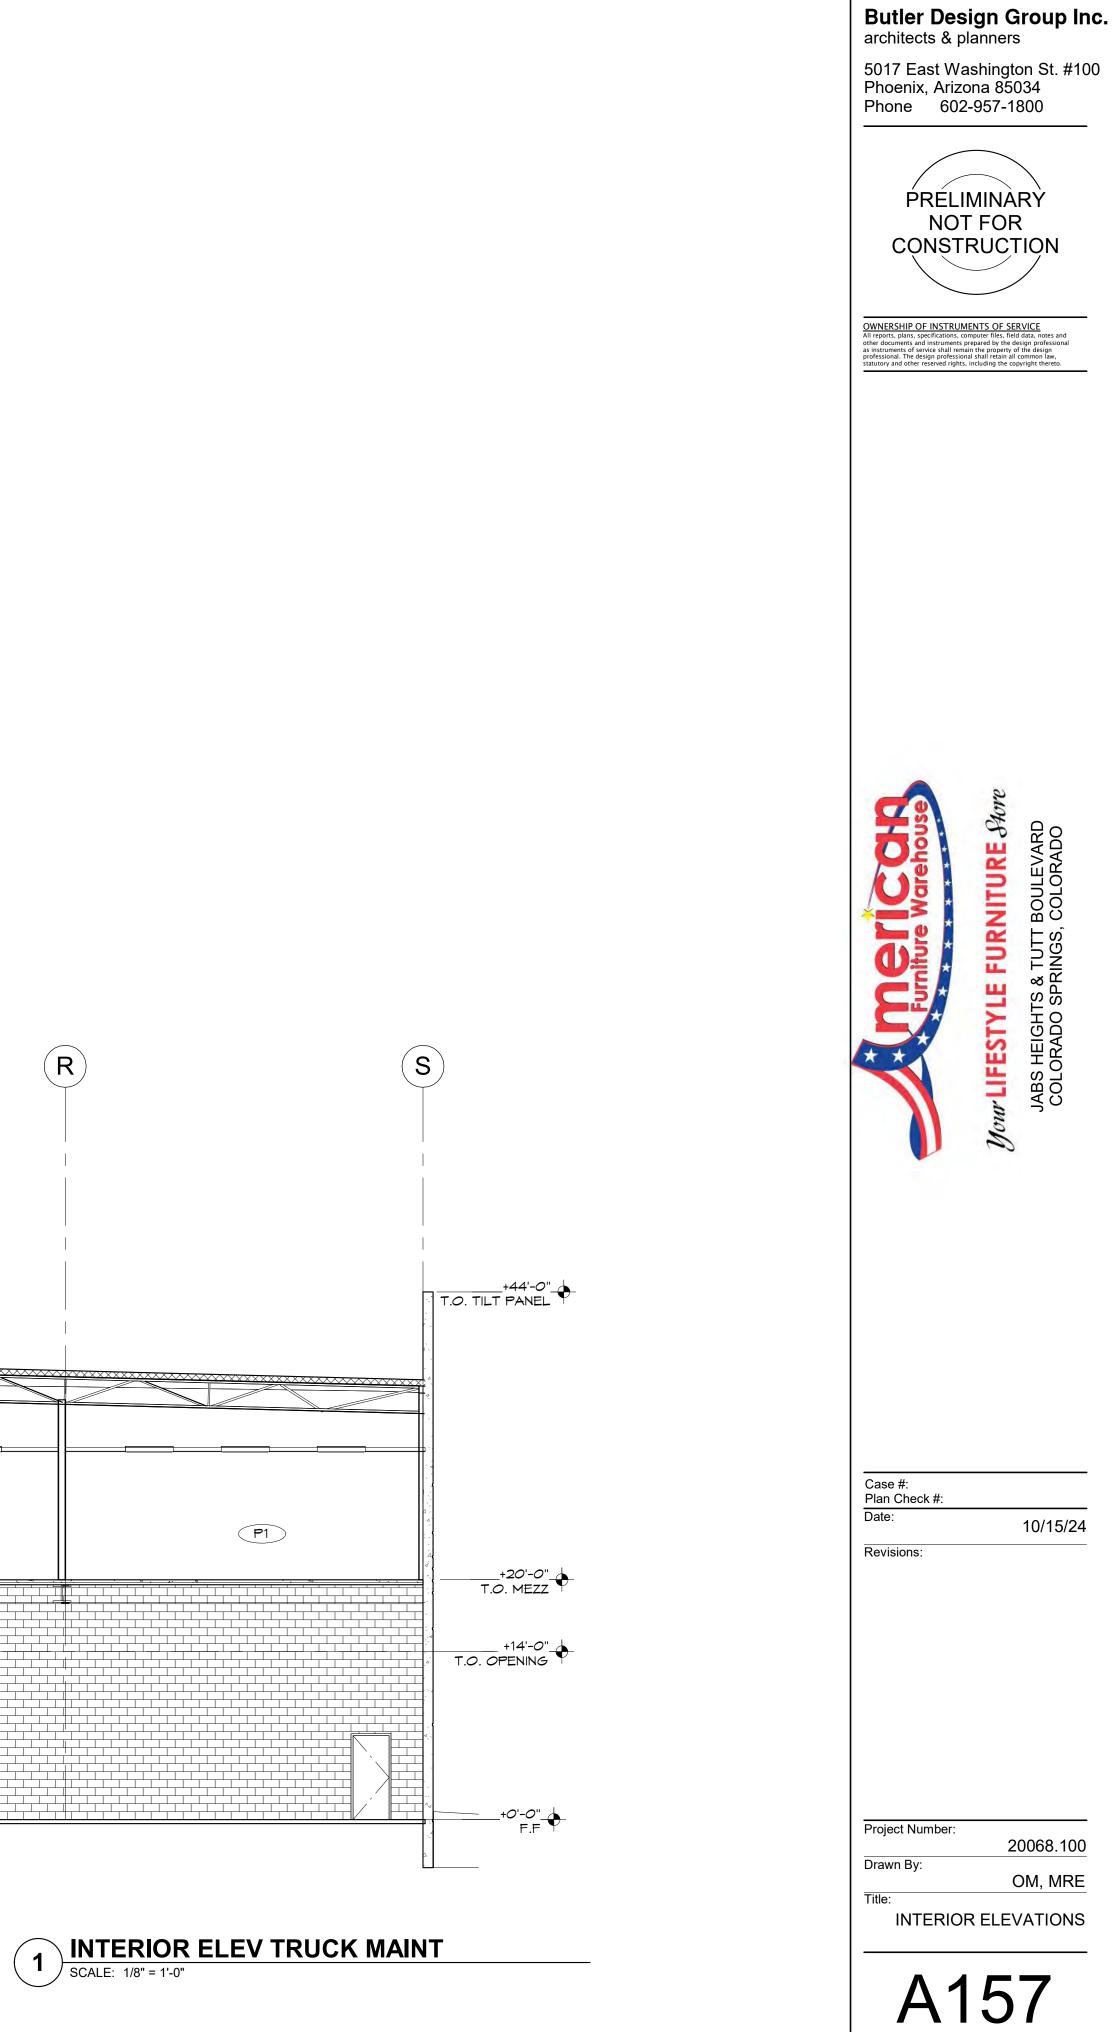



<u>d</u> g


10/15/24

20068.100


OM, MRE

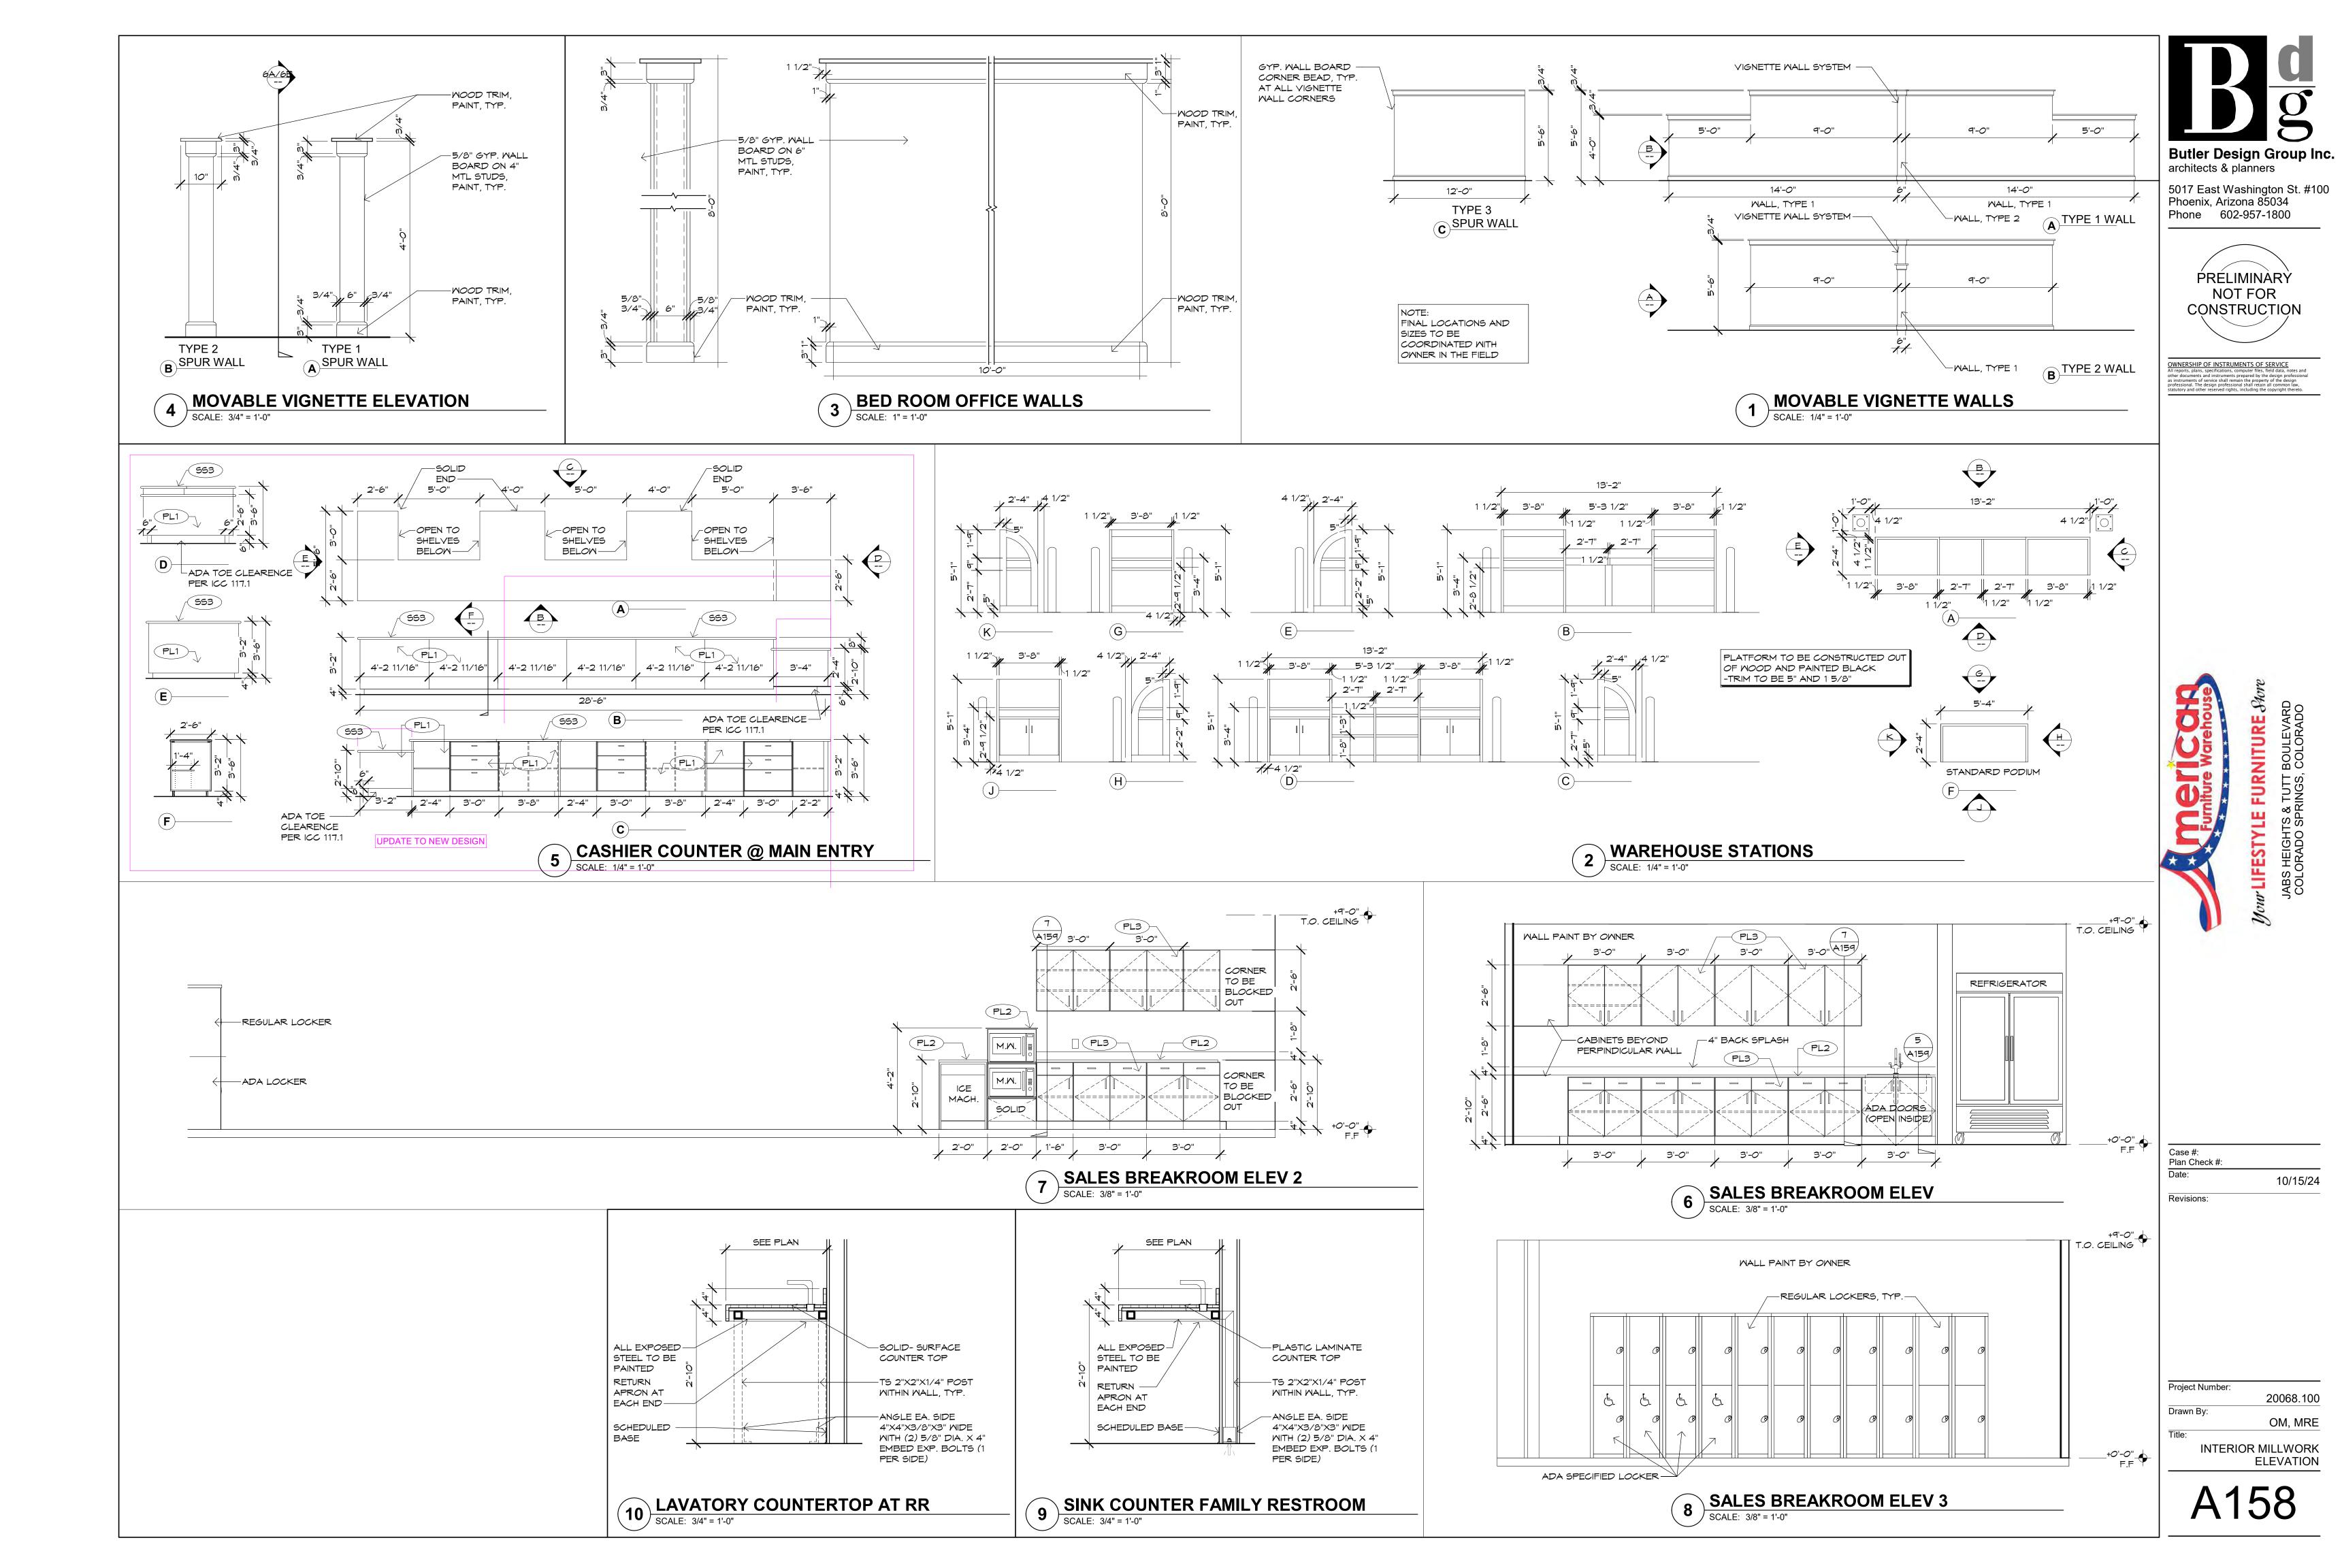

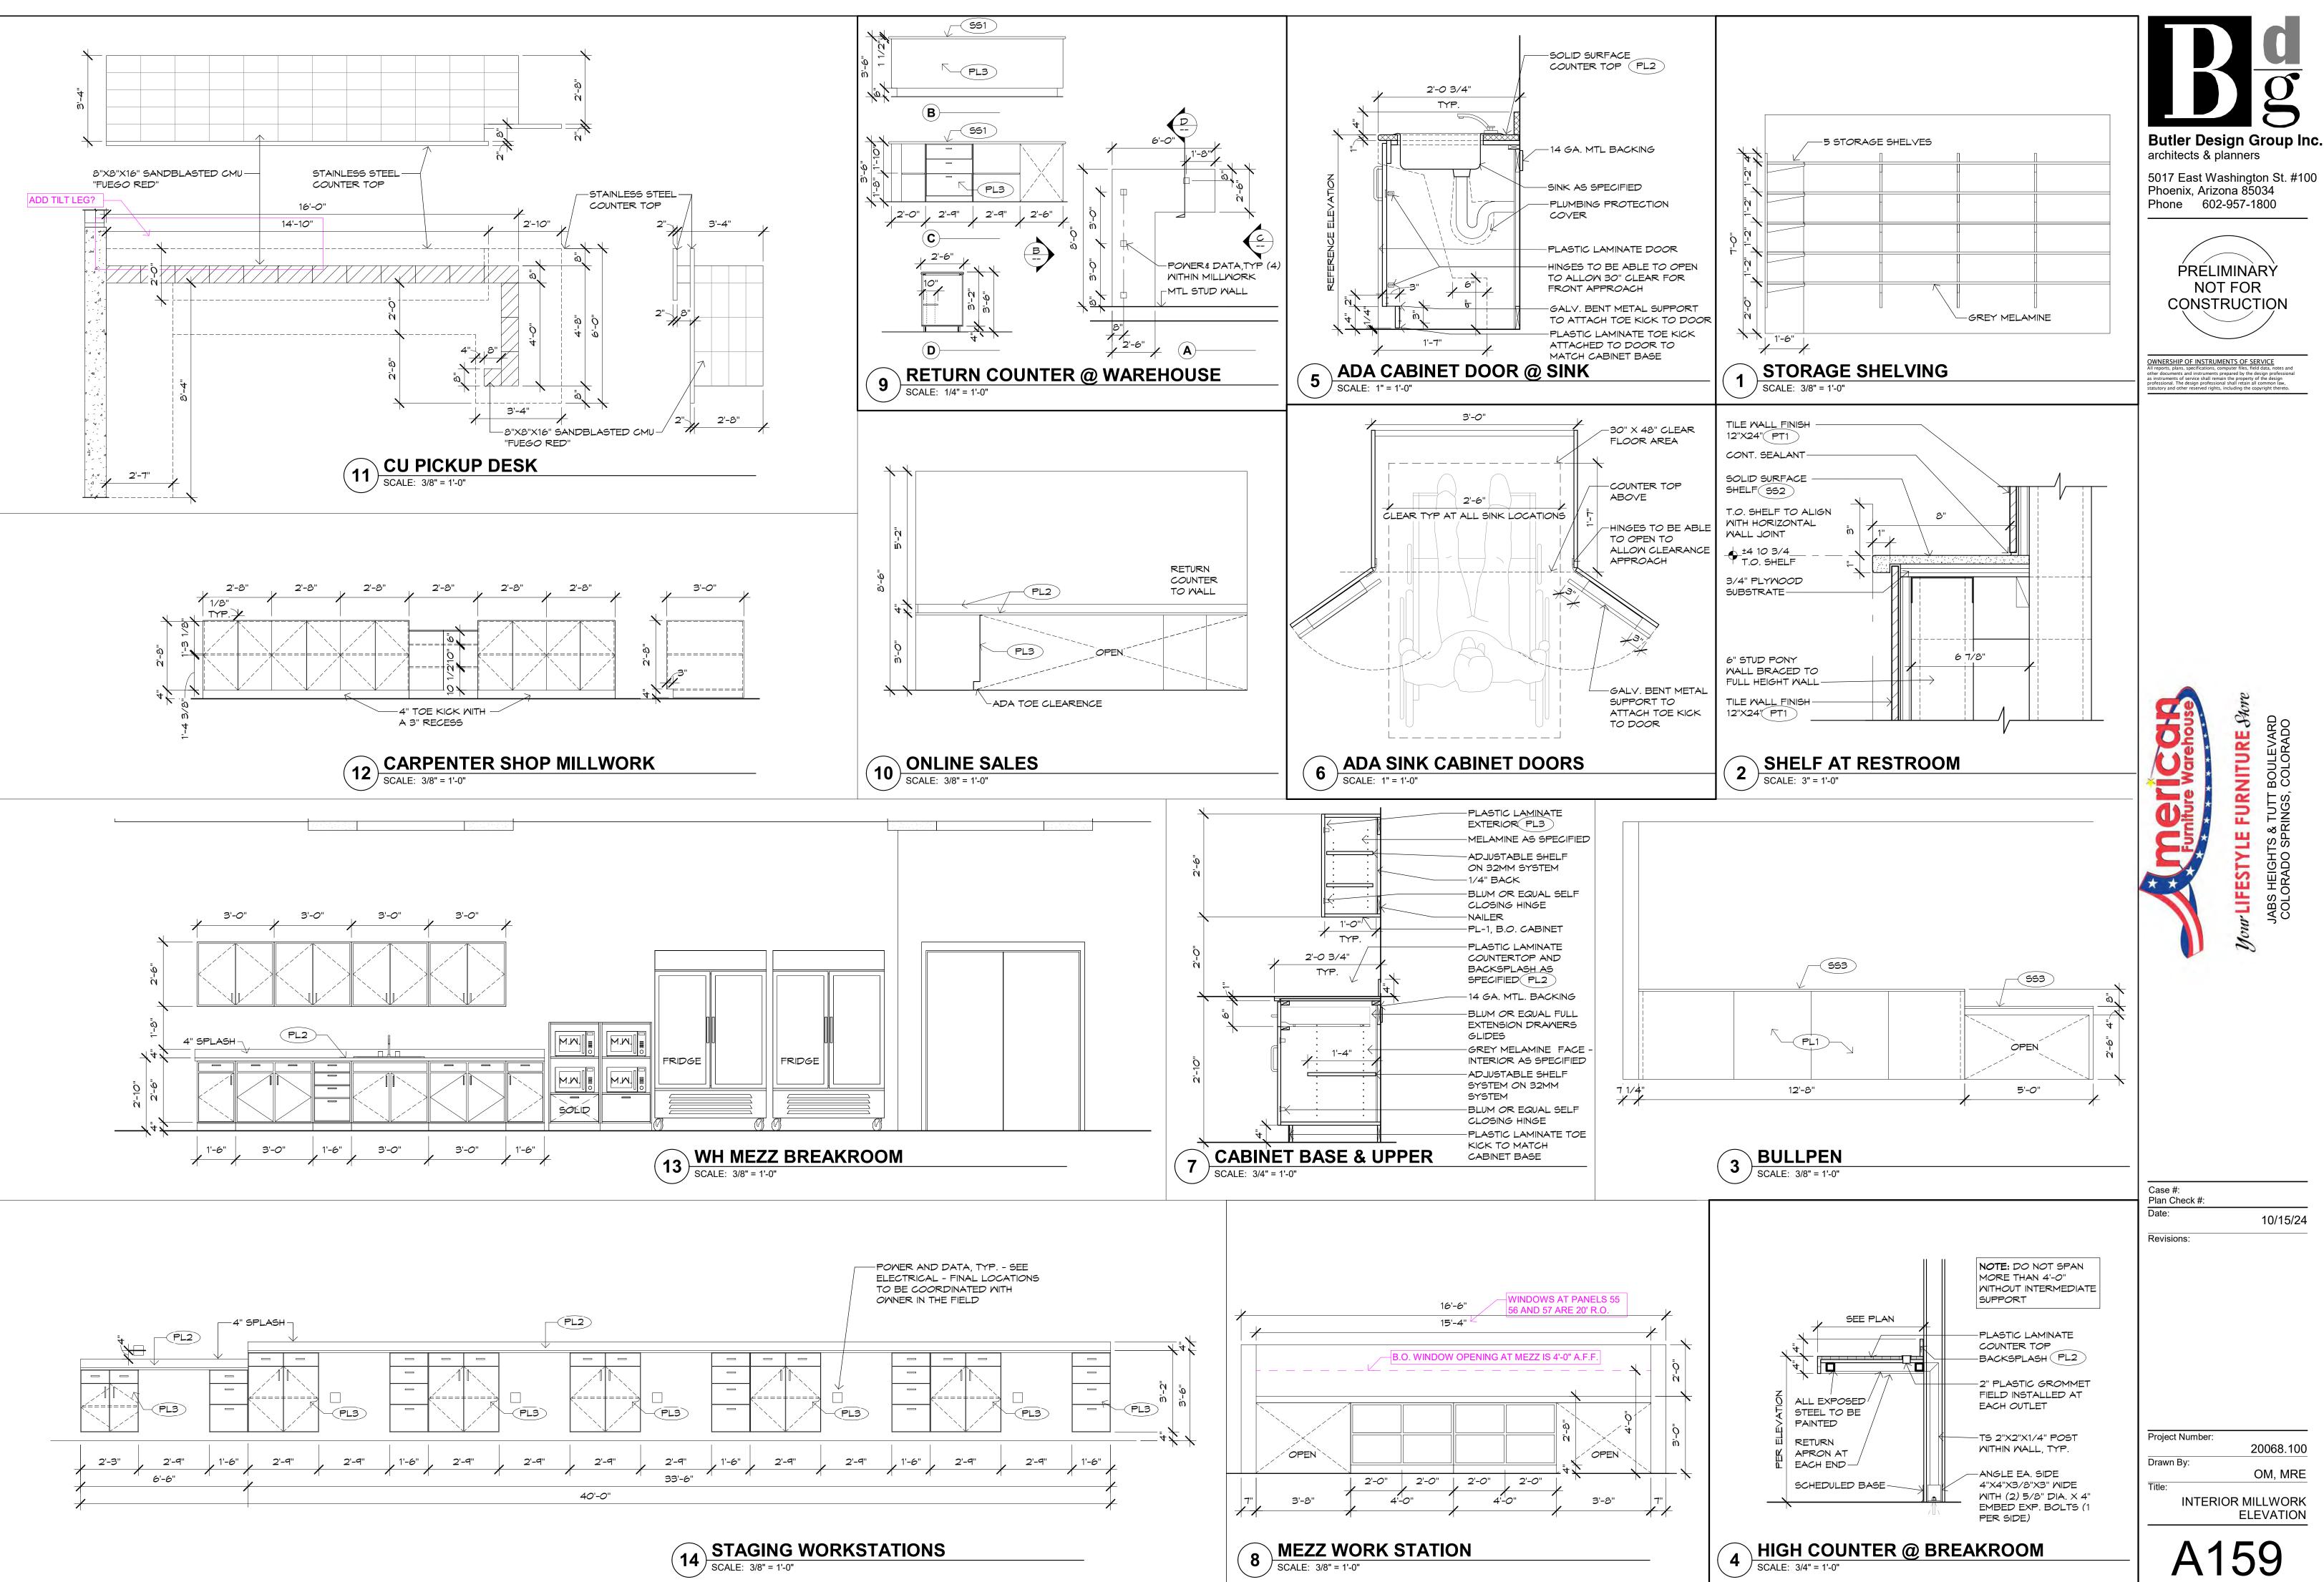


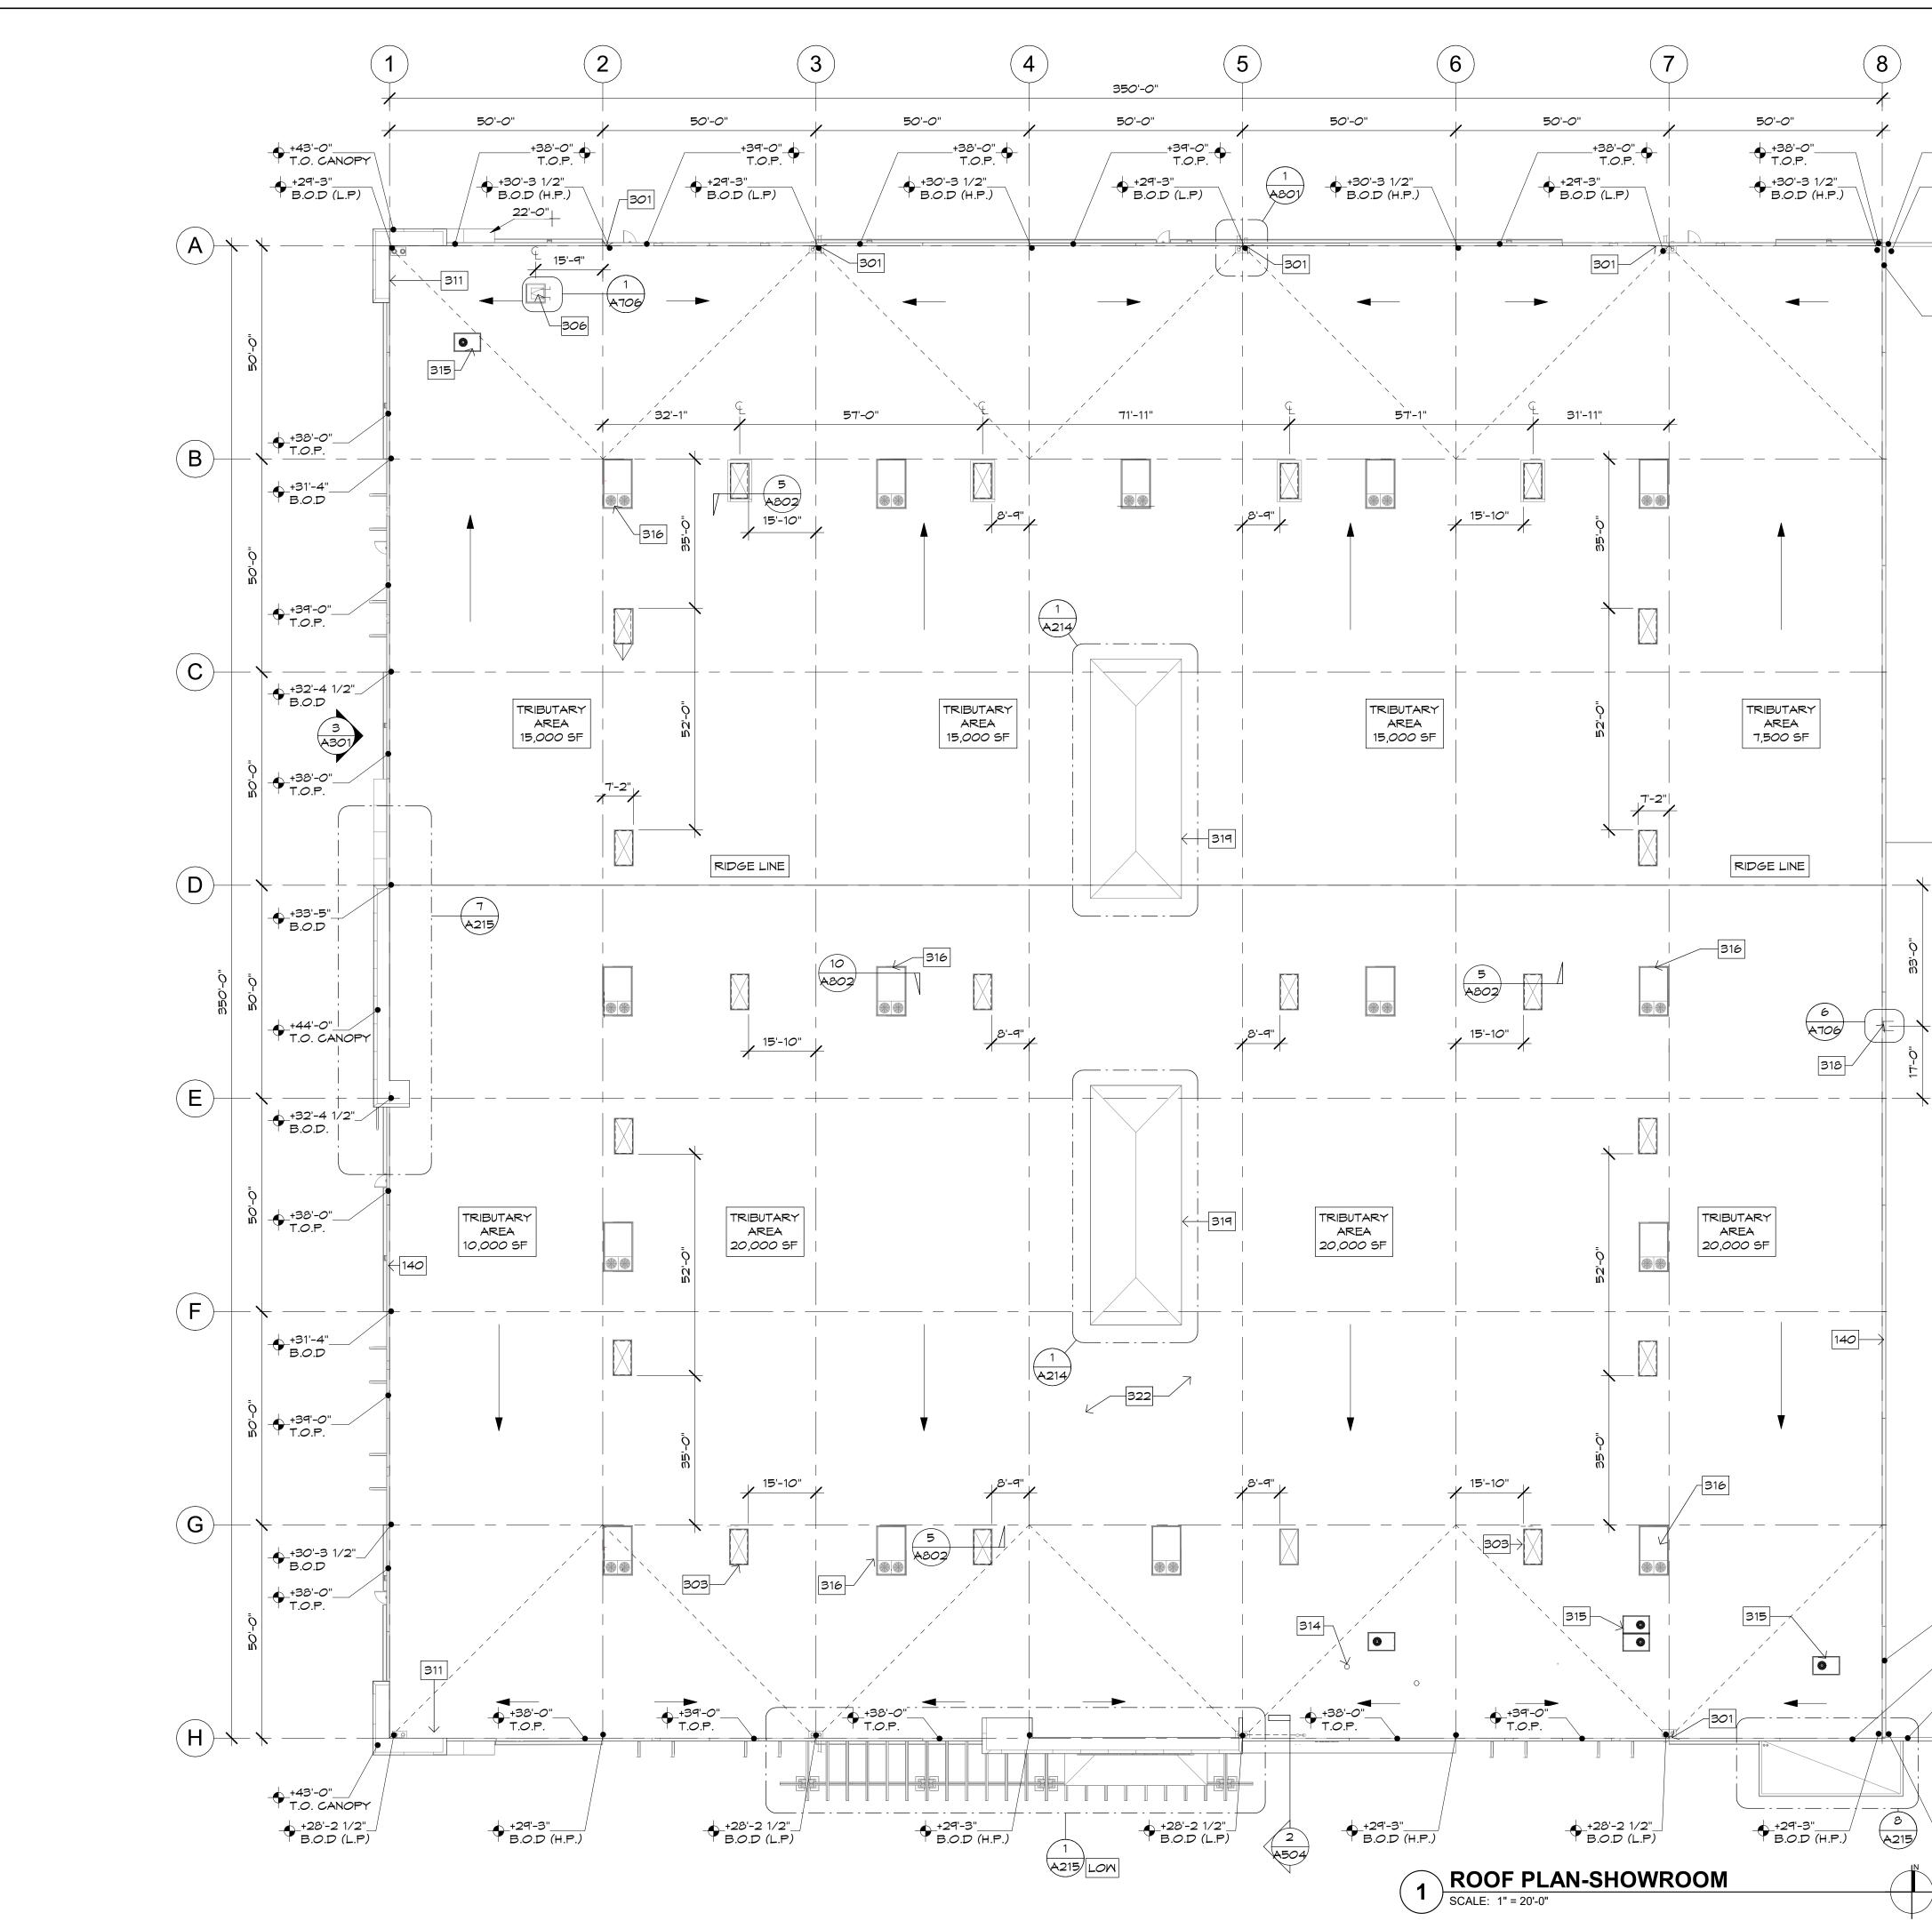


	ROOF PLAN KEYNOTES	
+44'-0" +38'-3 1/2" B.O.D (H.P.) +44'-0" T.O.P. +44'-0"	<ul> <li>301 ROOF DRAIN AND OVERFLOW PLUMBING PLANS FOR ADDITIONAL INFORMATION.</li> <li>303 4X8' SKYLIGHT, SEE DETAILS 5/A802 AND 6/A802.</li> <li>305 EXPANSION MEMBRANE JOINT, SEE STRUCTURAL AND DETAILING FOR CONDITION.</li> <li>306 ROOF ACCESS HATCH SEE FLOOR PLAN FOR CONDITIONS, LOCATION AND STYLE OF ROOF ACCESS.</li> <li>309 CLASS A TPO ROOFING SEE SPECIFICATIONS.</li> <li>311 ACCESS PANEL AT BACK OF ROOF PARAPET.</li> <li>314 EXHAUST FAN - SEE MECHANICAL</li> <li>315 HEAT PUMP - SEE MECHANICAL</li> <li>316 ROOF TOP UNIT - SEE MECHANICAL</li> <li>317 PAINT BOOTH EXHAUST FAN</li> <li>318 PARAPET LADDER</li> <li>319 CLERESTORY ROOF</li> <li>322 SINGLE-PLY ROOF MEMBRANE OVER R-30 INSULATION BOARD MECHANICALLY ATTACHED TO METAL DECKING - SEE ROOF SPEC.</li> </ul>	<image/> <section-header><section-header><text><text><text><text></text></text></text></text></section-header></section-header>
	ROOF CLASSIFICATION	
	1. THE ROOF ASSEMBLY SHALL BE A CLASS 'C' ROOF ASSEMBLY PER	_
	TABLE 1505.1 OF THE IBC.         2. THE ROOFING SUB-CONTRACTOR SHALL PROVIDE A ROOF         CLASSIEICATION LETTER INDICATING THE ULL CLASSIEICATION ASSEMBLY.	
	CLASSIFICATION LETTER INDICATING THE U.L. CLASSIFICATION ASSEMBLY OF THE ROOF SYSTEM OVER NON-COMBUSTIBLE METAL DECK. 3. THE ROOFING CONTRACTOR SHALL PROVIDE MANUFACTURER'S	
-	DETAILS AND SHOP DRAWINGS THAT SHOW COMPLIANCE WITH A CLASS 'C' ROOF SYSTEM.	an an
	ROOF PLAN LEGEND	
	+0'-0" B.O.D. = BOTTOM OF DECK	
	+0'-0" = TOP OF MASONRY	
	+0'-0" = TOP OF PARAPET	
	• 1.O.P. 1	
	= ROOF FLOW	your JA
	ROOF PLAN GENERAL NOTES	_
	A. ALL AREAS OF THE ROOF SURFACE SHALL MAINTAIN A MINIMUM SLOPE OF 1/4" PER FOOT. ADD FOAM CRICKETS AS REQUIRED TO ACHIEVE 1/4" PER FOOT SLOPE.	
	B. ROOFING MEMBRANE SHALL BE PROVIDED AND INSTALLED IN COMPLIANCE WITH THE PROJECT SPECIFICATIONS AND MANUFACTURER DETAILS.	Case #:
	C. SEE PROJECT MANUAL AND MECHANICAL, PLUMBING, AND STRUCTURAL DOCUMENTS FOR COORDINATING ITEMS.	Plan Check #: Date: 10/15/24
	D. NO PENETRATIONS OR EQUIPMENT SHALL BE INSTALLED WITHIN 24 INCHES OF THE BUILDING PARAPET U.N.O.	Revisions:
	E. LOCATIONS INDICATED FOR THE ROOF DRAINS SHALL BE COORDINATED WITH THE ARCHITECTURAL FLOOR PLAN AND THE STRUCTURAL AND	
+44'-0"- T.O.P. +38'-0"_ T.O.P.	PLUMBING PLANS FOR PROPER PLACEMENT. F. ELEVATIONS SHOWN ON THE ROOF PLAN ARE TO BOTTOM OF DECK (B.O.D.) UNLESS NOTED OTHERWISE. SEE STRUCTURAL DOCUMENTS FOR THE SPECIFIED DECKING MATERIALS. HEIGHTS ARE RELEVANT TO FIRST FINISH FLOOR NOTED AS +0'-0".	
+44'-0" T.O.P.	G. LOCATION OF FLASHING AND COUNTER FLASHING, ABOVE ROOF SURFACE, IS TO BE INSTALLED IN COMPLIANCE WITH THE ROOFING MANUFACTURER'S	
-	REQUIREMENTS. H. THE DASHED LINE ON THE ROOF DESIGNATES EXTENT OF ROOF WARPING, NOT CRICKET BUILD OUTS.	Project Number:
	I. MECHANICAL UNITS SHALL BE PLACED IN AN ORDERLY FASHION FOR EASE OF MAINTENANCE AND COMPATIBILITY WITH ROOF DRAINAGE BEST	Project Number: 20068.100 Drawn By:
,+37'-3"∳ B.O.D (H.P.) ♥	PRACTICES. J. GENERAL CONTRACTOR IS RESPONSIBLE FOR COORDINATING EXACT LOCATION OF ROOF ACCESS AND MECHANICAL UNIT WALK PADS WITH SUPPLIERS. WALK PADS SHOULD EXTEND FROM ROOF ACCESS TO AND AROUND ALL UNITS, AND TO ANY ADDITIONAL MAINTENANCE POINTS FOR	OM, MRE Title: ROOF PLAN-SHOWROOM
	ROOFTOP EQUIPMENT. K. ALL ROOF MOUNTED EQUIPMENT TO BE ON MECHANICAL CURBS AND	A211
	RAISED FROM ROOFING SURFACE.	

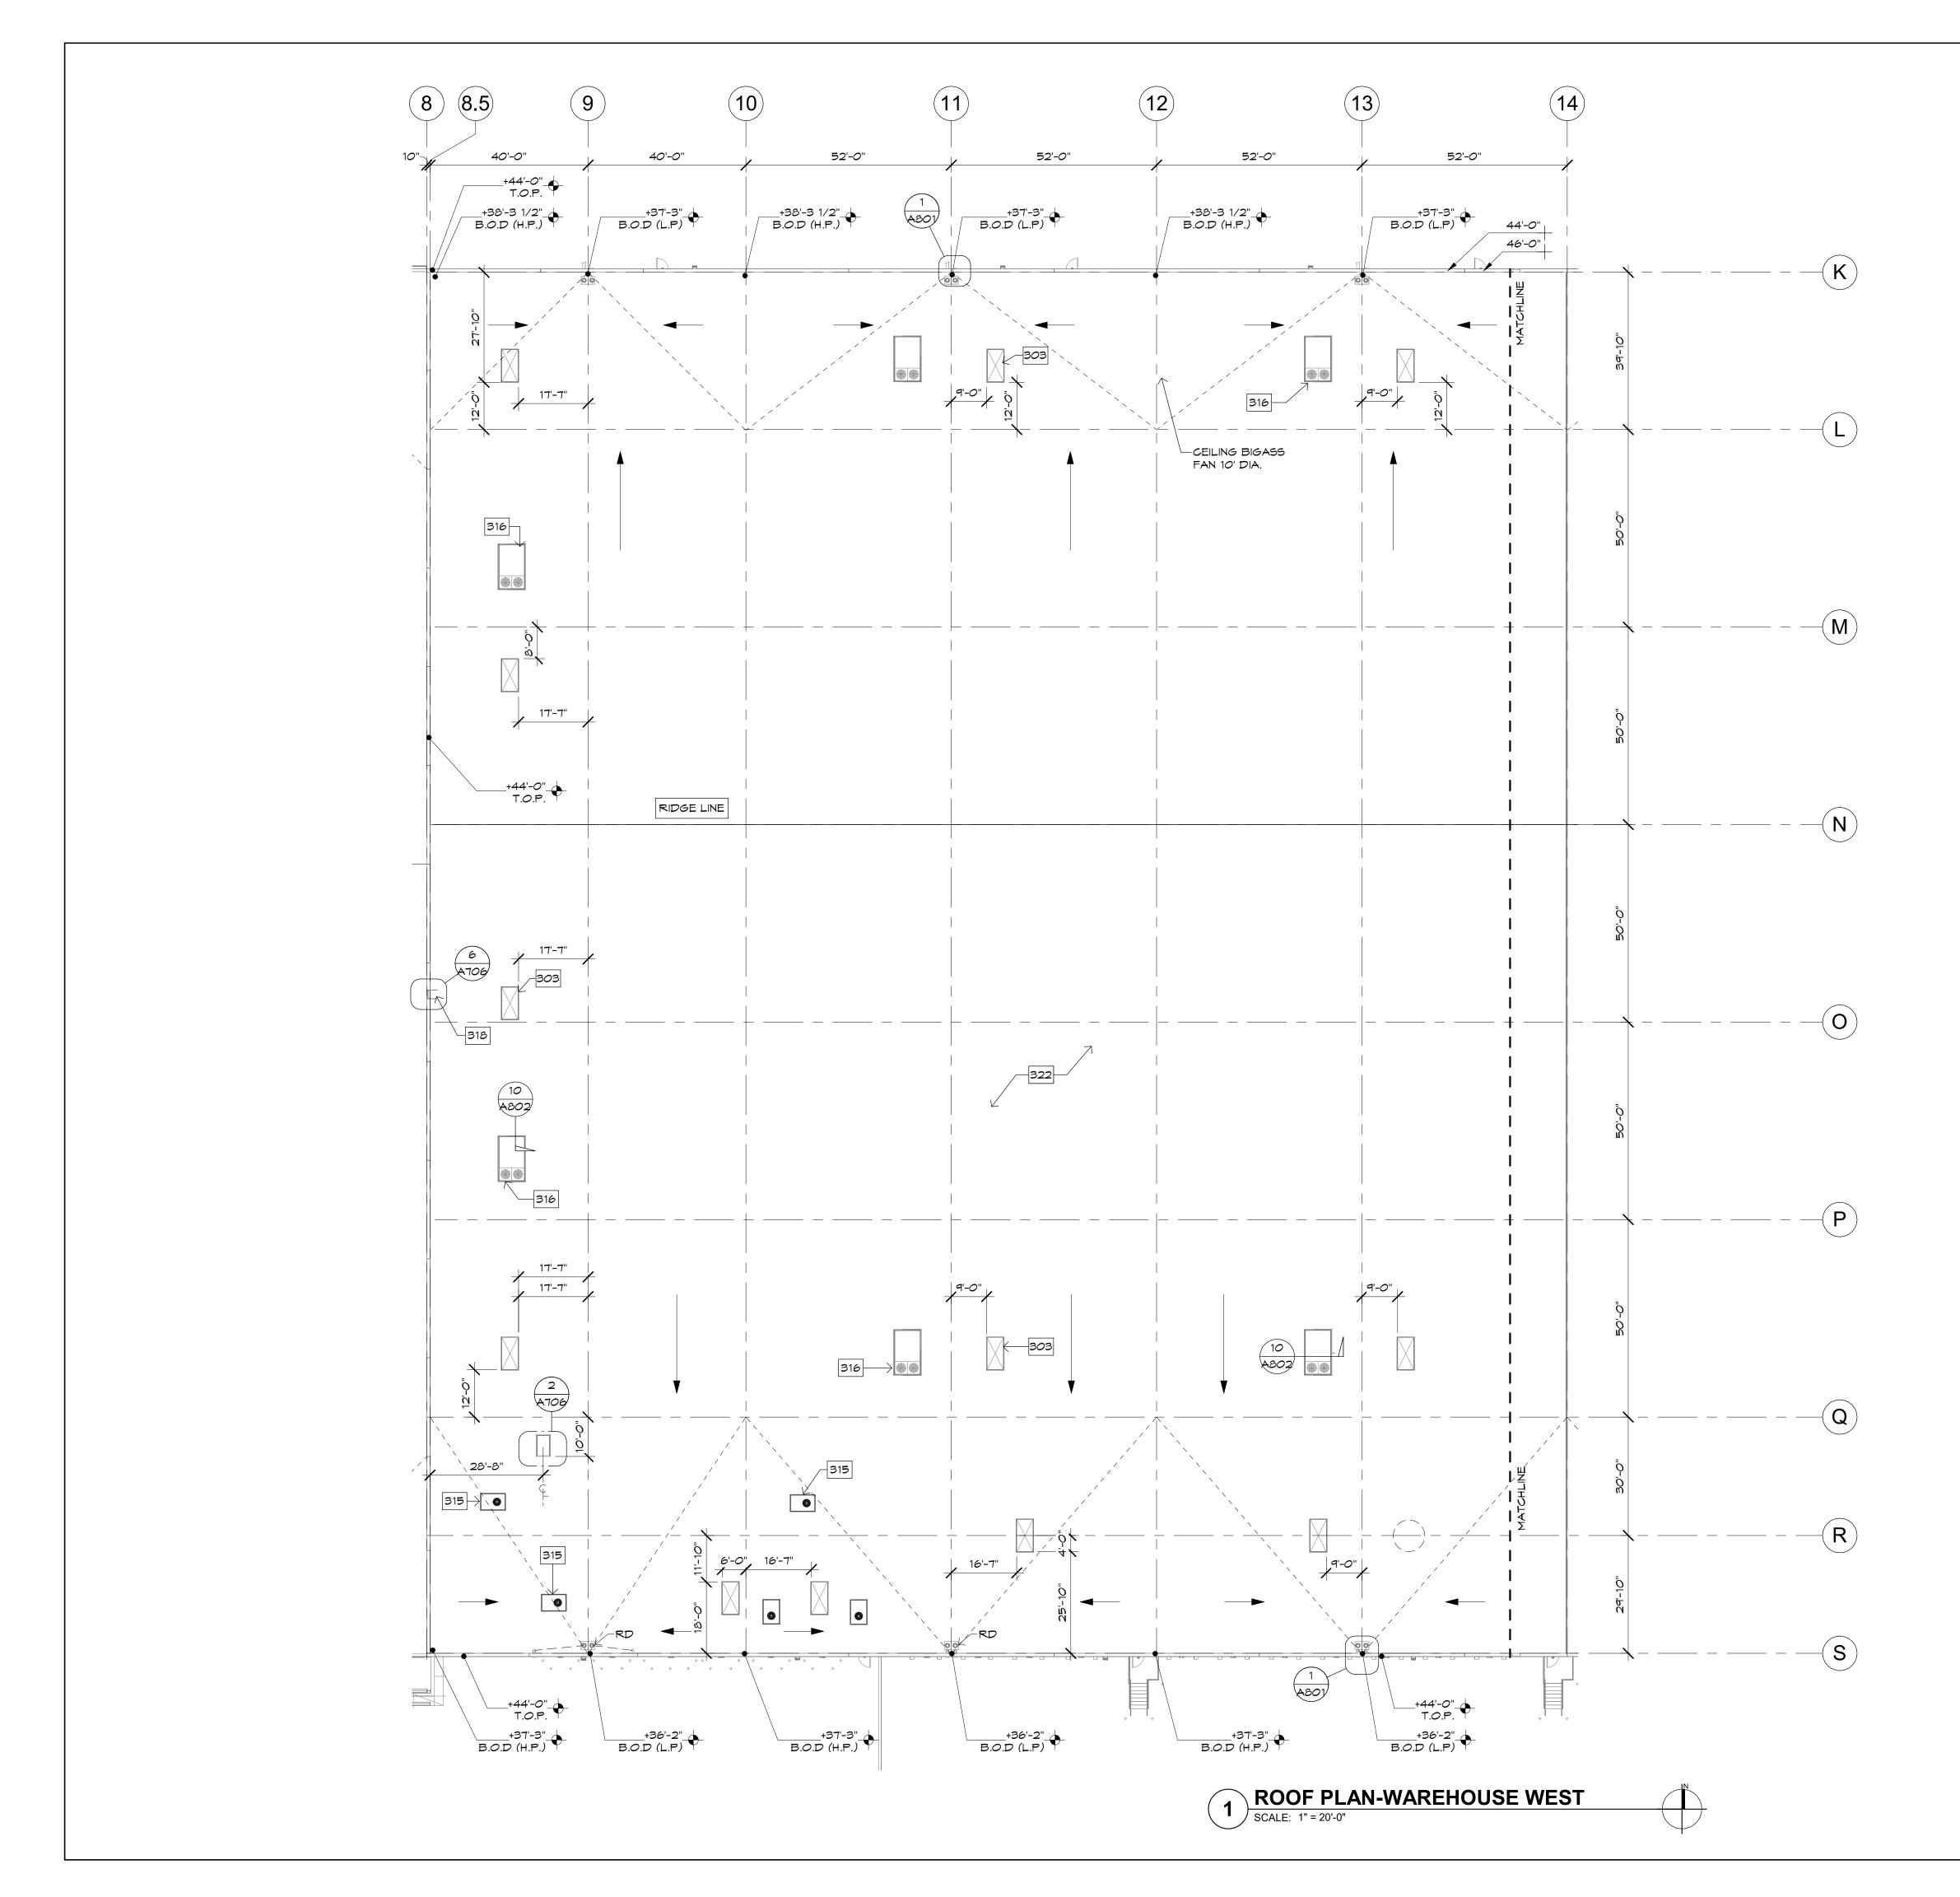



	RUU	F PLAN KEYN	IOTES	#	
301		OTE MAY APPLY OR BE REFERENC OVERFLOW PLUMBING PLANS F			
303		E DETAILS 5/A802 AND 6/A80			)g
306	CONDITION. ROOF ACCESS HAT	CH SEE FLOOR PLAN FOR CO		- 1	sign Group I
309		CCESS. FING SEE SPECIFICATIONS. BACK OF ROOF PARAPET.		architects & 5017 East V	planners Vashington St. # <sup>^</sup>
314 315	EXHAUST FAN - SEE HEAT PUMP - SEE M	E MECHANICAL 1ECHANICAL		Phoenix, Ari Phone 60	zona 85034 )2-957-1800
317	ROOF TOP UNIT - S PAINT BOOTH EXHA PARAPET LADDER				
319 322	CLERESTORY ROO SINGLE-PLY ROOF	MEMBRANE OVER R-30 INSULA			
		TACHED TO METAL DECKING -	SEE ROOF SPEC.		DT FOR TRUCTION
	A211	A212	A213	other documents and instrume as instruments of service shall	s, computer files, field data, notes and nts prepared by the design professional remain the property of the design
				statutory and other reserved rig	ssional shall retain all common faw, ghts, including the copyright thereto.
	ROC	OF CLASSIFIC	ATION		
	HE ROOF ASSEMBL ABLE 1505.1 OF TH	LY SHALL BE A CLASS 'C' R <i>OO</i> E IBC.	F ASSEMBLY PER		
C	LASSIFICATION LET	CONTRACTOR SHALL PROVIDE TER INDICATING THE U.L. CLAS EM OVER NON-COMBUSTIBLE N	SIFICATION ASSEMBLY		
D		RACTOR SHALL PROVIDE MAN DRAWINGS THAT SHOW COMPI			24
	RO	OF PLAN LEG	SEND		LE Ston
	+0'-0" B.O.D.	= BOTTOM OF DECK			AITURE & BOULEVARE COLORADO
	+0'-0" T.O.M.	= TOP OF MASONRY			FURN TUTT I
	+0'-0" T.O.P.	= TOP OF PARAPET		E	
	►	= 1/4" : 1'-0" MIN. SLOPE		* *	<b><i>w</i>LIFESTY</b> JABS HEIGH COLORADO
		= ROOF FLOW			Now JA
	ROOF F	PLAN GENERA	AL NOTES		
	ALL AREAS OF THE	PLAN GENERA E ROOF SURFACE SHALL MAINT DD FOAM CRICKETS AS REQUI	TAIN A MINIMUM SLOPE C		
B.	ALL AREAS OF THE 1/4" PER FOOT. AI FOOT SLOPE. ROOFING MEMBRA	E ROOF SURFACE SHALL MAIN	TAIN A MINIMUM SLOPE C RED TO ACHIEVE 1/4" PI INSTALLED IN	ER Case #:	
В.	ALL AREAS OF THE 1/4" PER FOOT. AI FOOT SLOPE. ROOFING MEMBRA COMPLIANCE WITH DETAILS. SEE PROJECT MAN	E ROOF SURFACE SHALL MAIN DD FOAM CRICKETS AS REQUI	TAIN A MINIMUM SLOPE C RED TO ACHIEVE 1/4" PI INSTALLED IN 5 AND MANUFACTURER	ER Case #: Plan Check #: Date:	10/15/2
В. С. D.	ALL AREAS OF THE 1/4" PER FOOT. AI FOOT SLOPE. ROOFING MEMBRA COMPLIANCE WITH DETAILS. SEE PROJECT MAN DOCUMENTS FOR C	E ROOF SURFACE SHALL MAIN DD FOAM CRICKETS AS REQUI ANE SHALL BE PROVIDED AND THE PROJECT SPECIFICATIONS IVAL AND MECHANICAL, PLUMB COORDINATING ITEMS. OR EQUIPMENT SHALL BE INST	TAIN A MINIMUM SLOPE C RED TO ACHIEVE 1/4" PI INSTALLED IN 5 AND MANUFACTURER SING, AND STRUCTURAL	ER Case #: Plan Check #: Date: Revisions:	10/15/2
В. С. D. E.	ALL AREAS OF THE 1/4" PER FOOT. AI FOOT SLOPE. ROOFING MEMBRA COMPLIANCE WITH DETAILS. SEE PROJECT MAN DOCUMENTS FOR C NO PENETRATIONS OF THE BUILDING F LOCATIONS INDICA WITH THE ARCHITEC	E ROOF SURFACE SHALL MAIN DD FOAM CRICKETS AS REQUI ANE SHALL BE PROVIDED AND THE PROJECT SPECIFICATIONS IVAL AND MECHANICAL, PLUMB COORDINATING ITEMS. OR EQUIPMENT SHALL BE INST	TAIN A MINIMUM SLOPE C RED TO ACHIEVE 1/4" PI INSTALLED IN 5 AND MANUFACTURER 5ING, AND STRUCTURAL TALLED WITHIN 24 INCHE 5HALL BE COORDINATED	ER Case #: Plan Check #: Date: Revisions:	10/15/2
В. С. D. E. F.	ALL AREAS OF THE 1/4" PER FOOT. AL FOOT SLOPE. ROOFING MEMBRA COMPLIANCE WITH DETAILS. SEE PROJECT MAN DOCUMENTS FOR C NO PENETRATIONS OF THE BUILDING F LOCATIONS INDICA WITH THE ARCHITEC PLUMBING PLANS F ELEVATIONS SHOW (B.O.D.) UNLESS NO	E ROOF SURFACE SHALL MAIN DD FOAM CRICKETS AS REQUINANE SHALL BE PROVIDED AND THE PROJECT SPECIFICATIONS NUAL AND MECHANICAL, PLUMB COORDINATING ITEMS. OR EQUIPMENT SHALL BE INST PARAPET U.N.O. TED FOR THE ROOF DRAINS S CTURAL FLOOR PLAN AND THE FOR PROPER PLACEMENT.	TAIN A MINIMUM SLOPE C RED TO ACHIEVE 1/4" PI INSTALLED IN 5 AND MANUFACTURER SING, AND STRUCTURAL TALLED WITHIN 24 INCHE SHALL BE COORDINATED STRUCTURAL AND D BOTTOM OF DECK URAL DOCUMENTS FOR	Case #: Plan Check #: Date: Revisions:	10/15/2
В. С. D. E. F.	ALL AREAS OF THE 1/4" PER FOOT. AL FOOT SLOPE. ROOFING MEMBRA COMPLIANCE WITH DETAILS. SEE PROJECT MAN DOCUMENTS FOR C NO PENETRATIONS OF THE BUILDING F LOCATIONS INDICA WITH THE ARCHITEC PLUMBING PLANS F ELEVATIONS SHOW (B.O.D.) UNLESS NOT THE SPECIFIED DEC FINISH FLOOR NOT LOCATION OF FLAS	E ROOF SURFACE SHALL MAIN DD FOAM CRICKETS AS REQUINANE SHALL BE PROVIDED AND THE PROJECT SPECIFICATIONS NUAL AND MECHANICAL, PLUMB COORDINATING ITEMS. OR EQUIPMENT SHALL BE INST PARAPET U.N.O. TED FOR THE ROOF DRAINS S CTURAL FLOOR PLAN AND THE FOR PROPER PLACEMENT.	TAIN A MINIMUM SLOPE C RED TO ACHIEVE 1/4" PI INSTALLED IN 5 AND MANUFACTURER 5 AND MANUFACTURER 5 AND STRUCTURAL TALLED WITHIN 24 INCHE 5 HALL BE COORDINATED 5 STRUCTURAL AND 0 BOTTOM OF DECK URAL DOCUMENTS FOR RE RELEVANT TO FIRST 5, ABOVE ROOF SURFAC	Case #: Plan Check #: Date: Revisions:	10/15/2
В. С. Е.	ALL AREAS OF THE 1/4" PER FOOT. AL FOOT SLOPE. ROOFING MEMBRA COMPLIANCE WITH DETAILS. SEE PROJECT MAN DOCUMENTS FOR C NO PENETRATIONS OF THE BUILDING F LOCATIONS INDICA WITH THE ARCHITEC PLUMBING PLANS F ELEVATIONS SHOW (B.O.D.) UNLESS NO THE SPECIFIED DEC FINISH FLOOR NOT LOCATION OF FLAS IS TO BE INSTALLED REQUIREMENTS. THE DASHED LINE C NOT CRICKET BUILD	E ROOF SURFACE SHALL MAIN DD FOAM CRICKETS AS REQUINANE SHALL BE PROVIDED AND THE PROJECT SPECIFICATIONS NUAL AND MECHANICAL, PLUMB COORDINATING ITEMS. OR EQUIPMENT SHALL BE INST PARAPET U.N.O. TED FOR THE ROOF DRAINS SE CTURAL FLOOR PLAN AND THE FOR PROPER PLACEMENT. IN ON THE ROOF PLAN ARE TO DIED OTHERWISE. SEE STRUCTI CKING MATERIALS. HEIGHTS AR ED AS +0'-0". SHING AND COUNTER FLASHING D IN COMPLIANCE WITH THE RO ON THE ROOF DESIGNATES EX D OUTS.	TAIN A MINIMUM SLOPE C RED TO ACHIEVE 1/4" PI INSTALLED IN 5 AND MANUFACTURER 5 AND MANUFACTURER 5 AND STRUCTURAL TALLED WITHIN 24 INCHE 5 HALL BE COORDINATED 5 HALL BE COORDINATED 5 BOTTOM OF DECK URAL DOCUMENTS FOR RE RELEVANT TO FIRST 5, ABOVE ROOF SURFAC DOFING MANUFACTURER TENT OF ROOF WARPING	Case #: Plan Check #: Date: Revisions: CE, CE, CS, CE, Project Number	
В. С. Д. Е. F. G. H.	ALL AREAS OF THE 1/4" PER FOOT. AL FOOT SLOPE. ROOFING MEMBRA COMPLIANCE WITH DETAILS. SEE PROJECT MAN DOCUMENTS FOR C NO PENETRATIONS OF THE BUILDING F LOCATIONS INDICA WITH THE ARCHITEC PLUMBING PLANS F ELEVATIONS SHOW (B.O.D.) UNLESS NO THE SPECIFIED DEC FINISH FLOOR NOT LOCATION OF FLAS IS TO BE INSTALLED REQUIREMENTS. THE DASHED LINE C NOT CRICKET BUILD	E ROOF SURFACE SHALL MAIN DD FOAM CRICKETS AS REQUINANE SHALL BE PROVIDED AND THE PROJECT SPECIFICATIONS WAL AND MECHANICAL, PLUMB COORDINATING ITEMS. OR EQUIPMENT SHALL BE INST PARAPET U.N.O. ITED FOR THE ROOF DRAINS SE CTURAL FLOOR PLAN AND THE FOR PROPER PLACEMENT. IN ON THE ROOF PLAN ARE TO DTED OTHERWISE. SEE STRUCT CKING MATERIALS. HEIGHTS AR ED AS +0'-0". SHING AND COUNTER FLASHING D IN COMPLIANCE WITH THE RO	TAIN A MINIMUM SLOPE C RED TO ACHIEVE 1/4" PI INSTALLED IN 5 AND MANUFACTURER 5 AND MANUFACTURER 5 AND STRUCTURAL TALLED WITHIN 24 INCHE 5 HALL BE COORDINATED 5 HALL BE COORDINATED 5 BOTTOM OF DECK URAL DOCUMENTS FOR RE RELEVANT TO FIRST 5, ABOVE ROOF SURFAC DOFING MANUFACTURER TENT OF ROOF WARPING DERLY FASHION FOR EAS	Case #: Plan Check #: Date: Revisions: CE, CE, CS, CE, Project Number	: 20068.10
В. С. Р. Е. F. G. H. I.	ALL AREAS OF THE 1/4" PER FOOT. AI FOOT SLOPE. ROOFING MEMBRA COMPLIANCE WITH DETAILS. SEE PROJECT MAN DOCUMENTS FOR C NO PENETRATIONS OF THE BUILDING F LOCATIONS INDICA WITH THE ARCHITEC PLUMBING PLANS F ELEVATIONS SHOW (B.O.D.) UNLESS NO THE SPECIFIED DEC FINISH FLOOR NOT LOCATION OF FLAS IS TO BE INSTALLED REQUIREMENTS. THE DASHED LINE C NOT CRICKET BUILD MECHANICAL UNITS OF MAINTENANCE A PRACTICES. GENERAL CONTRAC	E ROOF SURFACE SHALL MAIN DD FOAM CRICKETS AS REQUINANE SHALL BE PROVIDED AND THE PROJECT SPECIFICATIONS WAL AND MECHANICAL, PLUMB COORDINATING ITEMS. OR EQUIPMENT SHALL BE INST PARAPET U.N.O. ITED FOR THE ROOF DRAINS S CTURAL FLOOR PLAN AND THE FOR PROPER PLACEMENT. IN ON THE ROOF PLAN ARE TO DTED OTHERWISE. SEE STRUCTION CKING MATERIALS. HEIGHTS AR ED AS +0'-0". SHING AND COUNTER FLASHING D IN COMPLIANCE WITH THE RO ON THE ROOF DESIGNATES EX D OUTS. SHALL BE PLACED IN AN ORD AND COMPATIBILITY WITH ROO CTOR IS RESPONSIBLE FOR C DF ACCESS AND MECHANICAL IN PADS SHOULD EXTEND FROM IN AND TO ANY ADDITIONAL MA	TAIN A MINIMUM SLOPE C RED TO ACHIEVE 1/4" PI INSTALLED IN 5 AND MANUFACTURER 5 AND MANUFACTURER 5 AND STRUCTURAL TALLED WITHIN 24 INCHE 5 HALL BE COORDINATED 5 HALL BE COORDINATED 5 STRUCTURAL AND 0 BOTTOM OF DECK URAL DOCUMENTS FOR RE RELEVANT TO FIRST 5, ABOVE ROOF SURFAC DOFING MANUFACTURER TENT OF ROOF WARPING DERLY FASHION FOR EAS 0 F DRAINAGE BEST 0 ORDINATING EXACT UNIT WALK PADS WITH ROOF ACCESS TO AND	Case #: Plan Check #: Date: Date: Revisions: CE, CE, SE Drawn By: Title: ROOF PLA	

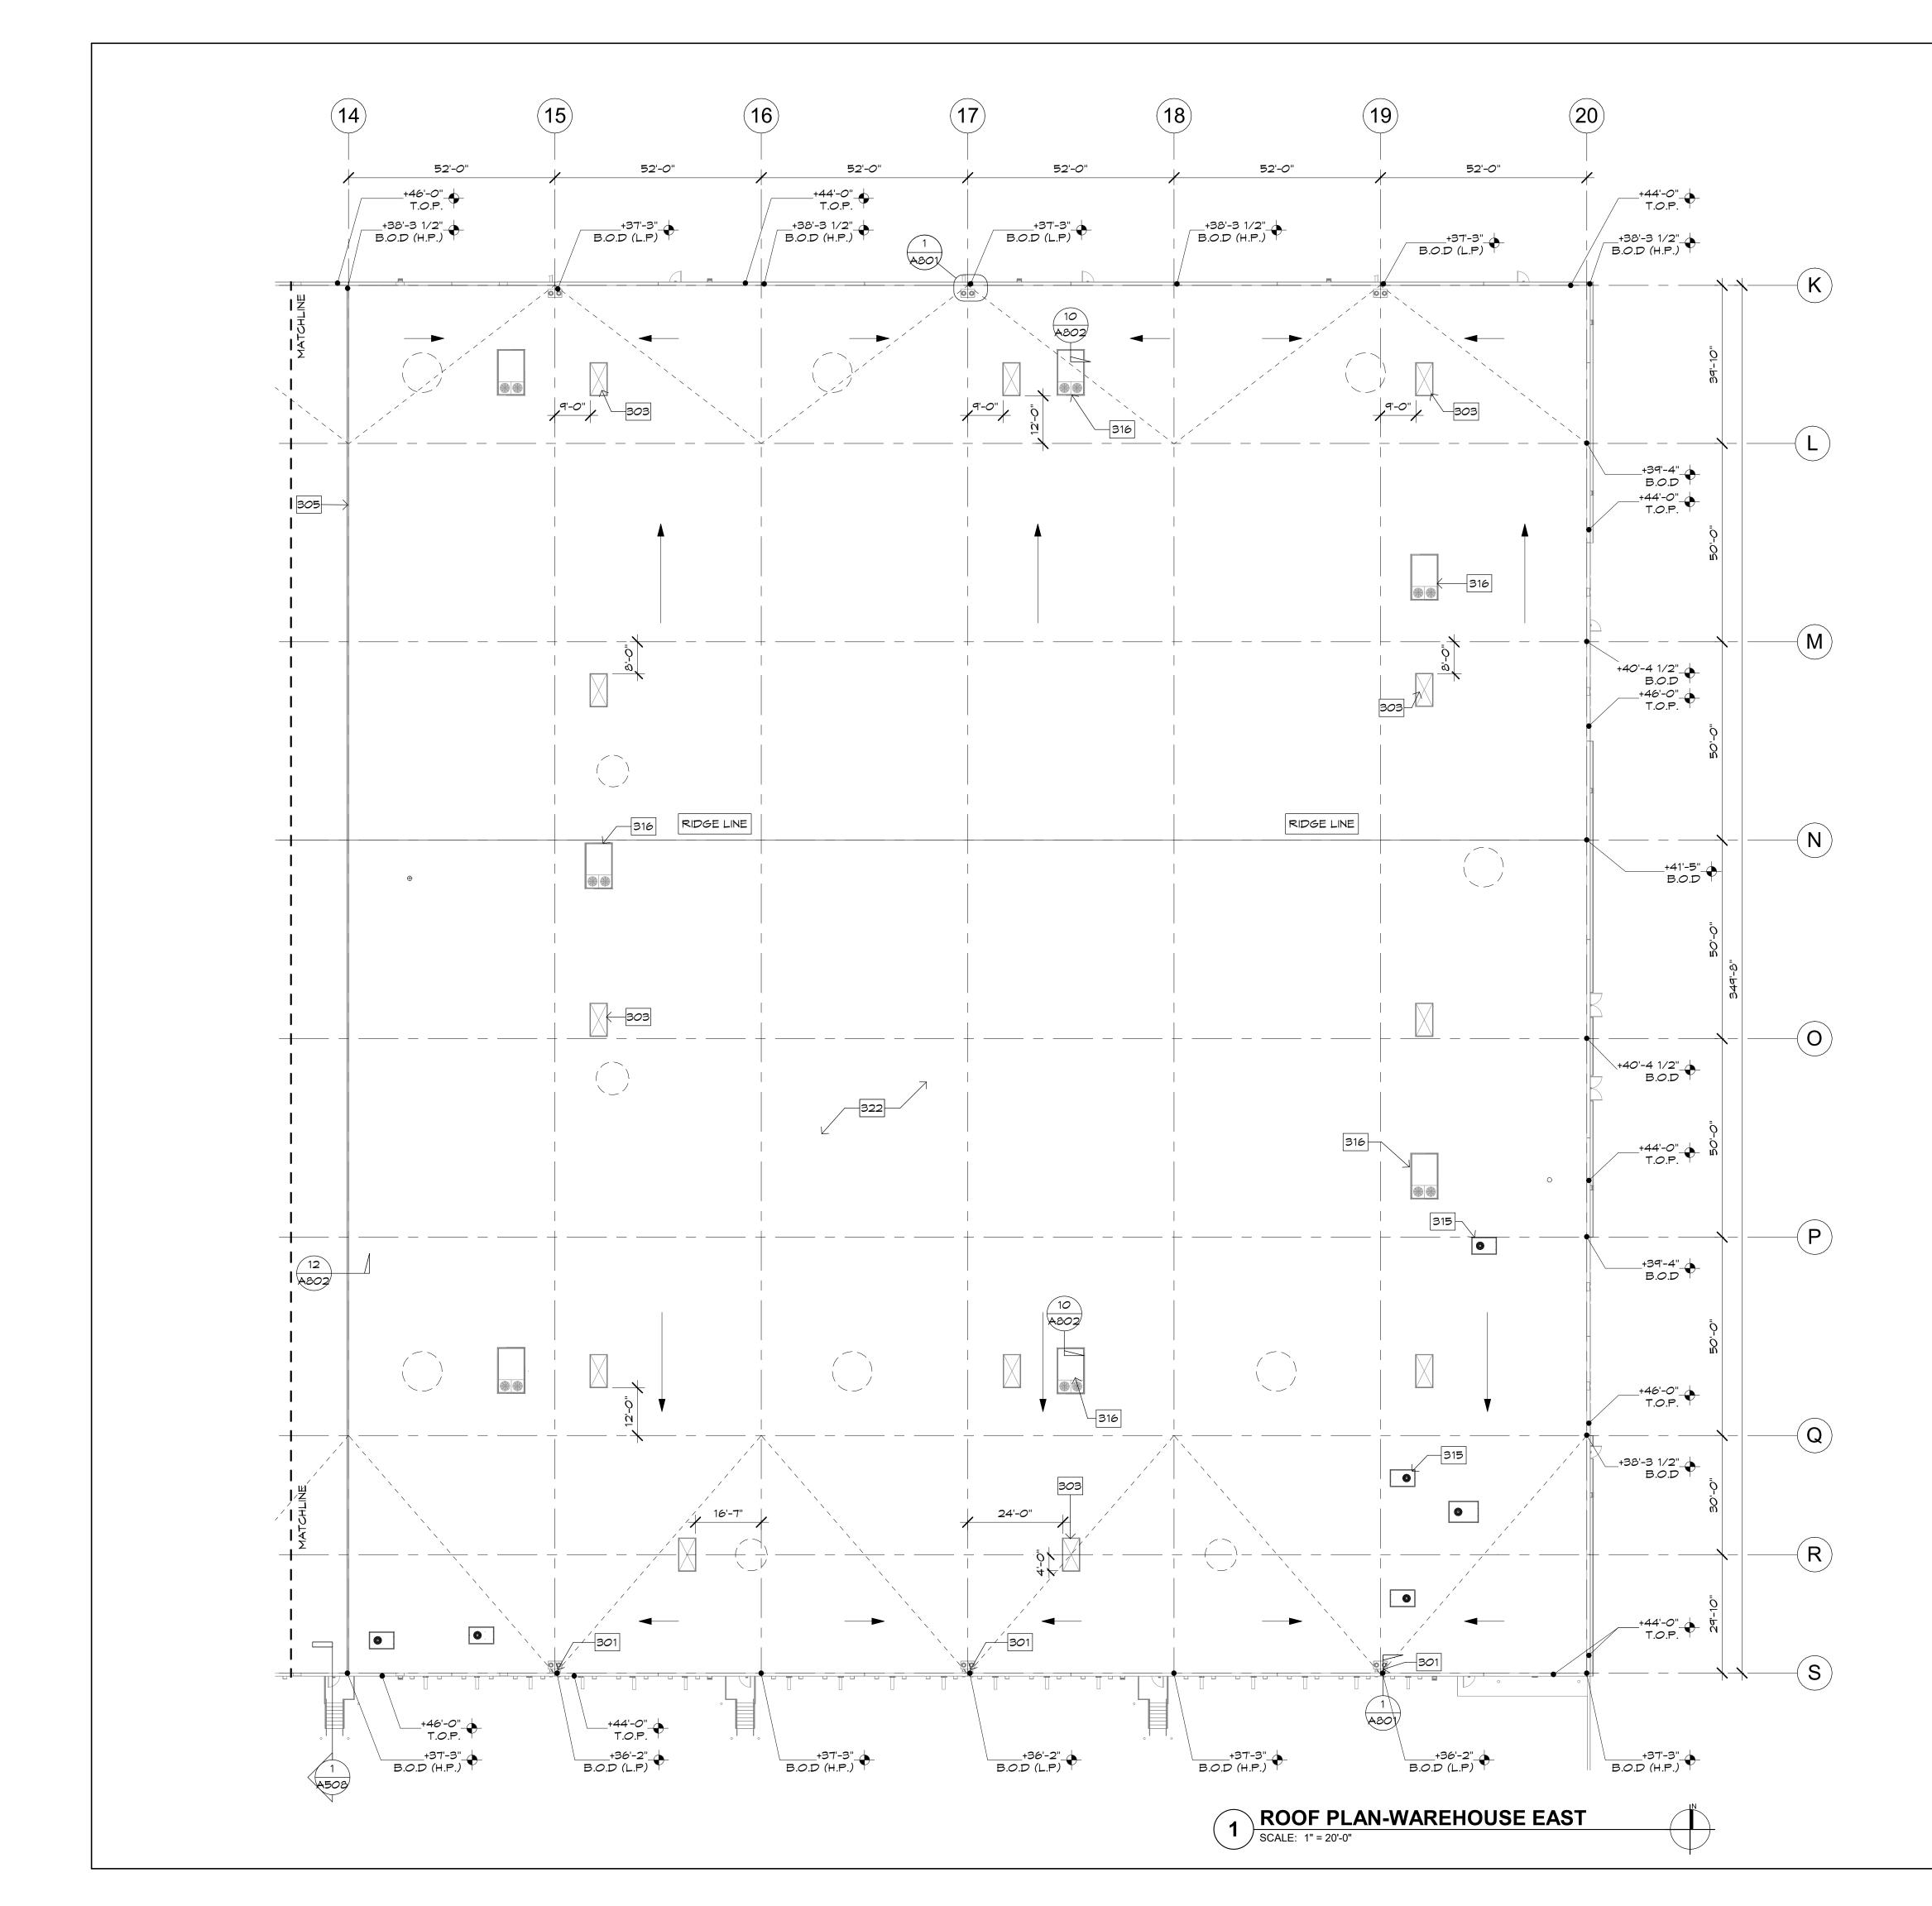


			EYNOTES			
301 RC INF 303 4'X 305 EXF 305 RC 306 RC 5T 309 CL 309 CL	DOF DRAIN AND C FORMATION. (8' SKYLIGHT, SEE PANSION MEMBR, DNDITION. DOF ACCESS HATC YLE OF ROOF AC ASS A TPO ROOF ASS A TPO ROOF	DVERFLOW PLUMBING E DETAILS 5/A802 AN ANE JOINT, SEE STRU CH SEE FLOOR PLAN CCESS. FING SEE SPECIFICAT BACK OF ROOF PAR	ICTURAL AND DETAILIN I FOR CONDITIONS, LC IONS.	NAL NG FOR DCATION AND	Butler Des architects & p 5017 East Wa Phoenix, Arizo	lanners Ishington St. #
<ul> <li>315 HE,</li> <li>316 RC</li> <li>317 PA</li> <li>318 PA</li> <li>319 CLI</li> <li>322 SIN</li> </ul>		ECHANICAL EE MECHANICAL UST FAN = MEMBRANE OVER R-	-30 INSULATION BOARI ECKING - SEE ROOF St	D	Phone 602 PRELI	MINARY FOR RUCTION
	A211	     A212 	A213		OWNERSHIP OF INSTRUM All reports, plans, specifications, co other documents and instruments p as instruments of service shall rema professional. The design profession statutory and other reserved rights,	mputer files, field data, notes and repared by the design professional in the property of the design al shall retain all common law,
	ROOF AREA (17,6	ULATION (PER TRIBU 93 SQ FT) X RAIN FA S PER MINUTE (GPM) 18 TABLE 1106.2	LL (.6 INCHS)			
.104 X F	•	960 SQ FT) X RAIN FA PER MINUTE (GPM) 18 TABLE 1106.2	LL (.6 INCHS)			
	ROO	F CLASS	IFICATION	J		
TAB	LE 1505.1 OF THE	EIBC.	5 'C' ROOF ASSEMBLY	PER		
CLAS	SSIFICATION LETT		PROVIDE A ROOF U.L. CLASSIFICATION A SUSTIBLE METAL DECK.			
DET,			VIDE MANUFACTURER'S DM COMPLIANCE MITH ,	-		20
	RO	OF PLAN	LEGEND		A Subsection	VARD ADO
•	+0'-0" B.O.D.	= BOTTOM OF D	ECK			NITURE & BOULEVARD COLORADO
•	+0'-0" T.O.M.	= TOP OF MASON	NRY			FUR TUTT INGS,
•	+0'-0" T.O.P.	= TOP OF PARAF	°ET		Ē	TYLE GHTS & DO SPR
_	►	= 1/4" : 1'-0" MIN.	SLOPE		* *	LIFES ABS HEI OLORA
		= ROOF FLOW			N	Now JA
		LAN GEN	IERAL NO			
_		ROOF SURFACE SHA	ALL MAINTAIN A MINIMU	IM SLOPE OF		
A. ALI 1/4 F <i>O</i>	L AREAS OF THE 1" PER FOOT. AD OT SLOPE.	D FOAM CRICKETS ,	AS REQUIRED TO ACH	IEVE 1/4" PER		
A. ALI 1/4 FO B. RC CC DE	L AREAS OF THE 4" PER FOOT. AD 2007 SLOPE. 200FING MEMBRAN 200FING MEMBRAN 200FILIANCE WITH T 21 TAILS.	D FOAM CRICKETS , NE SHALL BE PROVIE THE PROJECT SPECIF	AS REQUIRED TO ACHI DED AND INSTALLED IN FICATIONS AND MANUF	IEVE 1/4" PER N FACTURER	Case #: Plan Check #:	
A. ALI 1/4 FO B. RC CO DE C. SEI DC	L AREAS OF THE 4" PER FOOT. AD OT SLOPE. DOFING MEMBRAN DMPLIANCE WITH T TAILS. E PROJECT MANU DOCUMENTS FOR C	DD FOAM CRICKETS , NE SHALL BE PROVIE THE PROJECT SPECIF JAL AND MECHANICA COORDINATING ITEMS	AS REQUIRED TO ACHI DED AND INSTALLED IN FICATIONS AND MANUF	IEVE 1/4" PER N FACTURER RUCTURAL		10/15/
A. ALI 1/4 FO B. RC CC DE C. SEI DC D. NO OF E. LO WIT	L AREAS OF THE "PER FOOT. AD OT SLOPE. OFING MEMBRAN OMPLIANCE WITH T TAILS. E PROJECT MANU OCUMENTS FOR C PENETRATIONS OF THE BUILDING PA OCATIONS INDICAT THE ARCHITEC	DD FOAM CRICKETS , NE SHALL BE PROVIE THE PROJECT SPECIF JAL AND MECHANICA CORDINATING ITEMS OR EQUIPMENT SHAL ARAPET U.N.O. TED FOR THE ROOF TURAL FLOOR PLAN	AS REQUIRED TO ACH DED AND INSTALLED IN FICATIONS AND MANUF IL, PLUMBING, AND STR L BE INSTALLED WITHI DRAINS SHALL BE COM AND THE STRUCTURAL	N FACTURER RUCTURAL IN 24 INCHES	Plan Check #: Date:	10/15/
A. ALI 1/4 FO B. RC DE C. SEI DC D. NO OF E. LO WIT PLU F. ELI (B. THI	L AREAS OF THE "PER FOOT. AD OT SLOPE. DOFING MEMBRAN MPLIANCE WITH T TAILS. E PROJECT MANU COMENTS FOR C PENETRATIONS OF THE BUILDING PA CATIONS INDICAT THE ARCHITEC UMBING PLANS FO EVATIONS SHOWN O.D.) UNLESS NO E SPECIFIED DEC	DD FOAM CRICKETS , NE SHALL BE PROVIE THE PROJECT SPECIF JAL AND MECHANICA CORDINATING ITEMS OR EQUIPMENT SHAL ARAPET U.N.O. TED FOR THE ROOF TURAL FLOOR PLAN OR PROPER PLACEN N ON THE ROOF PLAN TED OTHERWISE. SEE KING MATERIALS. HE	AS REQUIRED TO ACH DED AND INSTALLED IN FICATIONS AND MANUF IL, PLUMBING, AND STR L BE INSTALLED WITHI DRAINS SHALL BE COM AND THE STRUCTURAL	IEVE 1/4" PER N FACTURER RUCTURAL IN 24 INCHES DORDINATED L AND F DECK IENTS FOR	Plan Check #: Date:	10/15/
A. ALI 1/4 FO B. RC CO DE C. SEE DC D. NOF E. LO F. ELE (B. THE FIN G. LO IS	L AREAS OF THE 4" PER FOOT. AD OT SLOPE. OFING MEMBRAN OMPLIANCE WITH T TAILS. E PROJECT MANU OCUMENTS FOR C PENETRATIONS OF THE BUILDING PA OCATIONS INDICAT TH THE ARCHITEC UMBING PLANS FO EVATIONS SHOWN O.D.) UNLESS NOT E SPECIFIED DEC IISH FLOOR NOTE OCATION OF FLAS TO BE INSTALLED	DD FOAM CRICKETS , NE SHALL BE PROVIE THE PROJECT SPECIF JAL AND MECHANICA CORDINATING ITEMS OR EQUIPMENT SHAL ARAPET U.N.O. TED FOR THE ROOF TURAL FLOOR PLAN OR PROPER PLACEN N ON THE ROOF PLAN TED OTHERWISE. SEE KING MATERIALS. HE ED AS +0'-0".	AS REQUIRED TO ACH DED AND INSTALLED IN FICATIONS AND MANUF AL, PLUMBING, AND STR DRAINS SHALL BE CON AND THE STRUCTURAL MENT. N ARE TO BOTTOM OF E STRUCTURAL DOCUM	N FACTURER RUCTURAL IN 24 INCHES PORDINATED L AND F DECK IENTS FOR T TO FIRST	Plan Check #: Date:	10/15/
A. ALI 1/4 FO B. RCCDE C. SEI D. OOF E. LOI PLI F. ELE (B.I FIN G. LO SEE H. THI	L AREAS OF THE "PER FOOT. AD OT SLOPE. DOFING MEMBRAN MPLIANCE WITH T TAILS. E PROJECT MANU OCUMENTS FOR C PENETRATIONS OF THE BUILDING PA OCATIONS INDICAT THE ARCHITEC UMBING PLANS FO EVATIONS SHOWN O.D.) UNLESS NOTE EVATIONS SHOWN O.D.) UNLESS NOTE SPECIFIED DEC IISH FLOOR NOTE OCATION OF FLAS TO BE INSTALLED QUIREMENTS.	DD FOAM CRICKETS , NE SHALL BE PROVIE THE PROJECT SPECIF JAL AND MECHANICA CORDINATING ITEMS OR EQUIPMENT SHAL ARAPET U.N.O. TED FOR THE ROOF TURAL FLOOR PLAN OR PROPER PLACEN N ON THE ROOF PLAN TED OTHERWISE. SEE KING MATERIALS. HE ED AS +0'-0". SHING AND COUNTER D IN COMPLIANCE WIT	AS REQUIRED TO ACHI DED AND INSTALLED IN FICATIONS AND MANUF AL, PLUMBING, AND STR AL BE INSTALLED WITHI DRAINS SHALL BE COM AND THE STRUCTURAL MENT. N ARE TO BOTTOM OF E STRUCTURAL DOCUM EIGHTS ARE RELEVANT	N FACTURER RUCTURAL IN 24 INCHES PORDINATED L AND F DECK TENTS FOR TO FIRST DOF SURFACE, JFACTURER'S OF WARPING,	Plan Check #: Date: Revisions:	10/15/
A. ALI 1/4 FO B. RCODE C. DE D. OCF C. DO D. OCF E. DO F. LB. F. LB. F. LB. F. LD. RE H. THO I. MEF	L AREAS OF THE "PER FOOT. AD OT SLOPE. DOFING MEMBRAN DMPLIANCE WITH T TAILS. E PROJECT MANU DCUMENTS FOR C PENETRATIONS OF THE BUILDING PA CATIONS INDICAT TH THE ARCHITEC UMBING PLANS FO EVATIONS SHOWN O.D.) UNLESS NOT E SPECIFIED DEC ISH FLOOR NOTE CATION OF FLAS TO BE INSTALLED CUIREMENTS. E DASHED LINE CO T CRICKET BUILD CHANICAL UNITS S	DD FOAM CRICKETS , NE SHALL BE PROVIE THE PROJECT SPECIF JAL AND MECHANICA CORDINATING ITEMS OR EQUIPMENT SHAL ARAPET U.N.O. TED FOR THE ROOF JAN OR PROPER PLACEN NON THE ROOF PLAN TED OTHERWISE. SEE KING MATERIALS. HE ED AS +0'-0". SHING AND COUNTER D IN COMPLIANCE WIT ON THE ROOF DESIGN O OUTS. SHALL BE PLACED IN	AS REQUIRED TO ACHI DED AND INSTALLED IN FICATIONS AND MANUF AL, PLUMBING, AND STR AL BE INSTALLED WITHI DRAINS SHALL BE COM AND THE STRUCTURAL MENT. N ARE TO BOTTOM OF E STRUCTURAL DOCUM EIGHTS ARE RELEVANT FLASHING, ABOVE RO TH THE ROOFING MANU	N FACTURER RUCTURAL IN 24 INCHES ORDINATED L AND F DECK IENTS FOR T TO FIRST OF SURFACE, UFACTURER'S OF WARPING, ON FOR EASE	Plan Check #: Date:	10/15/ 20068.1 OM, MF
A. ALI 1/4 F RCODE EEO D. D. D	L AREAS OF THE "PER FOOT. AD OT SLOPE. DOFING MEMBRAN MPLIANCE WITH T TAILS. E PROJECT MANU OCUMENTS FOR C PENETRATIONS OF THE BUILDING P/ OCATIONS INDICAT THE BUILDING P/ OCATIONS INDICAT THE ARCHITEC UMBING PLANS FO EVATIONS SHOWN O.D.) UNLESS NOTE OCATION OF FLAS TO BE INSTALLED OCATION OF FLAS TO BE INSTALLED CATION OF FLAS CONTRACE AIL CONTRACE AIL CONTRACES. ENERAL CONTRACE PLIERS. WALK P.	D FOAM CRICKETS , NE SHALL BE PROVIE THE PROJECT SPECIF JAL AND MECHANICA CORDINATING ITEMS OR EQUIPMENT SHAL ARAPET U.N.O. TED FOR THE ROOF JAN OR PROPER PLACEN NON THE ROOF PLAN TED OTHERWISE. SEE KING MATERIALS. HE ED AS +0'-0". SHING AND COUNTER D IN COMPLIANCE WIT ON THE ROOF DESIGN OUTS. SHALL BE PLACED IN ND COMPATIBILITY W CTOR IS RESPONSIBL F ACCESS AND MECH PADS SHOULD EXTENT , AND TO ANY ADDIT	AS REQUIRED TO ACHI DED AND INSTALLED IN FICATIONS AND MANUF AL, PLUMBING, AND STR AL BE INSTALLED WITHI DRAINS SHALL BE COM AND THE STRUCTURAL MENT. N ARE TO BOTTOM OF E STRUCTURAL DOCUM EIGHTS ARE RELEVANT FLASHING, ABOVE RC TH THE ROOFING MANU NATES EXTENT OF ROC N AN ORDERLY FASHIC	N ACTURER RUCTURAL IN 24 INCHES PORDINATED L AND F DECK MENTS FOR TO FIRST DOF SURFACE, JFACTURER'S OF WARPING, ON FOR EASE BEST G EXACT ADS WITH SS TO AND	Plan Check #: Date: Revisions: Project Number: Drawn By: Title: ROOF PLAN	20068.1 OM, MF

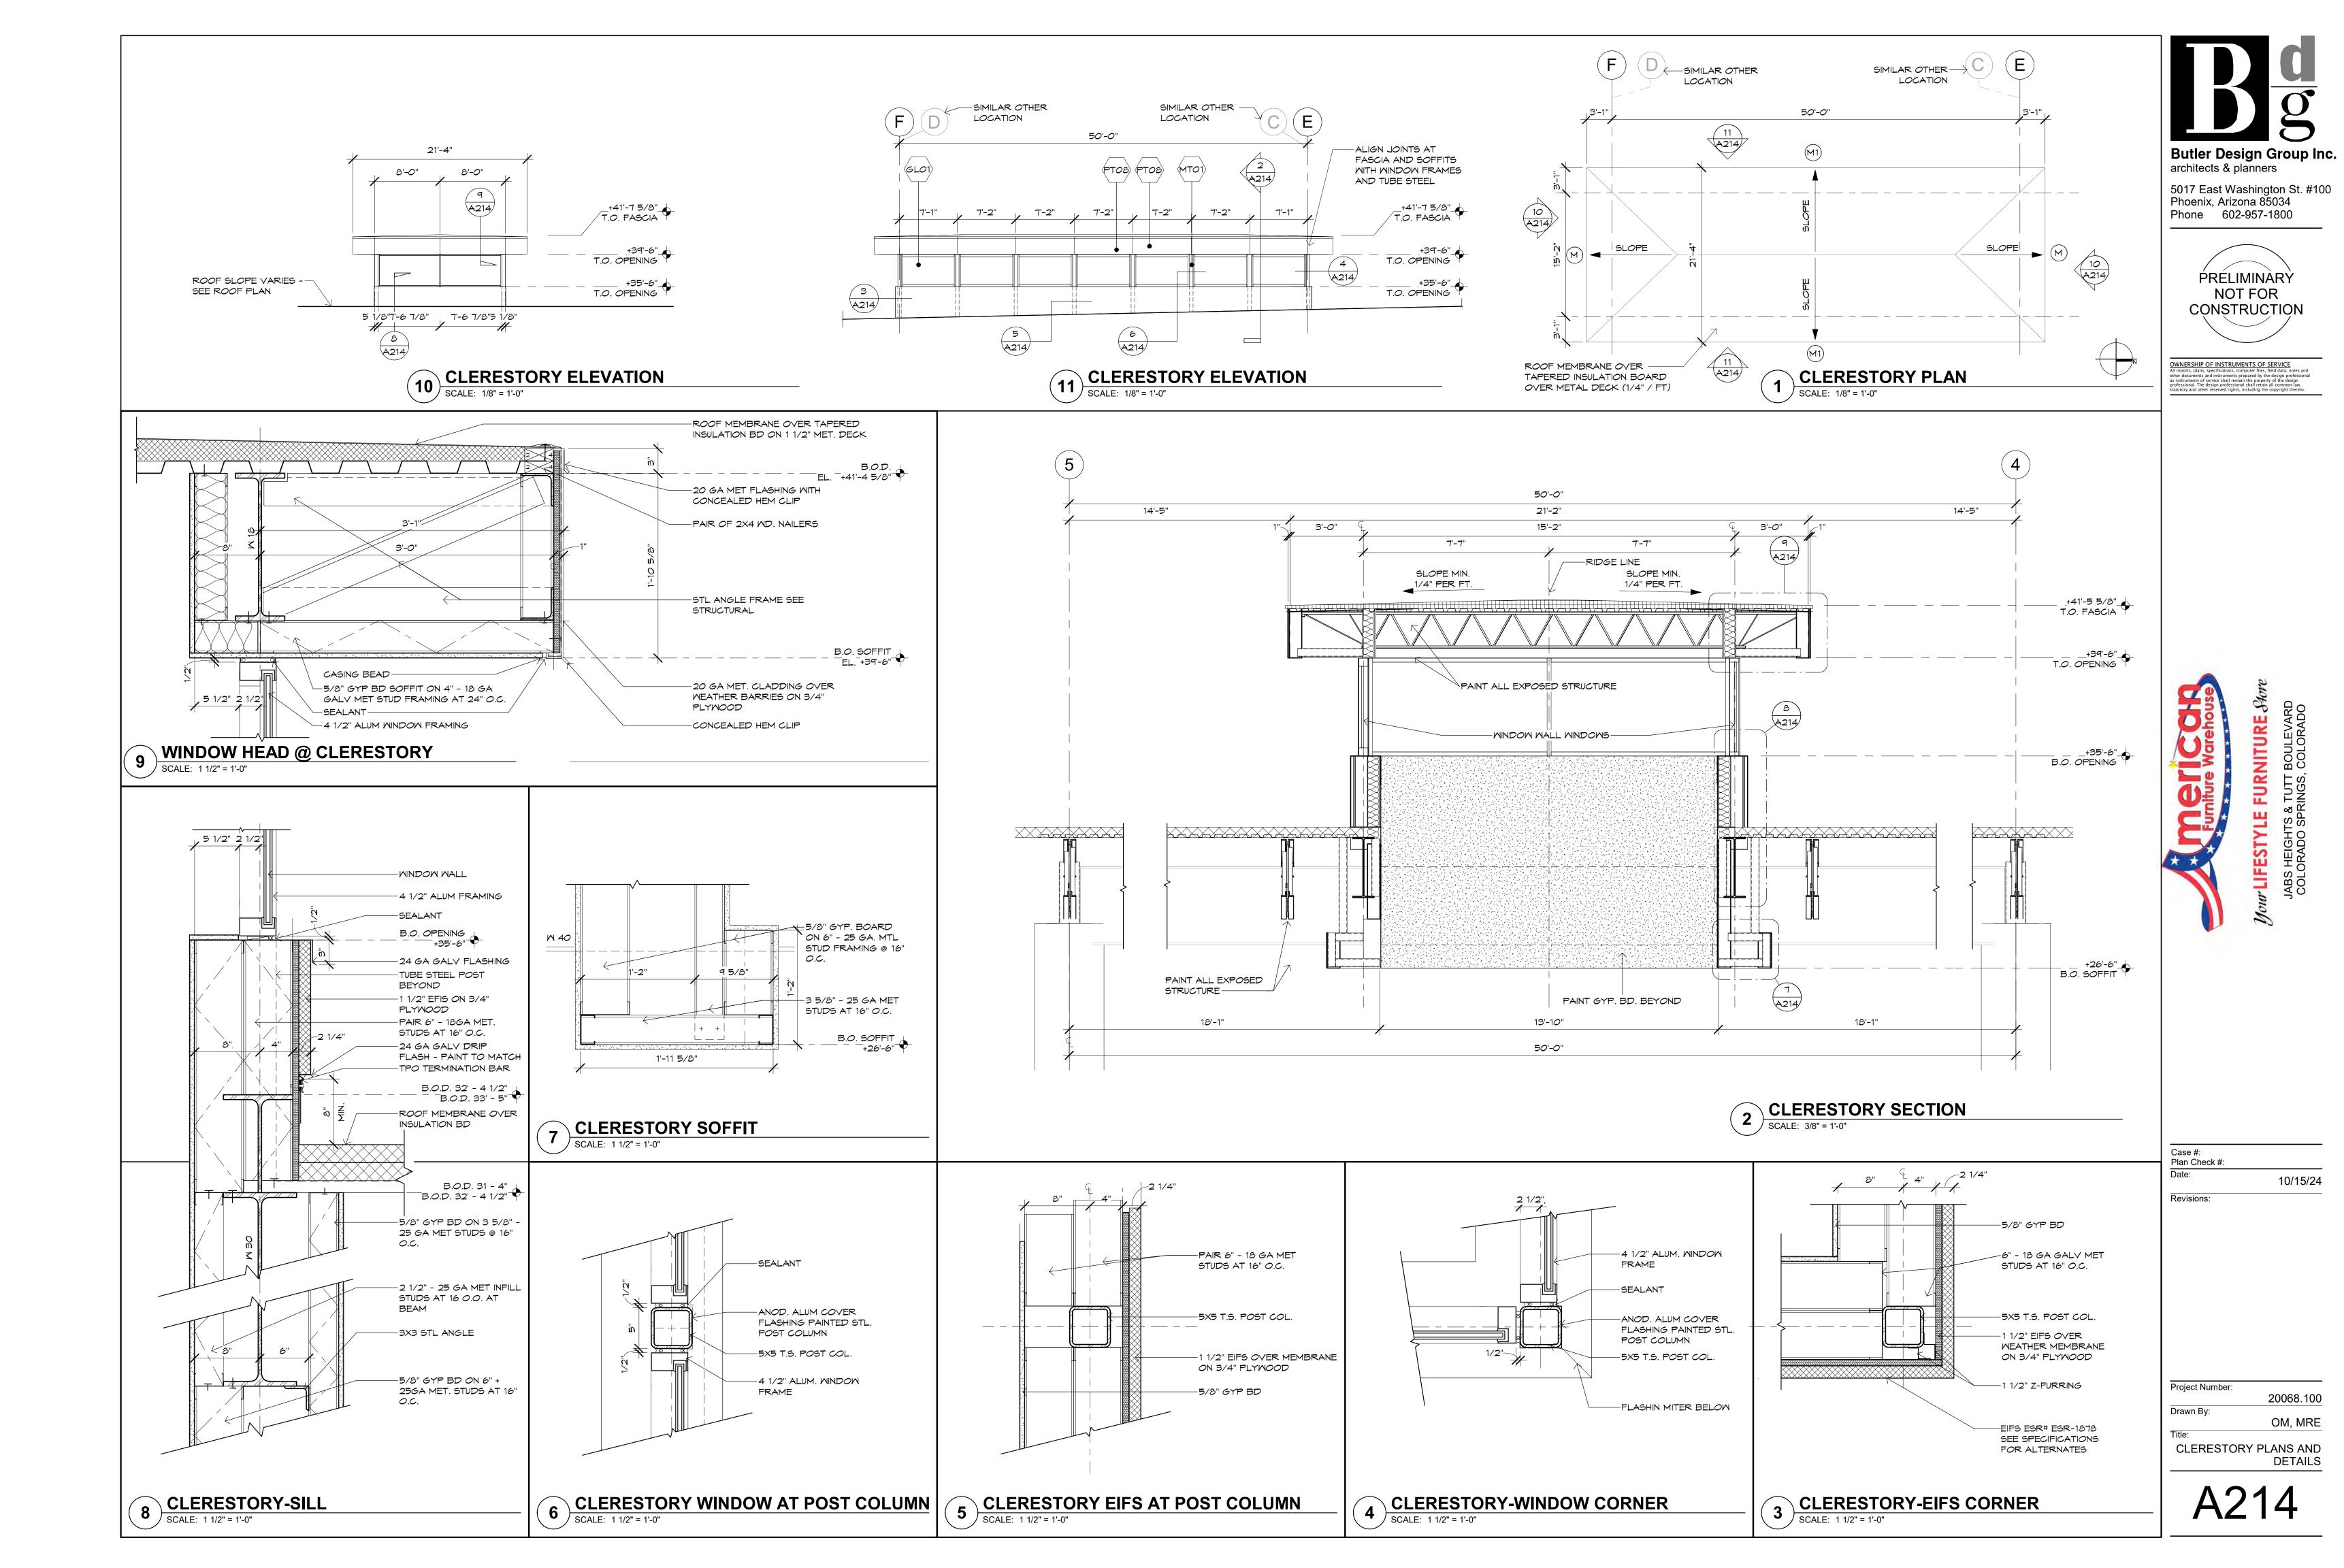


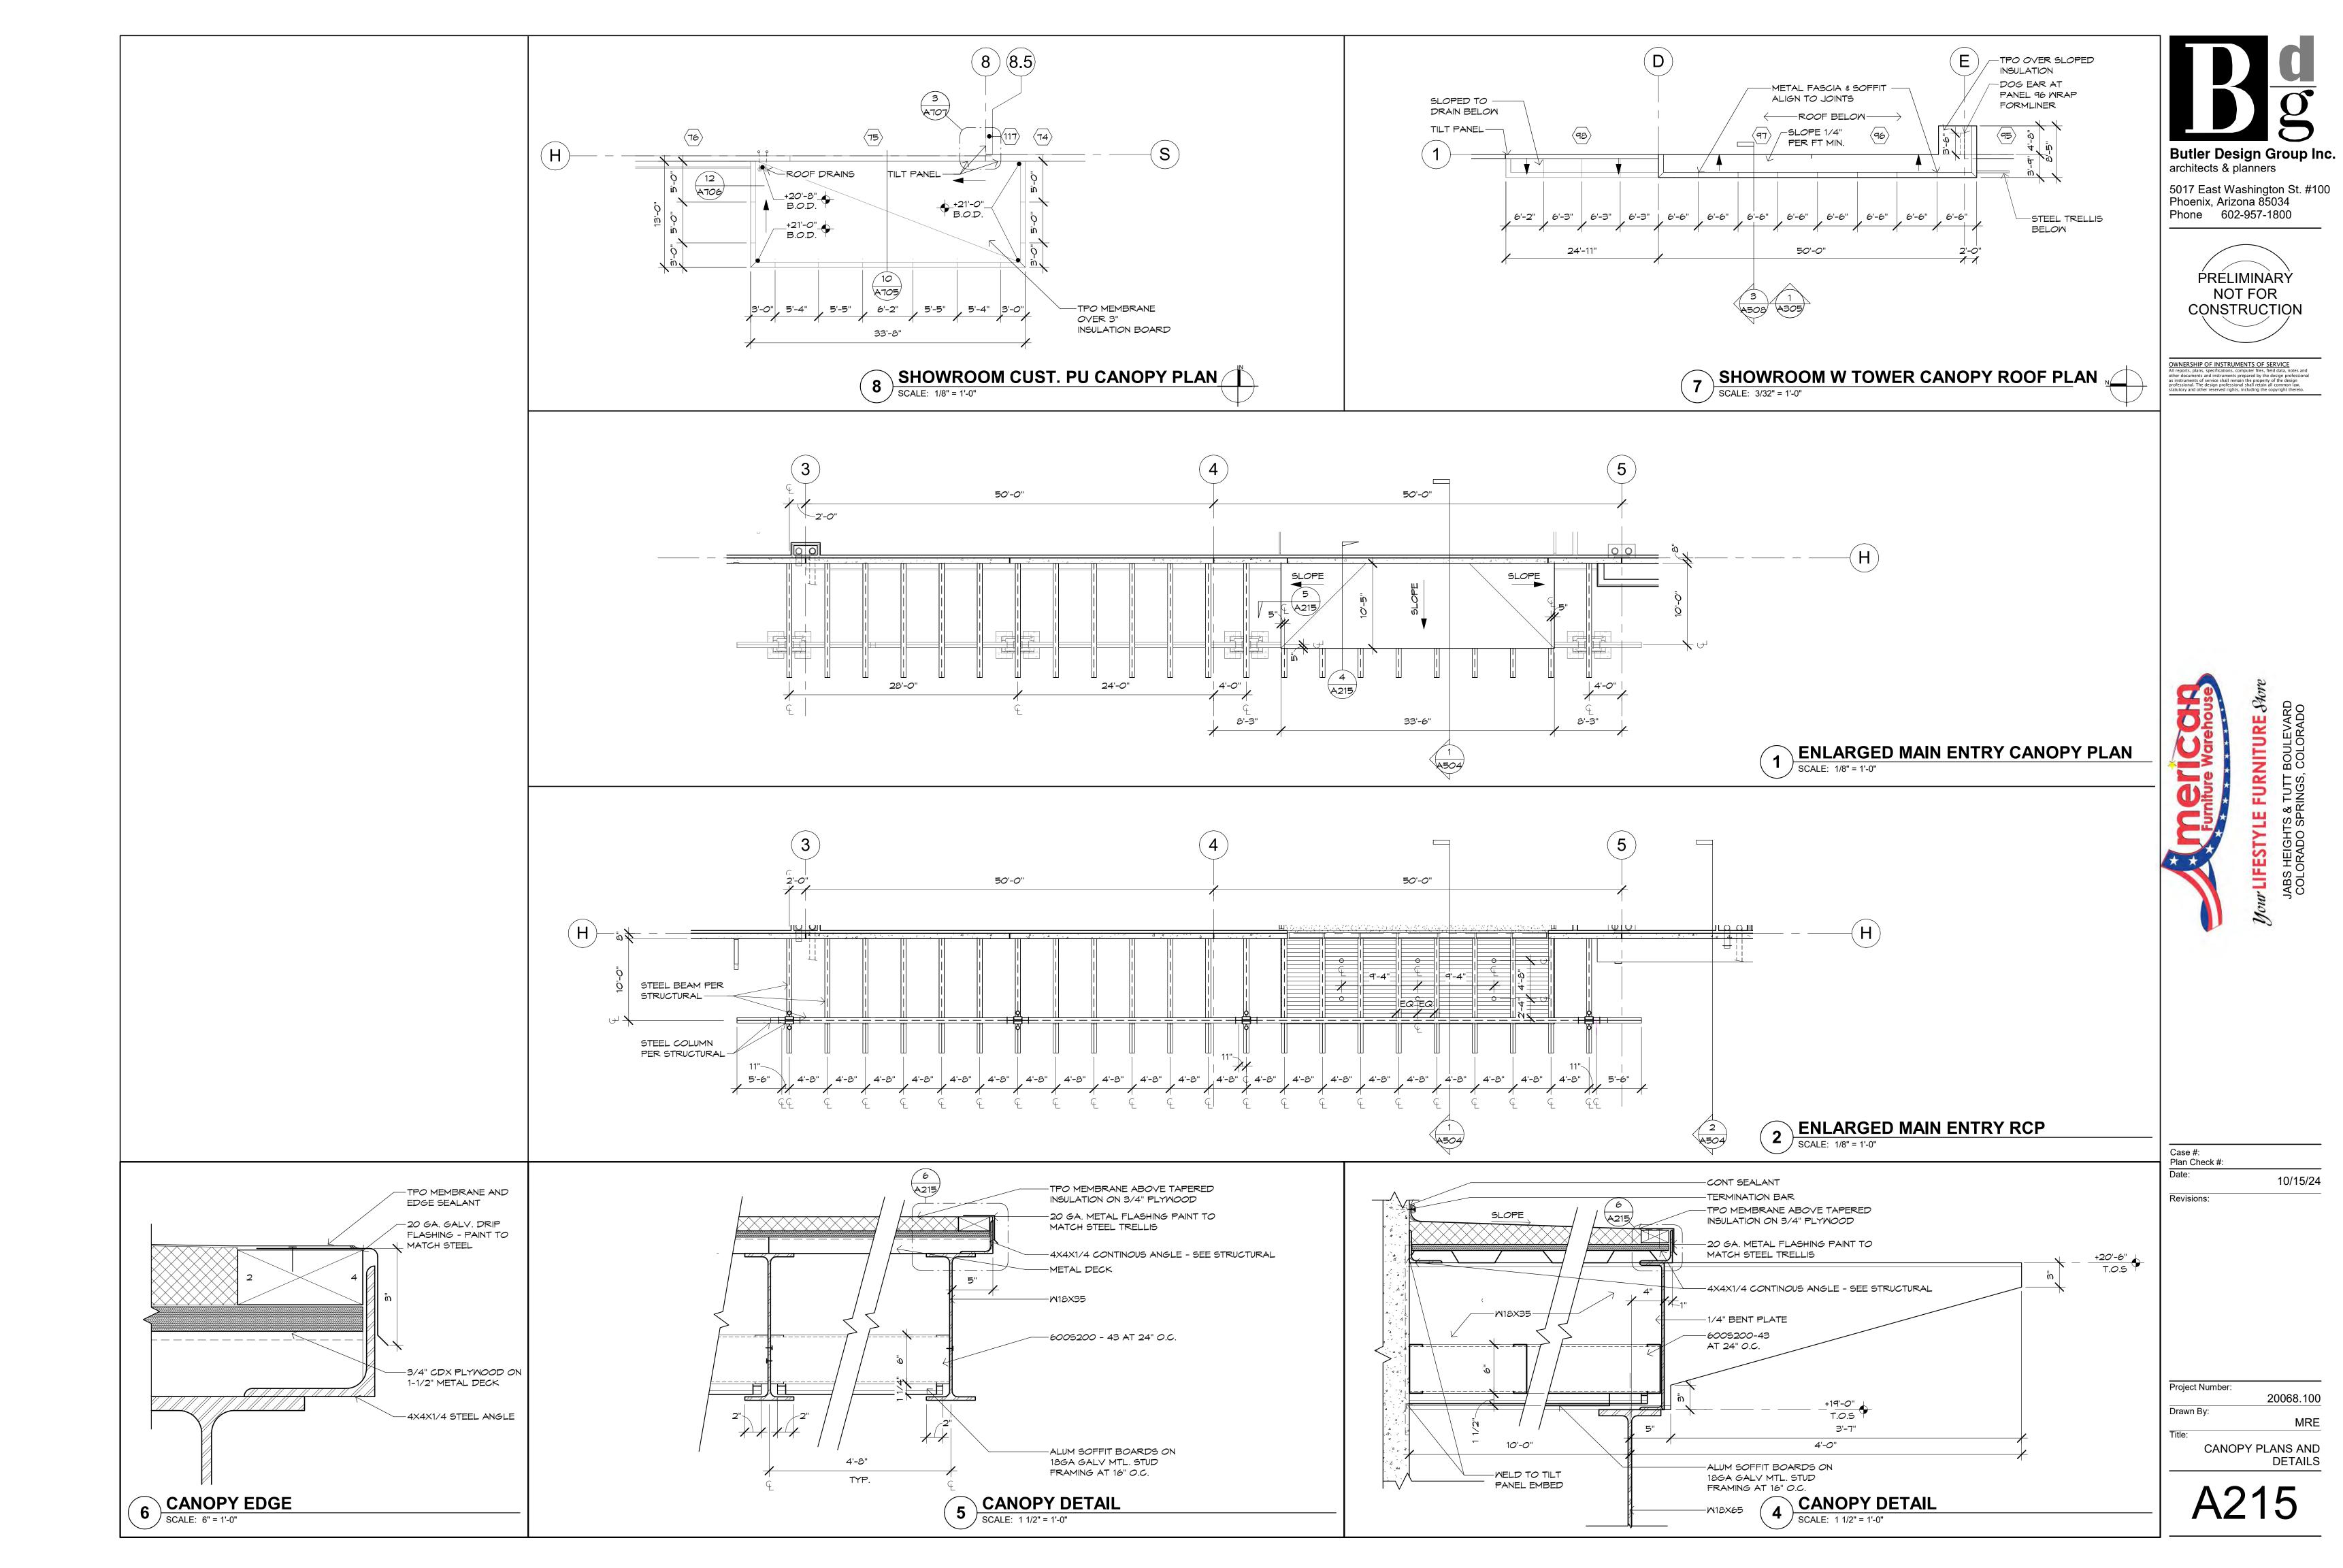


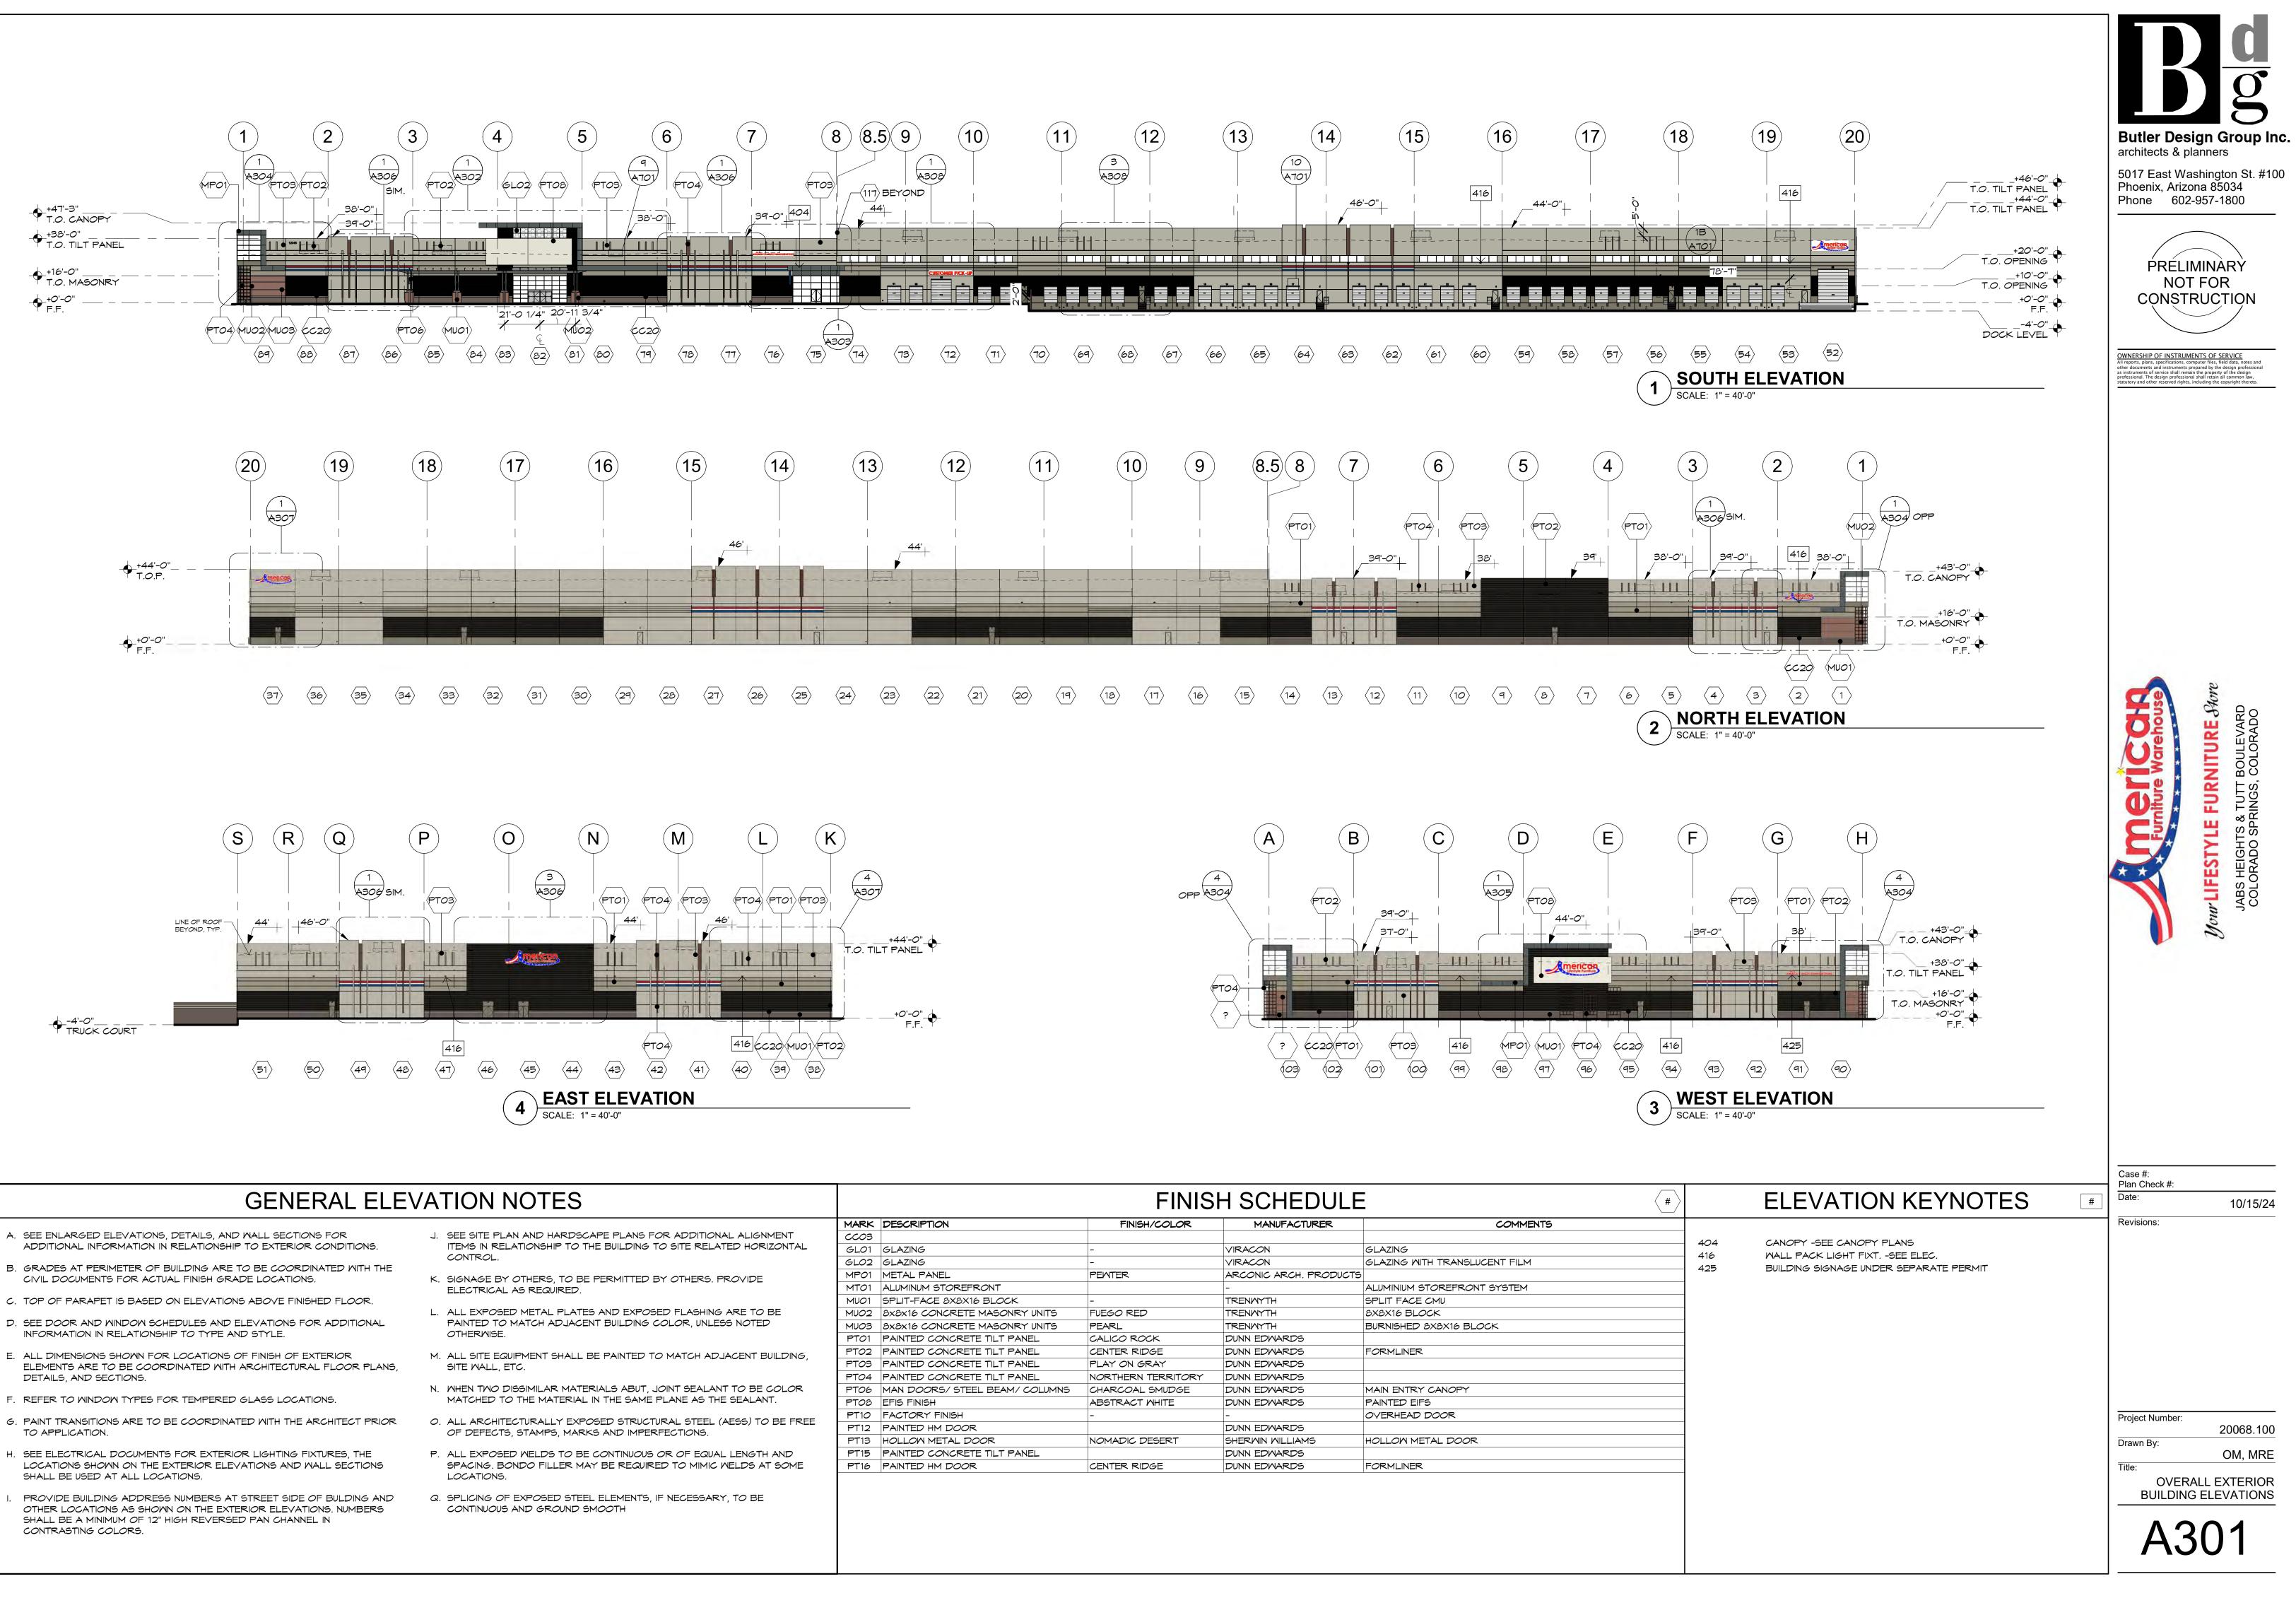



			FINIS	H SCHEDULE	Ξ
	MARK	DESCRIPTION	FINISH/COLOR	MANUFACTURER	COMMENTS
ITIONAL ALIGNMENT	CC03				
RELATED HORIZONTAL	GLO1	GLAZING	-	VIRACON	GLAZING
	GLO2	GLAZING	-	VIRACON	GLAZING WITH TRANSLUCENT FILM
RS. PROVIDE	MPO1	METAL PANEL	PEWTER	ARCONIC ARCH. PRODUCTS	5
	MTO1	ALUMINUM STOREFRONT		-	ALUMINIUM STOREFRONT SYSTEM
	MUO1	SPLIT-FACE 8X8X16 BLOCK	-	TRENWYTH	SPLIT FACE CMU
GHING ARE TO BE	MUO2	8x8x16 CONCRETE MASONRY UNITS	FUEGO RED	TRENMYTH	8X8X16 BLOCK
UNLESS NOTED	MUO3	8x8x16 CONCRETE MASONRY UNITS	PEARL	TRENMYTH	BURNISHED 8X8X16 BLOCK
	PT01	PAINTED CONCRETE TILT PANEL	CALICO ROCK	DUNN EDWARDS	
H ADJACENT BUILDING,	PTO2	PAINTED CONCRETE TILT PANEL	CENTER RIDGE	DUNN EDWARDS	FORMLINER
	PT03	PAINTED CONCRETE TILT PANEL	PLAY ON GRAY	DUNN EDWARDS	
	PT04	PAINTED CONCRETE TILT PANEL	NORTHERN TERRITORY	DUNN EDWARDS	
ALANT TO BE COLOR	PT06	MAN DOORS/ STEEL BEAM/ COLUMNS	CHARCOAL SMUDGE	DUNN EDWARDS	MAIN ENTRY CANOPY
S THE SEALANT.	PTOS	EFIS FINISH	ABSTRACT WHITE	DUNN EDWARDS	PAINTED EIFS
	PT10	FACTORY FINISH	-	-	OVERHEAD DOOR
'EEL (AESS) TO BE FREE NS.	PT12	PAINTED HM DOOR		DUNN EDWARDS	
	PT13	HOLLOW METAL DOOR	NOMADIC DESERT	SHERWIN WILLIAMS	HOLLOW METAL DOOR
EQUAL LENGTH AND	PT15	PAINTED CONCRETE TILT PANEL		DUNN EDWARDS	
IIMIC WELDS AT SOME	PT16	PAINTED HM DOOR	CENTER RIDGE	DUNN EDWARDS	FORMLINER

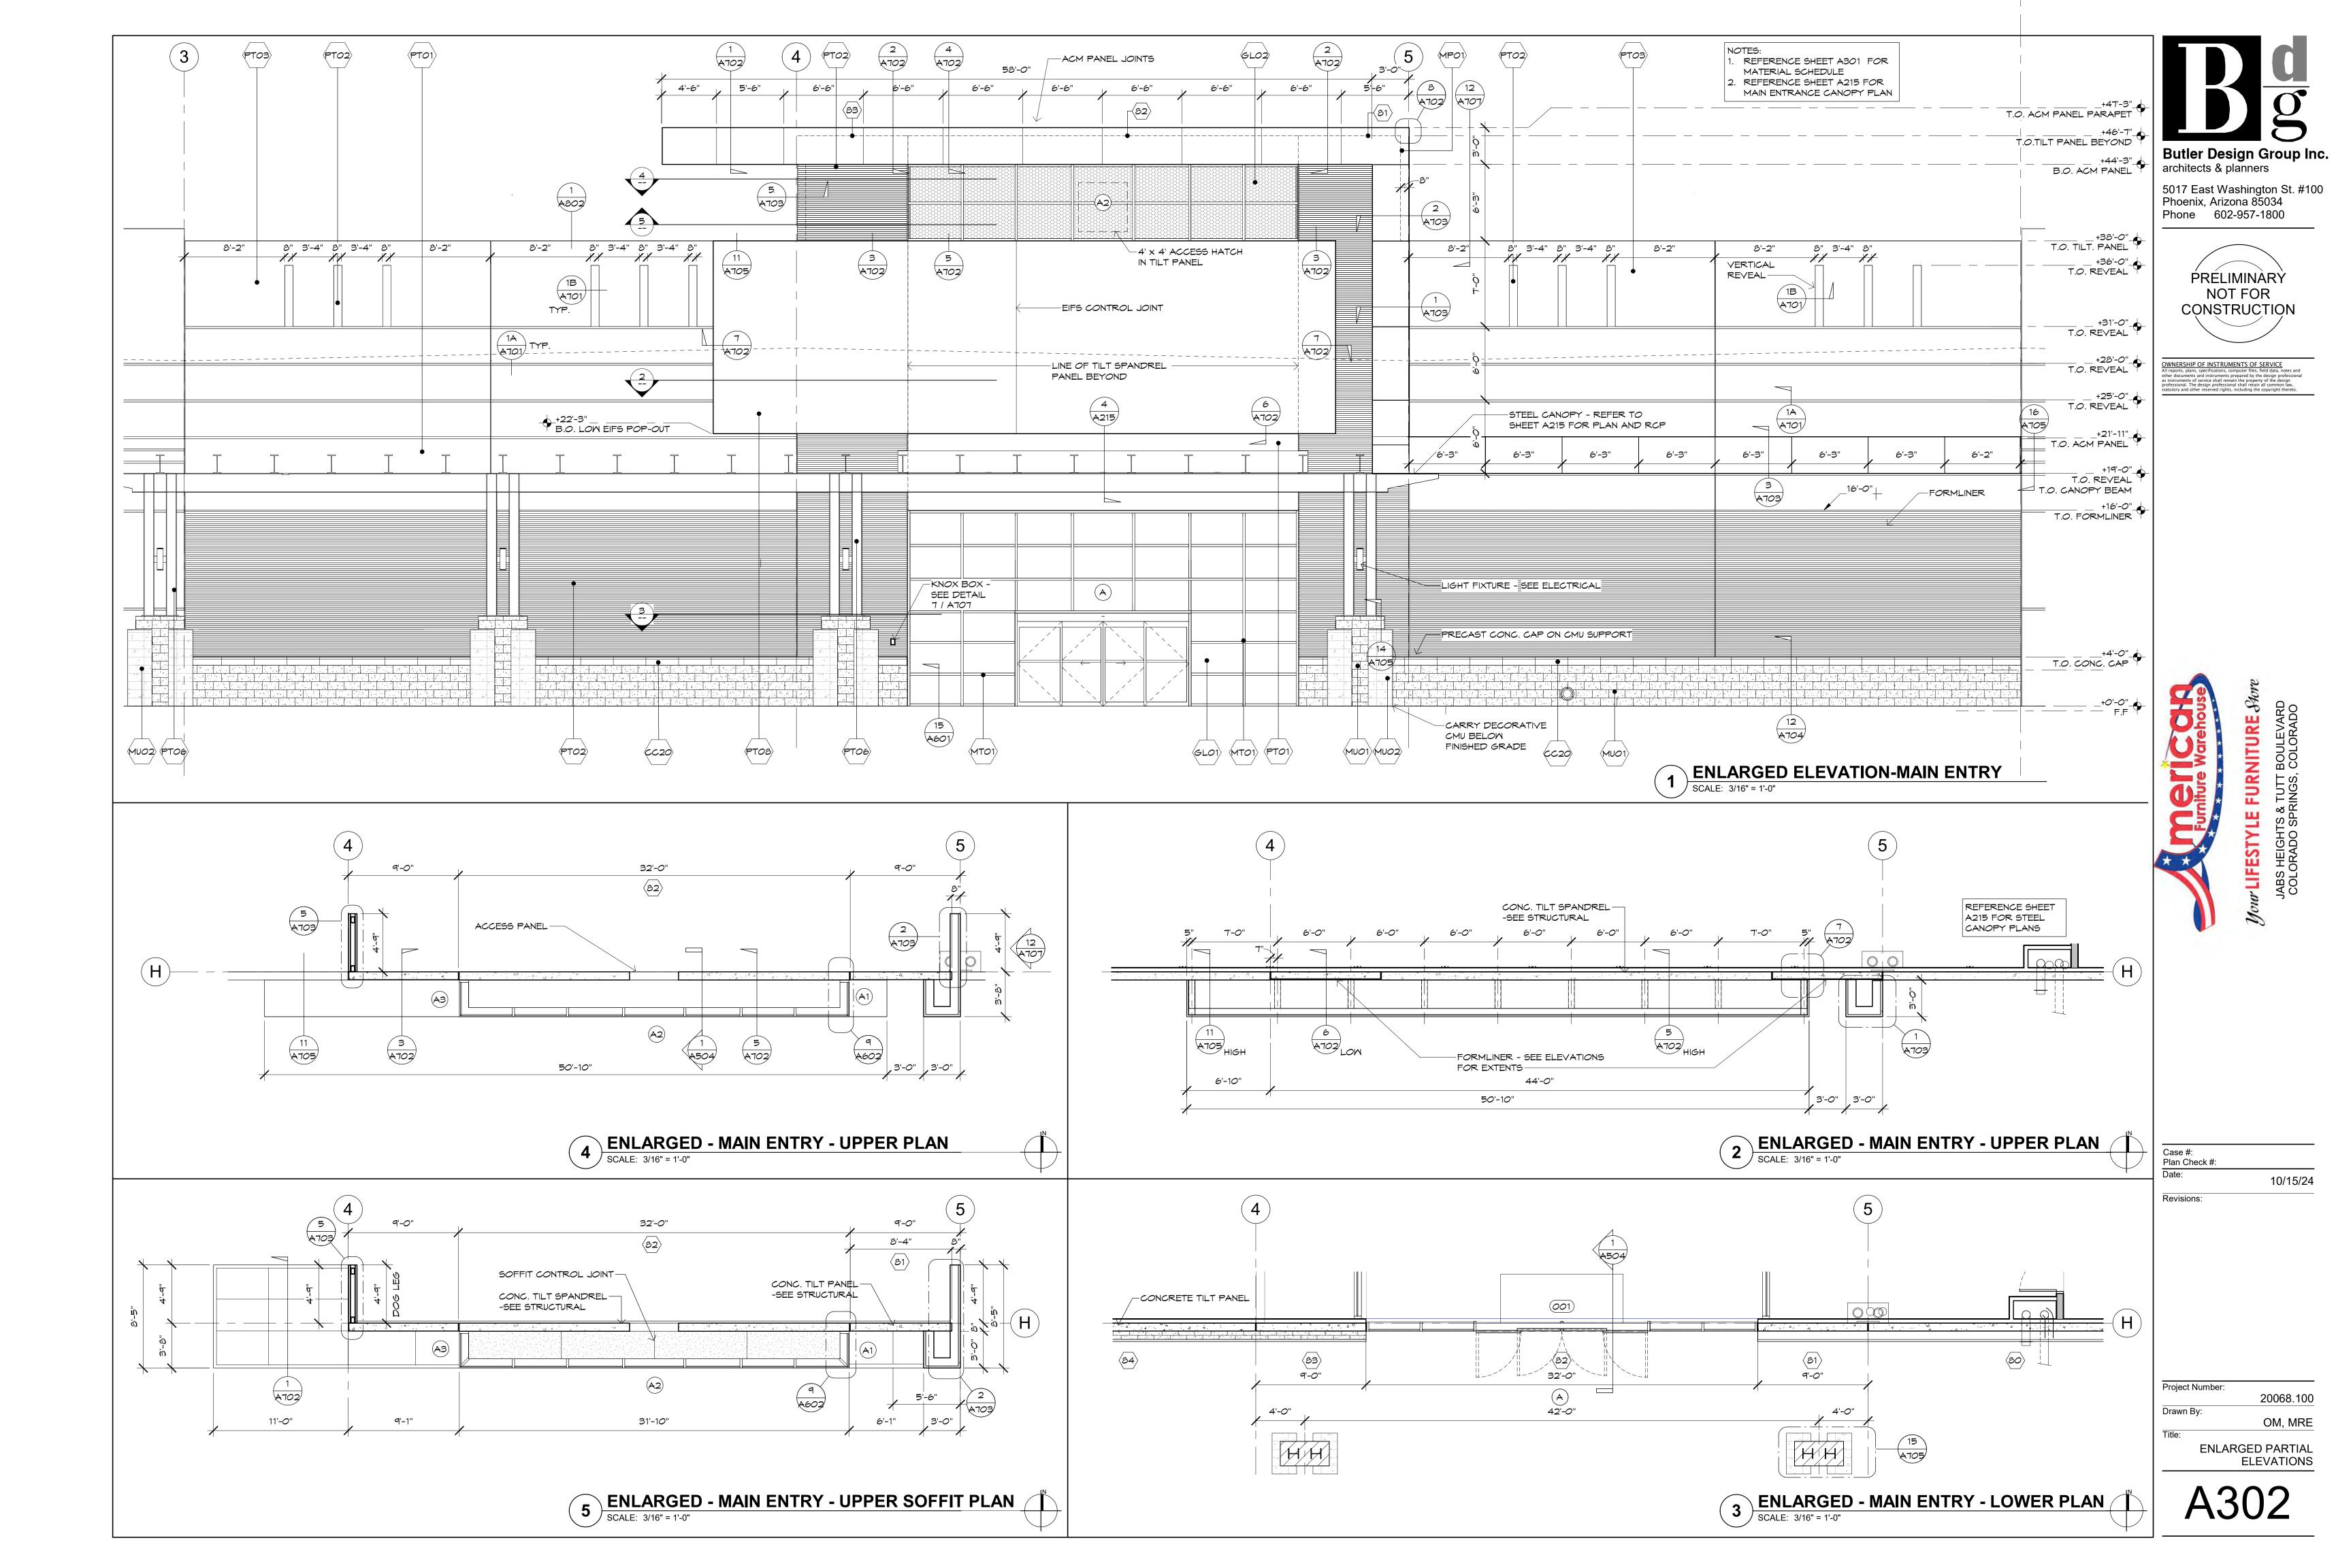


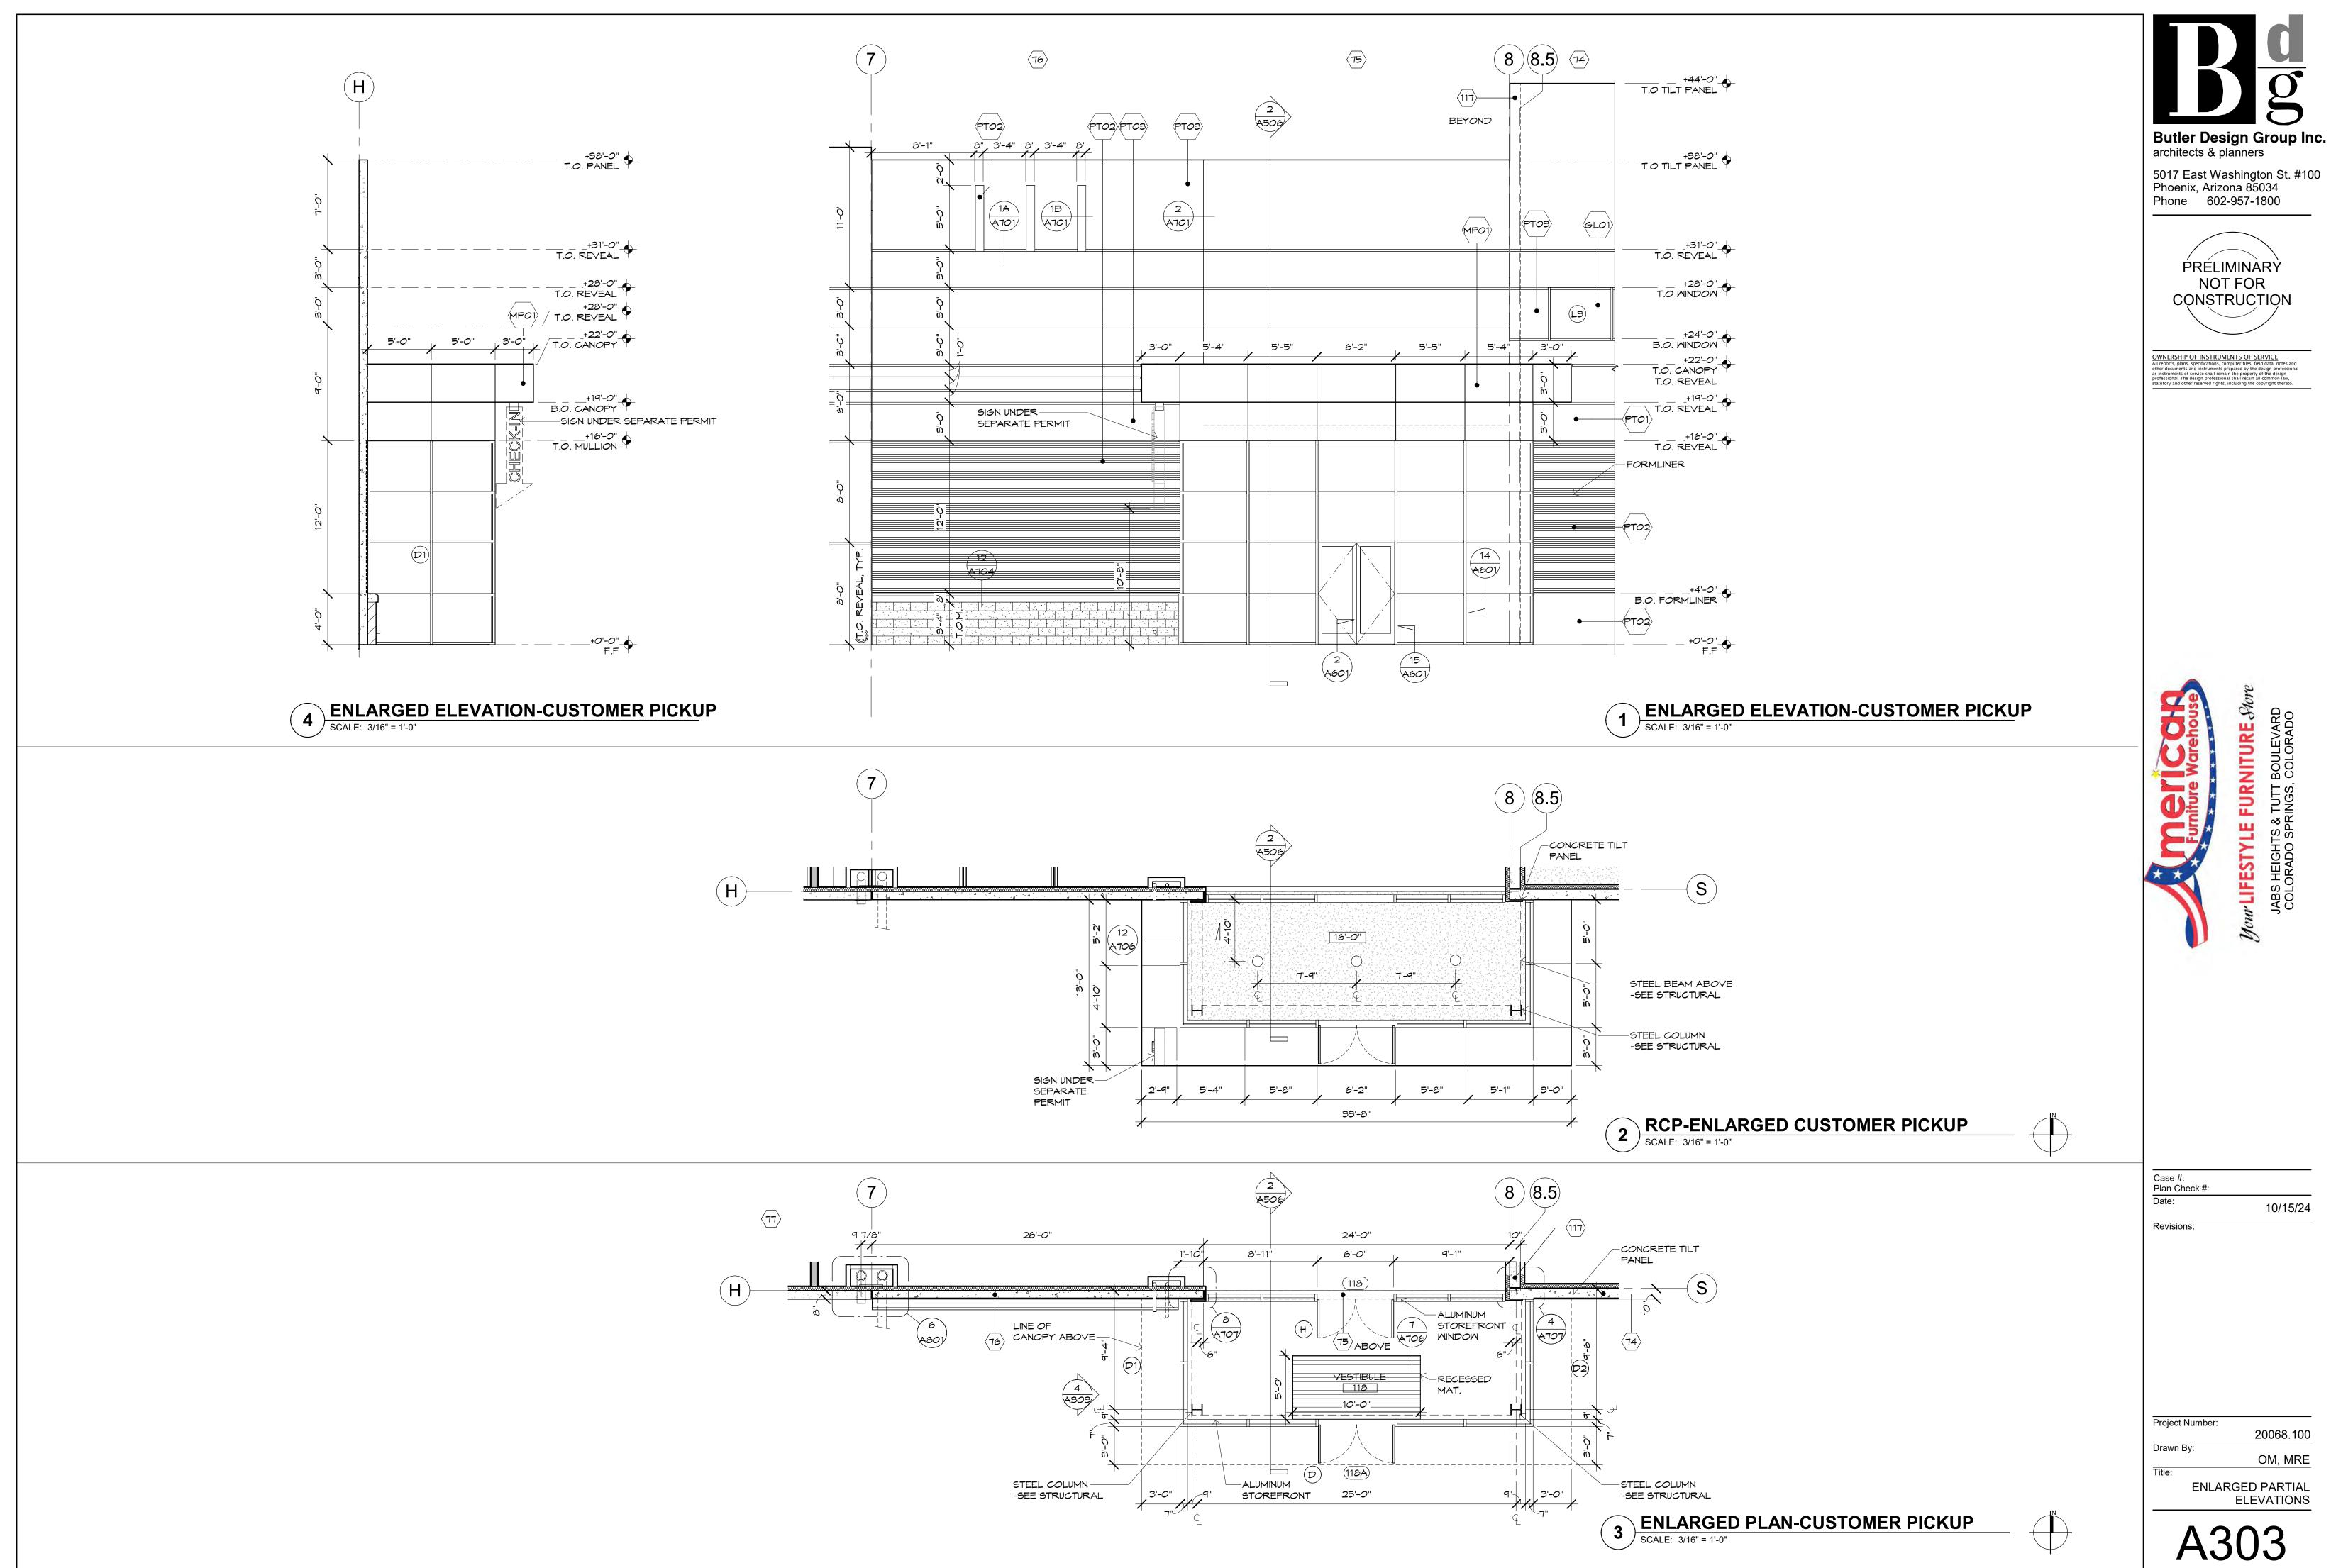


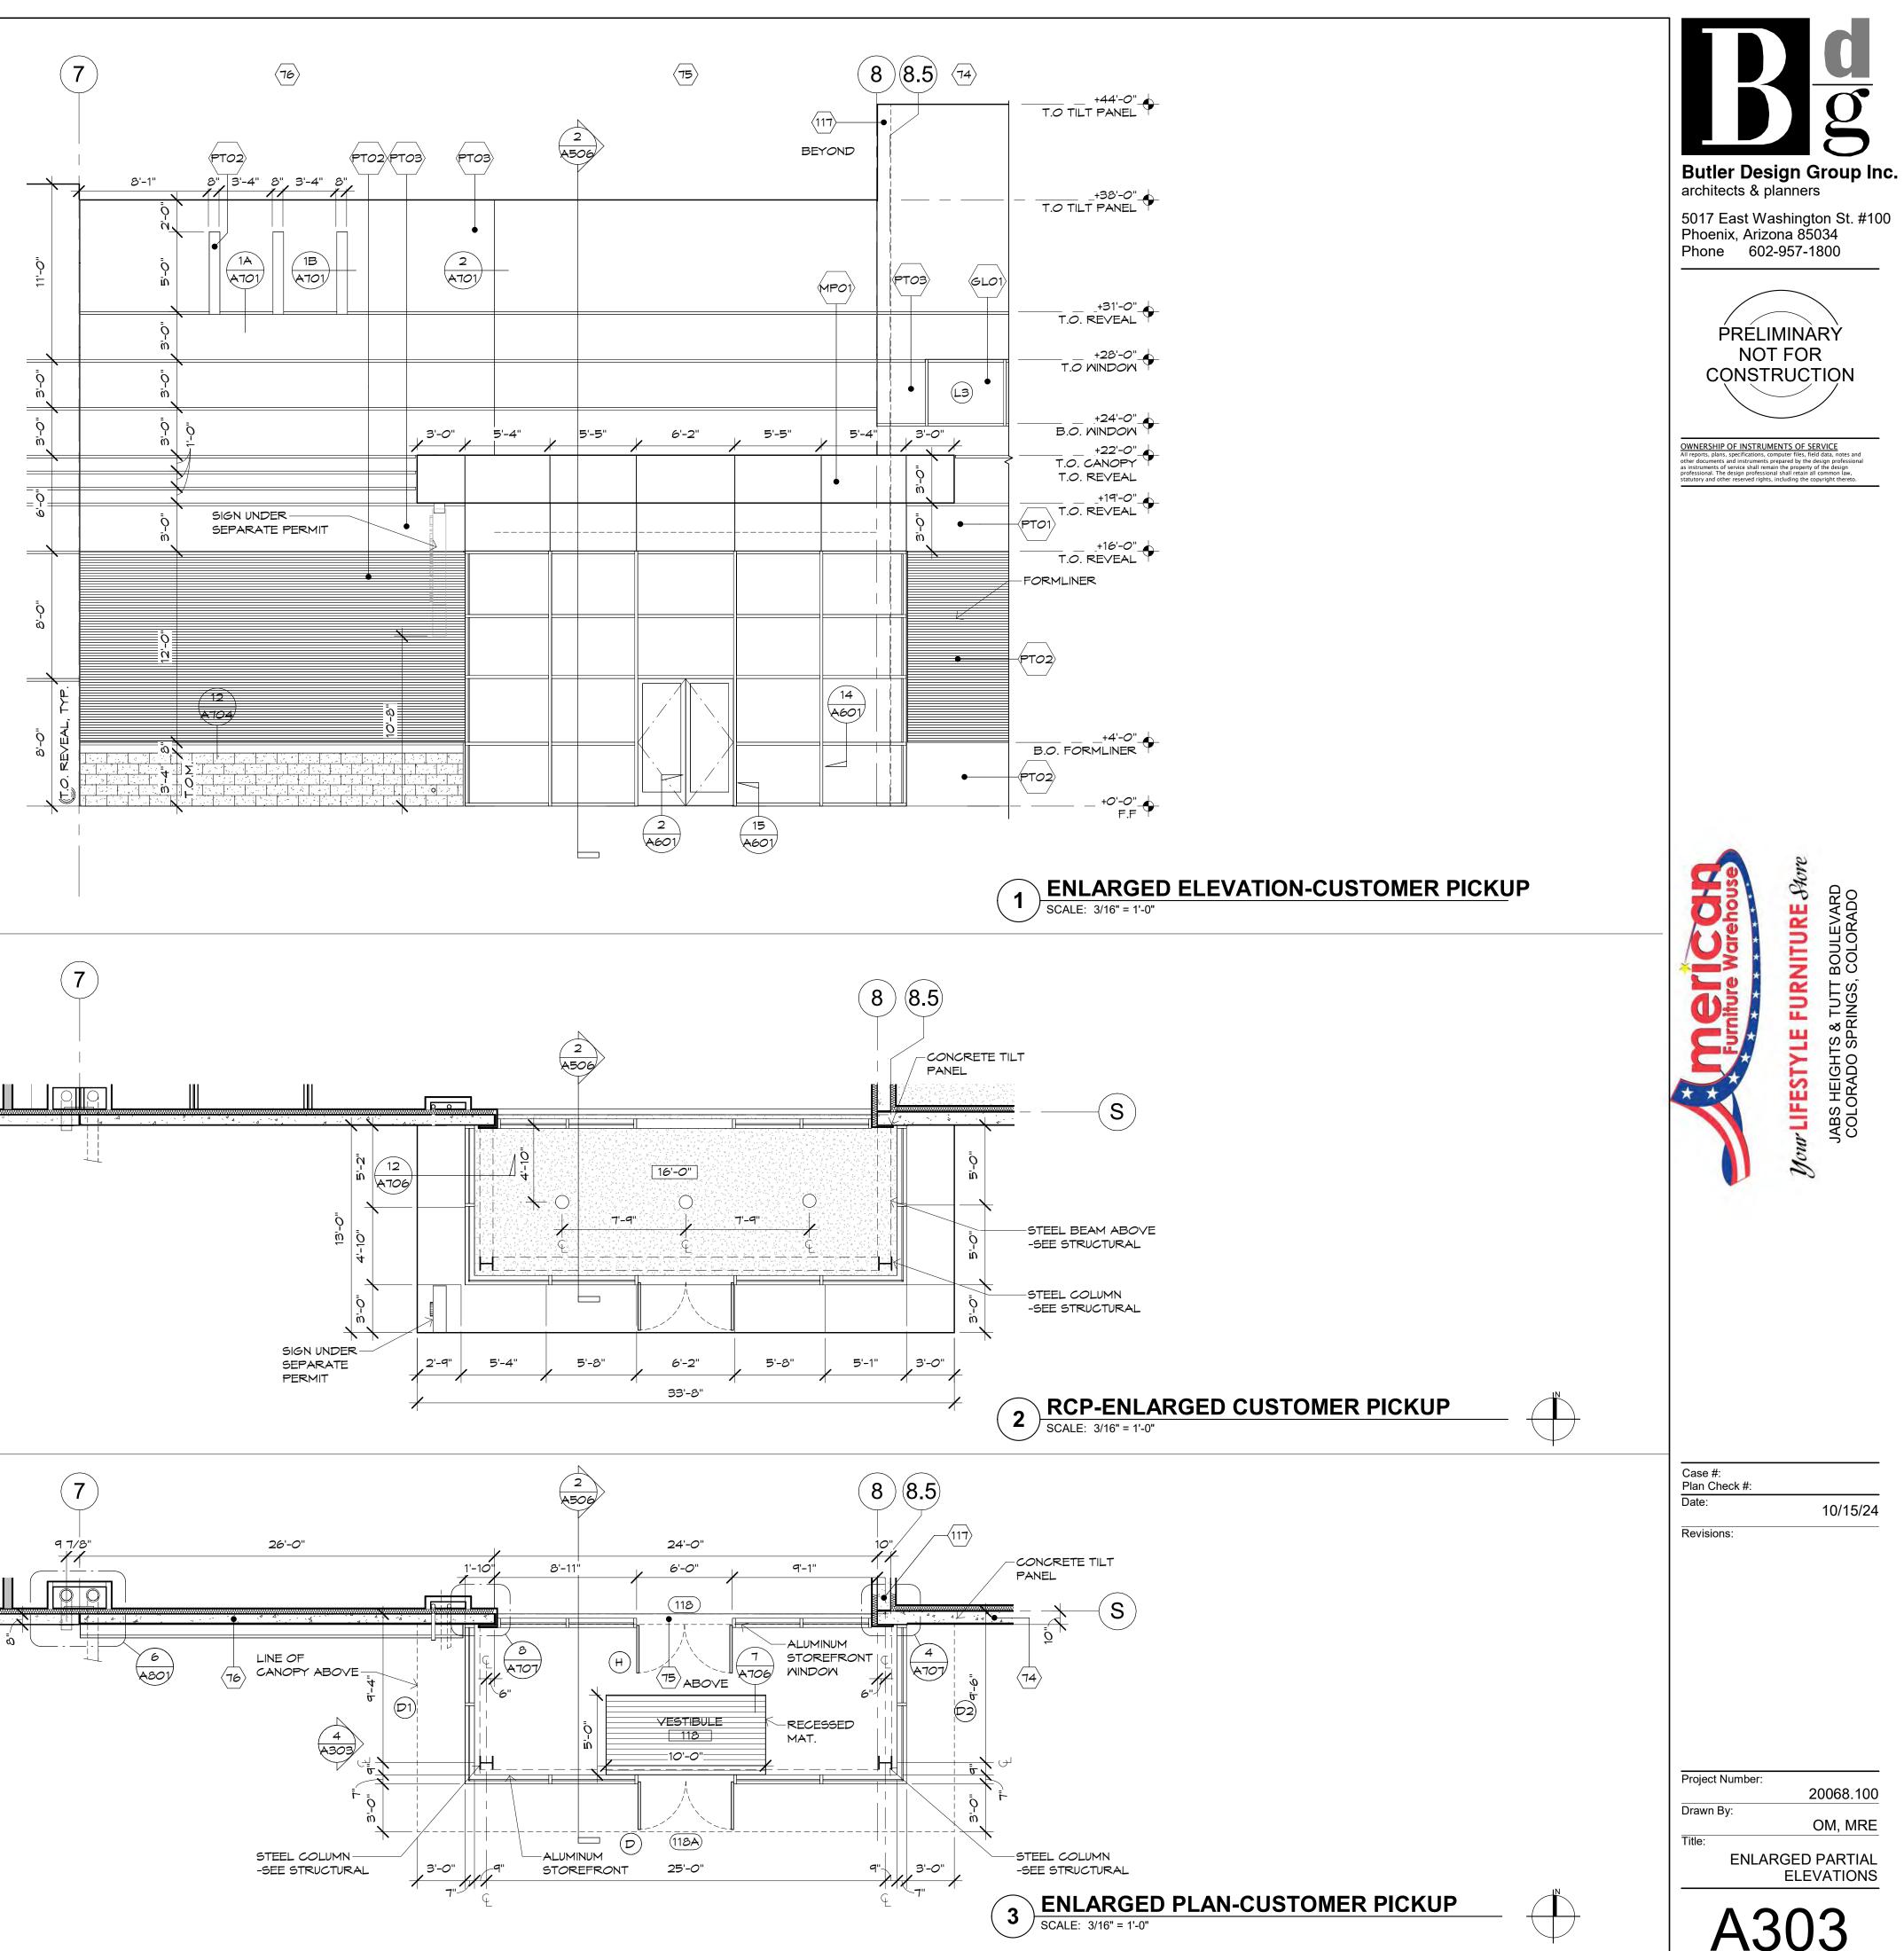


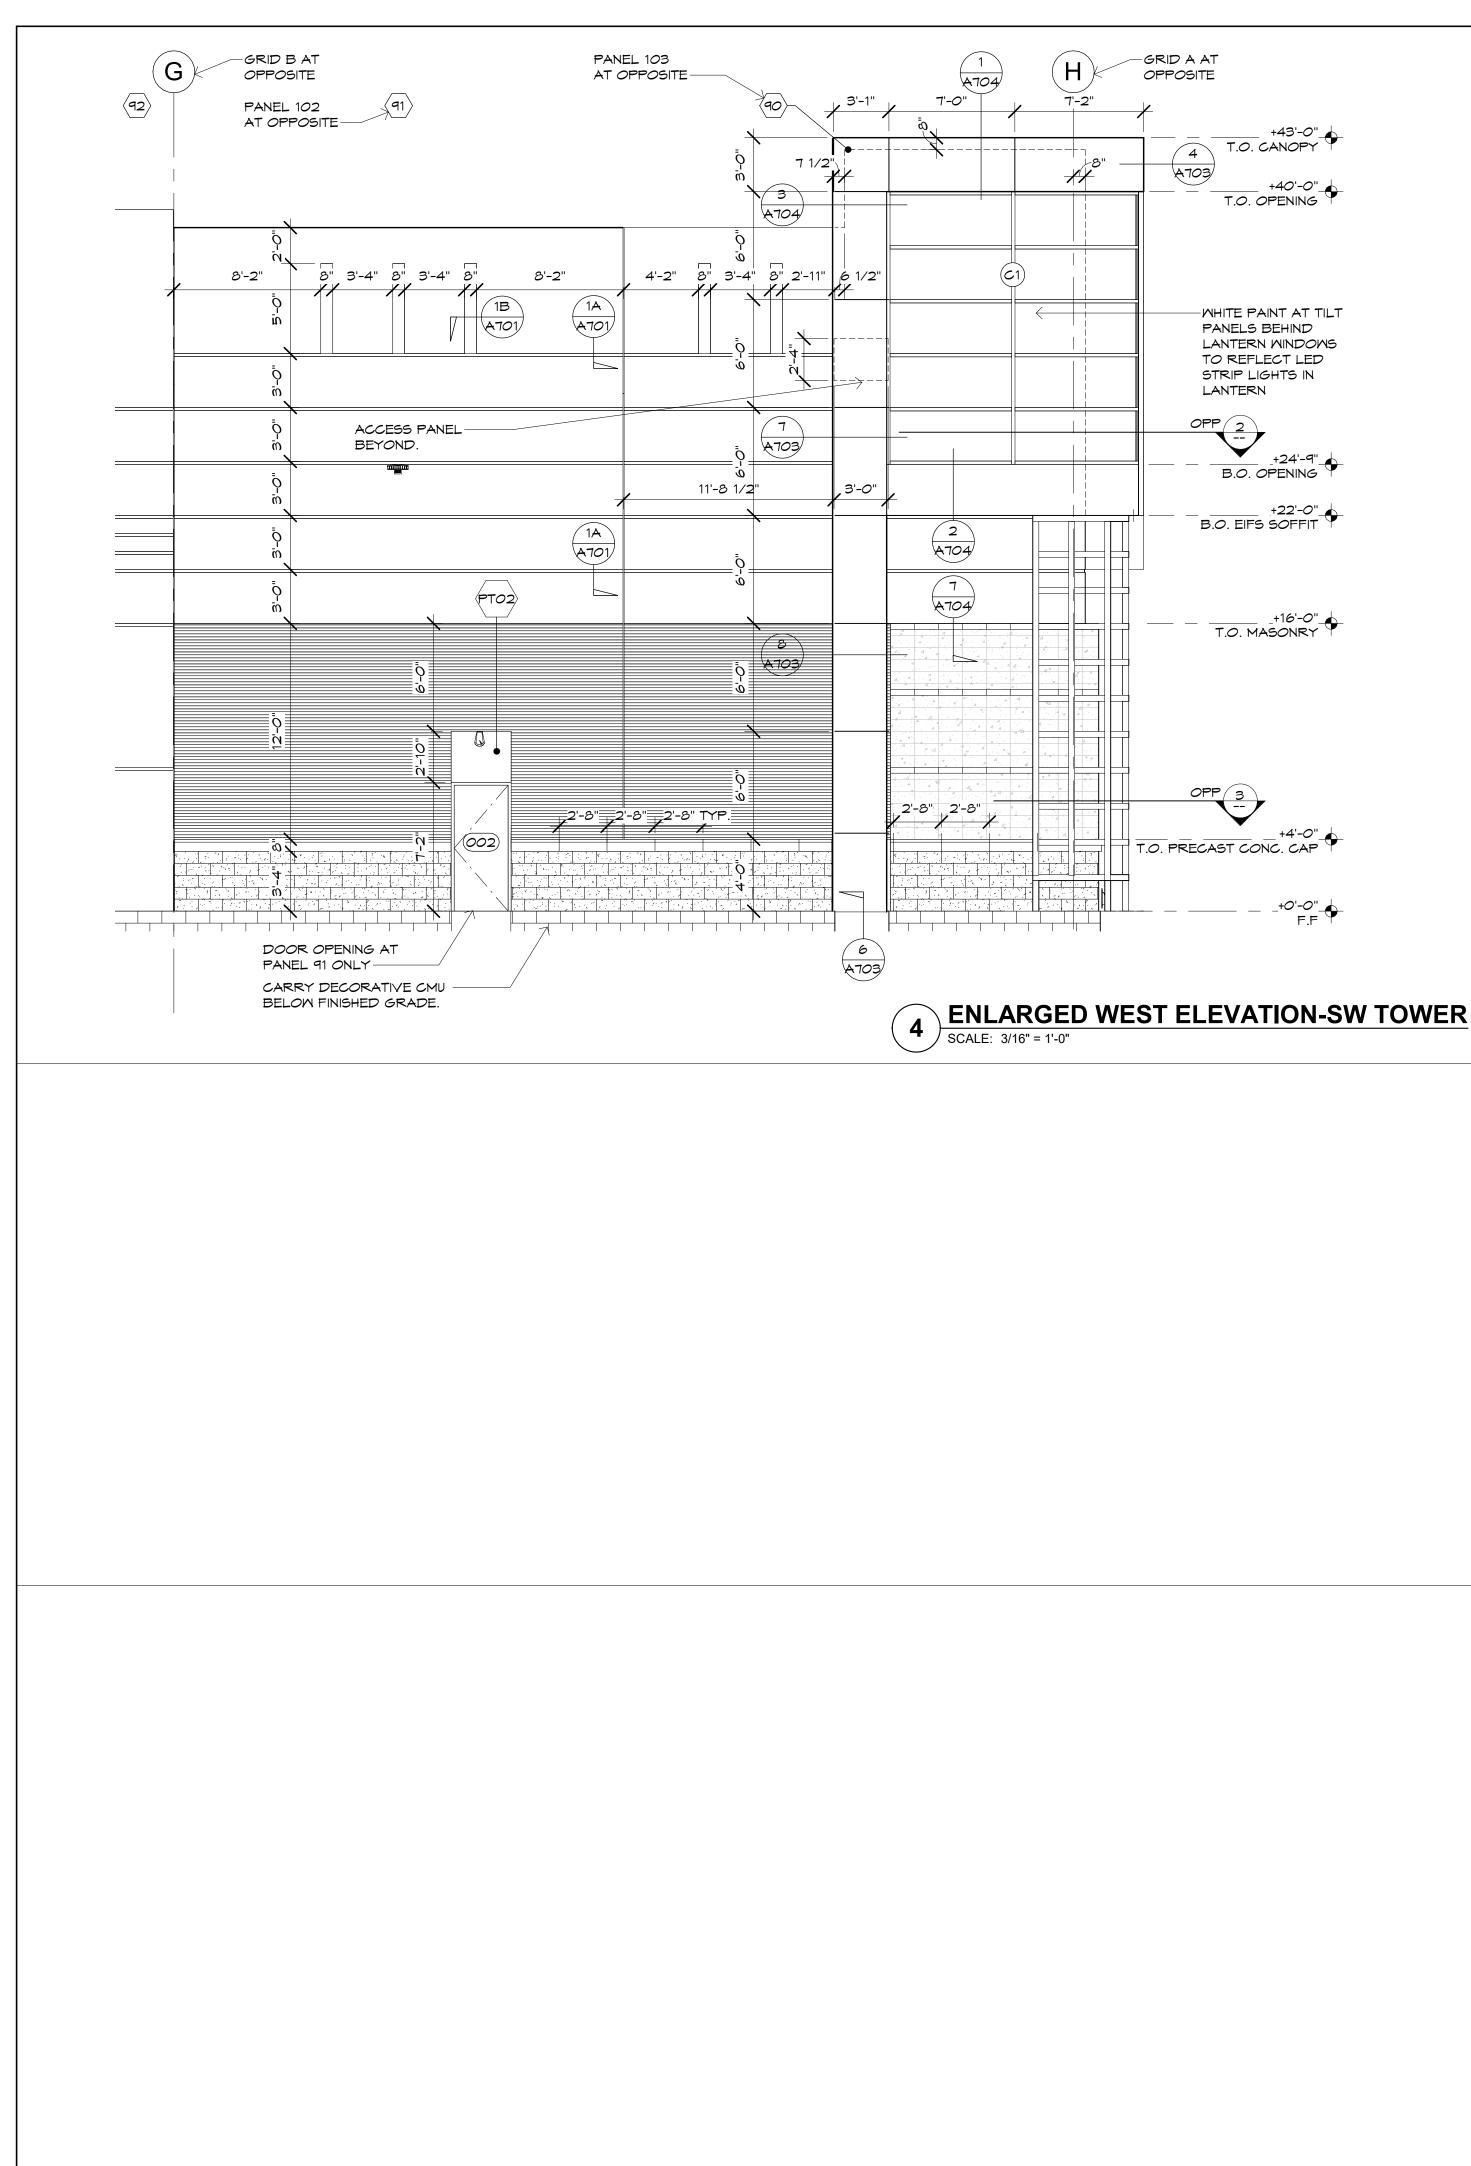

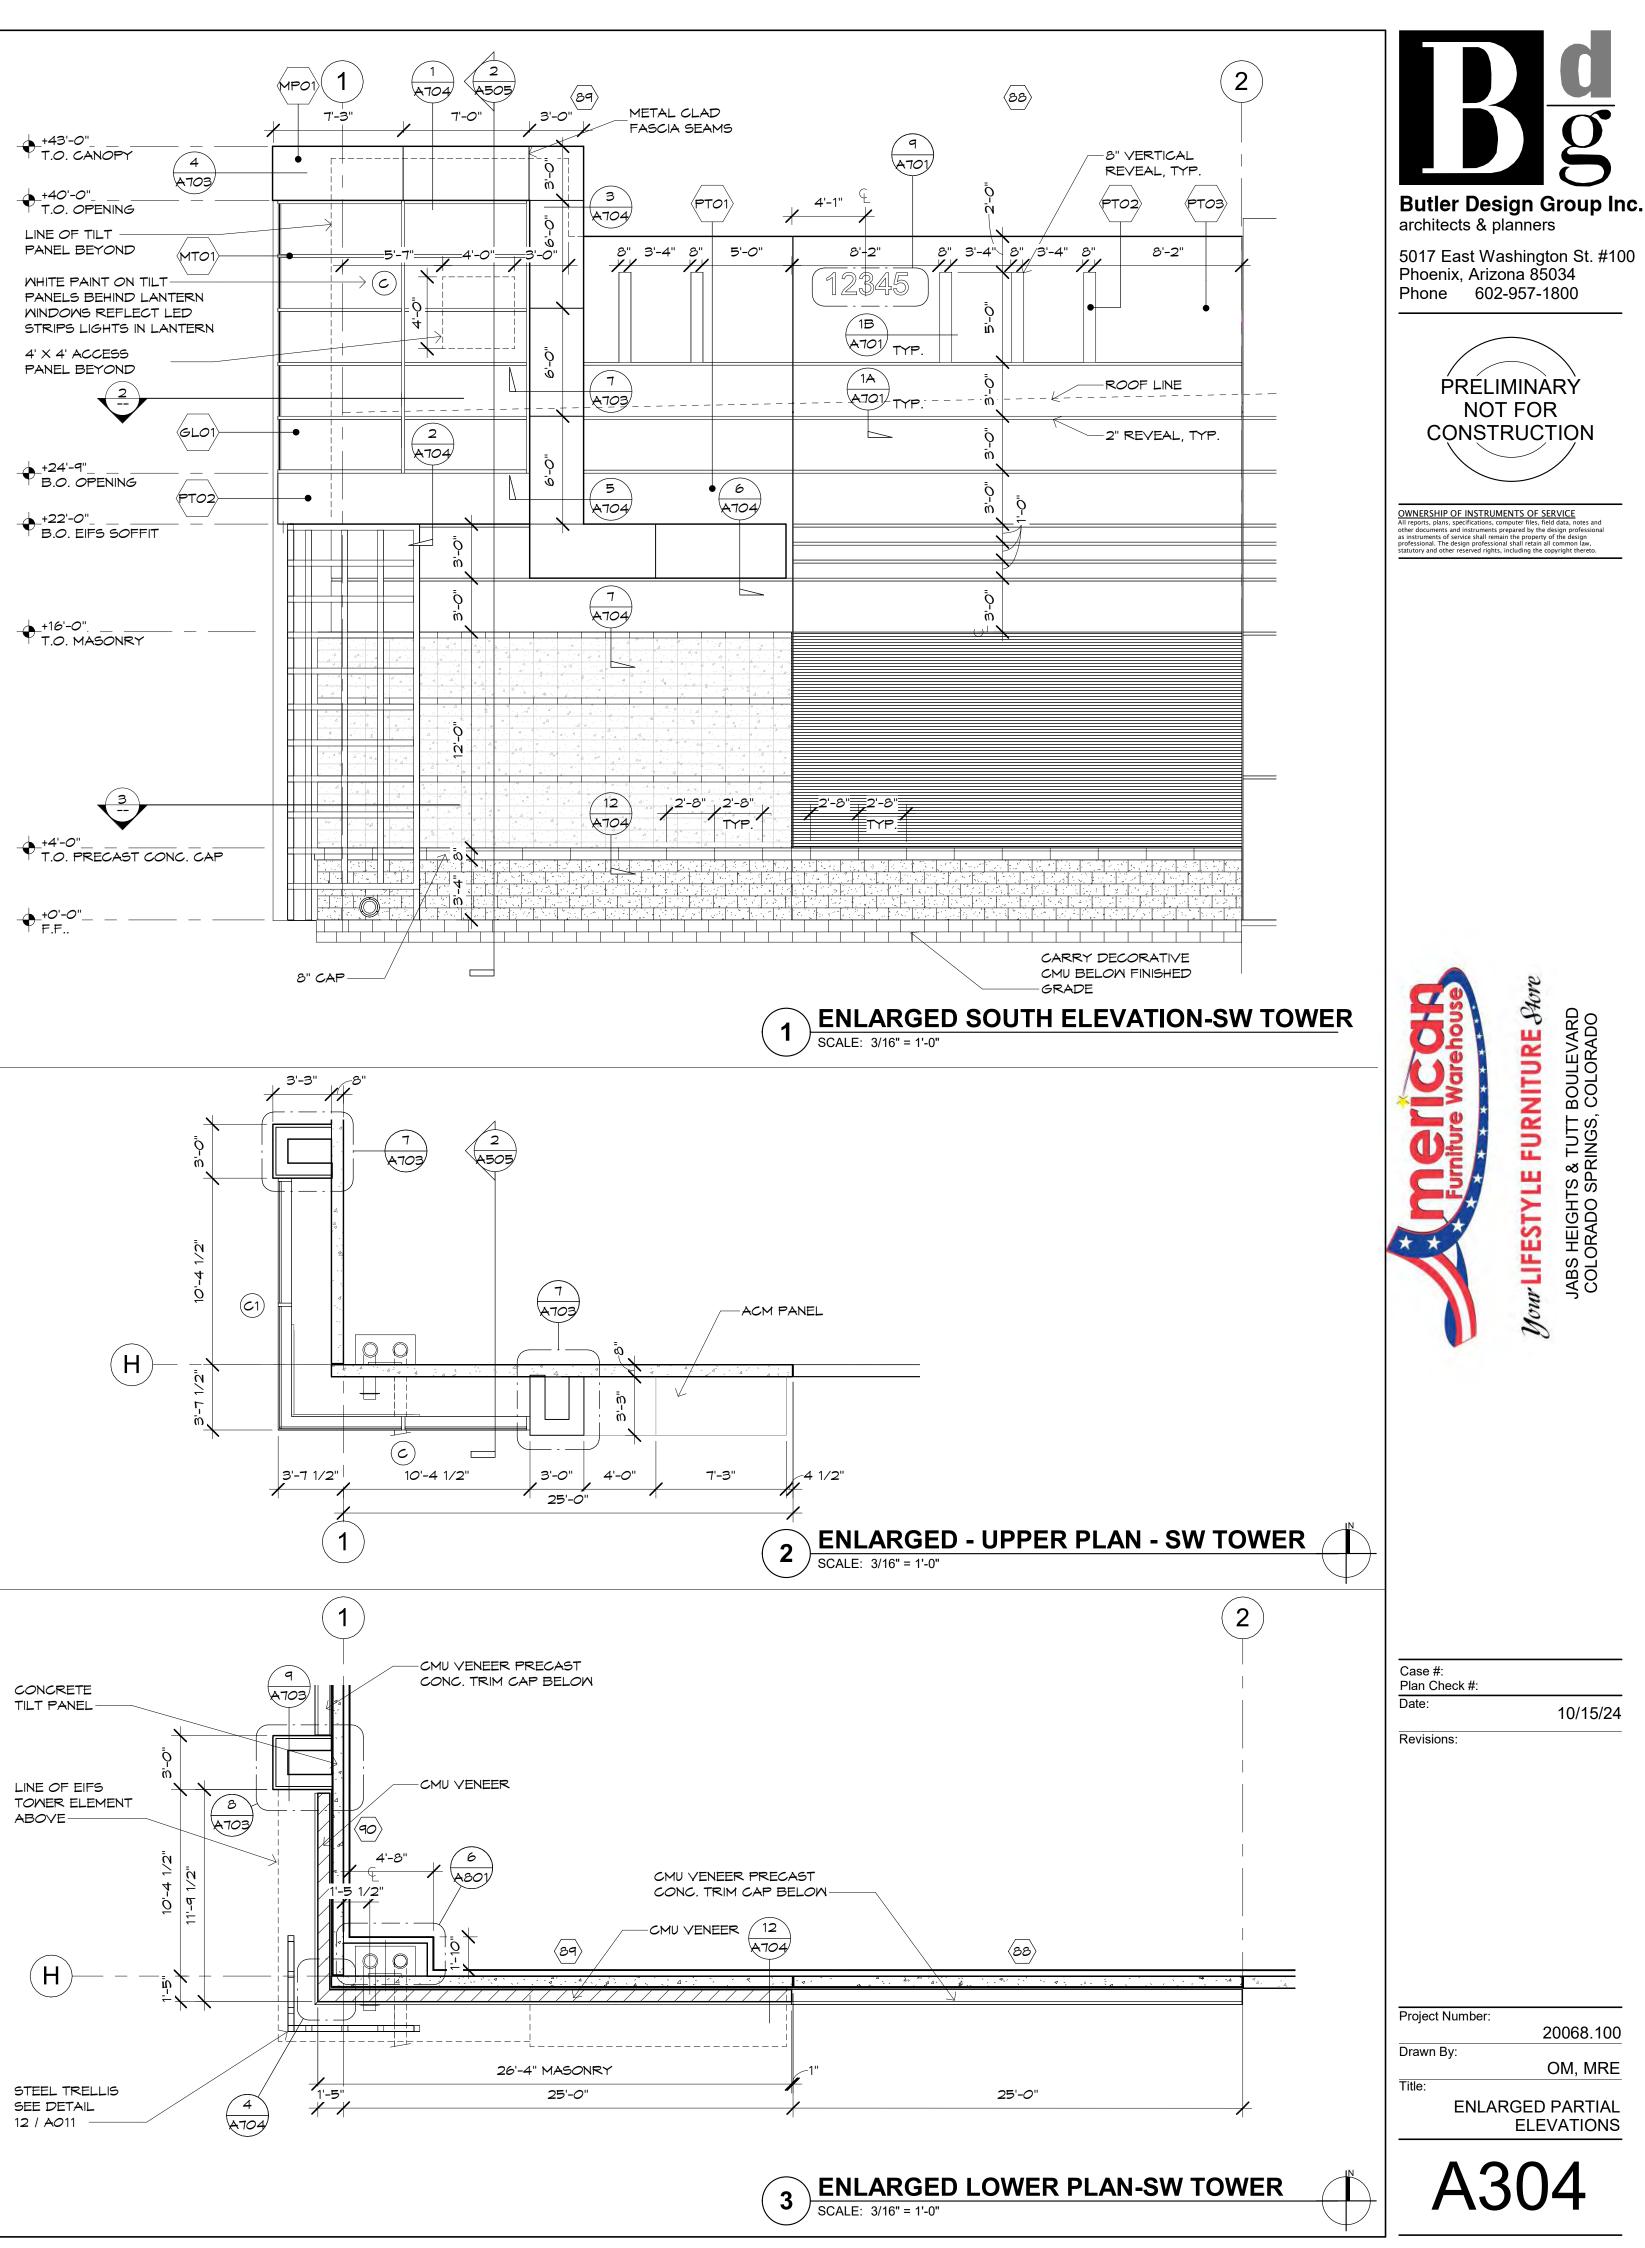

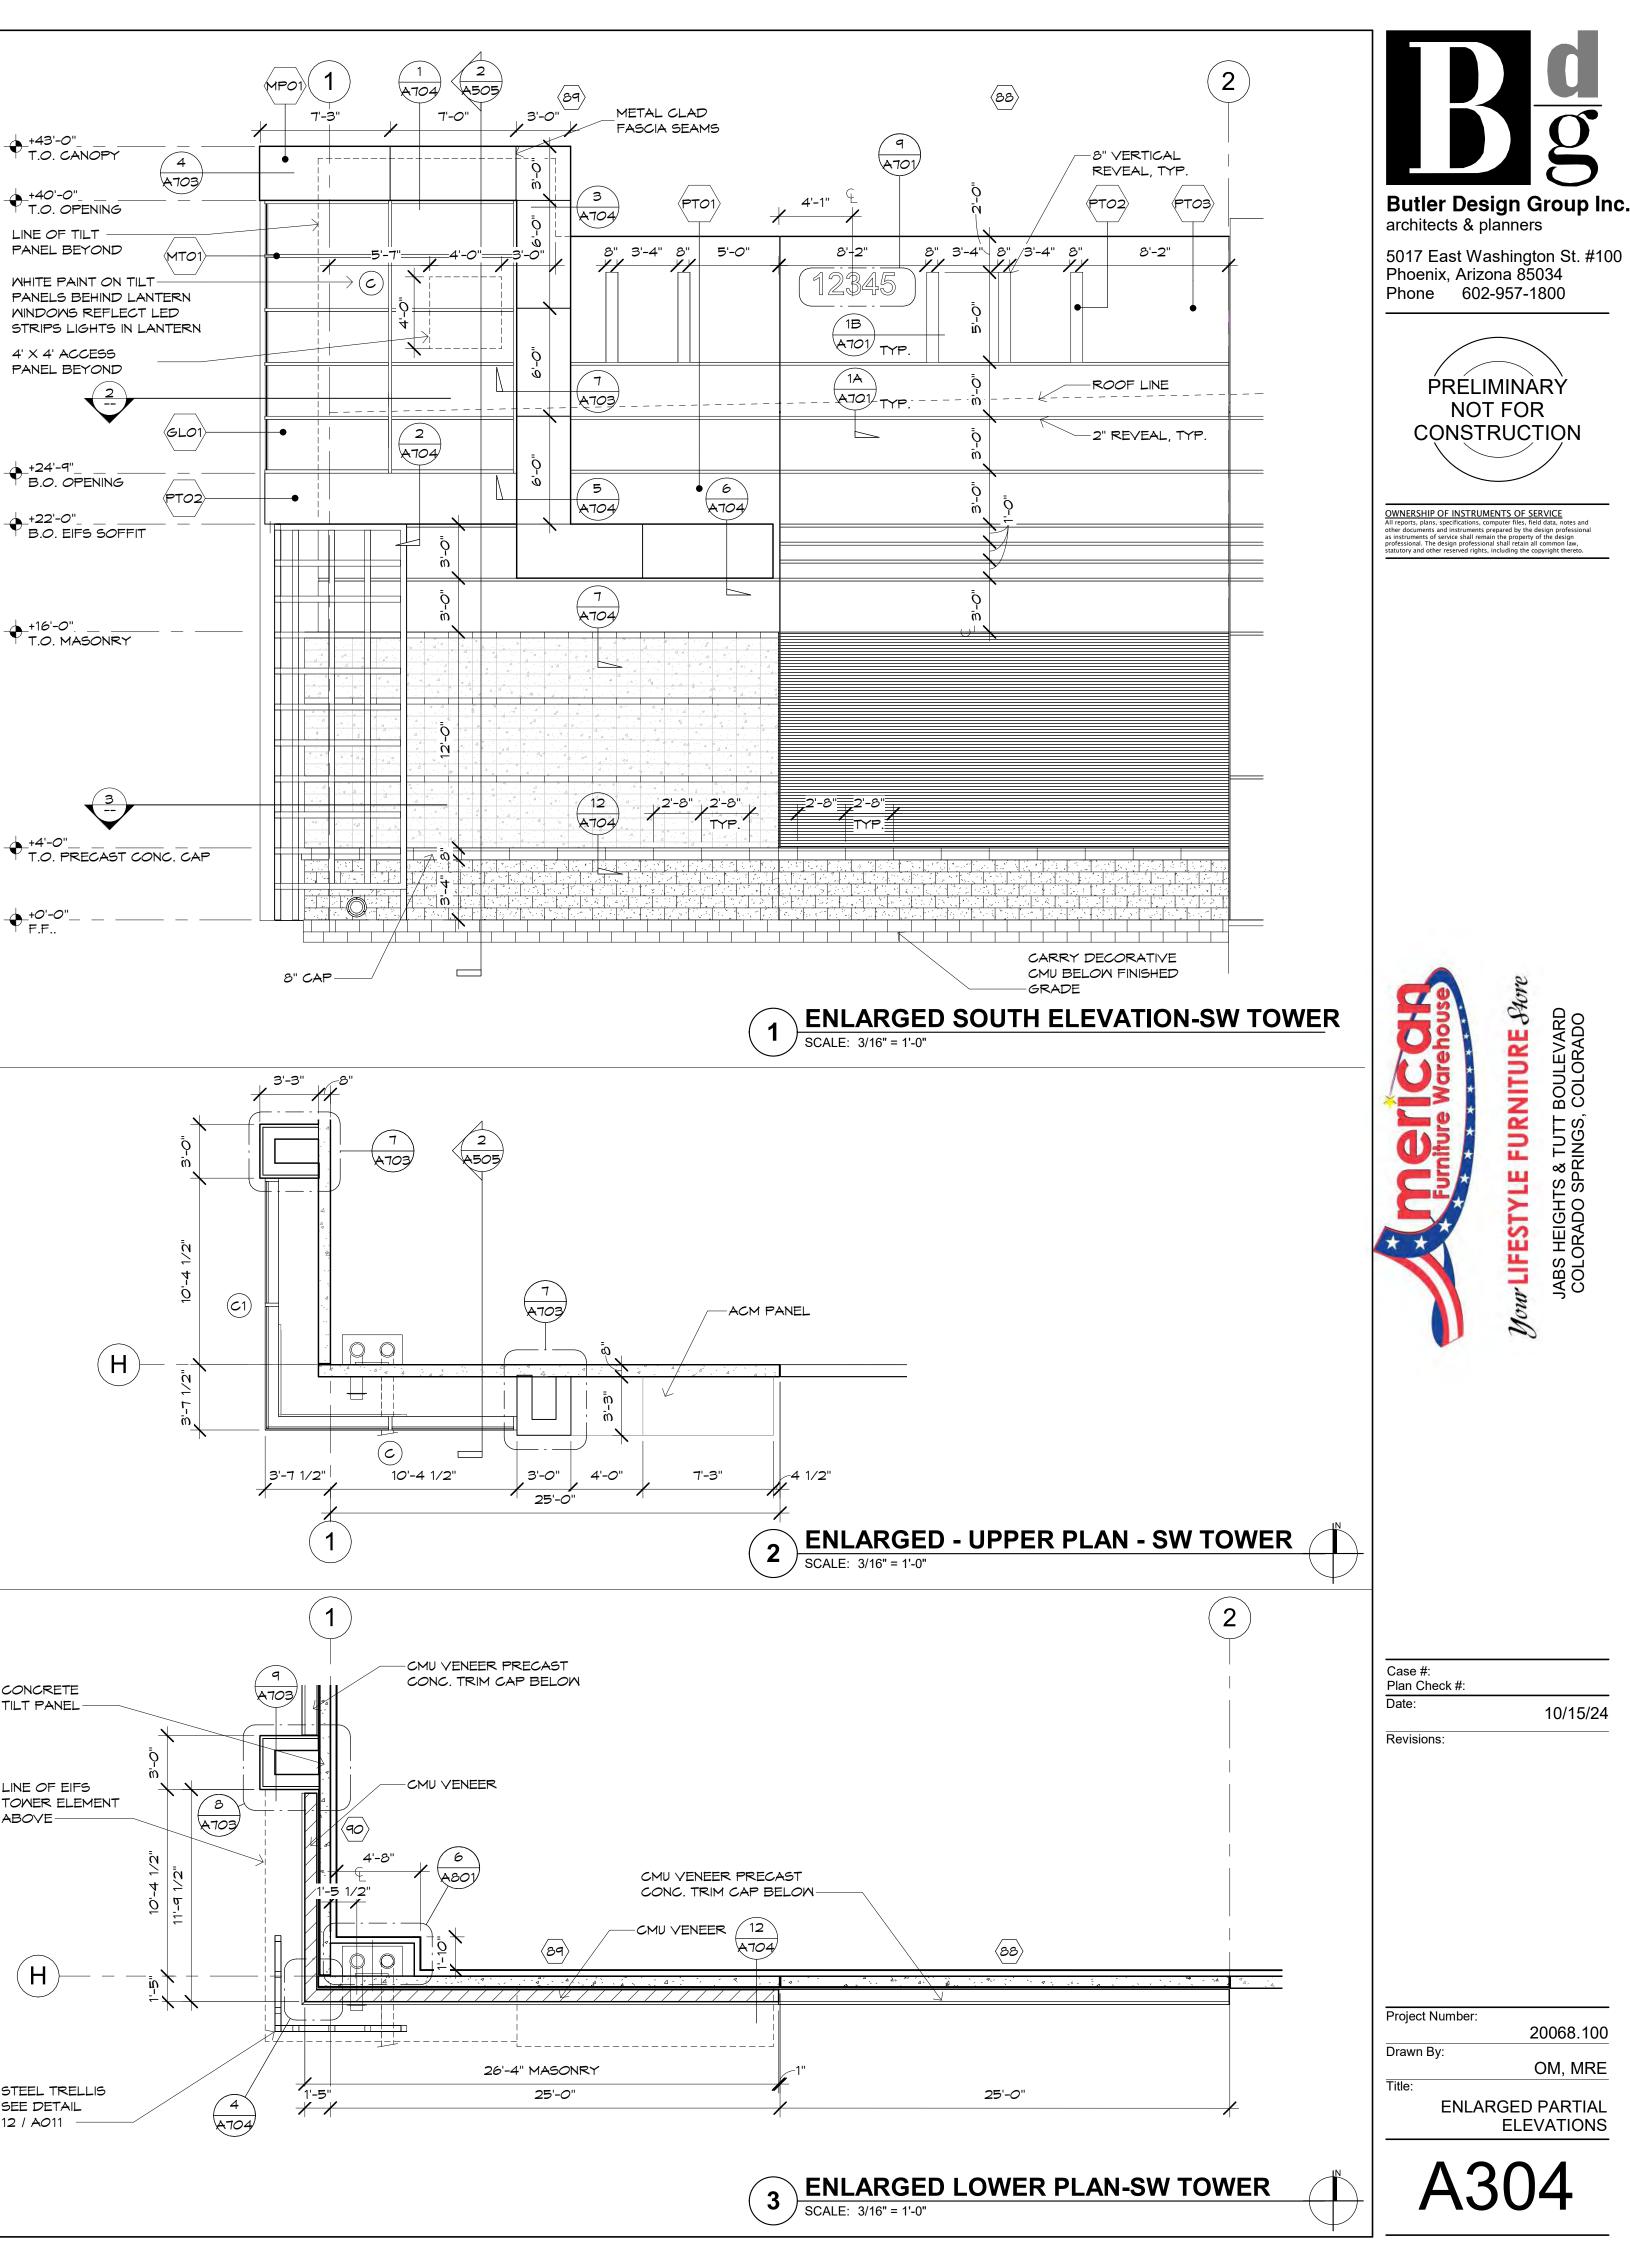


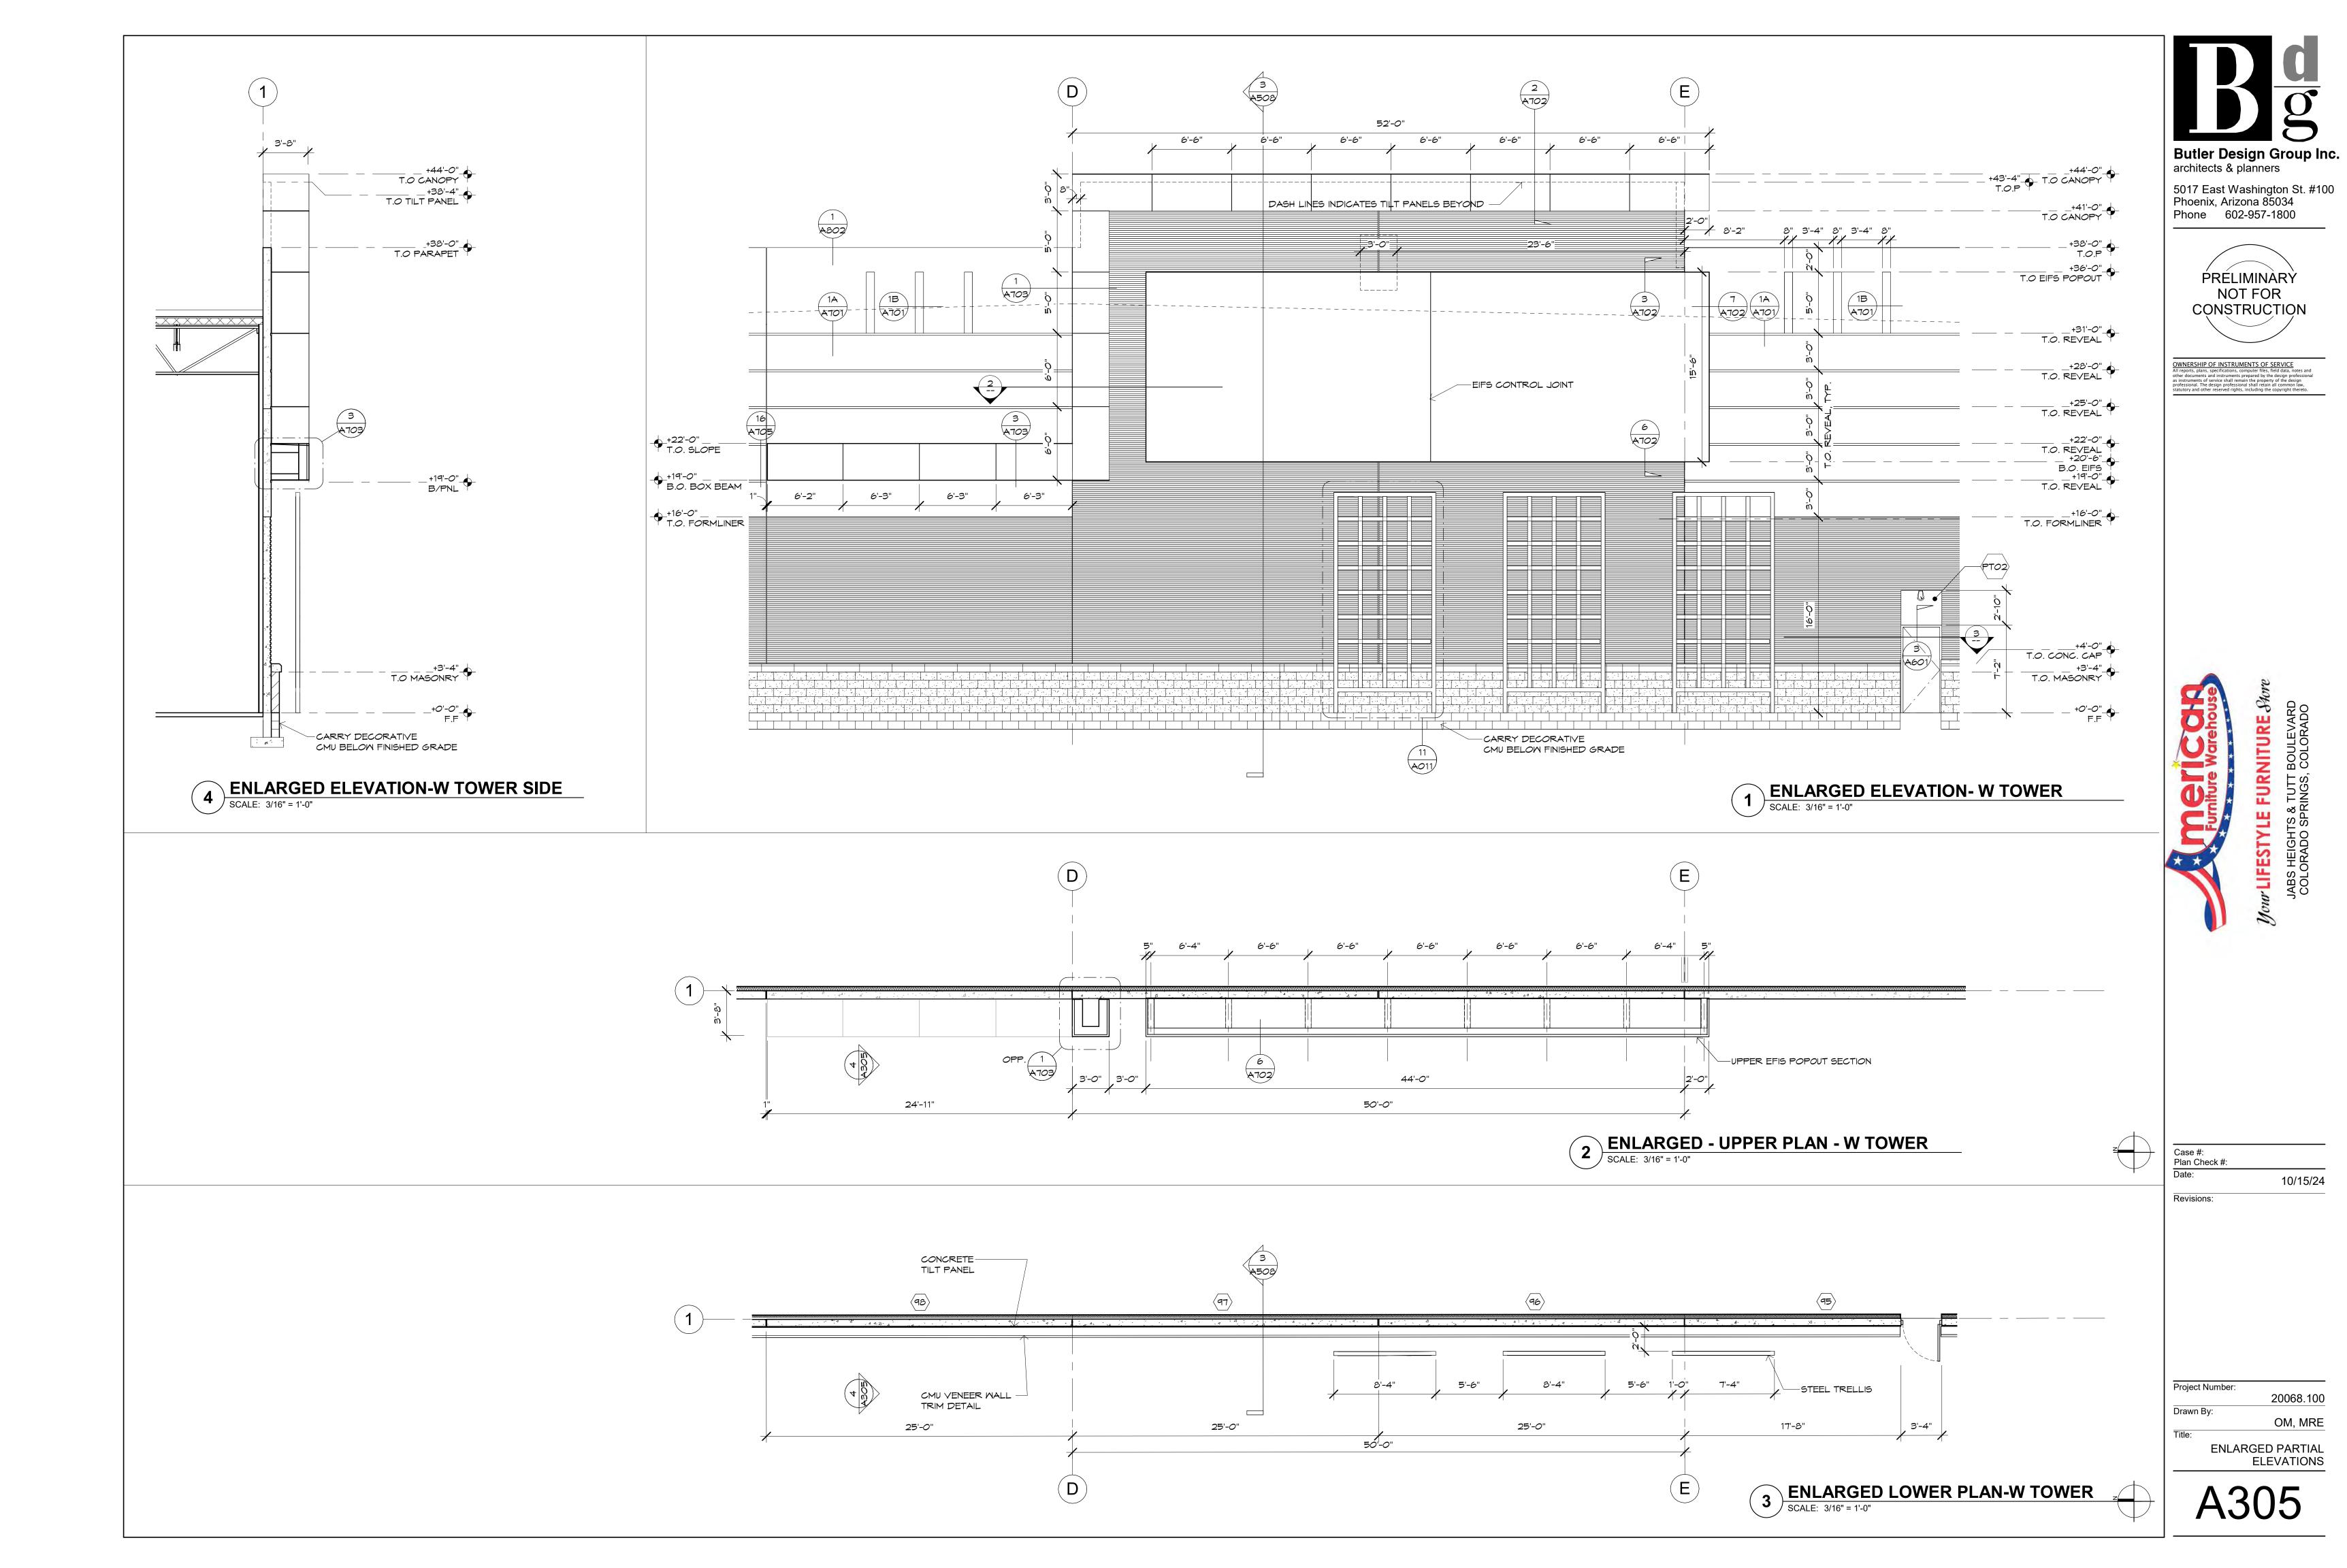


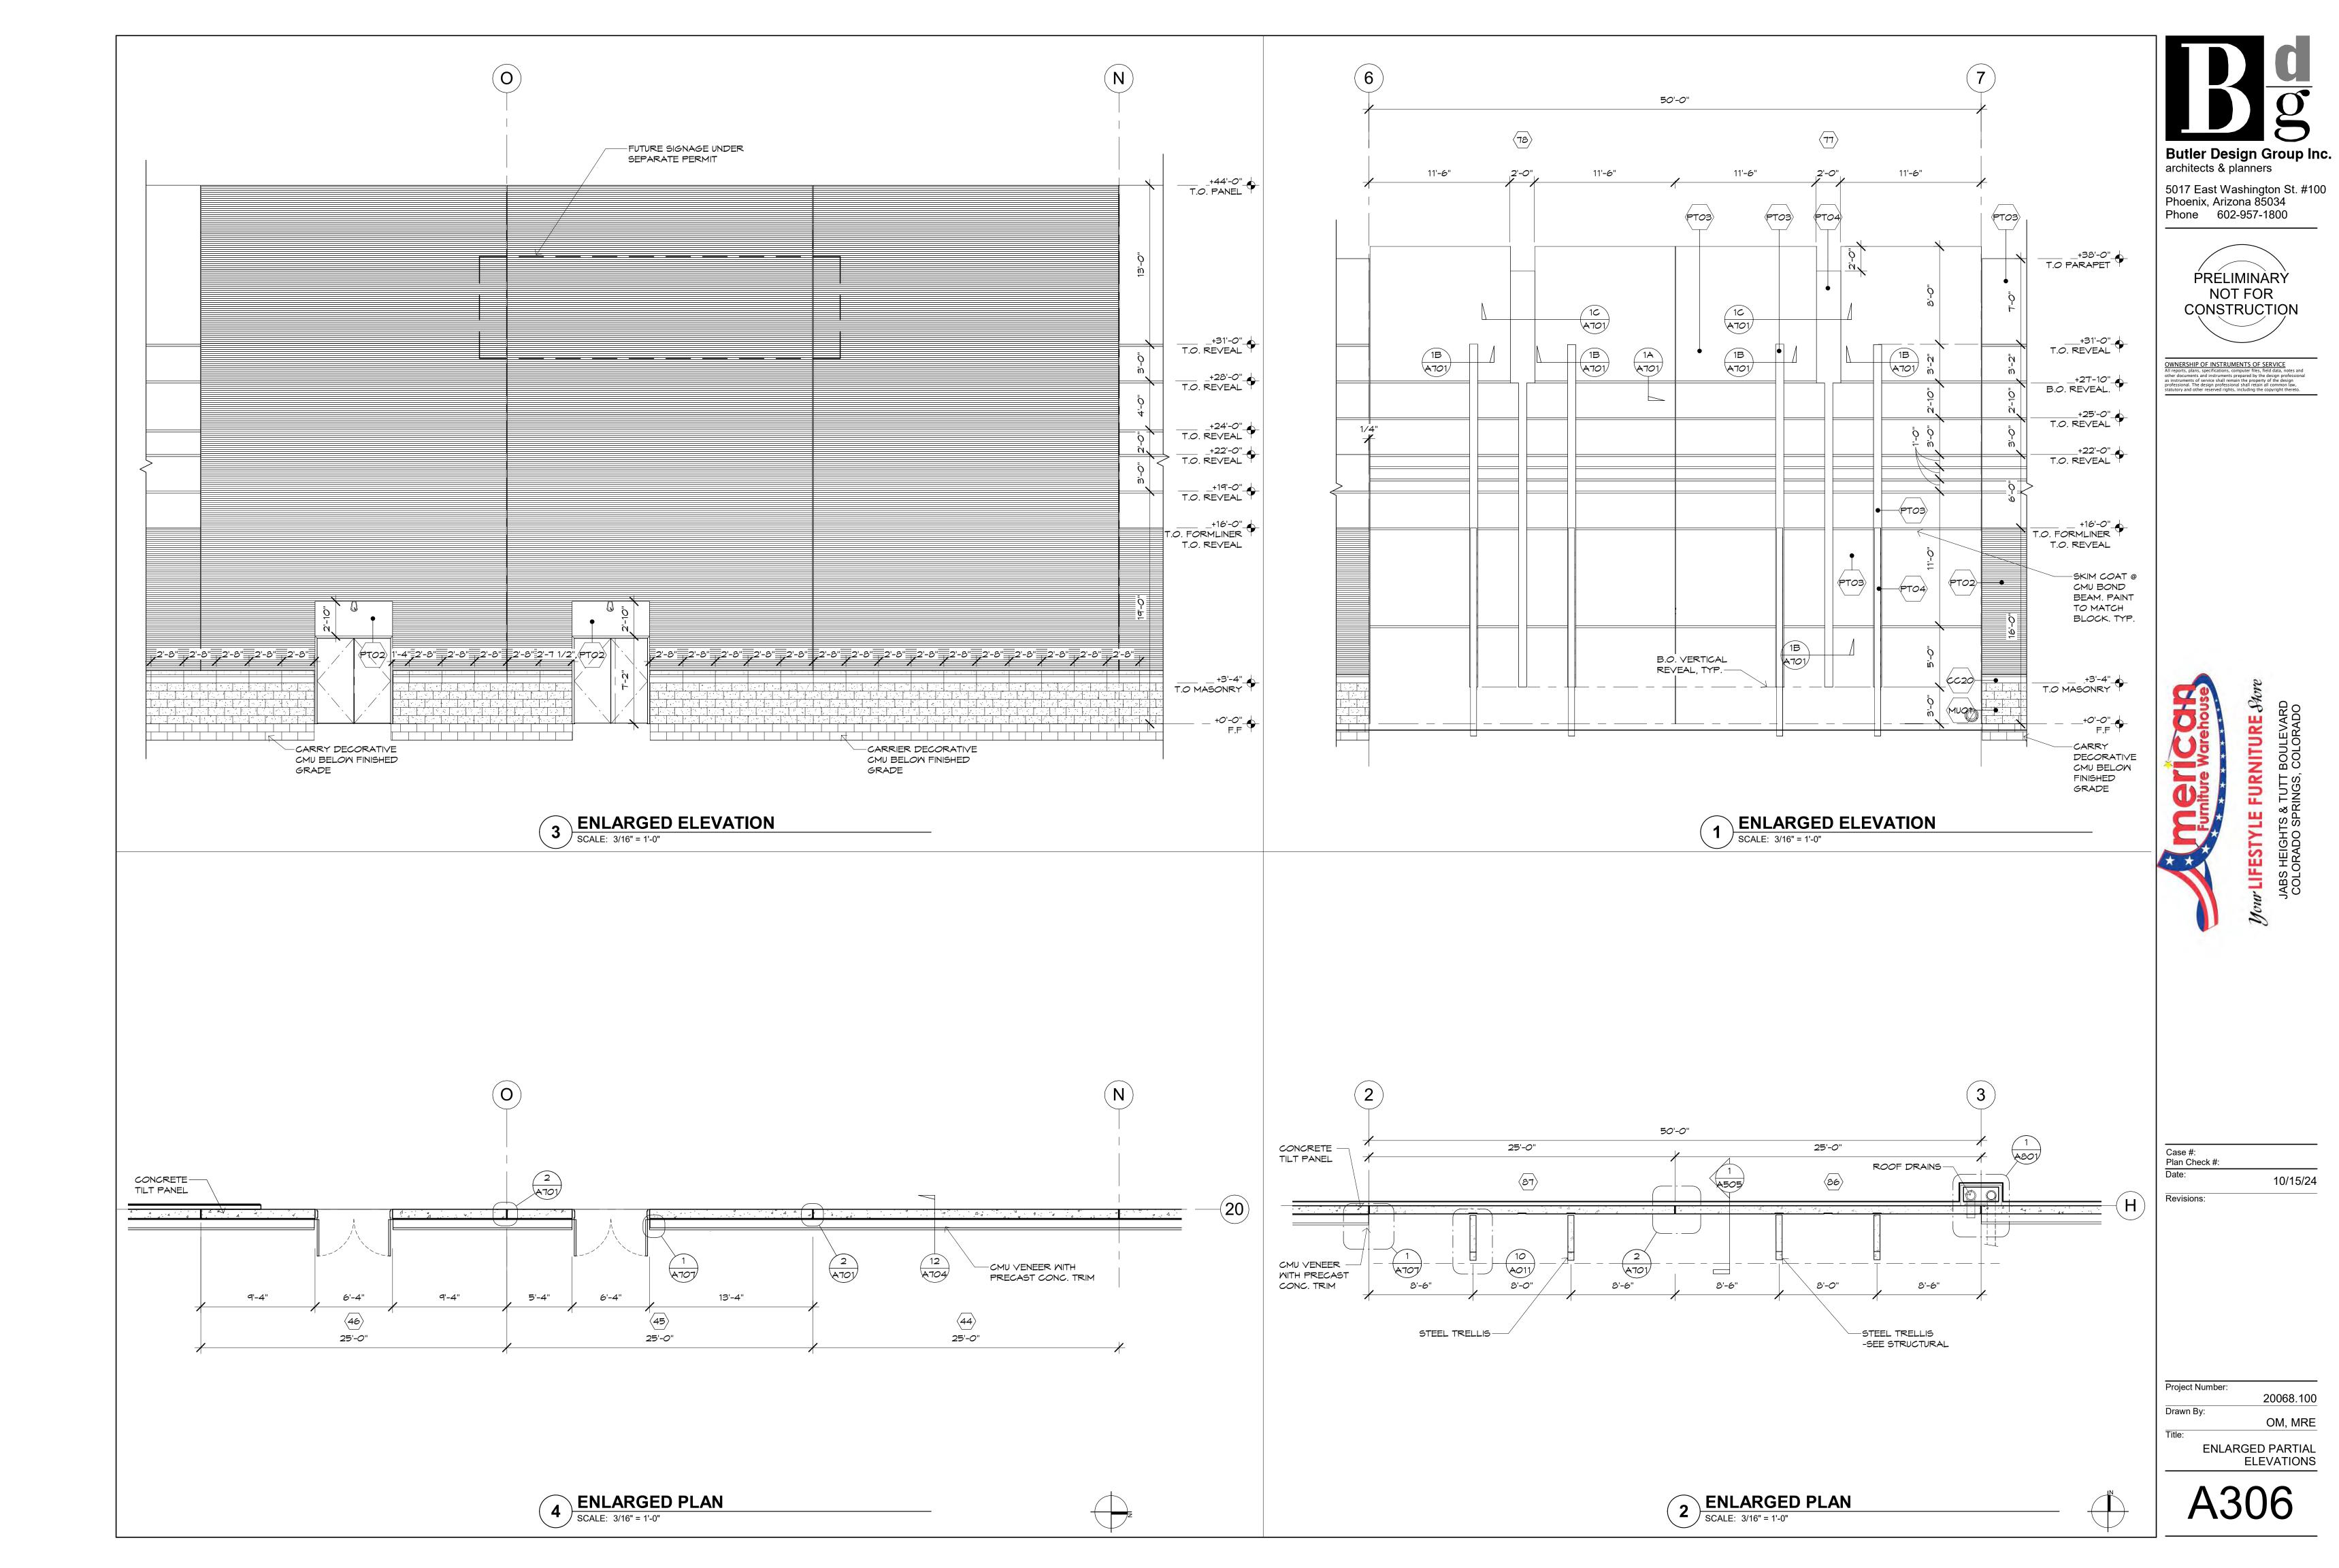


		L 4 4506
+48'-0" T.O. PARAPET	 <u>8'-2"</u> <u>8'</u> <u>3'-4"8</u> <u><u>8'</u><u>3'-4"8</u><u>8'</u><u>8'-2"</u></u>	5'-8" 8" 3'-4" 8" 3'-4" 8"
+28'-0" T.O. REVEAL		3'-0" 2'-0" 4'-0" 3'-0" T.O. REVEAL, TYP.
+16'-0" T.O. FORMLINER		
+3'-4" B.O. MASONRY +0'-0" F. F.		

CONCRETE TILT-PANEL

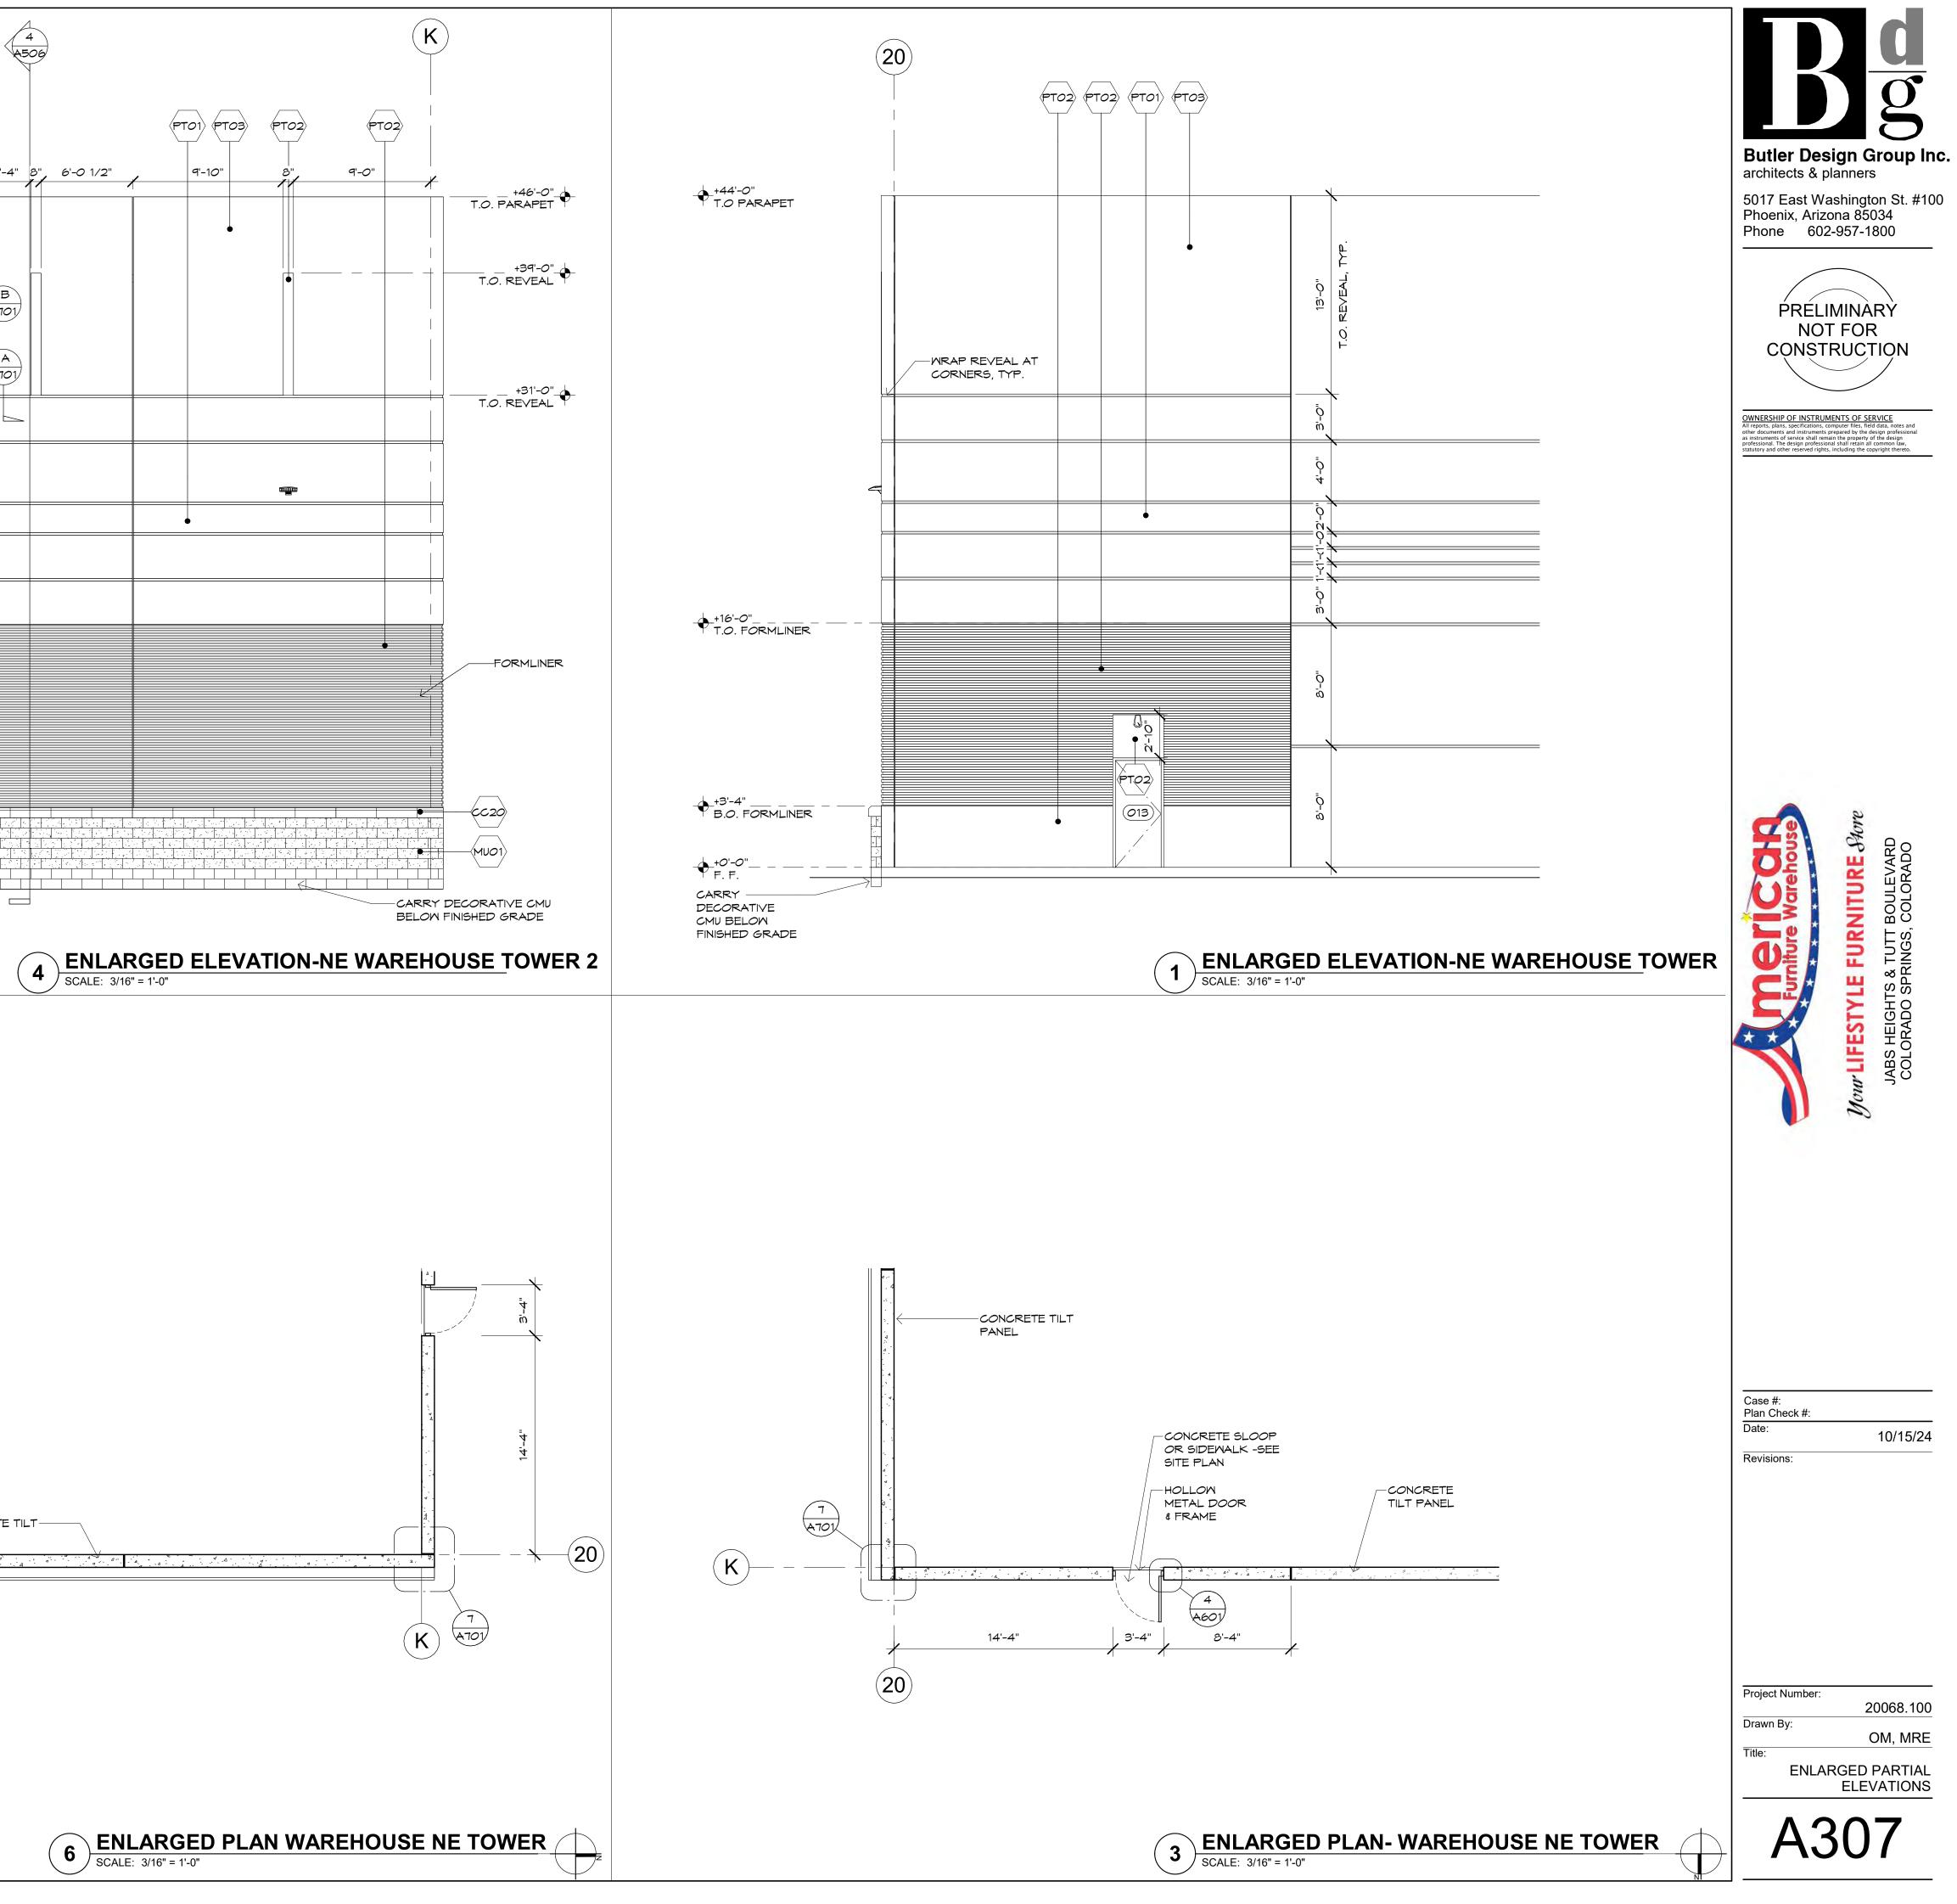

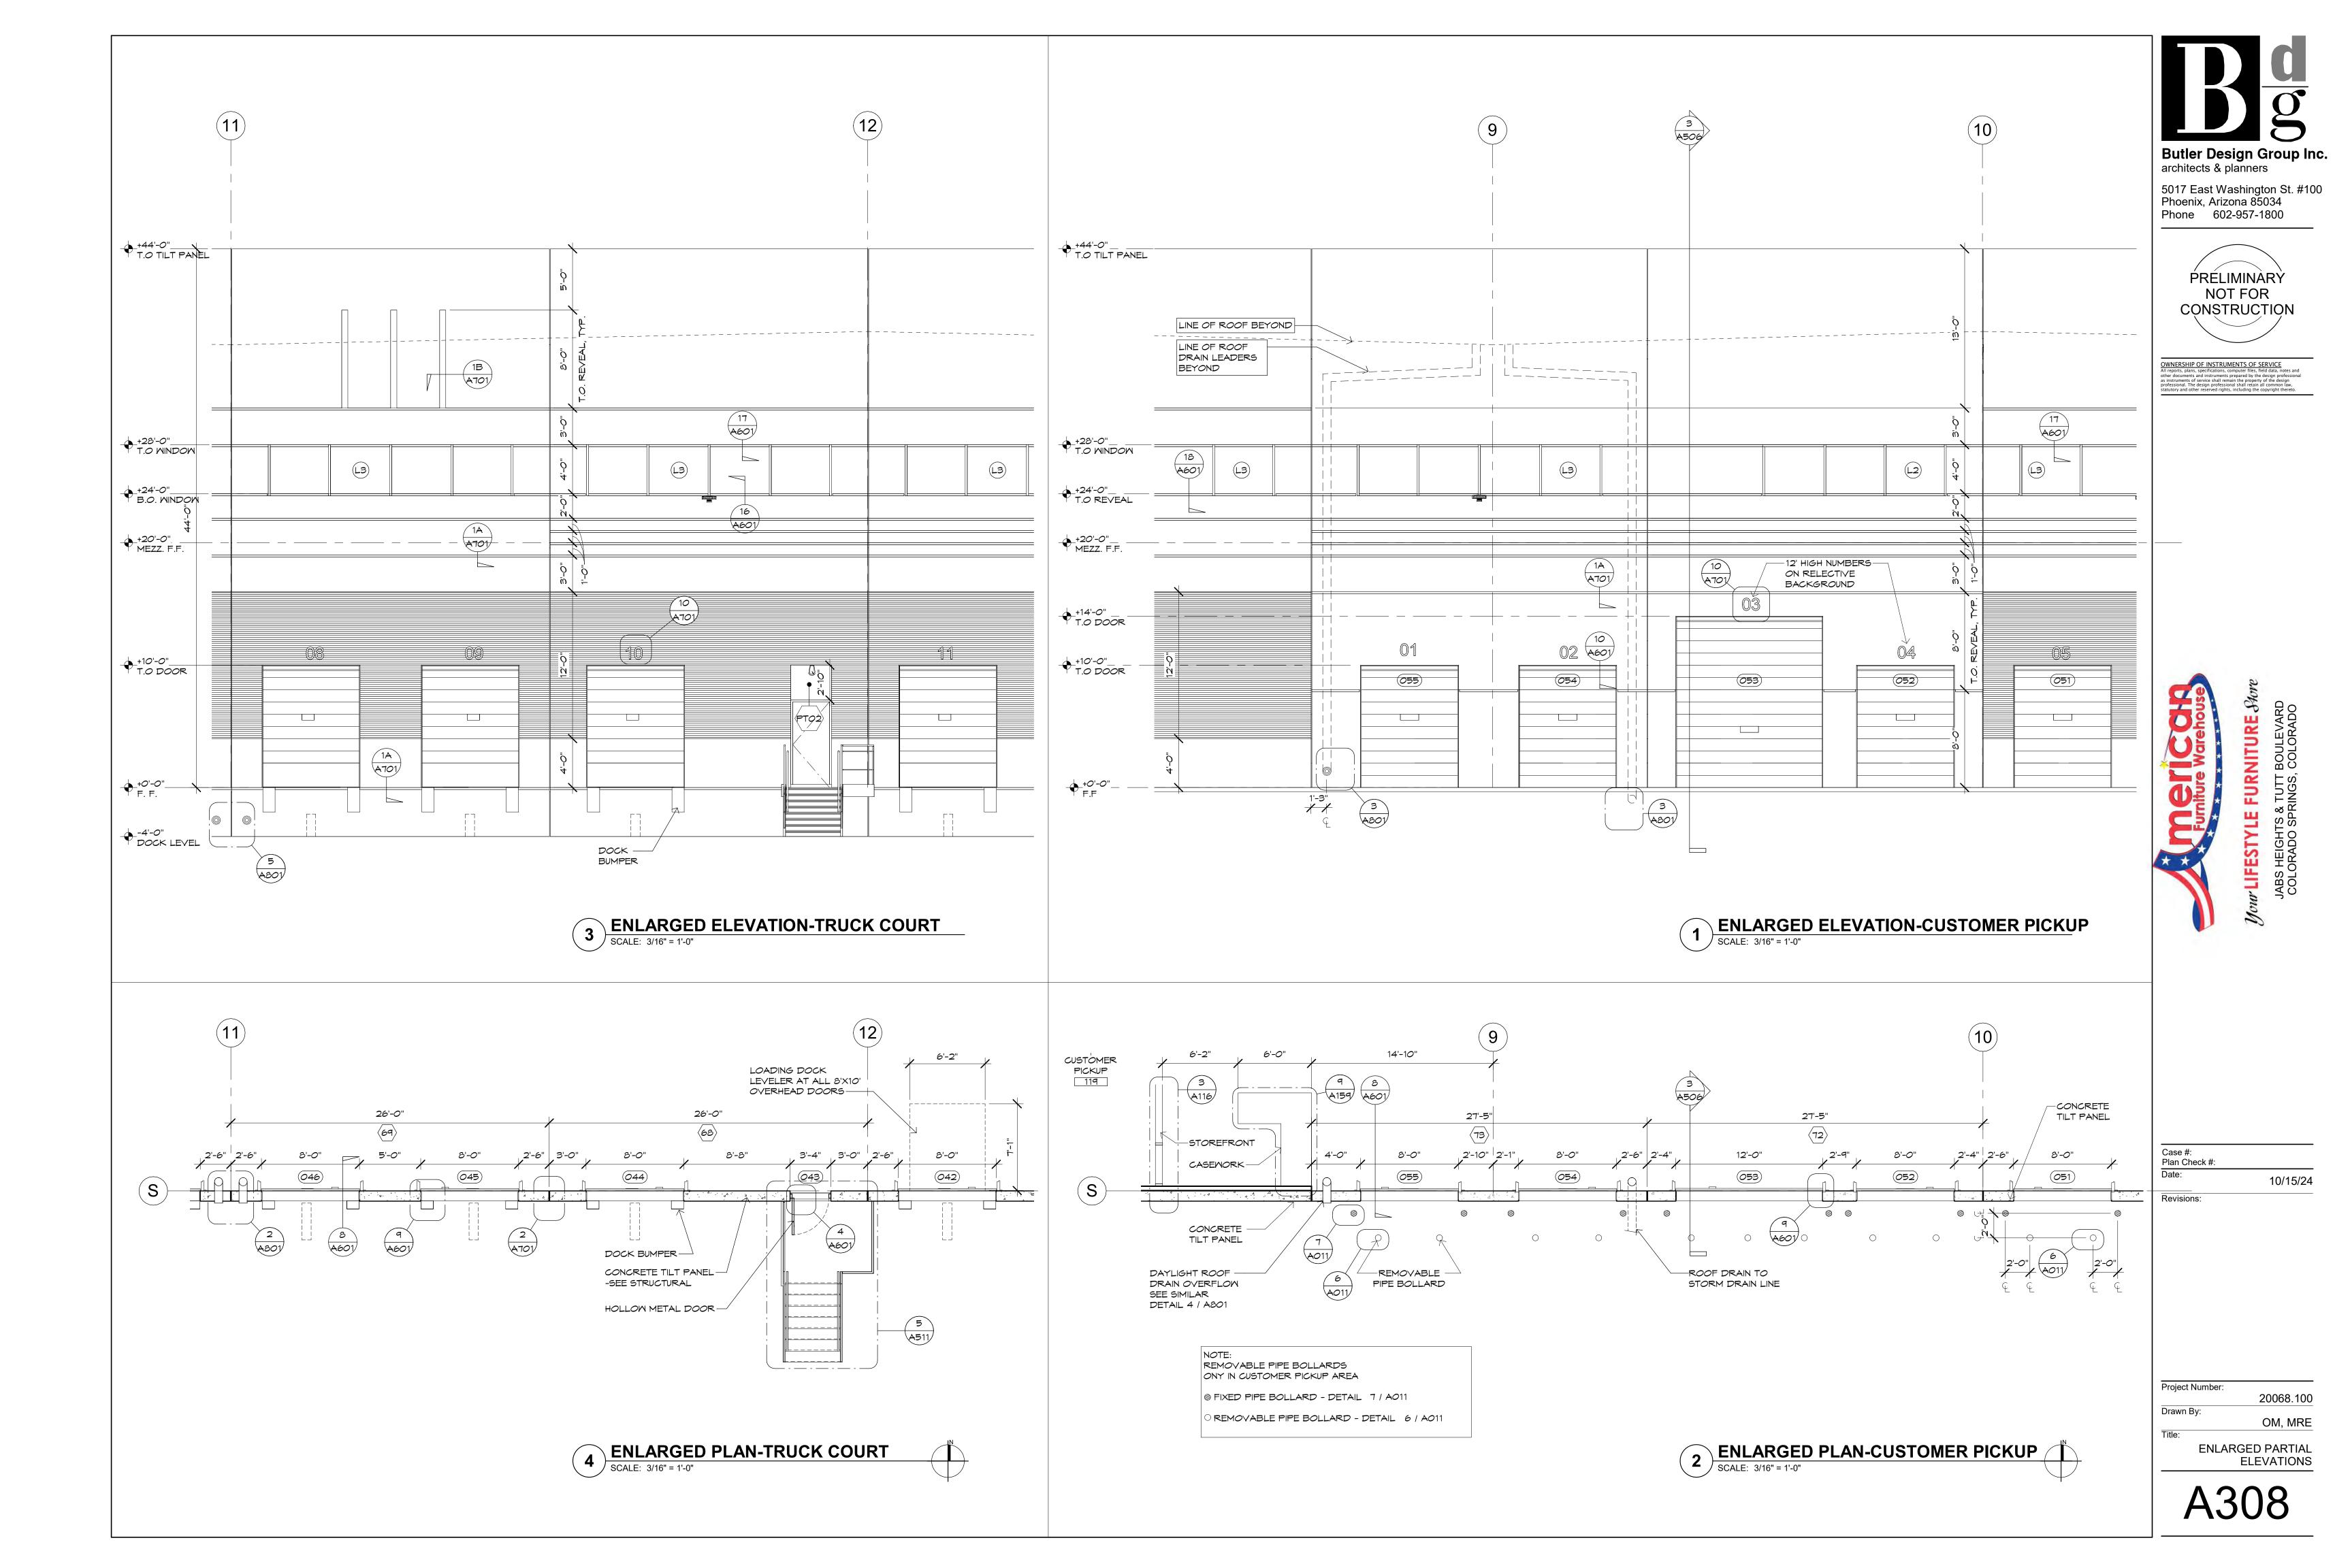

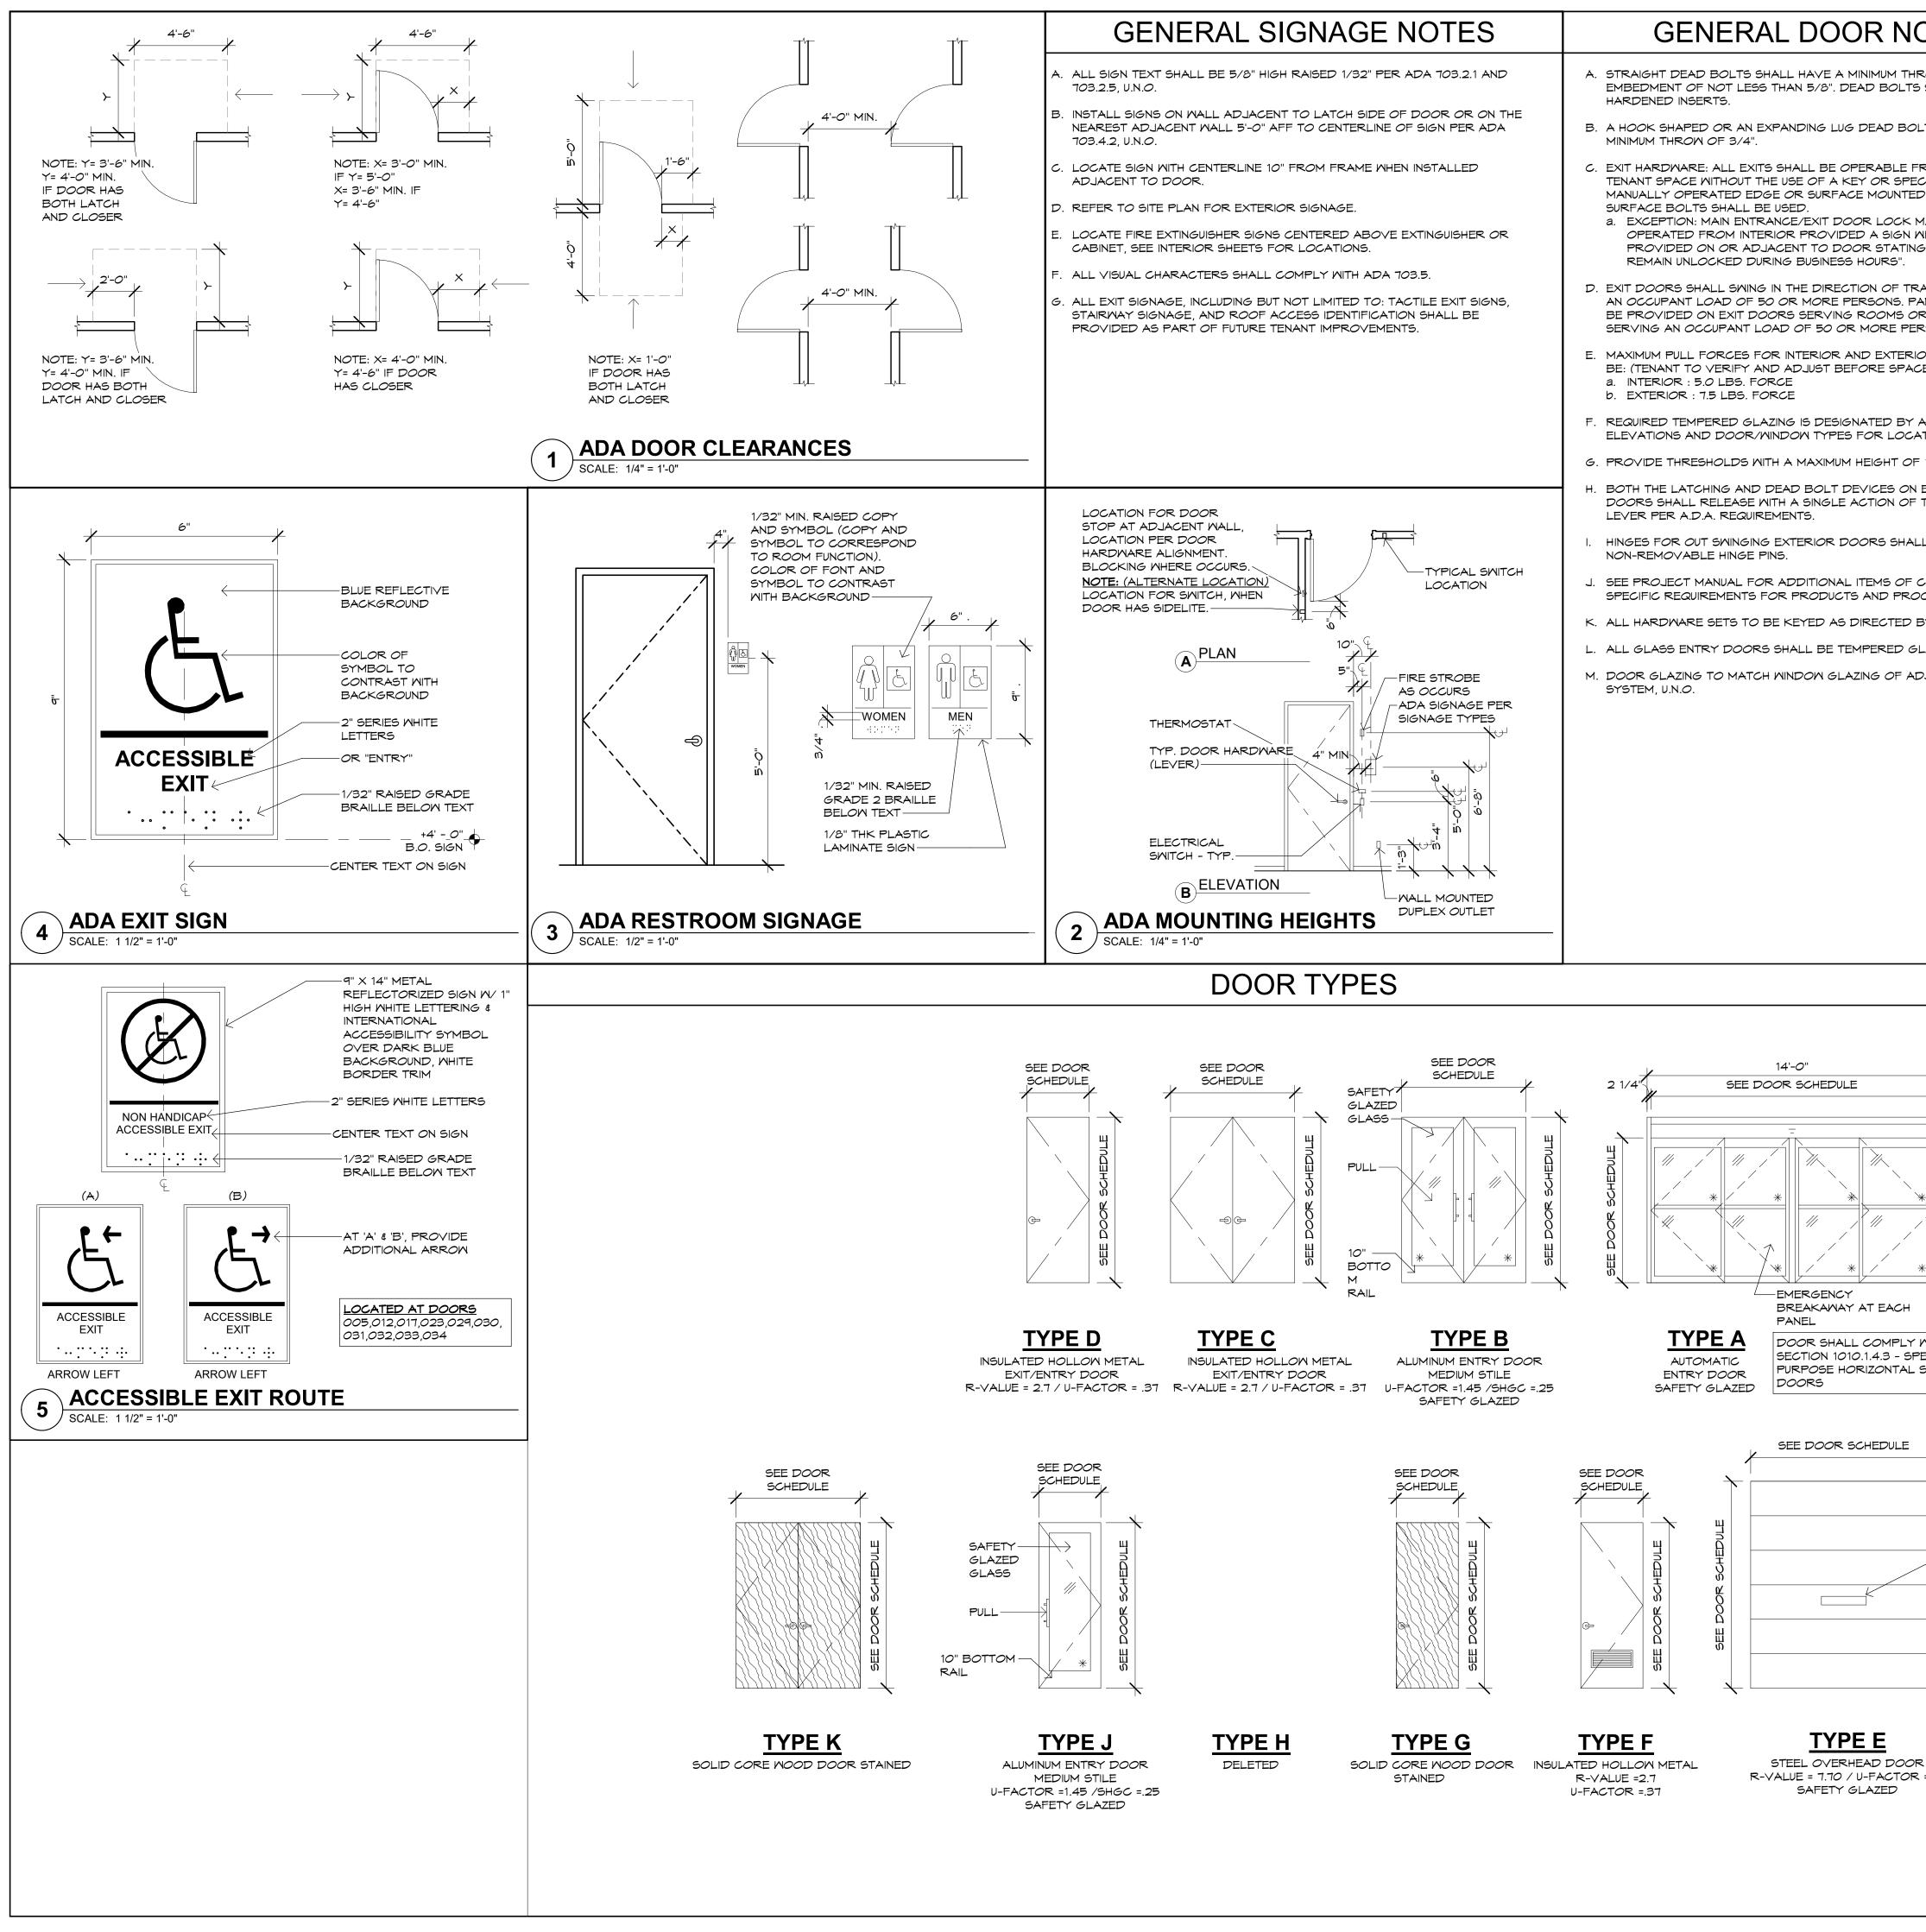

HROW OF 1" AND AN IS SHALL CONTAIN OLT SHALL HAVE A	<u>HARDWARE SET 1</u> 1 PR OFFSET PULL - SQ END RM2540 1 PR PUSH BAR - SQ END RM2512 (DOOR WIDTH) 2 SETS CONTINOUS HINGE 630	
OLT SHALL HAVE A		
	2 EA CYLINDERS 626 2 EA CONCEALED CLOSER 2 EA SILENCERS	_
FROM INTERIOR OF ECIAL KNOWLEDGE. NO ED FLUSH BOLTS OR	2 EA WEATHER SWEEP 1 EA THRESHOLD 1 EA SIGN "THIS DOOR TO REMAIN OPEN ETC"	Butler Design Group Inc. architects & planners 5017 East Washington St. #100
MAY BE KEY WITH 1" LETTERS BE NG "THIS DOOR TO	HARDWARE SET 2 1 EA EXIT DEVICE 99NL-R/V01-3 US26 4 EA 4.5 X 4.5 BUTTS 626 1 SET SILENCERS	Phoenix, Arizona 85034 Phone 602-957-1800
RAVEL WHEN SERVING PANIC HARDWARE SHALL OR CORRIDORS ERSONS.	1 EA WEATHER STRIPING KIT 1 EA THRESHOLD 1 EA SURFACE MOUNT CLOSURE 1 EA DRIP EDGE AT EXTERIOR DOORS	PRELIMINARY
CIOR EXIT DOORS SHALL	HARDWARE SET 3	NOT FOR CONSTRUCTION
´ A " * ". SEE	1EAEXIT DEVICE 9927NL-01-F-3 US264EA4.5 X 4.5 BUTTS 6261SETSILENCERS	OWNERSHIP OF INSTRUMENTS OF SERVICE
ATIONS. F 1/2" PER A.D.A.	1 EA SURFACE MOUNT CLOSER 1 EA CONCELAED THROM @ INACTIVE LEAF 1 EA SURFACE LATCH GUARD	All reports, plans, specifications, computer files, field data, notes and other documents and instruments prepared by the design professional as instruments of service shall remain the property of the design professional. The design professional shall retain all common law, statutory and other reserved rights, including the copyright thereto.
N EXTERIOR EXIT	1 EA WEATHER STRIPING KIT 1 EA THRESHOLD	
THE INSIDE KNOB OR	HARDWARE SET 5	
LL BE EQUIPPED WITH	<u>HARDWARE SET 6</u> 2 EA CYLINDERS 626 (SIM CONDITION PROVIDE ONE CYLINDER)	
COORDINATION AND OCEDURES.	1 EA SIGN "THIS DOOR TO REMAIN OPEN ETC"	
BY OWNER.	HARDWARE SET 7 1 EA PADLOCK @ ALL OVERHD DOORS	
SLAZING.	<u>HARDWARE SET 8</u> 1 EA K937L16KSTK626 4 EA 4.5 X 4.5 BUTTS 626	
	1 EA HESS 1006 1224D 630 J630 12VOLT ELECTRIC STRIKE (AT BIOSCAN LOCATIONS) 1 SET SILENCERS	
	1 EA WALL BUMPER 1 EA SURFACE MOUNT CLOSER	
	HARDWARE SET 9 1 EA K930N16KSTK 626	
	4 EA 4.5 X 4.5 BUTTS 626 1 SET SILENCERS 1 EA WALL BUMPER 1 EA SUBERCE MOUNT CLOSURE	<i>a</i>
	1 EA SURFACE MOUNT CLOSURE <u>HARDWARE SET 10</u>	
	1 EA K937D16KSTK 626 4 EA 4.5 X 4.5 BUTTS 626 1 SET SILENCERS	NITURE & BOULEVARD
	1 EA SURFACE MOUNT CLOSER 1 EA WALL BUMPER	
	1 EA THRESHOLD 1 EA HESS 1006 1224D 630/J630 12 VOLT (AT BIOSCAN LOCATIONS)	<b>FURNITURE</b> <i>More</i> INGS, COLORADO
#	HARDWARE SET 11 1 EA PUSH	VILFESTYLE FUR
	1 EA PULL 1 EA SURFACE MOUNT CLOSER	
	1 EA THRESHOLD 1 EA WALL BUMPER 1 EA SS KICKPLATES EACH SIDE	
2 1/4"	1 EA SIGN ADA RESTROOM (AT RESTROOMS ONLY) HARDWARE SET 12	Jone L JAB CO
	1 EA K937D165TK 626 4 EA 4.5X4.5 BUTTS 626	l l
	1 EA SILENCER 1 EA SURFACE MOUNTED CLOSER 626 1 EA WALL BUMPER 626	
*	1 EA THRESHOLD 1 EA HESS 10061224D 630 J630 12 VOLT ELECTRIC STRIKE	
	HARDWARE SET 13	
*	1 EA K9927-L-01-F-23 US 26 4 EA 4.5X4.5 BUTTS 626	
	1 EA SILENCER 1 EA SURFACE MOUNTED CLOSER 626 1 EA WALL BUMPER 626	
Y WITH IBC PECIAL	1 EA THRESHOLD 1 EA MEATHER STRIPPING KIT	
SLIDING	HARDWARE SET 14 1 EA 9K3ON15CSTK	
	4 EA 4.5X4.5 US 26 1 EA SURFACE CLOSER 1 EA THRESHOLD	Case #:
	1 EA WEATHER STRIPPING KIT	Plan Check #: Date: 10/15/24
	HARDWARE SET 15 1 EA 99NL-R/VO1-3 US26 4 EA 4.5X4.5 BUTTS 626	Revisions:
	1 EA SILENCER 1 EA WEATHER STRIPPING KIT 1 EA SURFACE MOUNT CLOSURE	
	1 EA HESS 10061224D 630 J630 12 VOLT ELECTRIC STRIKE (AT BIOSCAN LOCATIONS)	
PANEL		
		Project Number:
R		20068.100 Drawn By:
R =.13	NOTE:	
	DOOR HARDWARE IN THIS SCHEDULE SUPERSEDES TYPICALS NOTED IN PROJECT SPECIFICATIONS.	DOOR TYPES

A401


										[	DOOR SCHEDULE /	HARD		EDULI	E								
		DOOR		SIZE		DOOR		FRA		Hardware				DOOR		SIZE		DOOR		FRAM		Hardware	
DOOR NO.		TYPE	WIDTH	HEIGHT	THK.	MATERIAL	FINISH	MATERIAL	FINISH	Set #/Name	COMMENTS	DOOR NO.	LOCATION	TYPE	WIDTH	HEIGHT	1 3 / 4"	MATERIAL	FINISH	MATERIAL		Set #/Name	COMMENTS
001 001A	MAIN ENTRANCE EXT. MAIN ENTRANCE	A A	14'-0" 14'-0"	6'-11" 6'-11"	2 1/4"	ALUMINUM	GLASS	ALUM	ANOD			211B 212 213	BREAKROOM LAUNDRY OFFICE	G G	3'-0" 4'-0" 3'-0"	7'-0" 7'-0" 7'-0"	1 3/4" 1 3/4" 1 3/4"	NOOD NOOD NOOD	STAINED STAINED STAINED	ALUM ALUM ALUM	CLR CLR CLR	10	BIOSCAN
002	EXT. SHOWROOM	D	3'-0"	7'-0"		HOLLOW METAL		STEEL		3			BREAKOUT ROOM STORAGE		3'-O" 3'-O"	7'-0" 7'-0"	1 3/4" 1 3/4"	MOOD WOOD	STAINED STAINED	ALUM	CLR	10	
003 004	SHOWROOM SHOWROOM	D D	3'-O" 3'-O"	7'-0" 7'-0"	1 3/4"	HOLLOW METAL	PAINT	STEEL STEEL	PAINT			219 220	OFFICE PARTS	G	3'-0" 3'-0"	7'-0" 7'-0"	1 3/4" 1 3/4"	WOOD WOOD	STAINED STAINED	ALUM ALUM	CLR	8 10	
005	SHOWROOM SHOWROOM	ם ם	3'-0" 3'-0"	7'-0" 7'-0"	1 3/4"	HOLLOW METAL	PAINT	STEEL STEEL	PAINT	3 3 3		221 223	STORAGE ELEC ROOM	G	3'-0" 3'-0"	7'-0" 7'-0"		HOLLOW METAL	STAINED PAINT	ALUM STEEL	PAINT	10 10	1 HR RATED
007 008 009	SHOWROOM WAREHOUSE WAREHOUSE	ם ח ח	3'-0" 3'-0" 3'-0"	7'-0" 7'-0" 7'-0"	1 3/4"	HOLLOW METAL HOLLOW METAL HOLLOW METAL		STEEL STEEL STEEL		2 2		224 226	OFFICE	G K	3'-0" 6'-0"	7'-0" 7'-0"		HOLLOW METAL	STAINED STAINED	ALUM ALUM	CLR	8 8	
010 011	WAREHOUSE WAREHOUSE	D D	3'-O" 3'-O"	7'-0" 7'-0"	1 3/4"		PAINT	STEEL	PAINT	2		227 300	OPEN OFFICE ROOF HATCH	K	6'-0" 4'-0"	7'-0" 4'-0"	13/4"	HOLLOW METAL	STAINED	ALUM		8 7	
012 013	WAREHOUSE WAREHOUSE	D D	3'-0" 3'-0"	7'-0" 7'-0"		HOLLOW METAL HOLLOW METAL		STEEL STEEL		2 2		-											
014 015	WAREHOUSE WAREHOUSE	D E	3'-O" 8'-O"	7'-0" 10'-0"	1 3/4" 1 3/4"	HOLLOW METAL METAL	FACTORY FINISH		PAINT -	7	INSULATED PANELS	-											
016 017	WAREHOUSE WAREHOUSE	E	8'-0" 8'-0"	10'-0" 10'-0"	1 3/4" 1 3/4"	METAL METAL	FACTORY FINISH		-	ר ד	INSULATED PANELS INSULATED PANELS	-											
018 019	WAREHOUSE WAREHOUSE	E	8'-0" 8'-0"	10'-0" 10'-0"	1 3/4" 1 3/4" 1 3/4"	METAL METAL	FACTORY FINISH FACTORY FINISH PAINT		- - PAINT	2	INSULATED PANELS	-											
020 021 022	WAREHOUSE WAREHOUSE WAREHOUSE	D E E	3'-0" 8'-0" 8'-0"	7'-0" 10'-0" 10'-0"	1 3/4" 1 3/4"	HOLLOW METAL METAL METAL	FACTORY FINISH	STEEL		2 7	INSULATED PANELS	-											
022 023 024	WAREHOUSE WAREHOUSE	E	8'-0" 8'-0"	10'-0" 10'-0"	1 3/4" 1 3/4"	METAL METAL METAL	FACTORY FINISH	ł –		7	INSULATED PANELS	-											
025 026	WAREHOUSE WAREHOUSE	E	8'-0" 8'-0"	10'-0" 10'-0"	1 3/4" 1 3/4"	METAL	FACTORY FINISH	ł –	-	7	INSULATED PANELS	-											
027 028	WAREHOUSE WAREHOUSE	E D	8'-0" 3'-0"	10'-0" 7'-0"	1 3/4"	METAL HOLLOW METAL	FACTORY FINISH		- PAINT	7 2	INSULATED PANELS	-											
029 030	WAREHOUSE WAREHOUSE	E E	8'-0" 8'-0"	10'-0" 10'-0"	1 3/4" 1 3/4"	METAL METAL	FACTORY FINISH	ł –	-	7 7	INSULATED PANELS INSULATED PANELS	-											
031 032	WAREHOUSE WAREHOUSE	E E	8'-0" 8'-0"	10'-0" 10'-0"	1 3/4" 1 3/4"	METAL METAL	FACTORY FINISH		-	7	INSULATED PANELS	-											
033 034	WAREHOUSE WAREHOUSE	E E	8'-0" 8'-0"	10'-0" 10'-0"	1 3/4" 1 3/4"	METAL METAL	FACTORY FINISH		-														
035 036	WAREHOUSE WAREHOUSE	D E	3'-O" 8'-O"	7'-0" 10'-0"	1 3/4"	HOLLOW METAL METAL	FACTORY FINISH		PAINT -	2 7	INSULATED PANELS	-											
037 038	WAREHOUSE WAREHOUSE	E	8'-0" 8'-0"	10'-0" 10'-0"	1 3/4" 1 3/4"	METAL METAL	FACTORY FINISH	ł –	-	ד ד	INSULATED PANELS INSULATED PANELS	-											
039 040	WAREHOUSE WAREHOUSE	E	8'-0" 8'-0"	10'-0" 10'-0"	1 3/4" 1 3/4"	METAL METAL	FACTORY FINISH	ł –	-	7	INSULATED PANELS	-											
041 042	WAREHOUSE WAREHOUSE	E	8'-0" 8'-0"	10'-0" 10'-0"	1 3/4" 1 3/4"	METAL METAL	FACTORY FINISH	ł –		7 7 2	INSULATED PANELS	-											
043 044 045	WAREHOUSE WAREHOUSE WAREHOUSE	D E E	3'-0" 8'-0" 8'-0"	7'-0" 10'-0" 10'-0"	1 3/4" 1 3/4" 1 3/4"	HOLLOW METAL METAL METAL	PAINT FACTORY FINISH FACTORY FINISH		PAINT - -	2 7	INSULATED PANELS	-											
045 046 047	WAREHOUSE WAREHOUSE	E	8'-0" 8'-0"	10'-0" 10'-0"	1 3/4" 1 3/4"	METAL METAL METAL	FACTORY FINISH	ł –	-	7	INSULATED PANELS	-											
049 050	CUST. PICKUP CUST. PICKUP	D E	3'-O" 8'-O"	7'-0" 10'-0"	1 3/4" 1 3/4"	HOLLOW METAL METAL		STEEL	PAINT -	7 7 7	INSULATED PANELS	-											
051 052	CUST. PICKUP CUST. PICKUP	E	8'-0" 8'-0"	10'-0" 10'-0"	1 3/4" 1 3/4"	METAL METAL	FACTORY FINISH	ł –	-	7 7	INSULATED PANELS INSULATED PANELS	-											
053 054	CUST. PICKUP CUST. PICKUP	E E	12'-0" 8'-0"	14'-0" 10'-0"	2" 1 3/4"	METAL METAL	FACTORY FINISH FACTORY FINISH		-	7 2	INSULATED PANELS												
055 056	CUST. PICKUP SHOWROOM/WH	E D	8'-0" 3'-0"	10'-0" 7'-0"	1 3/4" 1 3/4"	METAL HOLLOW METAL		STEEL	- PAINT	7	INSULATED PANELS	-											
057 058	SHOWROOM/WH SHOWROOM/WH	E D	12'-0" 3'-0"			METAL HOLLOW METAL		STEEL	- PAINT	14 2		-											
059 103	SHOWROOM/WH OPEN OFFICE	E G	12'-0" 3'-0"	14'-0" 7'-0"	2" 1 3/4"	METAL WOOD	FACTORY FINISH	ALUM		8		-											
104 105 106	ELEC ROOM CASH WRAP MENS RR	G G G	3'-0" 3'-0" 3'-0"	7'-0" 7'-0" 7'-0"	1 3/4" 1 3/4" 1 3/4"	WOOD           WOOD           WOOD	STAINED STAINED STAINED	ALUM ALUM ALUM	CLR	8 8 11	1 HR RATED / PANIC HARDWARE BIOSCAN	-											
107 108	MOP CLOSET WOMENS RR	G	3'-0" 3'-0"	7'-0" 7'-0"	1 3/4" 1 3/4"	MOOD       WOOD	STAINED STAINED STAINED	ALUM ALUM		10 11	BIOSCAN	-											
109 110	FAMILY RR SALES LOCKER	G	3'-O" 3'-O"	7'-0" 7'-0"	1 3/4" 1 3/4"	MOOD WOOD	STAINED STAINED	ALUM ALUM		8	ADD ADA RESTROOM SIGN	-											
111 112	STORAGE ONLINE SALES	ם D	3'-0" 3'-0"	7'-0" 7'-0"		HOLLOW METAL HOLLOW METAL		STEEL STEEL	PAINT PAINT			-											
118 118A	VESTIBULE ENTRY CAFE ENTRY	B B	6'-0" 6'-0"	8'-0" 8'-0"	1 3/4" 1 3/4"	ALUMINUM ALUMINUM	CLEAR CLEAR	ALUM ALUM	CLR CLR	1 1													
119	CUSTOMER PICKUP/WH	D	3'-0"	8'-0"	1/4"	ALUMINUM	CLEAR	ALUM	CLR			_											
120 121	ELEC ROOM STORAGE	G	3'-0" 3'-0"	7'-0" 7'-0"	1 3/4" 1 3/4"	NOOD NOOD	STAINED STAINED	ALUM ALUM	CLR	4	1 HR RATED	-											
122 123 124	MENS RR MOP CLOSET WOMENS RR	G G G	3'-0" 3'-0" 3'-0"	7'-0" 7'-0" 7'-0"	1 3/4" 1 3/4" 1 3/4"	WOOD           WOOD           WOOD	STAINED STAINED STAINED	ALUM ALUM ALUM		11 10 11	BIOSCAN	-											
124 125 126	FIRE PUMP ROOM	С С С	6'-0" 3'-0"	7'-0" 7'-0"		HOLLOW METAL WOOD		STEEL	PAINT	4	1 HR RATED	-											
126A 127	ELEC ROOM WOMENS RR	С С С	6'-0" 3'-0"	7'-0" 7'-0"		HOLLOW METAL NOOD		STEEL	PAINT	11													
127A 128	ADA SHOWER MOP CLOSET	G G	3'-0" 3'-0"	7'-0" 7'-0"	1 3/4" 1 3/4"	NOOD NOOD	STAINED STAINED	ALUM ALUM	CLR CLR	8 10	BIOSCAN	-											
129 130	MENS RR BLDG MAINT	G G	3'-0" 3'-0"	7'-0" 7'-0"	1 3/4" 1 3/4"	WOOD WOOD	STAINED STAINED	ALUM ALUM	CLR CLR	11 10	BIOSCAN	-											
131	STORAGE PARTS OFFICE OFFICE	C	6'-0" 3'-0"	7'-0"		HOLLOW METAL		STEEL	PAINT	-		-											
132 133 133A	MAREHOUSE/MAINT MAINT EXT.	G G G	3'-0" 3'-0" 3'-0"	7'-0" 7'-0" 7'-0"	1 3/4" 1 3/4" 1 3/4"	WOOD           WOOD           WOOD	STAINED STAINED STAINED	ALUM ALUM ALUM	CLR CLR CLR	8		-											
133B 133C	WAREHOUSE WAREHOUSE	ם ח ח	3'-O" 3'-O"	7'-0" 7'-0"	1 3/4"	HOLLOW METAL HOLLOW METAL	PAINT	STEEL		2		-											
133D 134	WAREHOUSE/MAINT TRUCKER RR	E D	12'-0" 3'-0"	14'-0" 7'-0"	2"	METAL HOLLOW METAL	FACTORY FINISH			7	INSULATED PANELS	-											
135 180	CORRIDOR WAREHOUSE	D E	3'-0" 18'-0"	7'-0" 20'-0"	1 3/4" 2"	HOLLOW METAL METAL	PAINT FACTORY FINISH	STEEL	PAINT -	15 7	BIOSCAN INSULATED PANELS	-											
194 201	ROOF HATCH OTR OFFICE	G	5'-0" 3'-0"	3'-0" 7'-0"	1 3/4"	WOOD	STAINED	ALUM	CLR	7 9													
202 203	DATA MANAGER DATA	G D	3'-0" 3'-0"	7'-0" 7'-0"				ALUM STEEL	PAINT	8 12	BIOSCAN BIOSCAN	-											
204 205	EXERCISE ROOM WAREHOUSE MANAGER	G G	3'-0" 3'-0"	7'-0" 7'-0"	1 3/4" 1 3/4"	NOOD NOOD	STAINED STAINED	ALUM ALUM	CLR CLR	8		-											
206	MANAGER WAREHOUSE MANAGER	G	3'-0"	7'-0"	1 3/4"	WOOD	STAINED	ALUM	CLR	8		-											
207 207A	ADA SHOWER	6 6	3'-0" 3'-0"	7'-0" 7'-0"	1 3/4" 1 3/4"	MOOD MOOD	STAINED STAINED	ALUM ALUM		11 8		-											
208 209	MOP CLOSET WOMENS RR	G	3'-0" 3'-0"	7'-0" 7'-0"	1 3/4" 1 3/4"	WOOD WOOD	STAINED STAINED	ALUM ALUM			BIOSCAN												
209A 210	ADA SHOWER BREAKROOM	G K	3'-O" 6'-O"	7'-0" 7'-0"		NOOD HOLLOW METAL		ALUM ALUM	CLR CLR	8 8		-											
210A 211	BREAKROOM ELEC ROOM	G D	3'-0" 3'-0"	7'-0" 7'-0"	1 3/4" 1 3/4"	NOOD HOLLOW METAL	STAINED PAINT	ALUM STEEL	CLR PAINT	9 10	1 HR RATED												





5017 East Washington St. #100 Phoenix, Arizona 85034 Phone 602-957-1800




OWNERSHIP OF INSTRUMENTS OF SERVICE All reports, plans, specifications, computer files, field data, notes and other documents and instruments prepared by the design professional as instruments of service shall remain the property of the design professional. The design professional shall retain all common law, statutory and other reserved rights, including the copyright thereto.

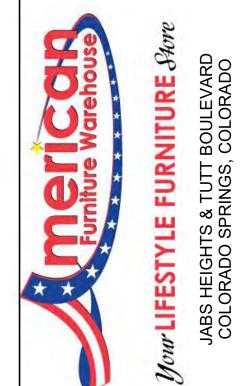

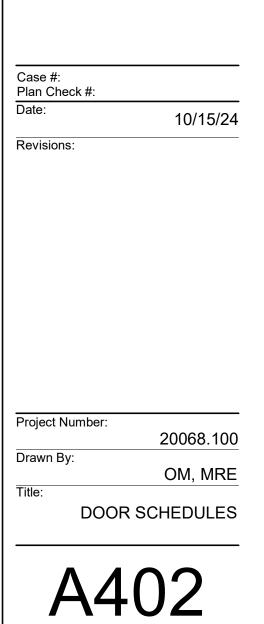


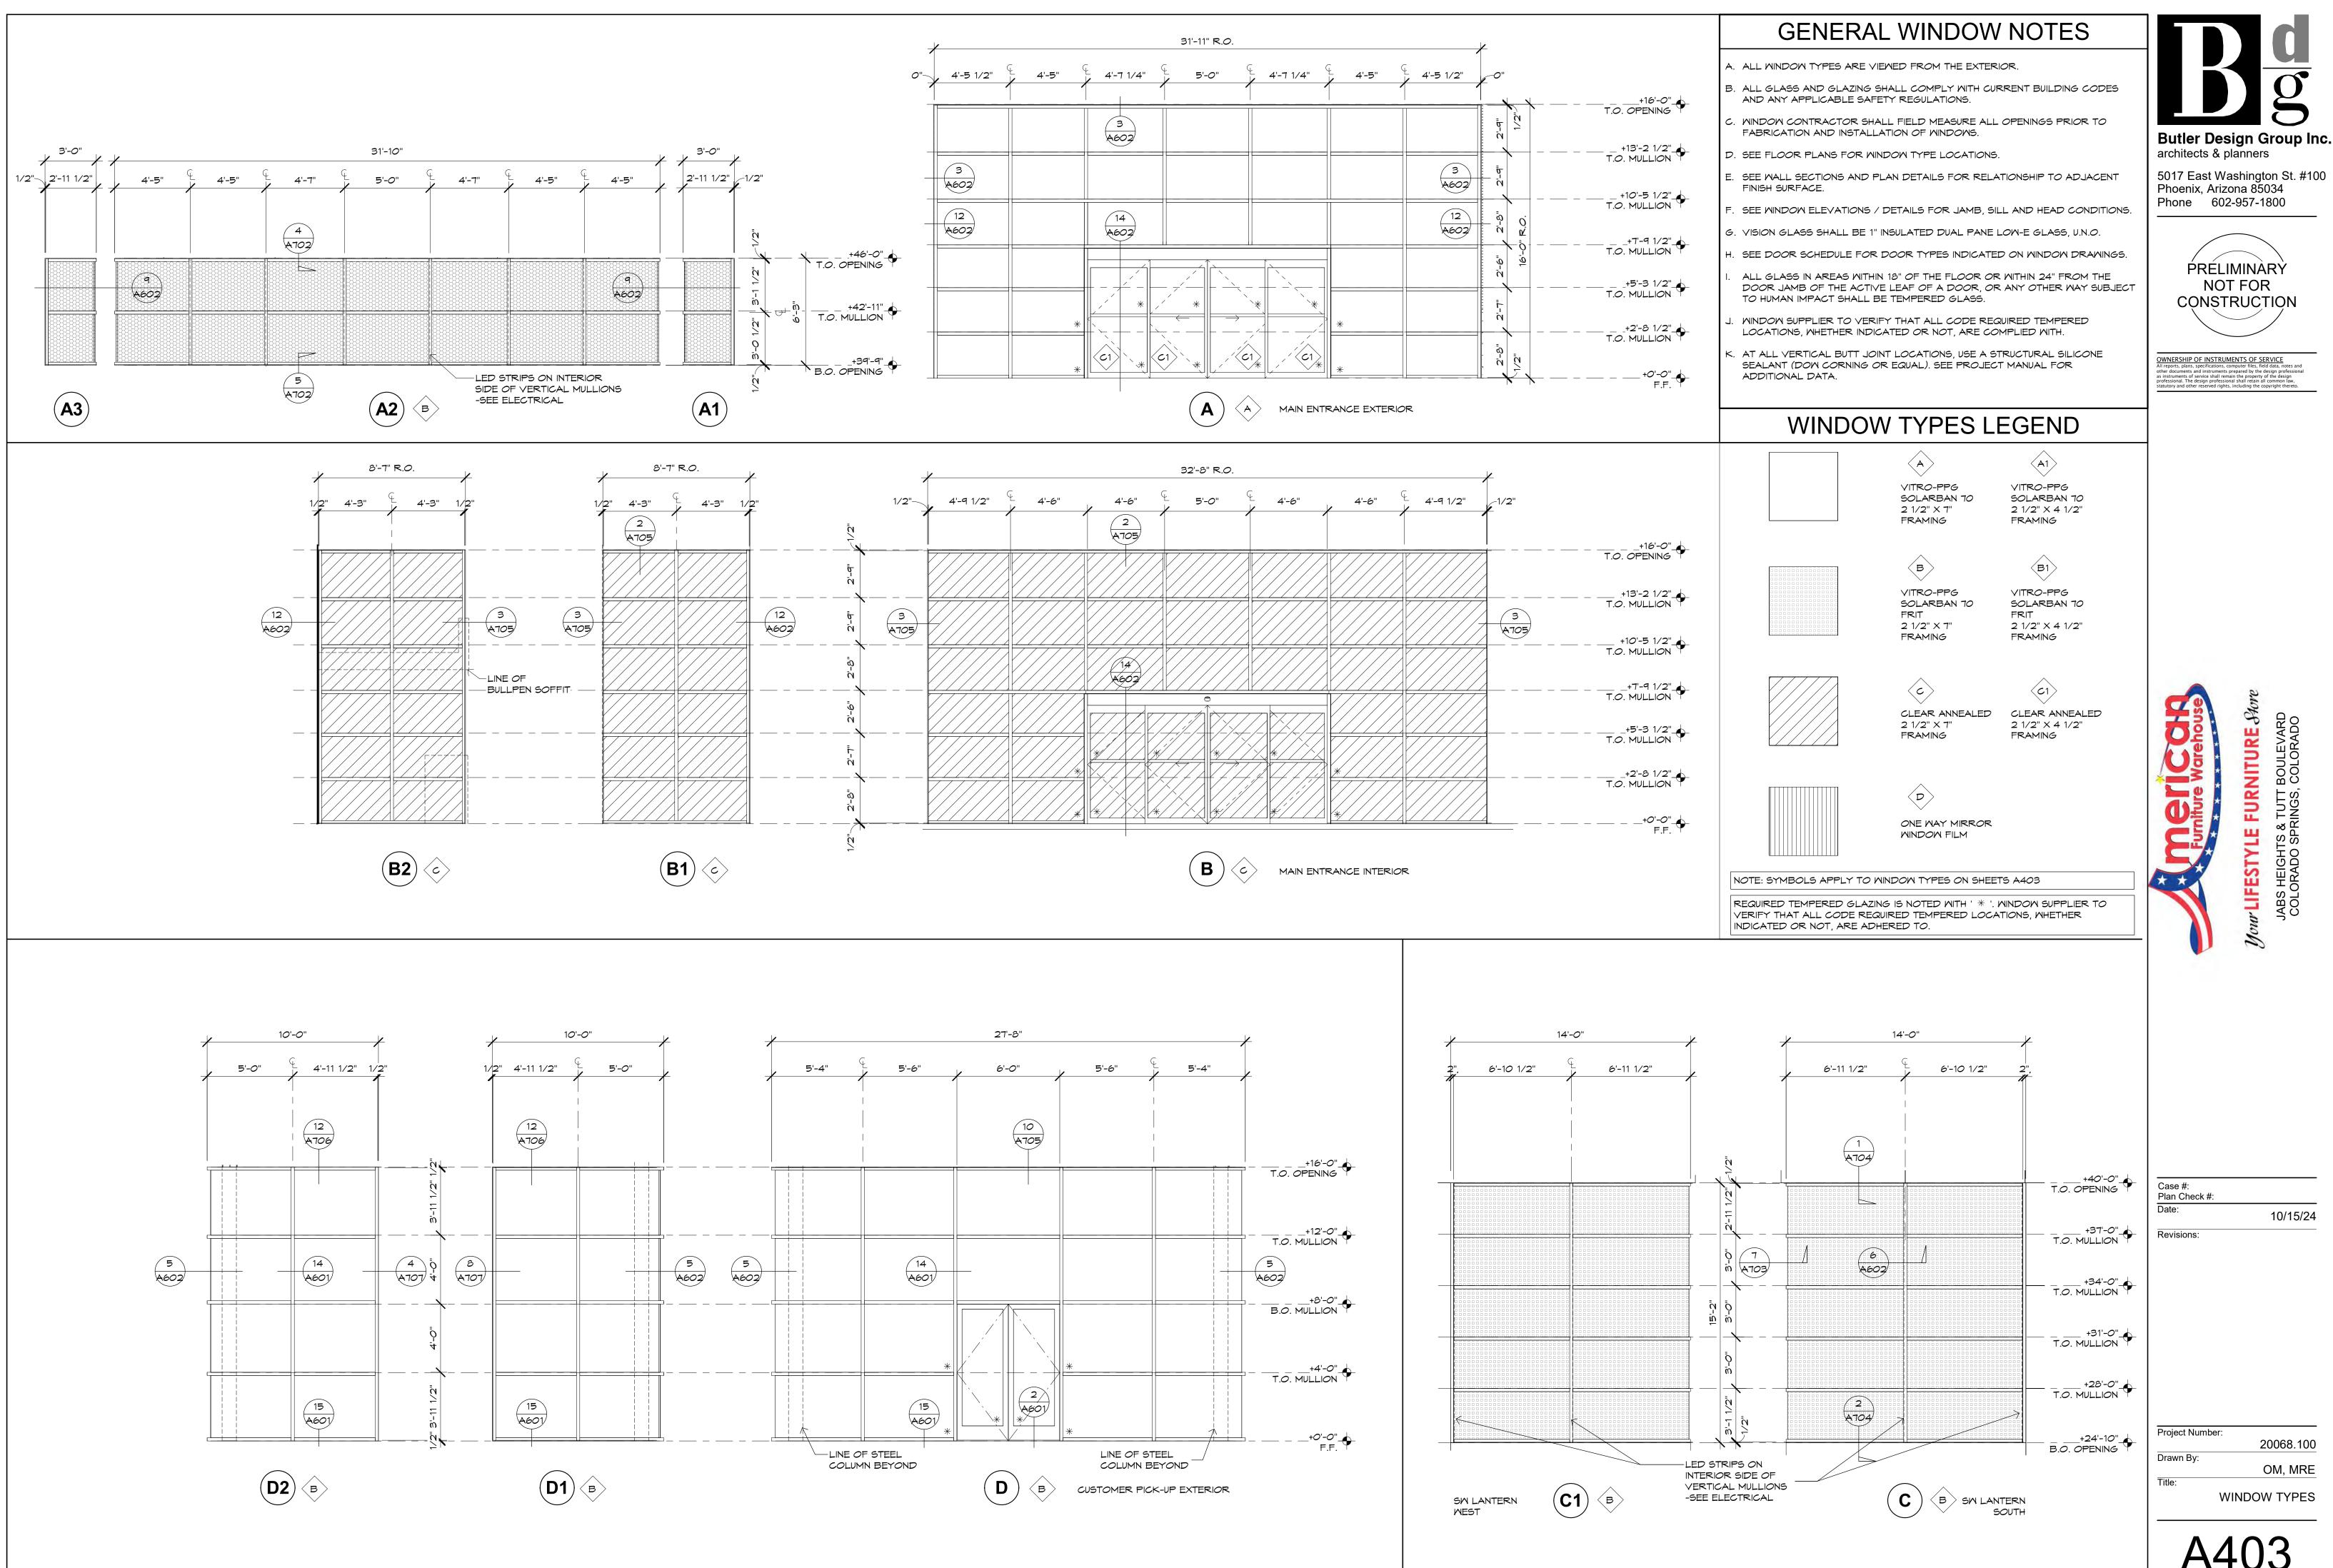



A403

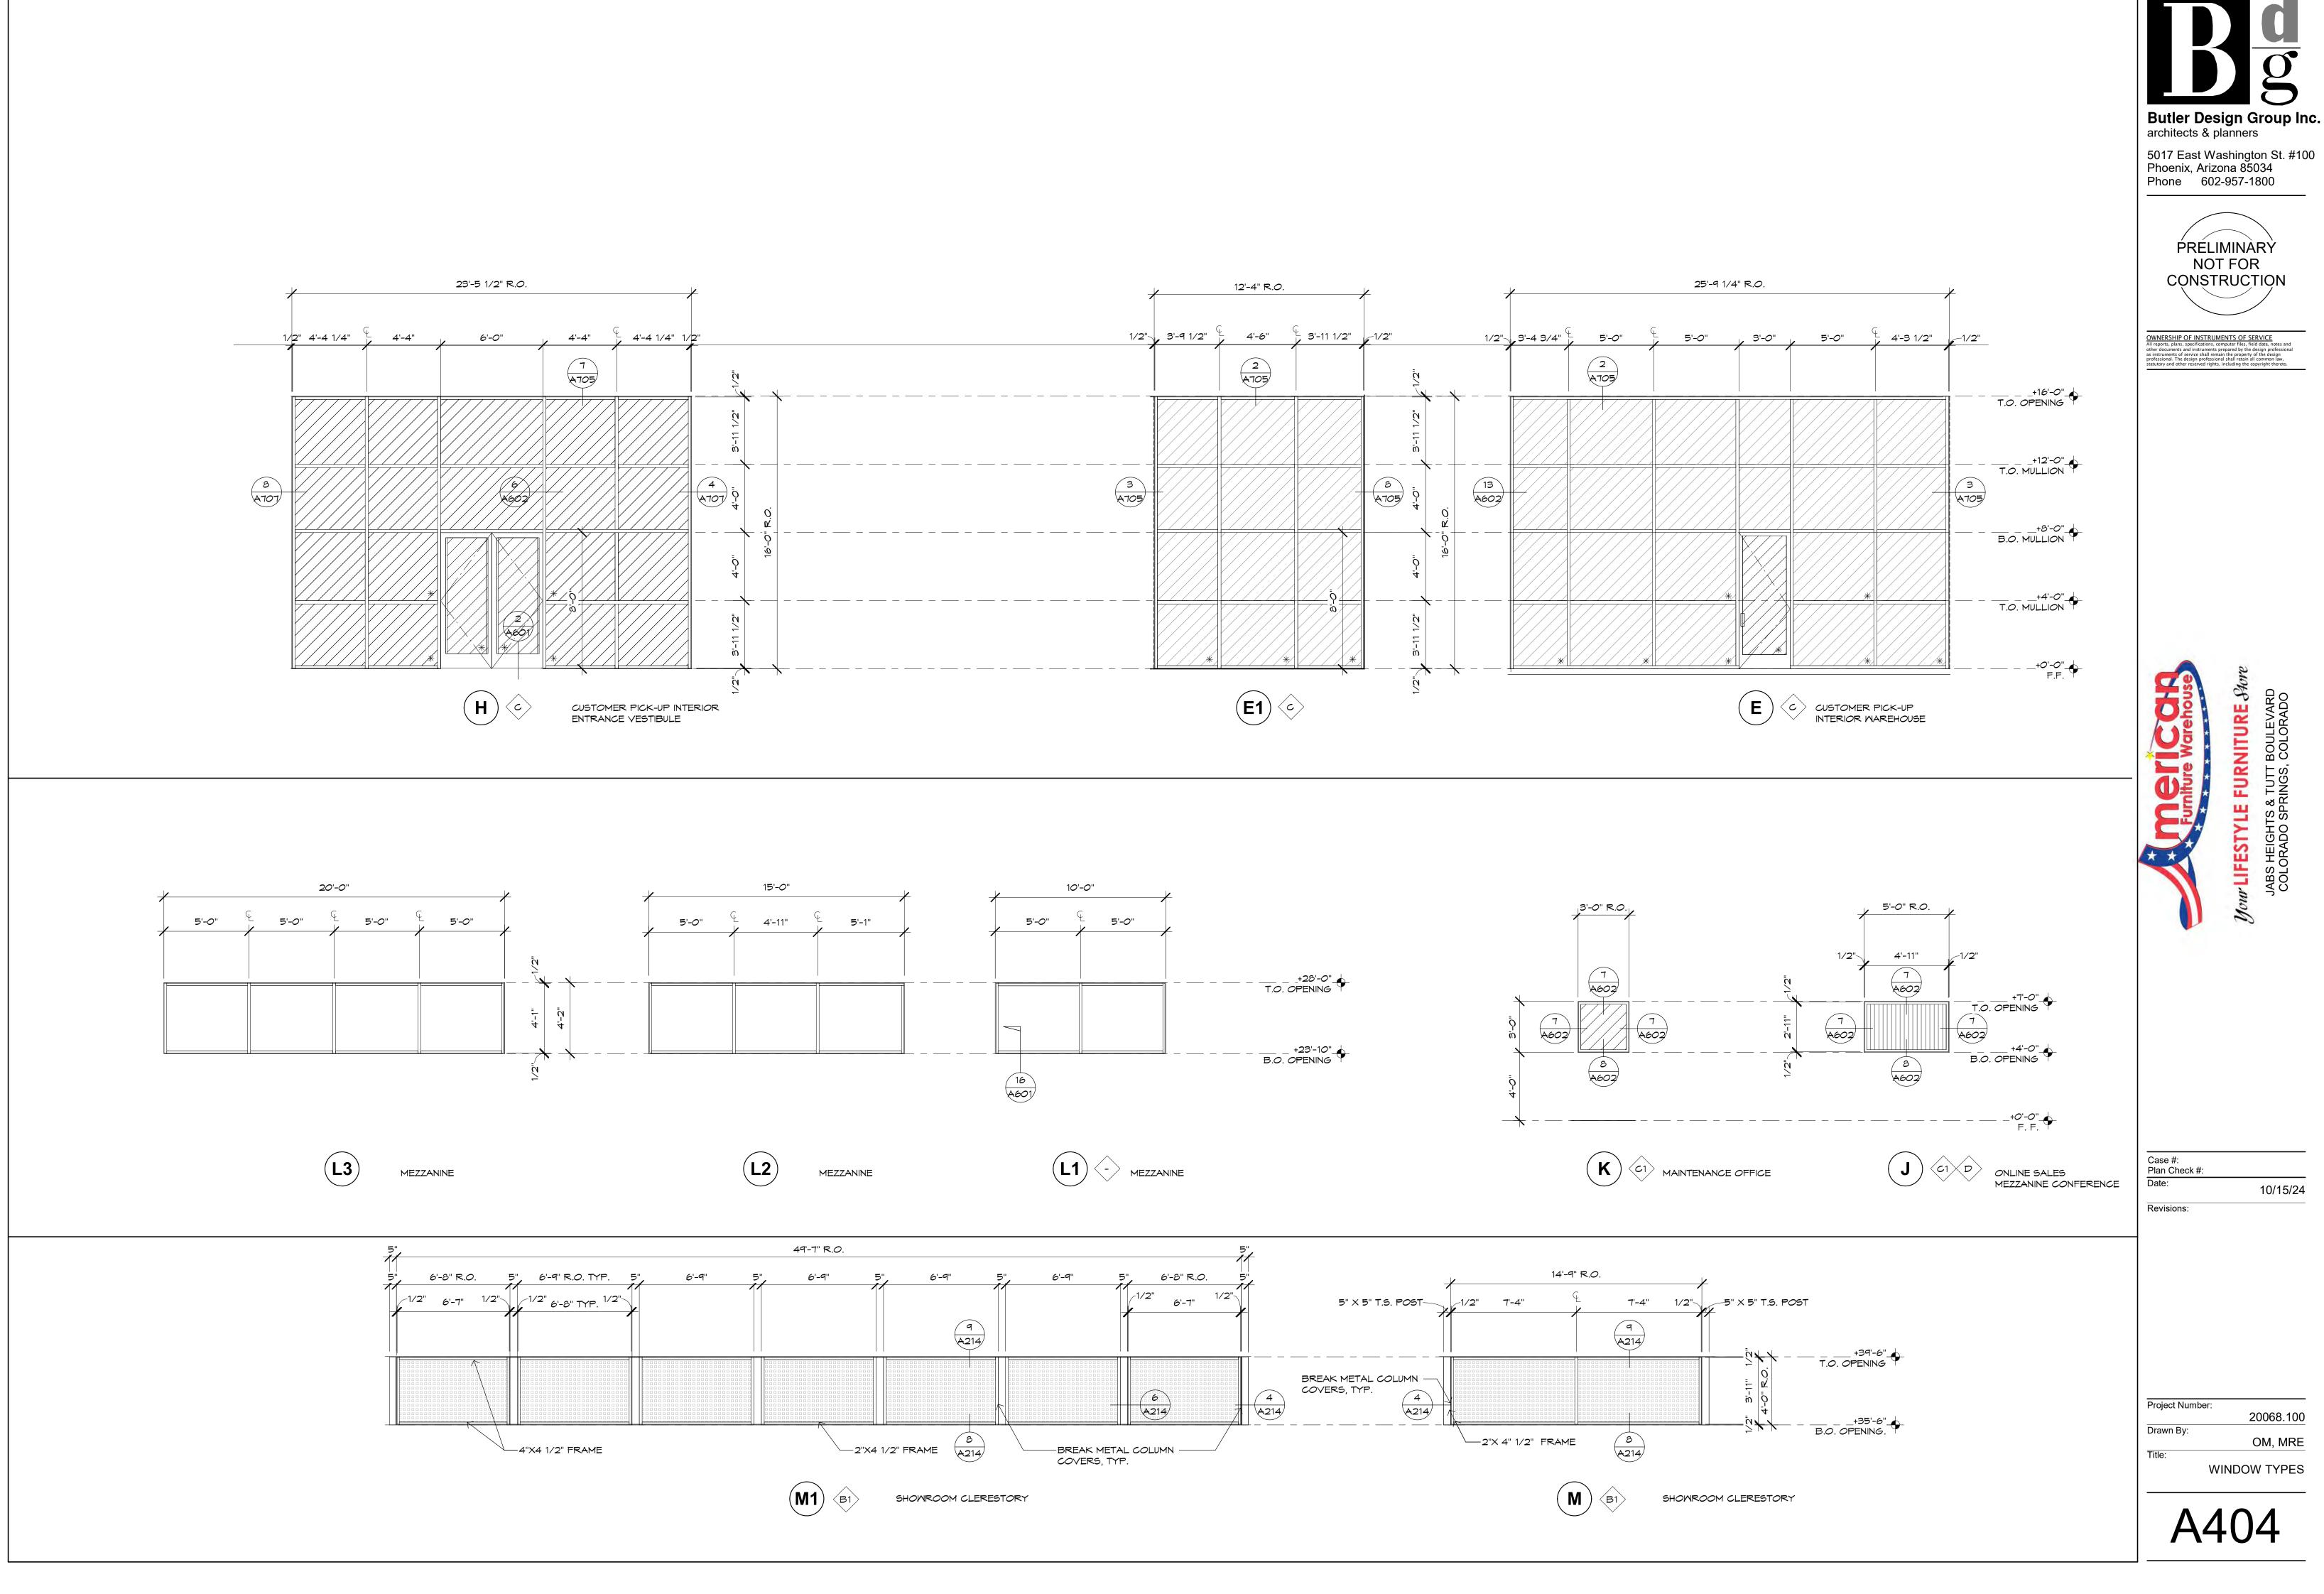


g Butler Design Group Inc.

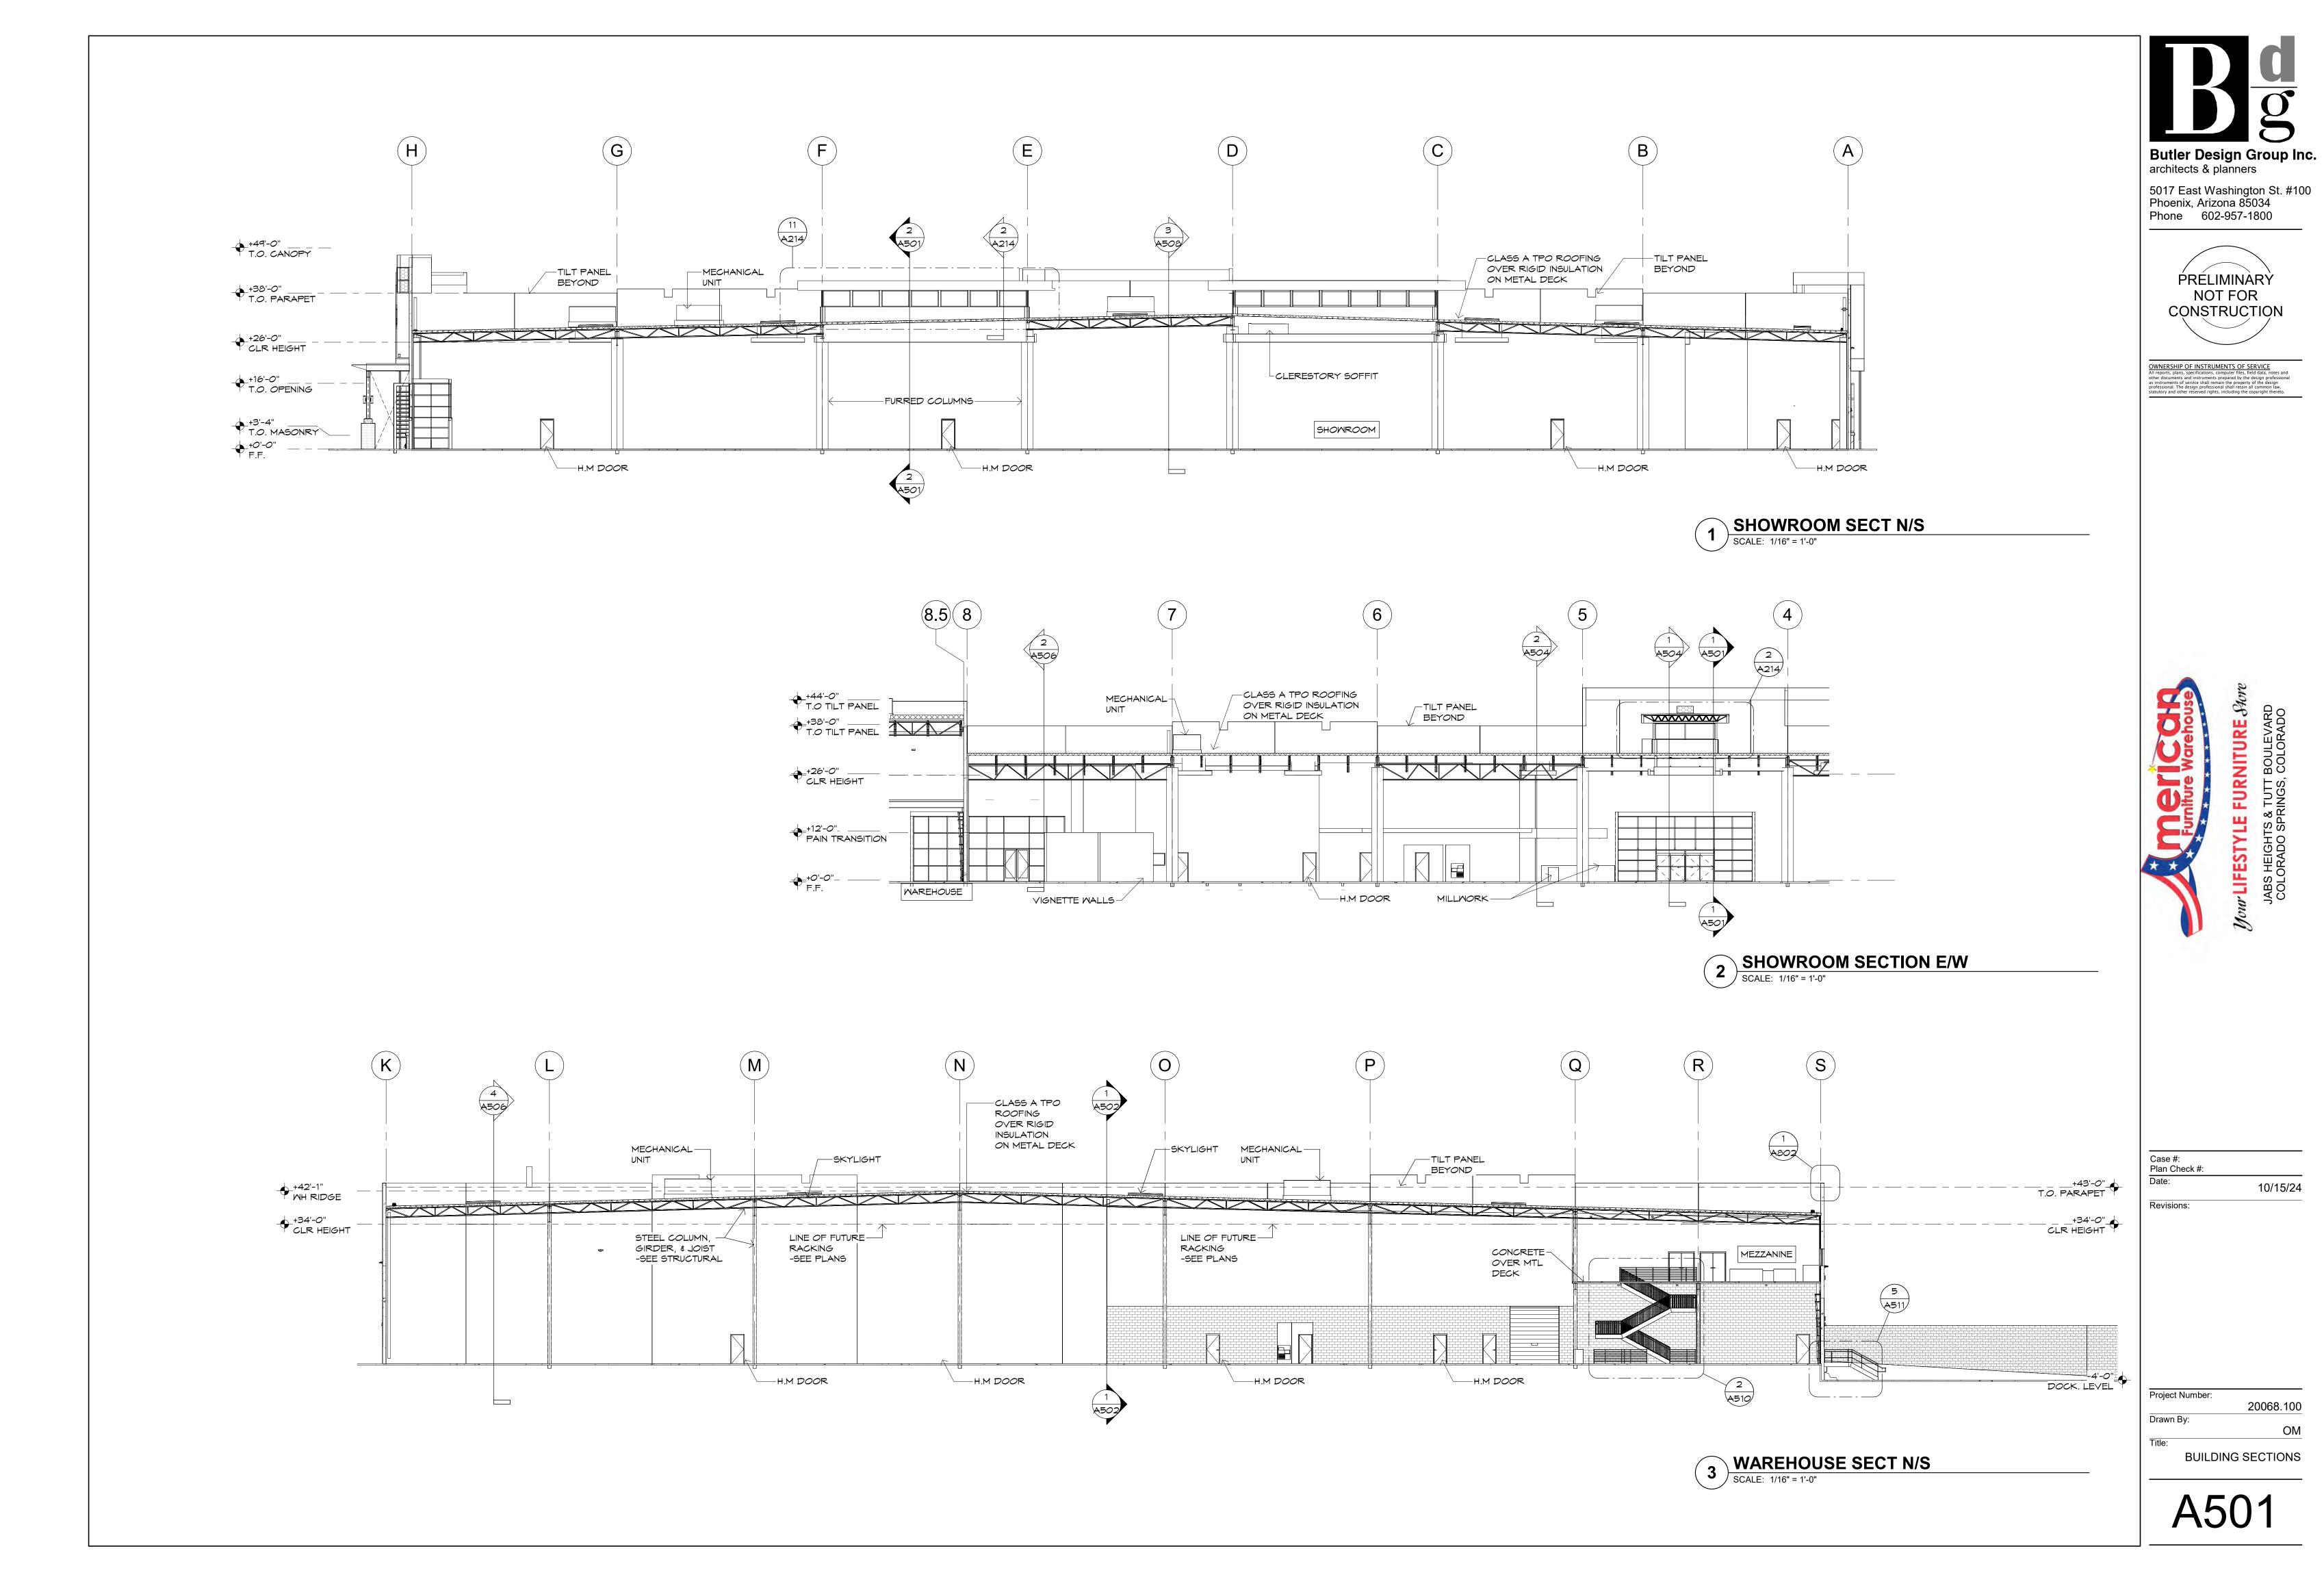

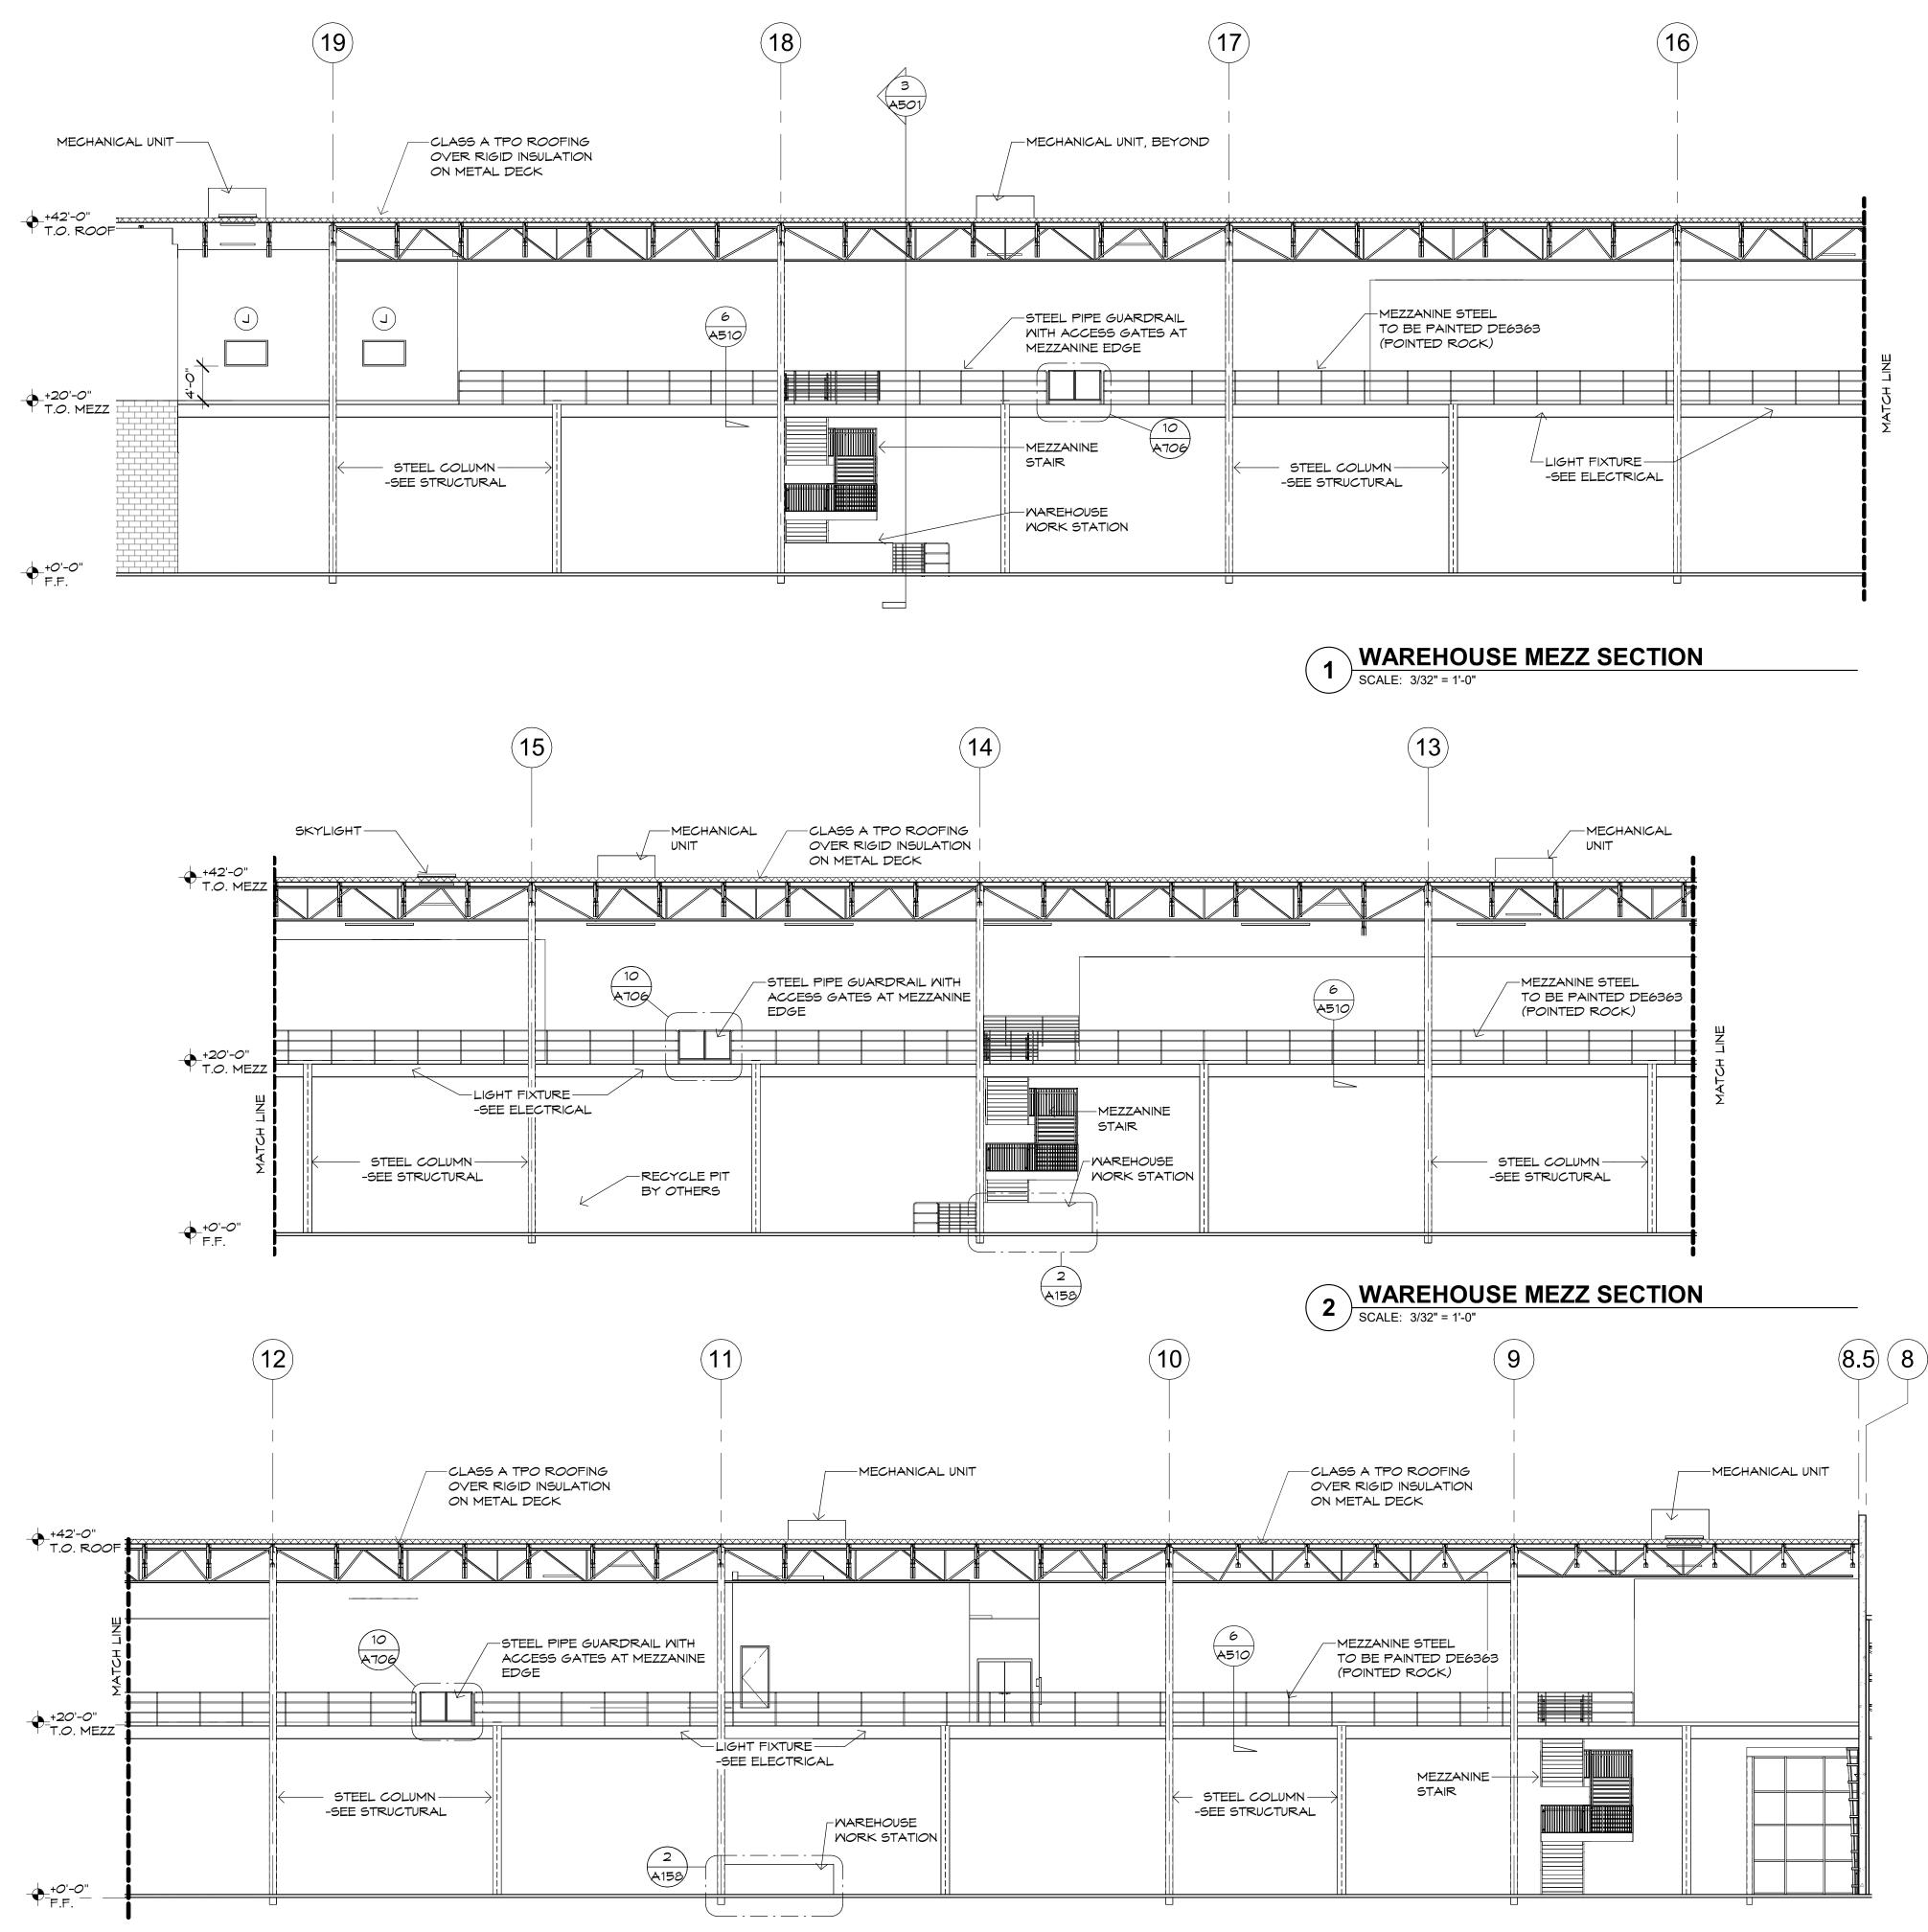

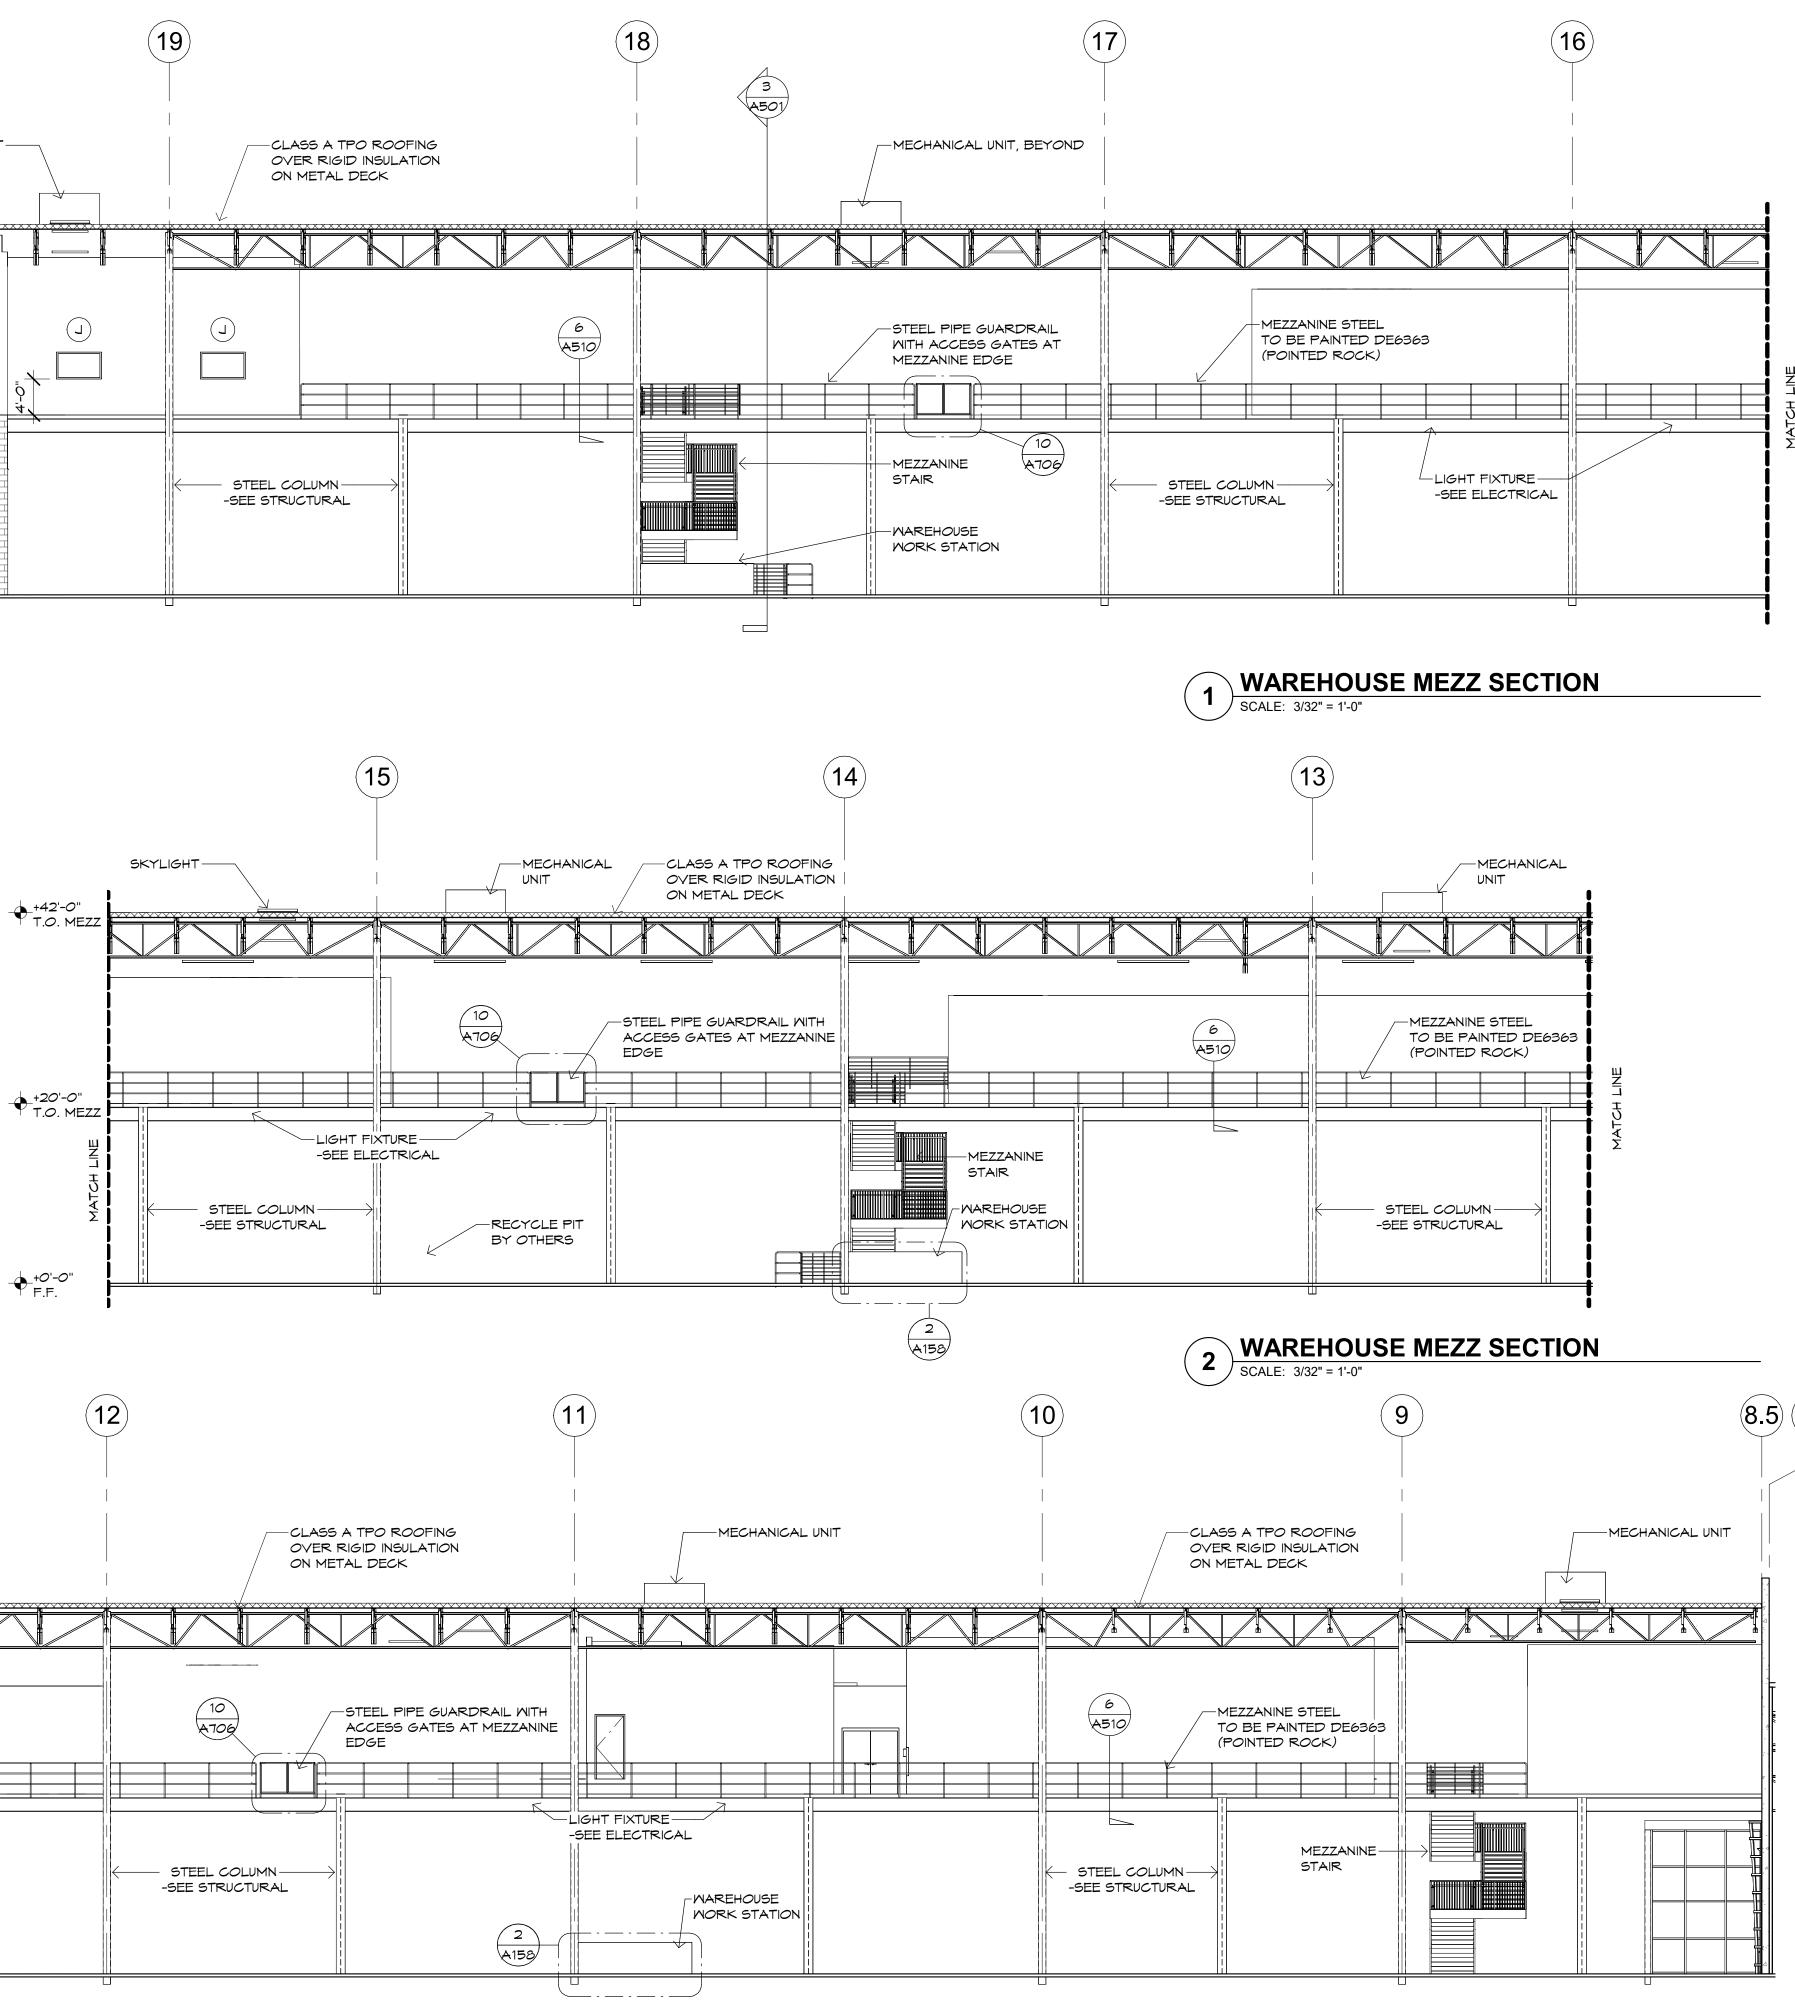

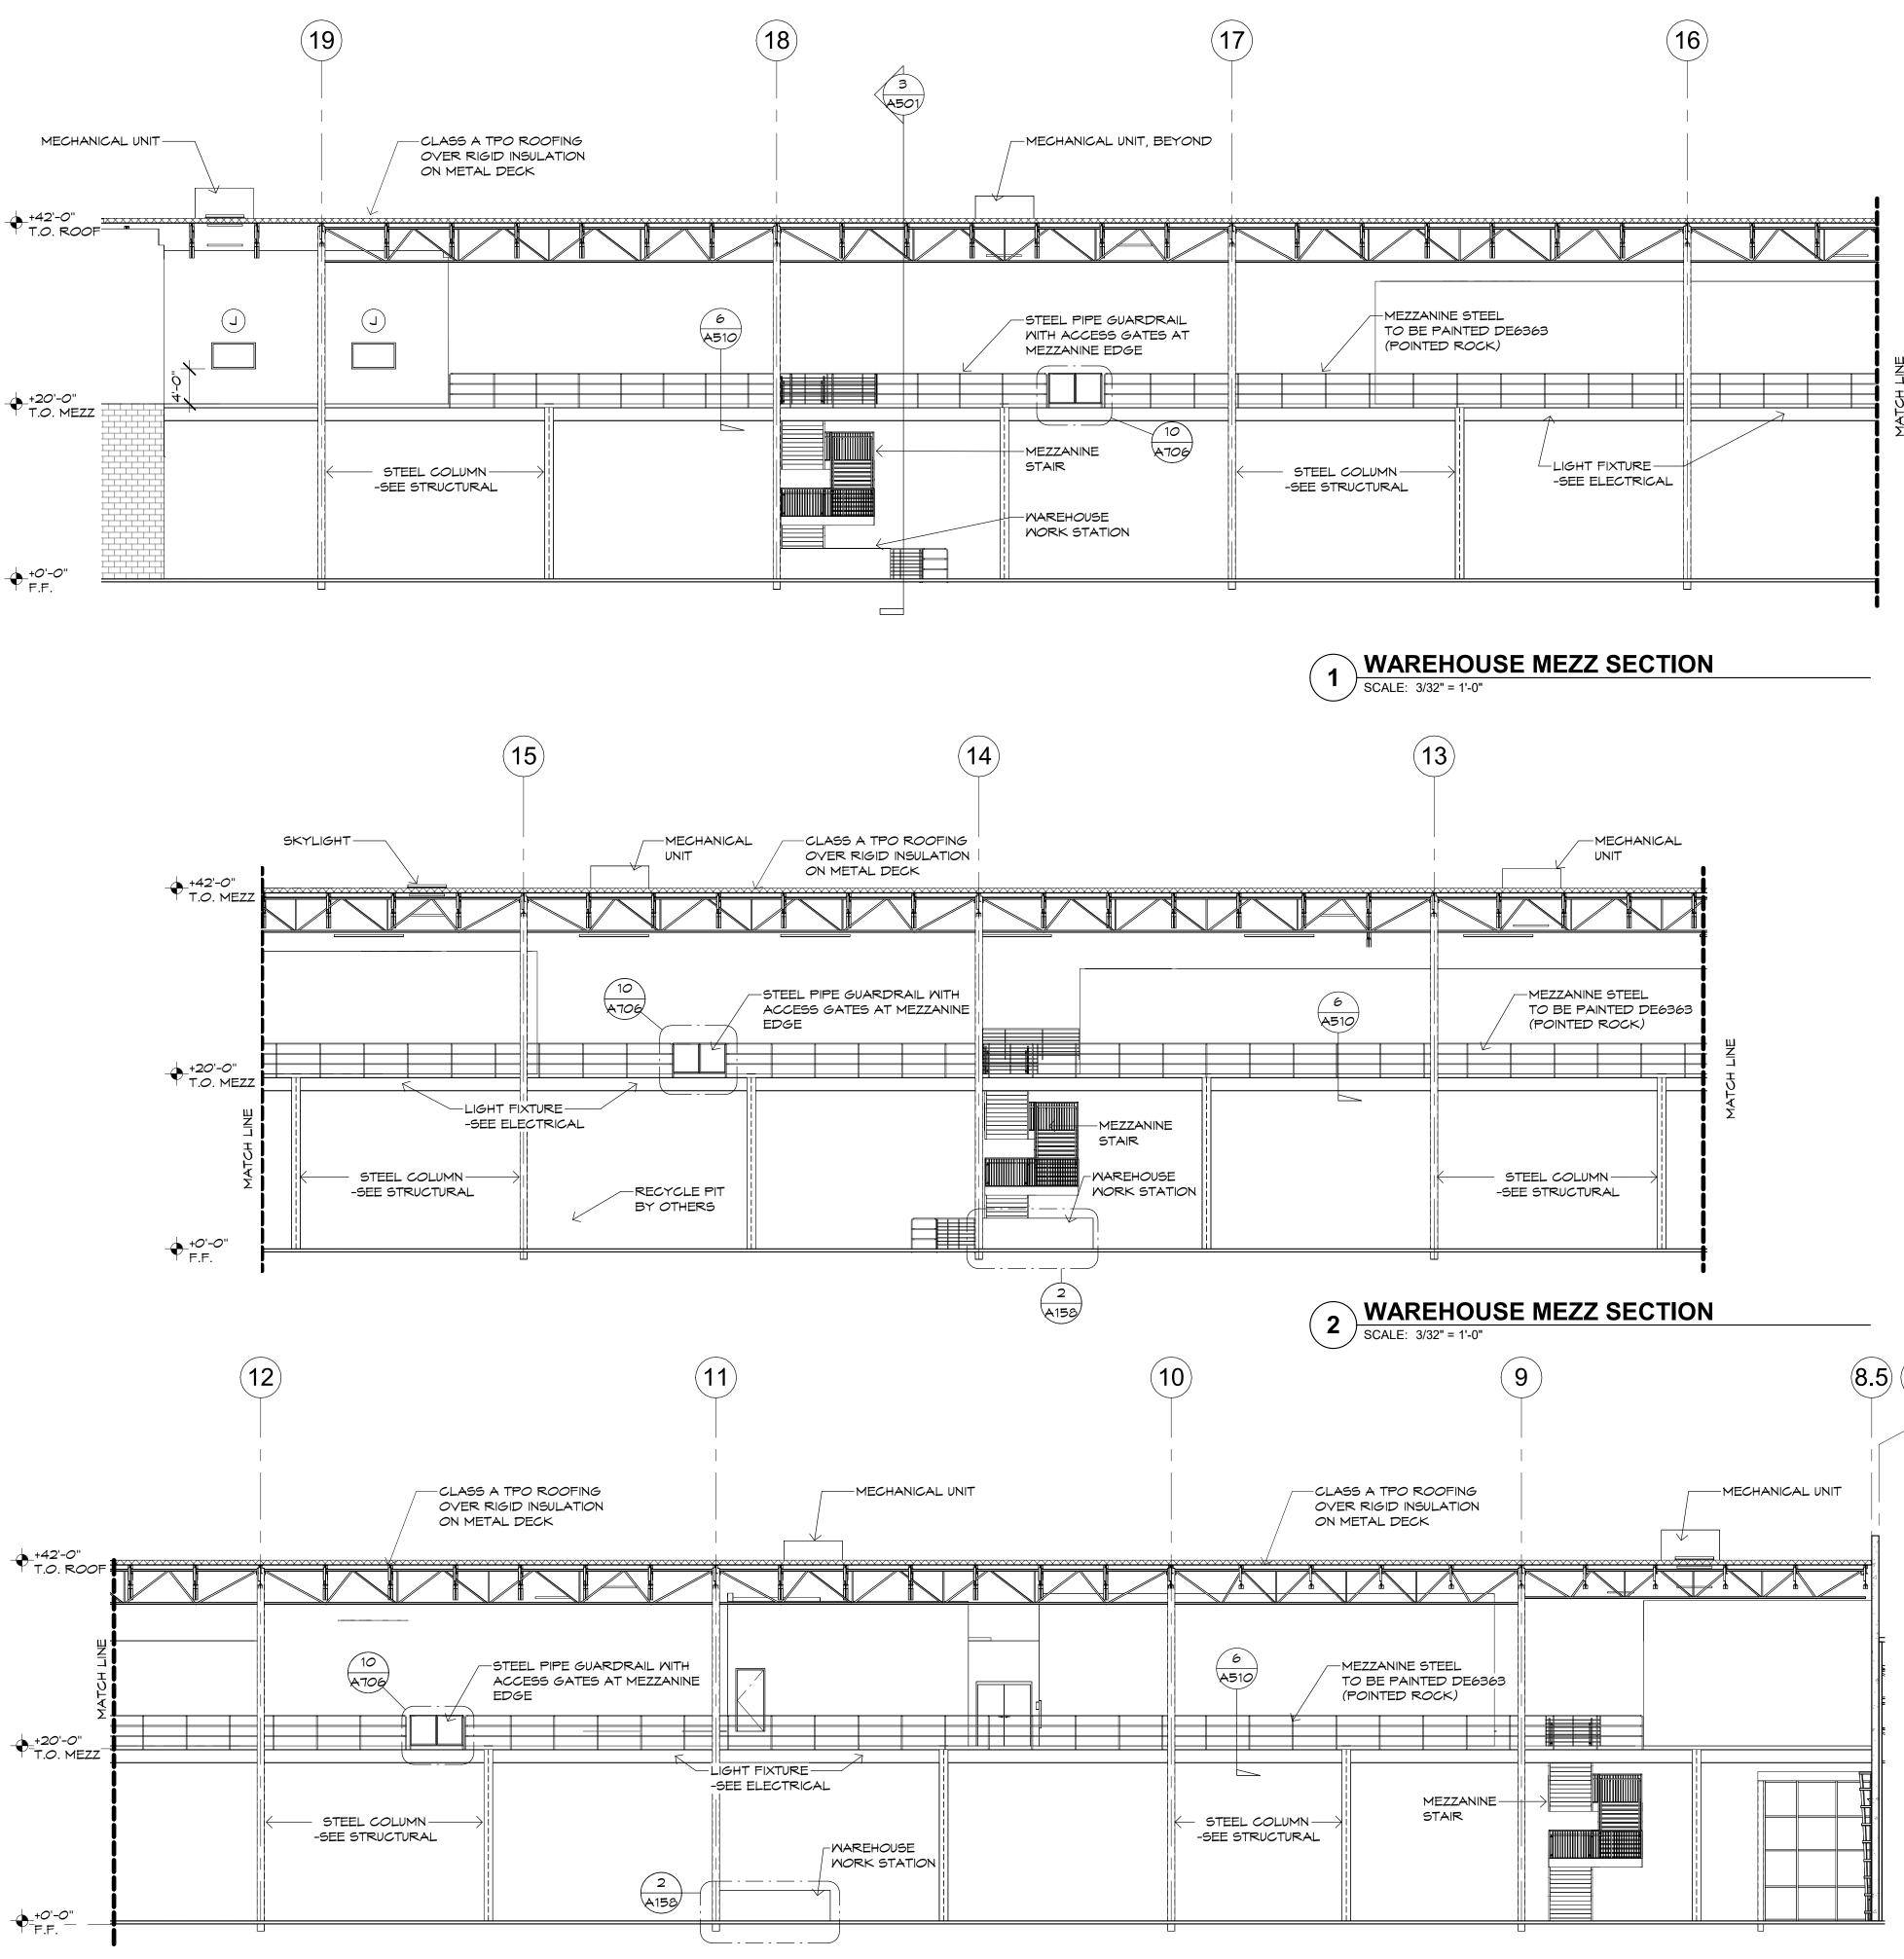





Project Number: 20068.100 Drawn By: OM Title: **BUILDING SECTIONS** 

10/15/24



Case #: Plan Check #:

Revisions:

Date:

FURNITURE & , COLORADO & TUTT | PRINGS, *a***'LIFESTYLE** JABS HEIGHTS { COLORADO SP






architects & planners


5017 East Washington St. #100 Phoenix, Arizona 85034 Phone 602-957-1800

**PRÉLIMINÀRY** 

NOT FOR

CONSTRUCTION

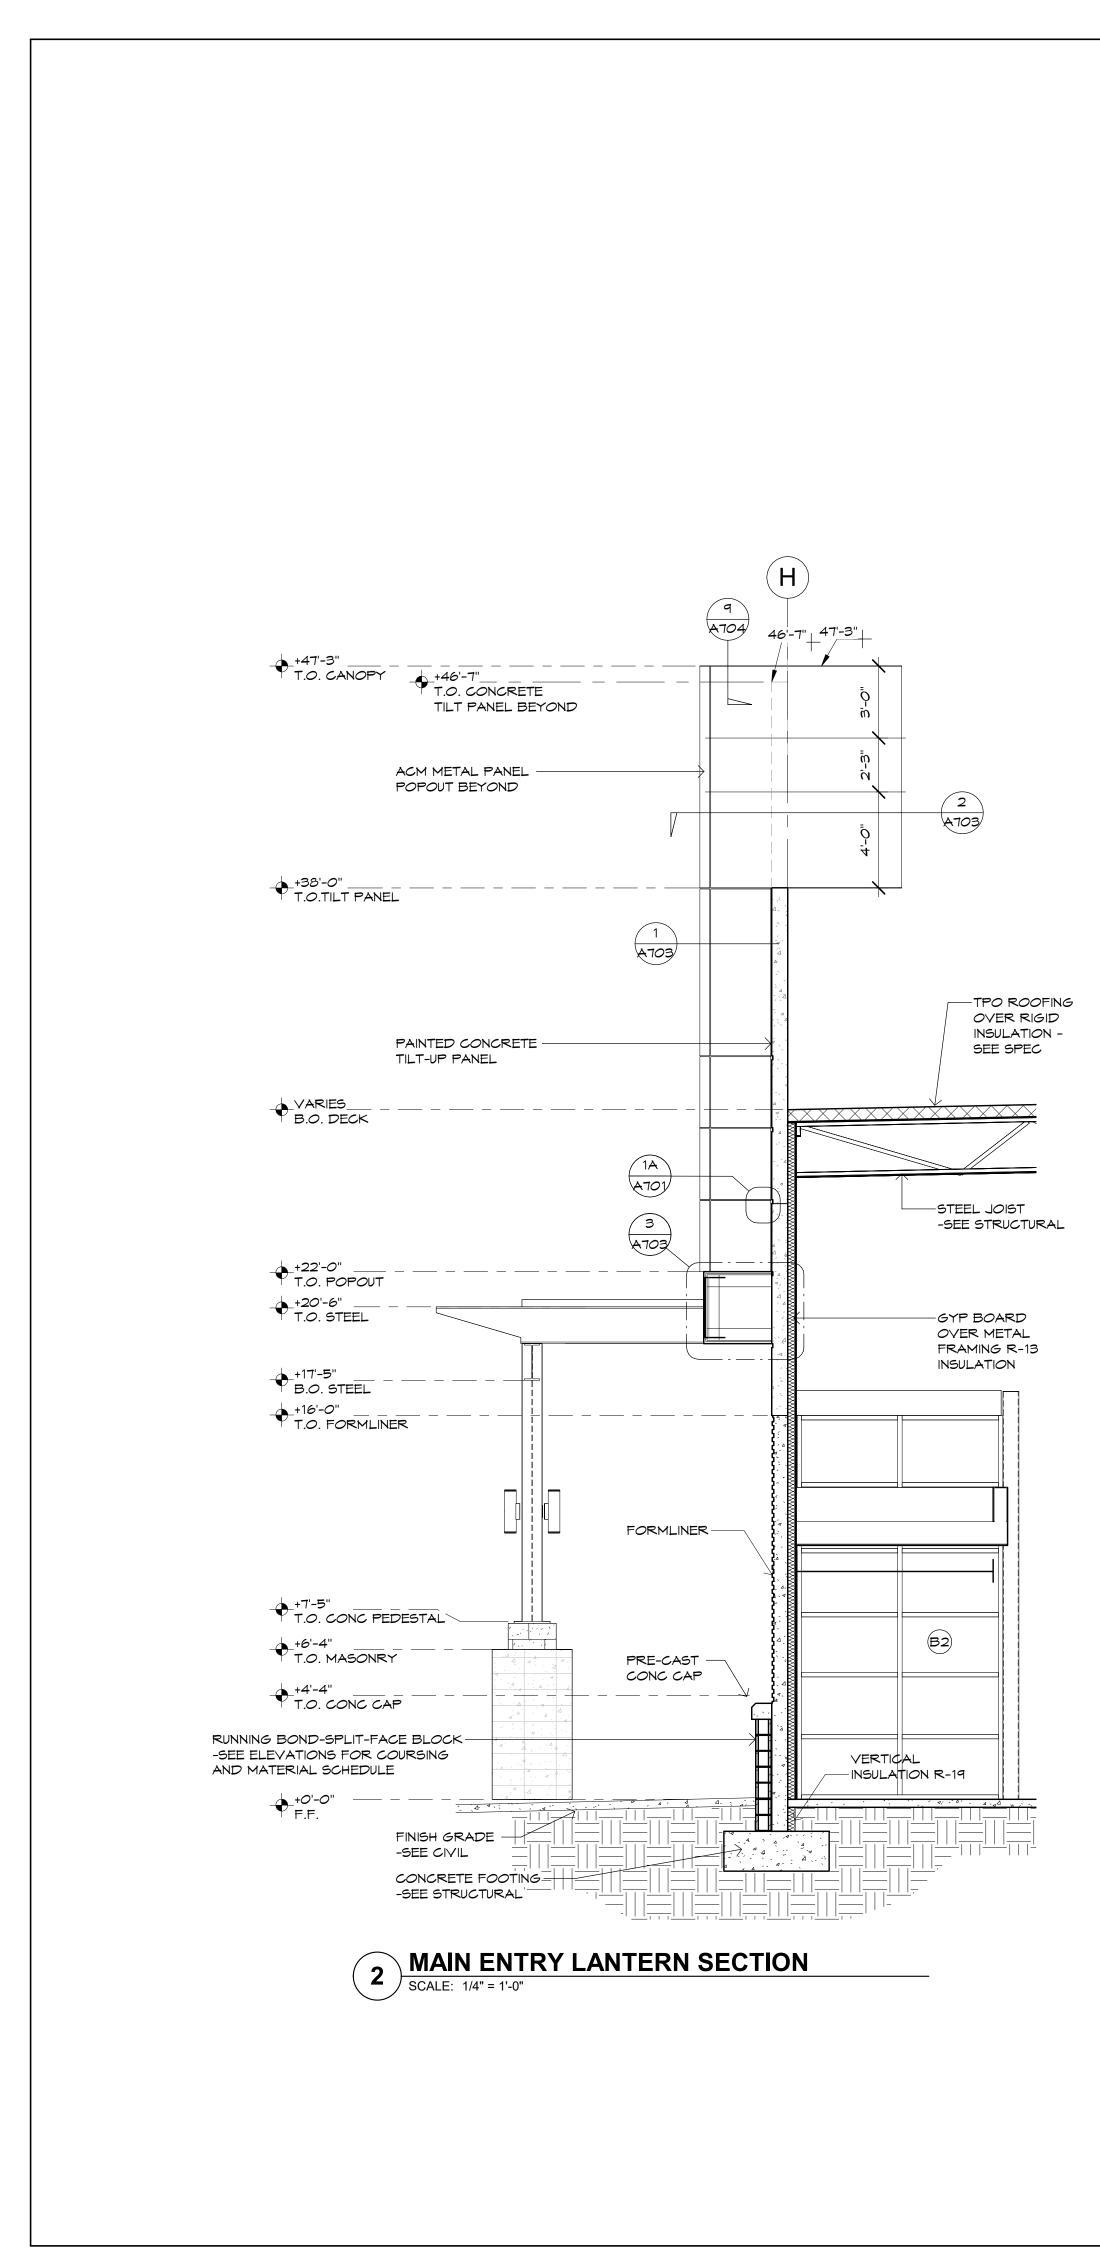


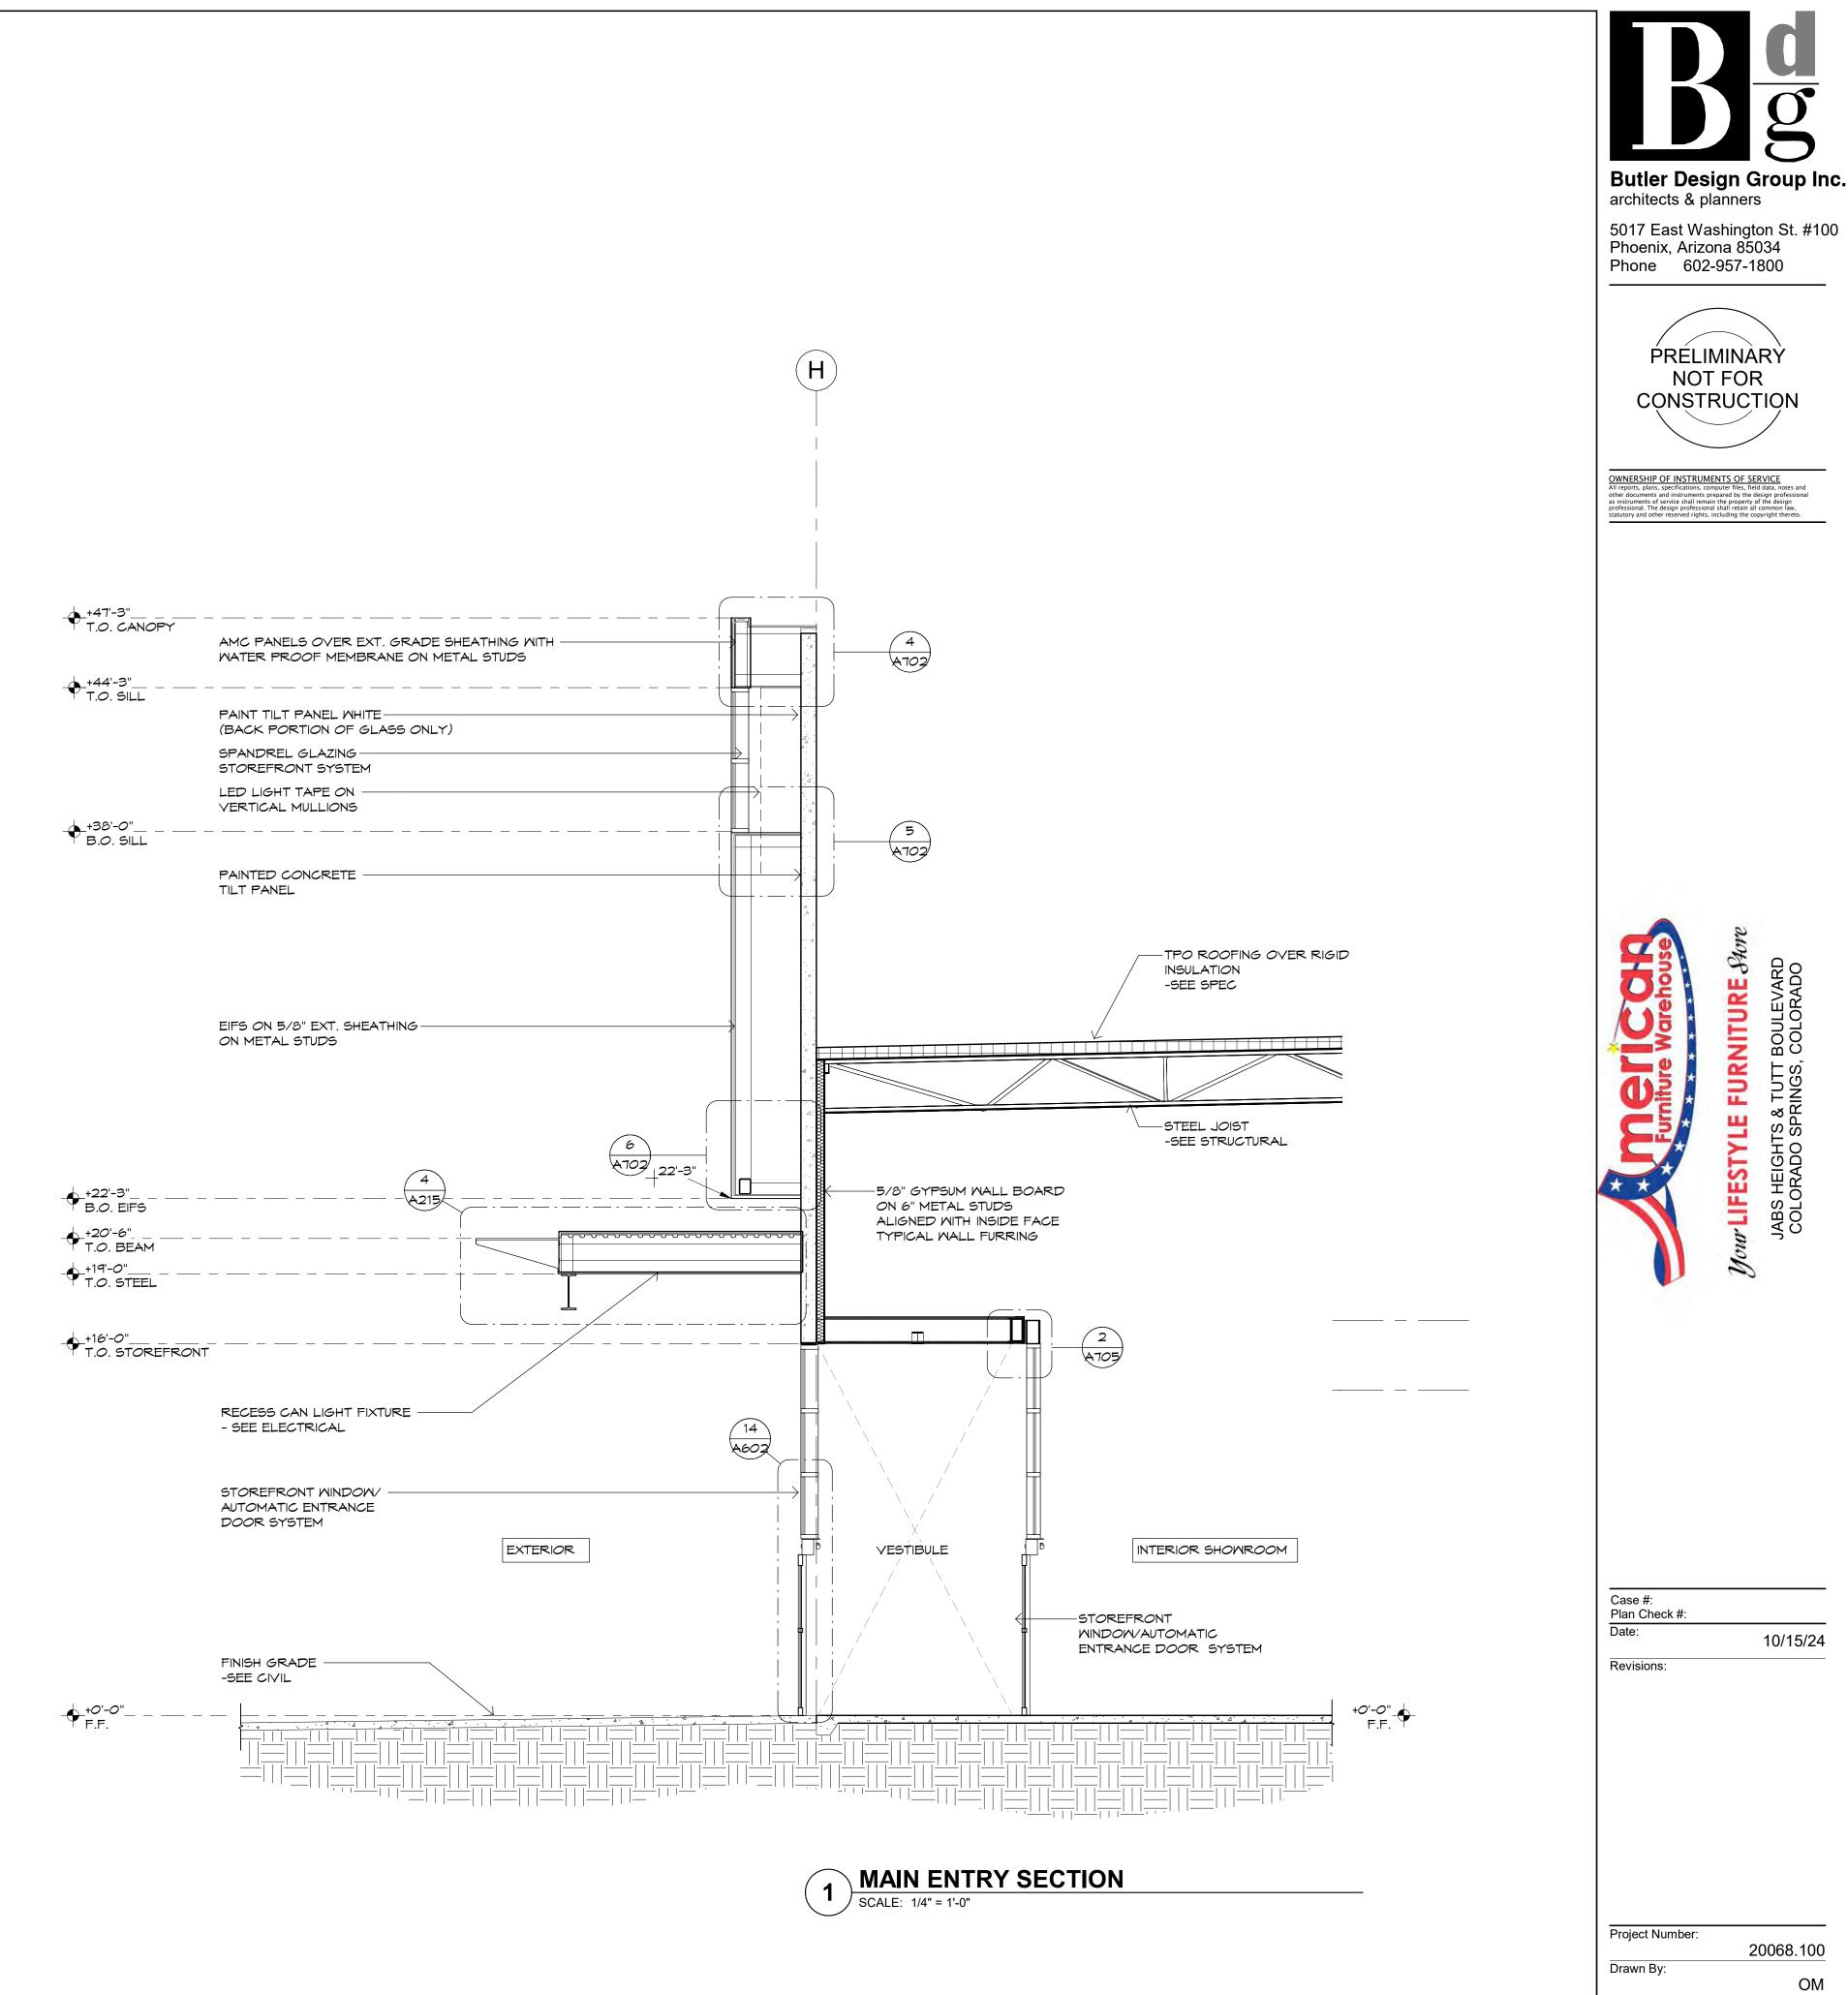



A504

WALL SECTIONS

Title:

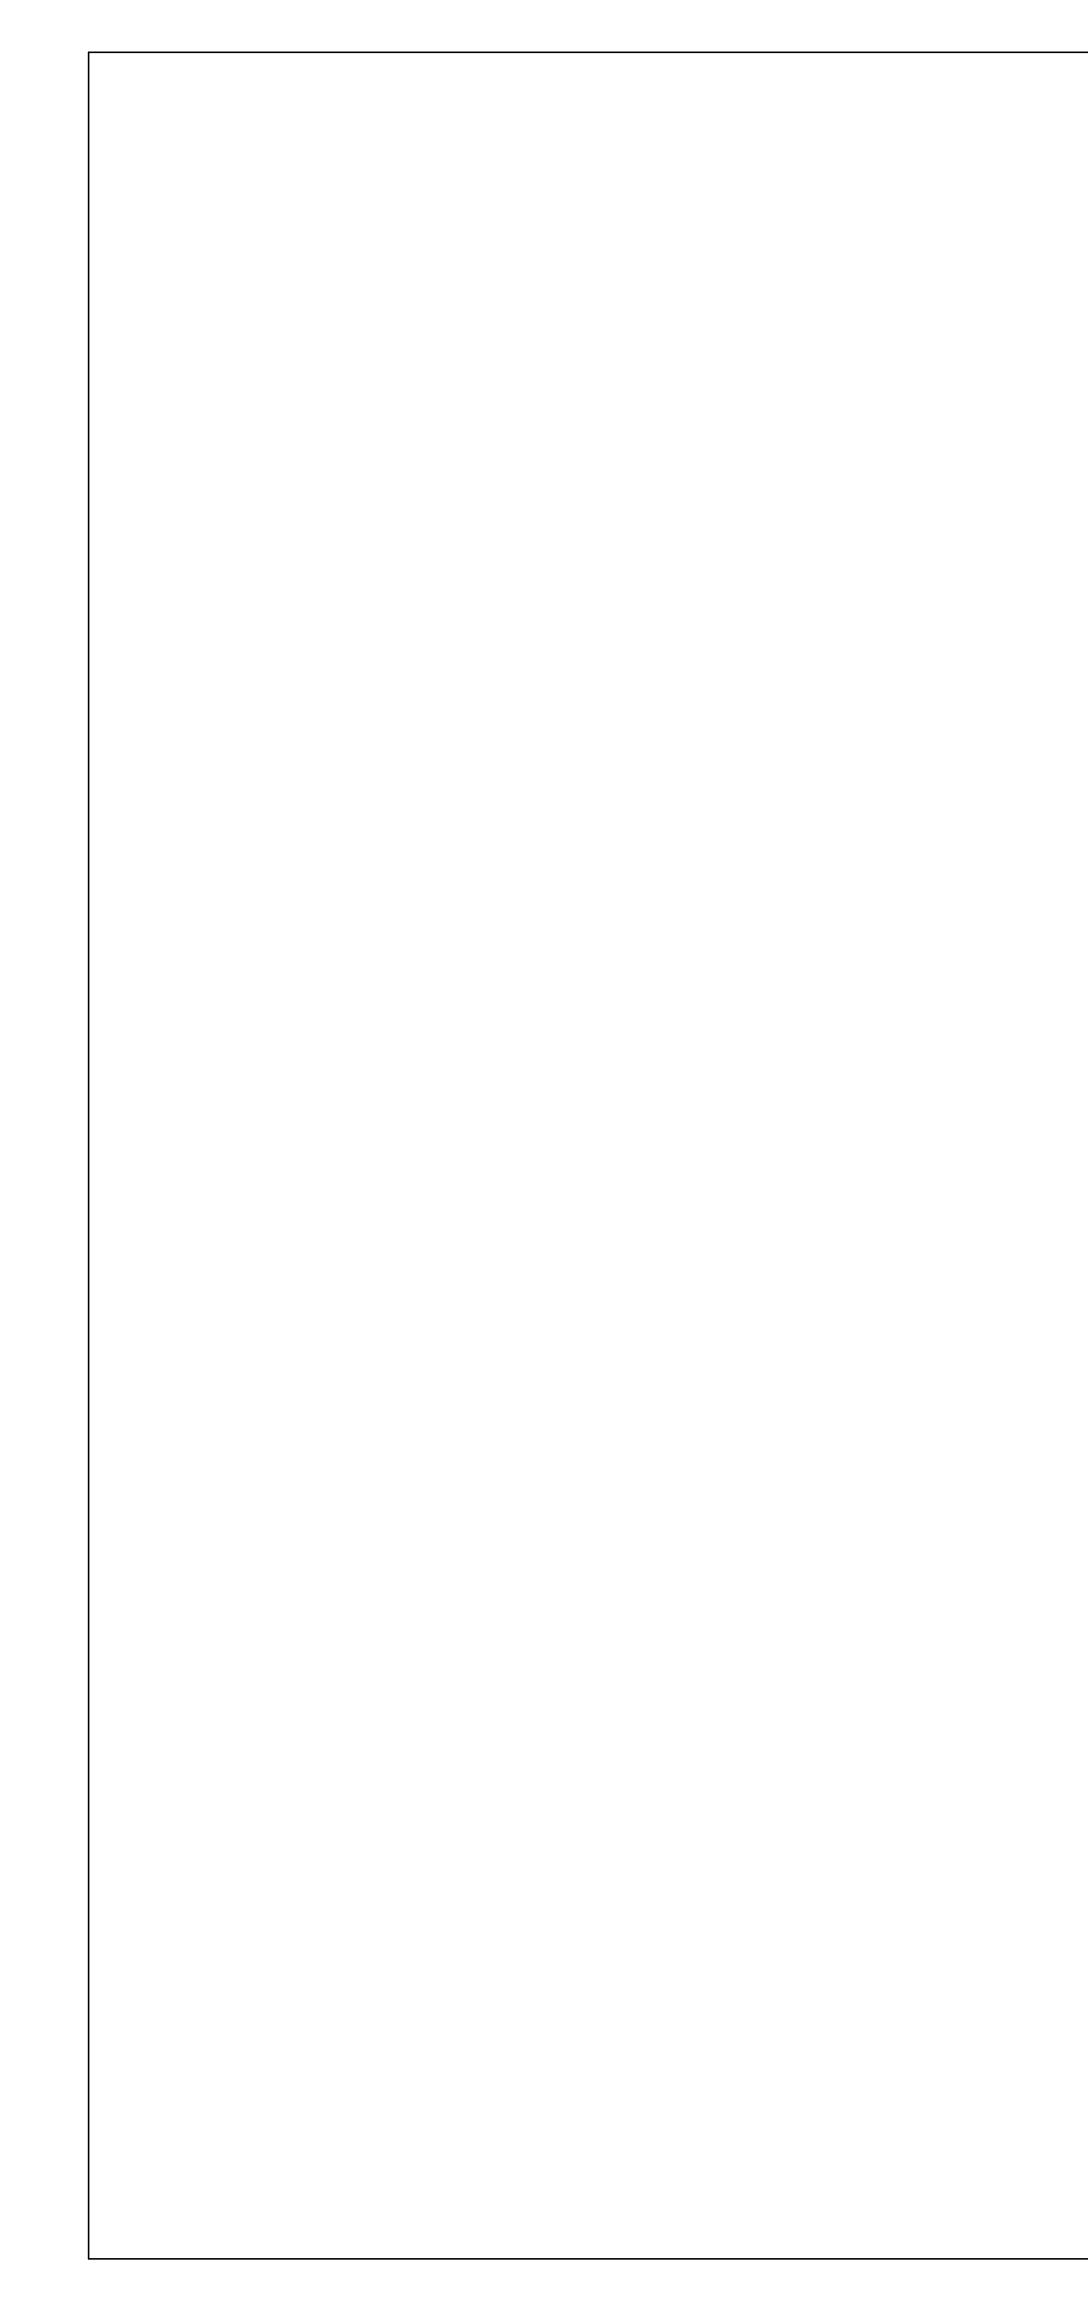

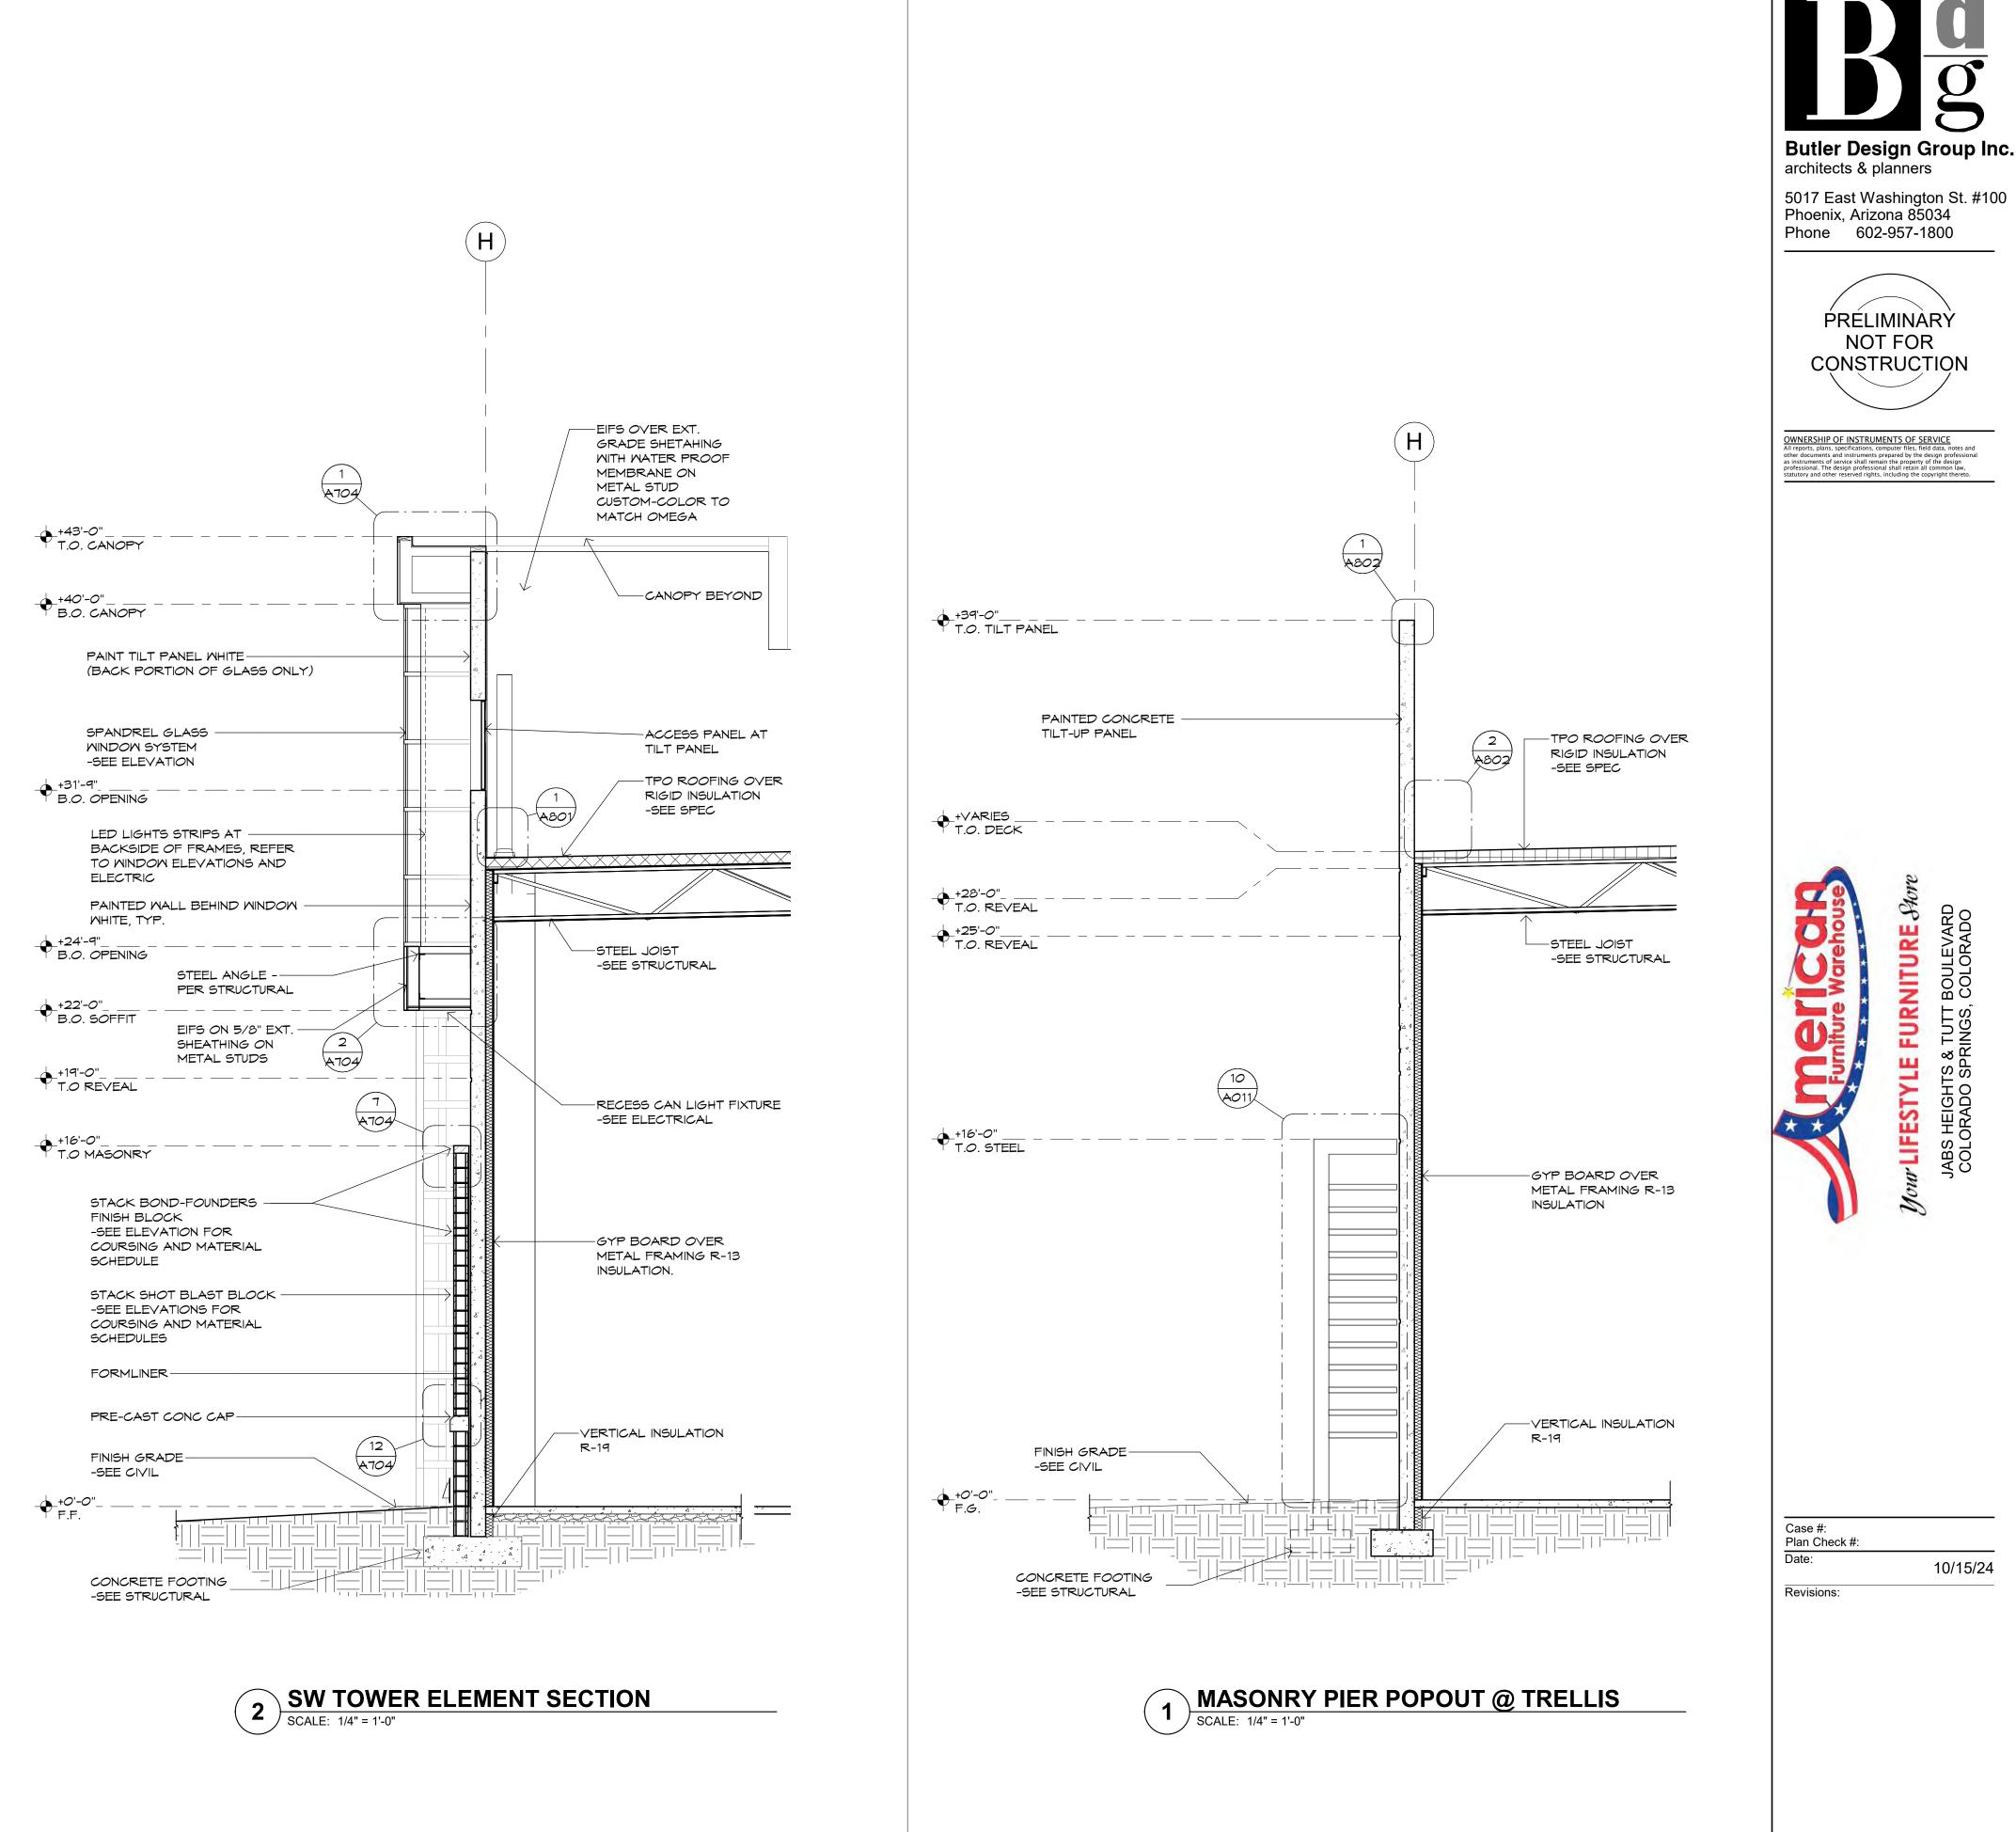

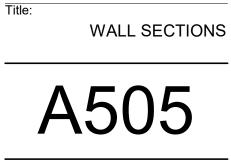


20068.100

OM

Project Number:

Drawn By:



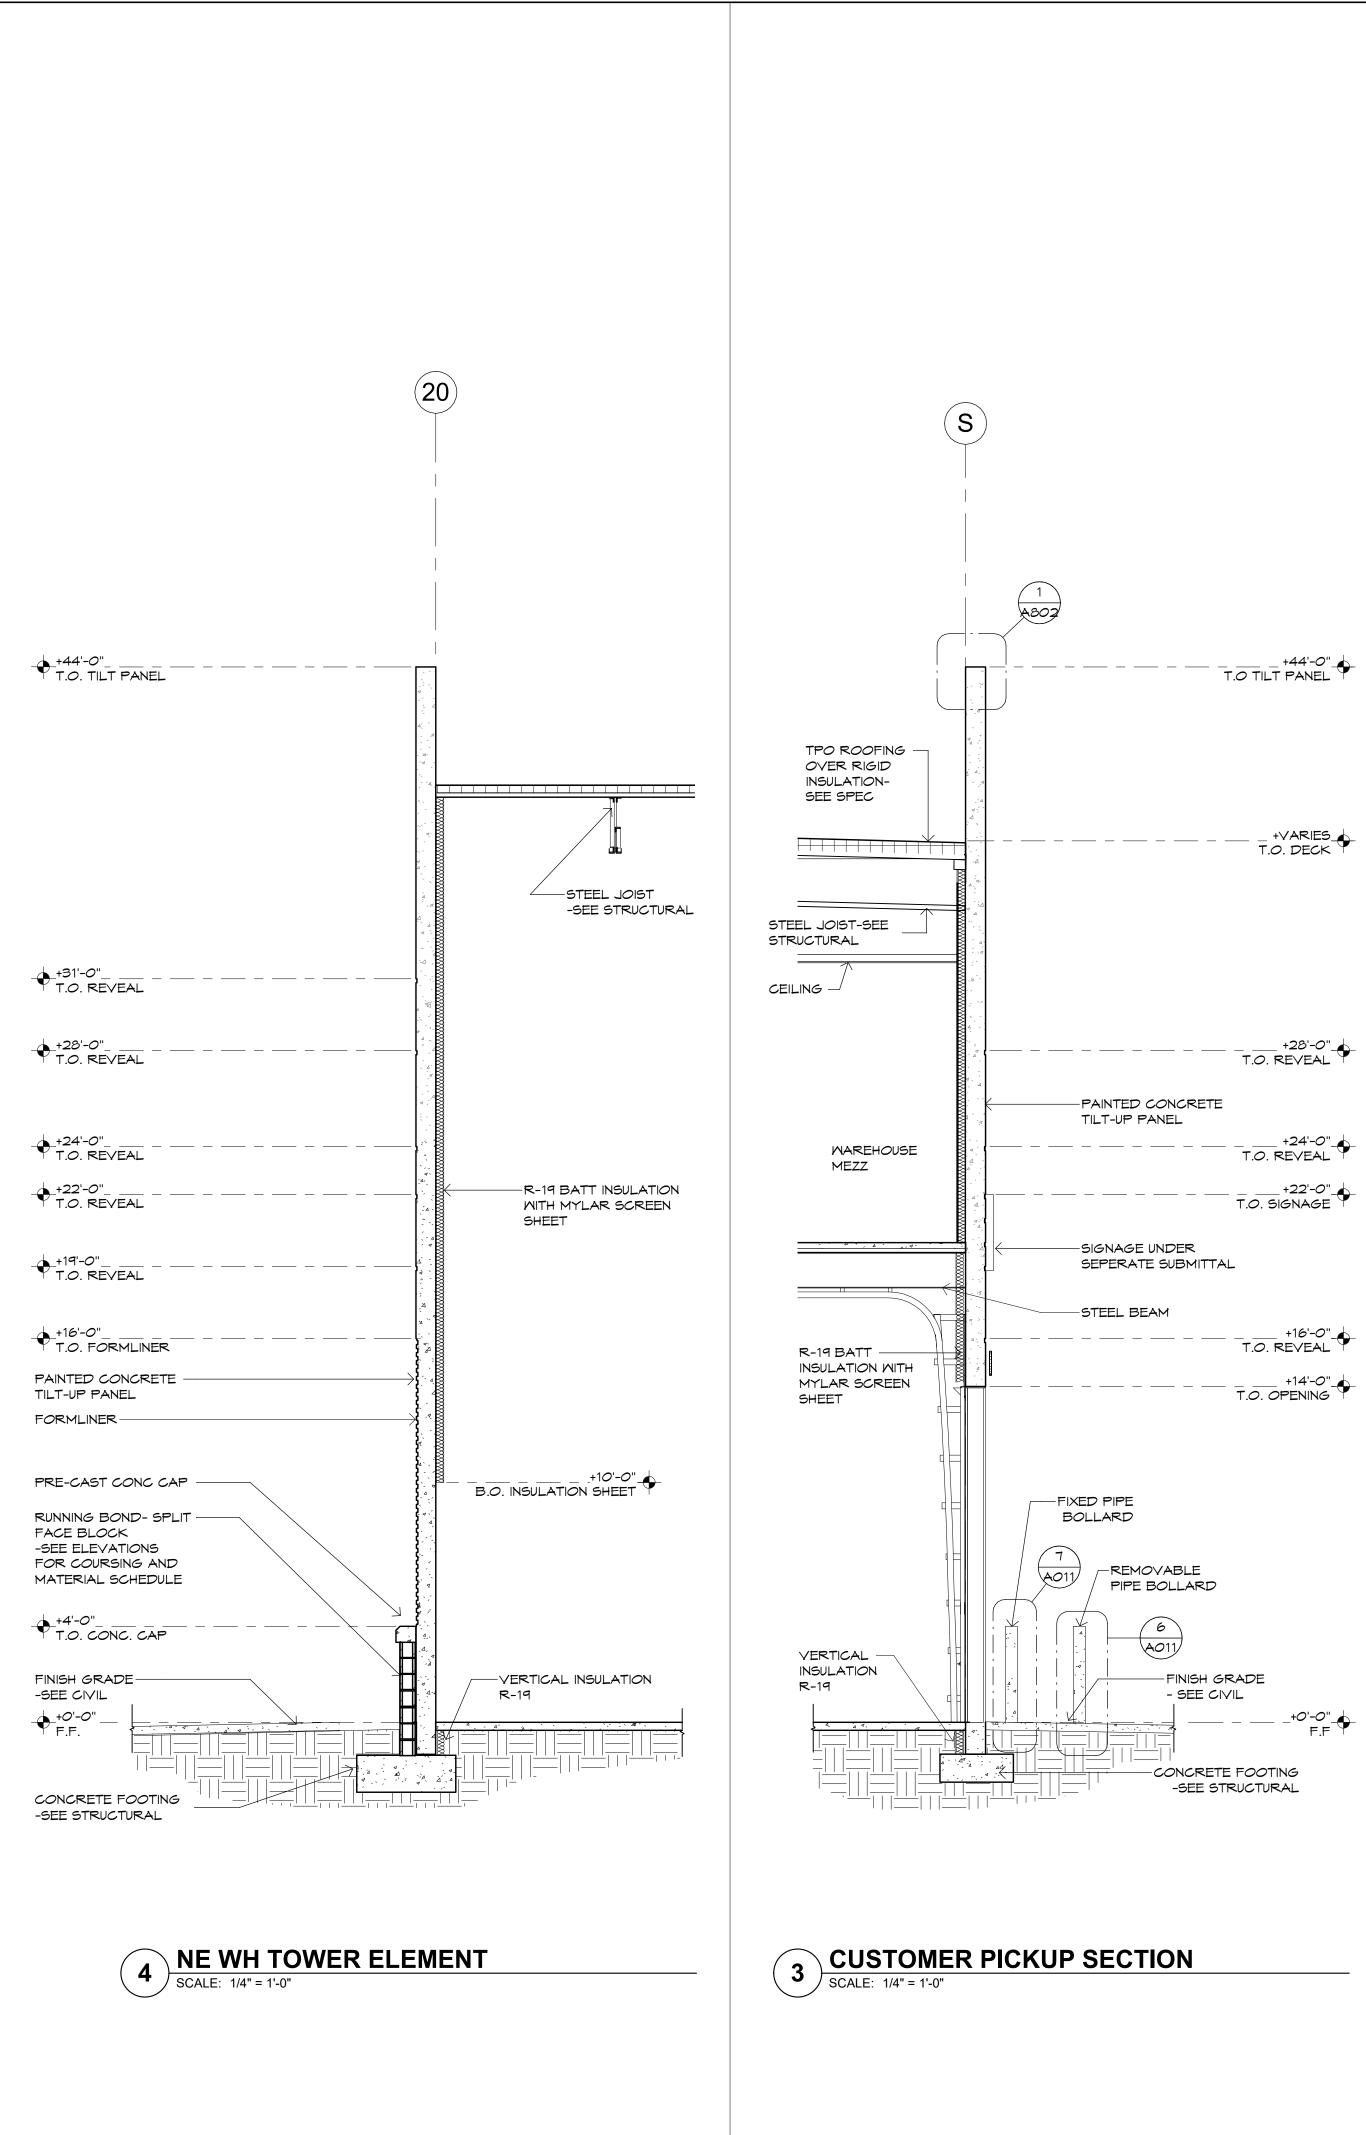

E	
	+24'-0"- T.O. REVEAL
	+22'-0"

CONCRETE -TILT PANEL BEYOND

TPO ROOFING -

OVER RIGID

INSULATION

-SEE SPEC

STEEL JOIST - SEE STRUCTURAL-

6 A705

-7-

-+

SPANDREL TILT PANEL

LINE OF MEZZANINE

DECK BEYOND -----

+20'-0"\_\_\_\_\_\_ T.O. MEZZANINE

+17'-2"\_\_\_\_\_ T.O. OPENING

BEYOND

BEYOND

+13'-1"\_\_\_\_\_\_ T.O. OPENING

LINE OF TILT -

PANEL OPENING

CUSTOMER PICKUP -

COUNTER BEYOND

DECK BEYOND

GYP BOARD OVER METAL FRAMING R-13 INSULATION

S

 $\begin{pmatrix} 1 \end{pmatrix}$ 

A802

-CONCRETE TILT

PANEL BEYOND \_\_\_\_ +38'-0"\_\_\_\_ T.O. PANEL

\_\_\_\_\_\_+31'-0"\_\_\_\_\_ T.O. REVEAL

T.O. REVEAL

AMC PANELS OVER EXT. GRADE-

\_ +28'-0"\_\_\_\_

\_\_\_\_ \_ +25'-0"\_\_\_\_ T.O. REVEAL (10) A705 -+22'-0" T.O. CANOPY

B.O. CANOPY -CARRIER BEAM

-SEE STRUCTURAL (D2) (H) (D)-STEEL COLUMN -SEE STRUCTURAL -WINDOW SYSTEM BEYOND

SHEATHING WITH WATER PROOF

MEMBRANE ON METAL STUDS

\_ \_ \_ \_ \_ \_ RECESS CAN LIGHT ------


FIXTURE -SEE ELECTRICAL

 $\overline{\phantom{a}}$ 

\_\_\_\_\_\_


15 A601 │━━│ | | ━━│ | | ━━│ | | ━━│ | | ━━│ | | ━━│ | | ━━│ | | ━━│ | | ━━│

2 CU PICKUP ENTRY SECTION SCALE: 1/4" = 1'-0"

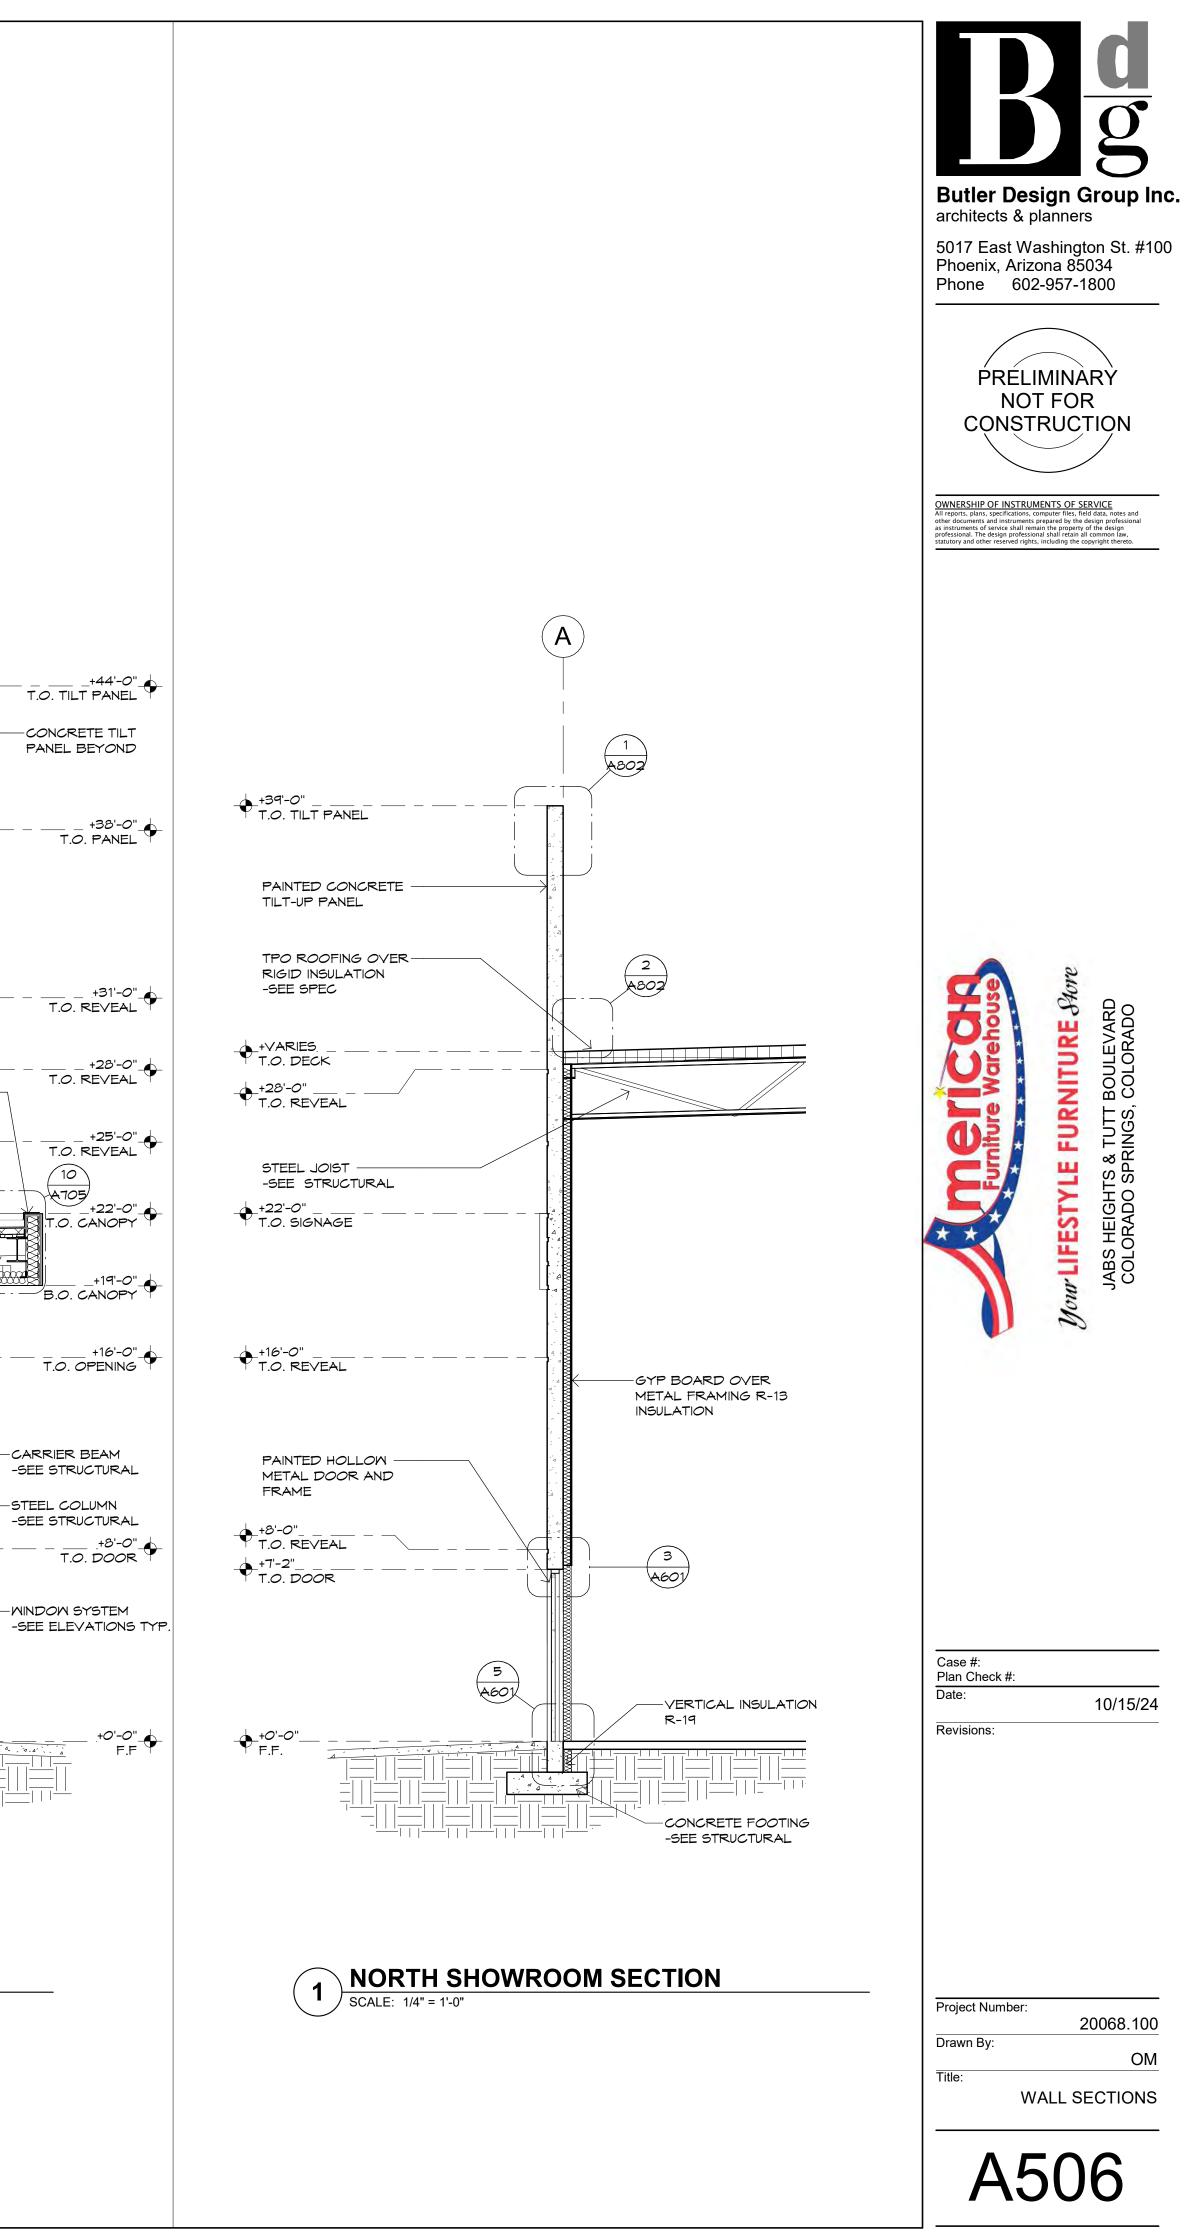



# 

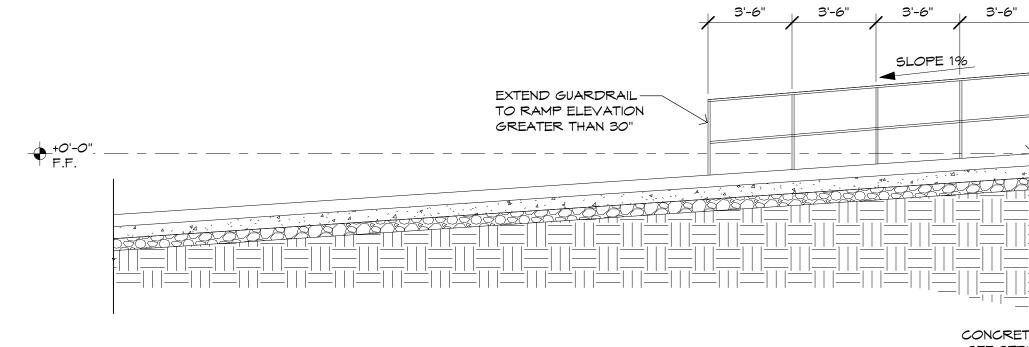

\_\_\_\_\_

### 

6" CONCRETE -----RAMP WALL

\_ \_\_\_ \_ \_\_\_

WALL PACK LIGHT\_ FIXT. -SEE ELEC.

3'-6"

3'-6"

## -+44'-0" \_\_\_\_\_ T.O. TILT PANEL

-+31'-0"\_\_\_\_ - -T.O. REVEAL


-+28'-0"\_\_\_\_ -T.O. REVEAL

+24'-0"\_\_\_\_ -T.O. REVEAL

-+22'-0"\_\_\_\_ -T.O. REVEAL


-+20'-0"\_\_\_\_\_ T.O. OPENING \_\_\_\_


\_\_\_\_\_

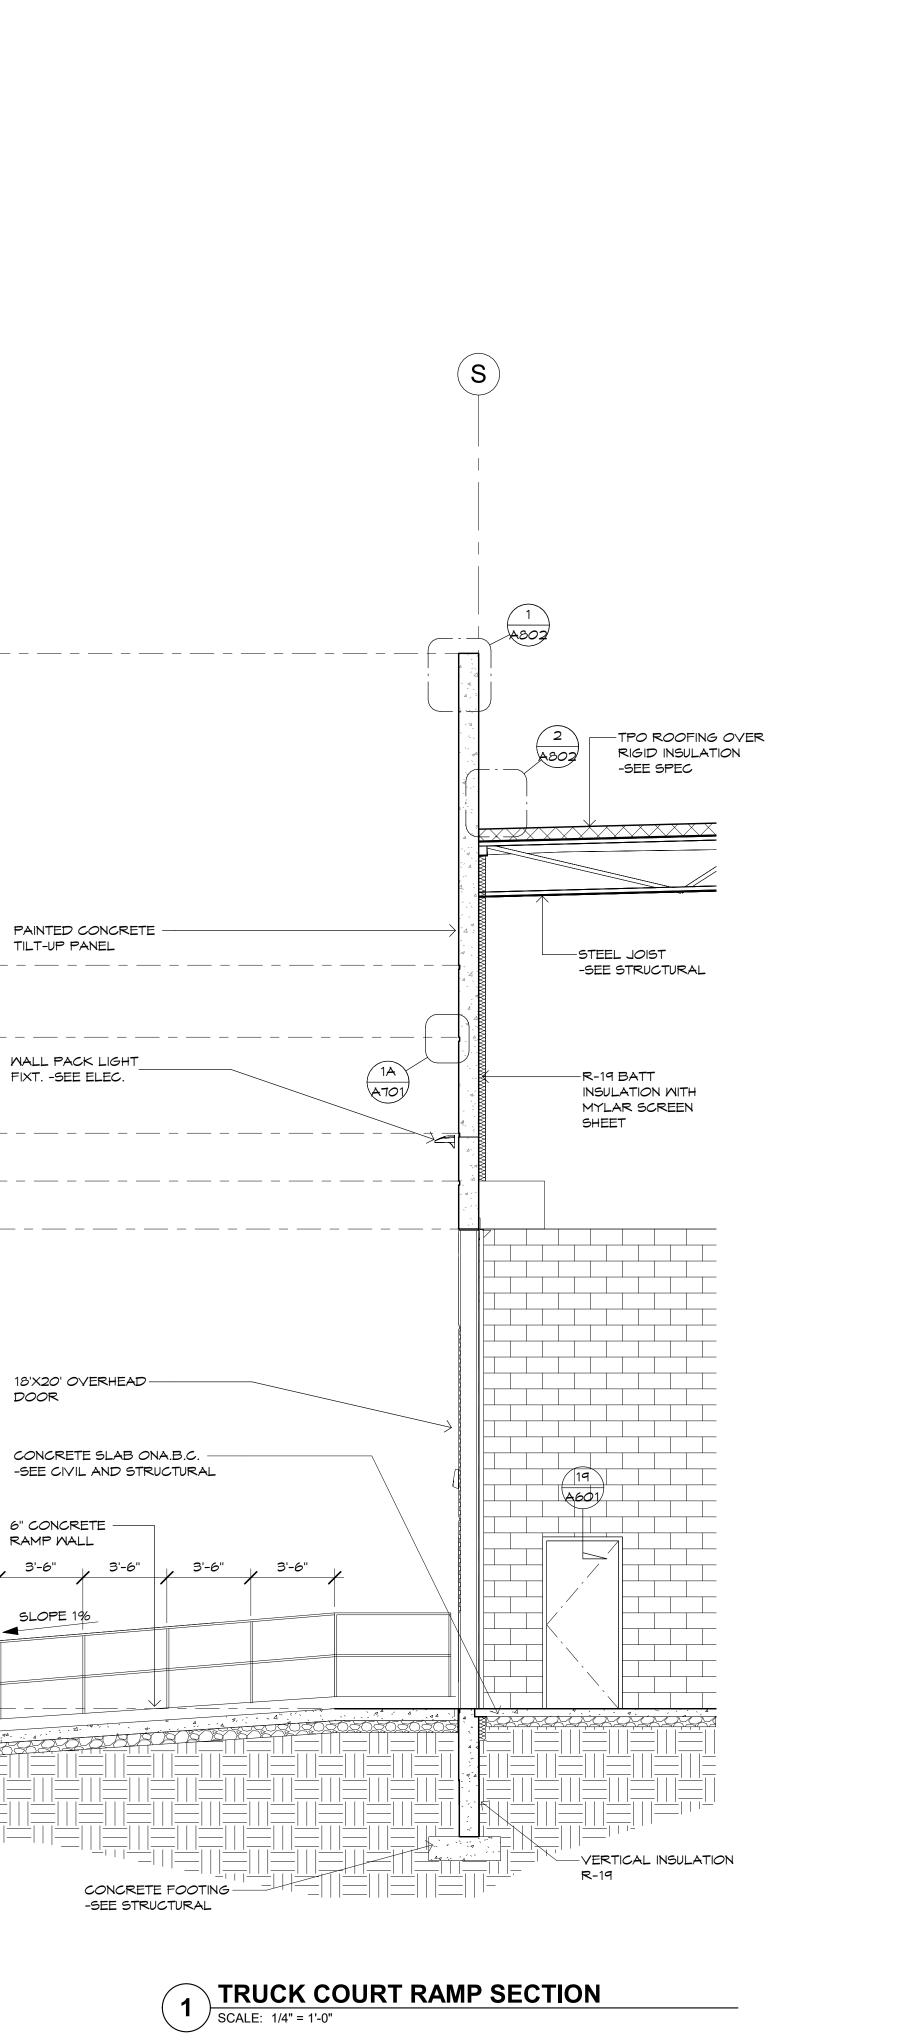



<section-header><section-header><section-header><text><text><text><text></text></text></text></text></section-header></section-header></section-header>							
statutory and other reserved rights, i	your LIFESTYLE FURNITURE <i>Store</i>	JABS HEIGHTS & TUTT BOULEVARD COLORADO SPRINGS, COLORADO COLORADO SPRINGS, COLORADO					
Case #: Plan Check #: Date: Revisions:		10/15/24					
		0068.100 OM ECTIONS					


<u>d</u> g

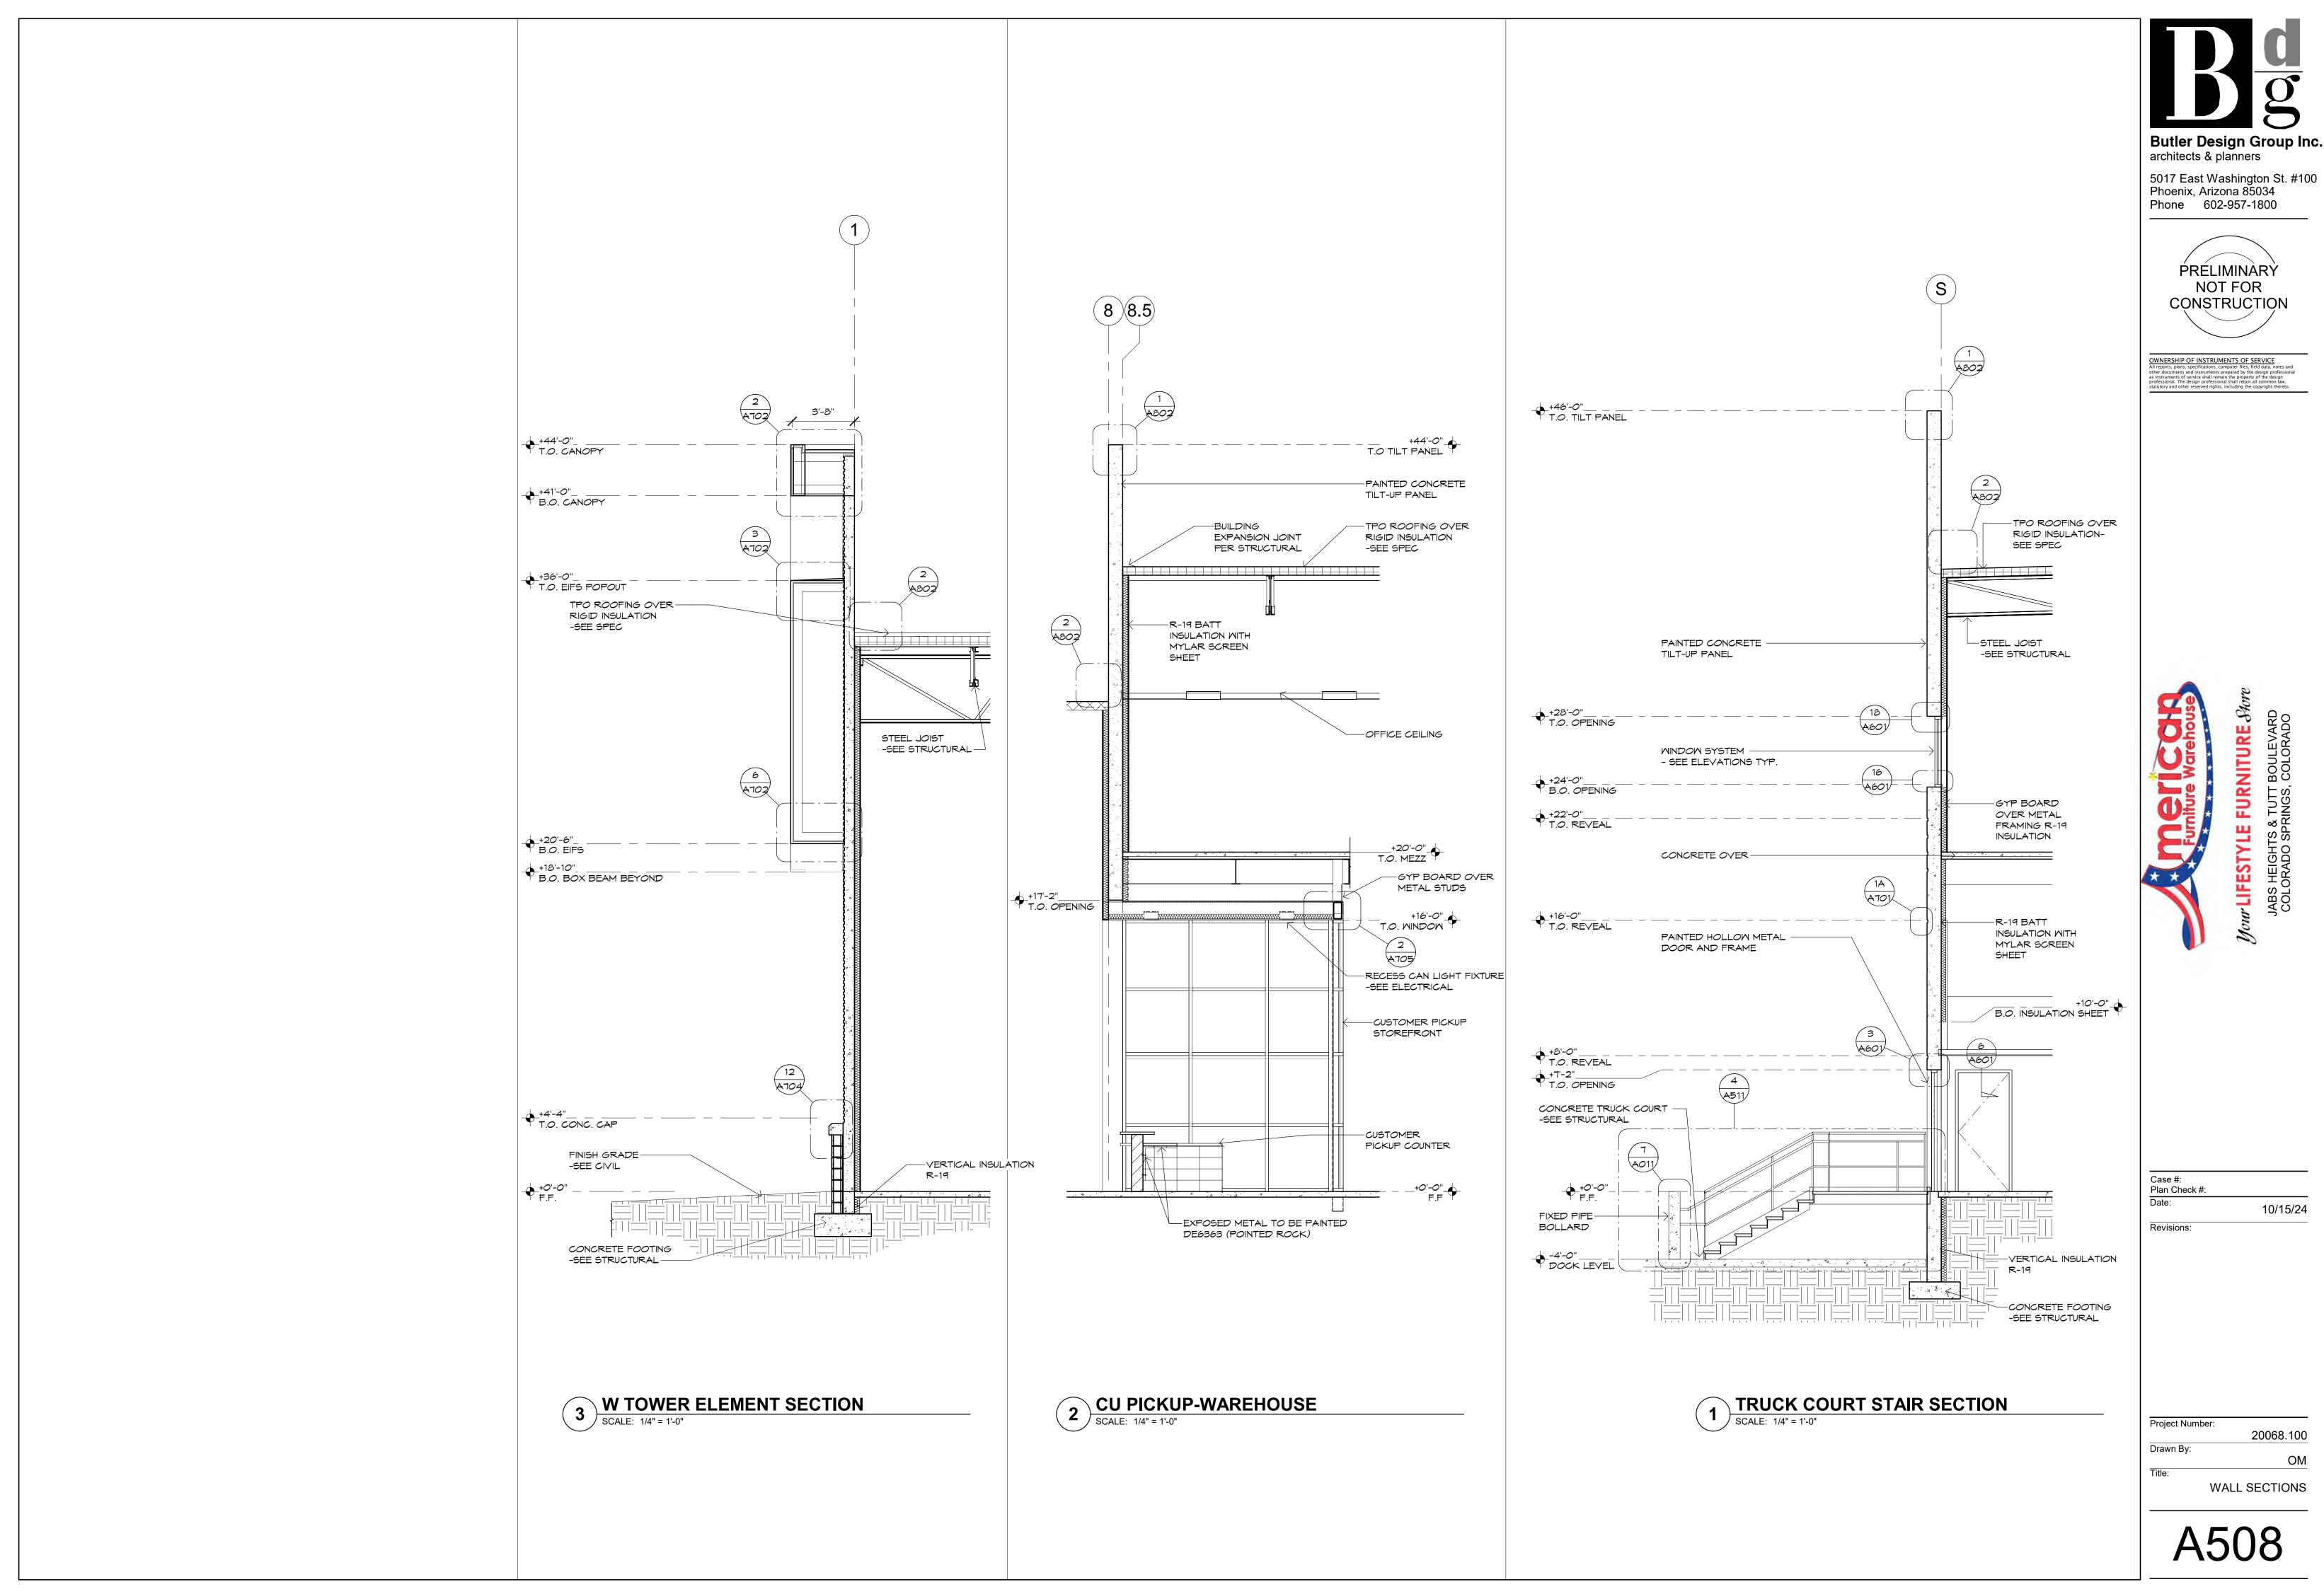


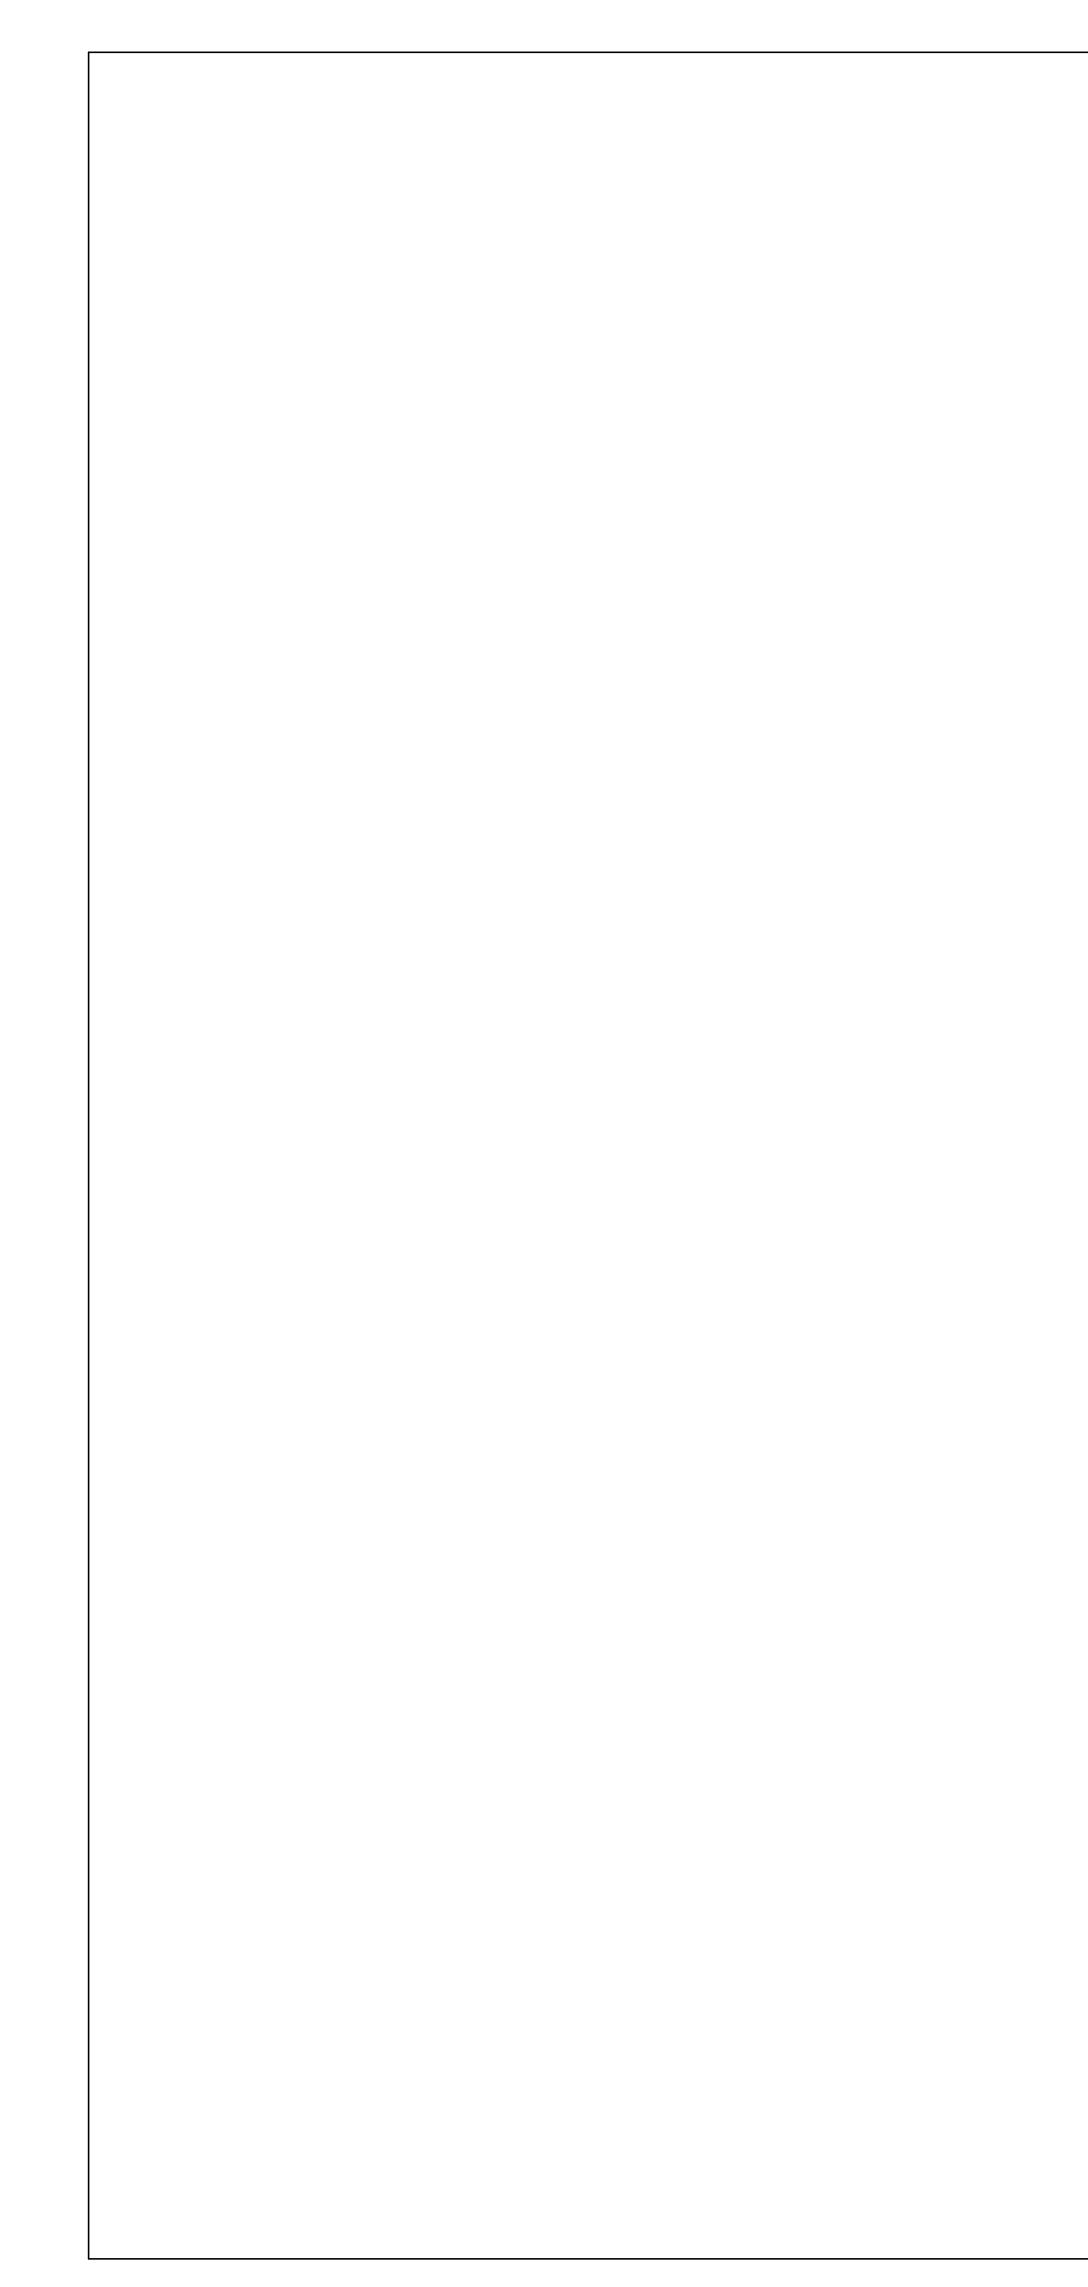


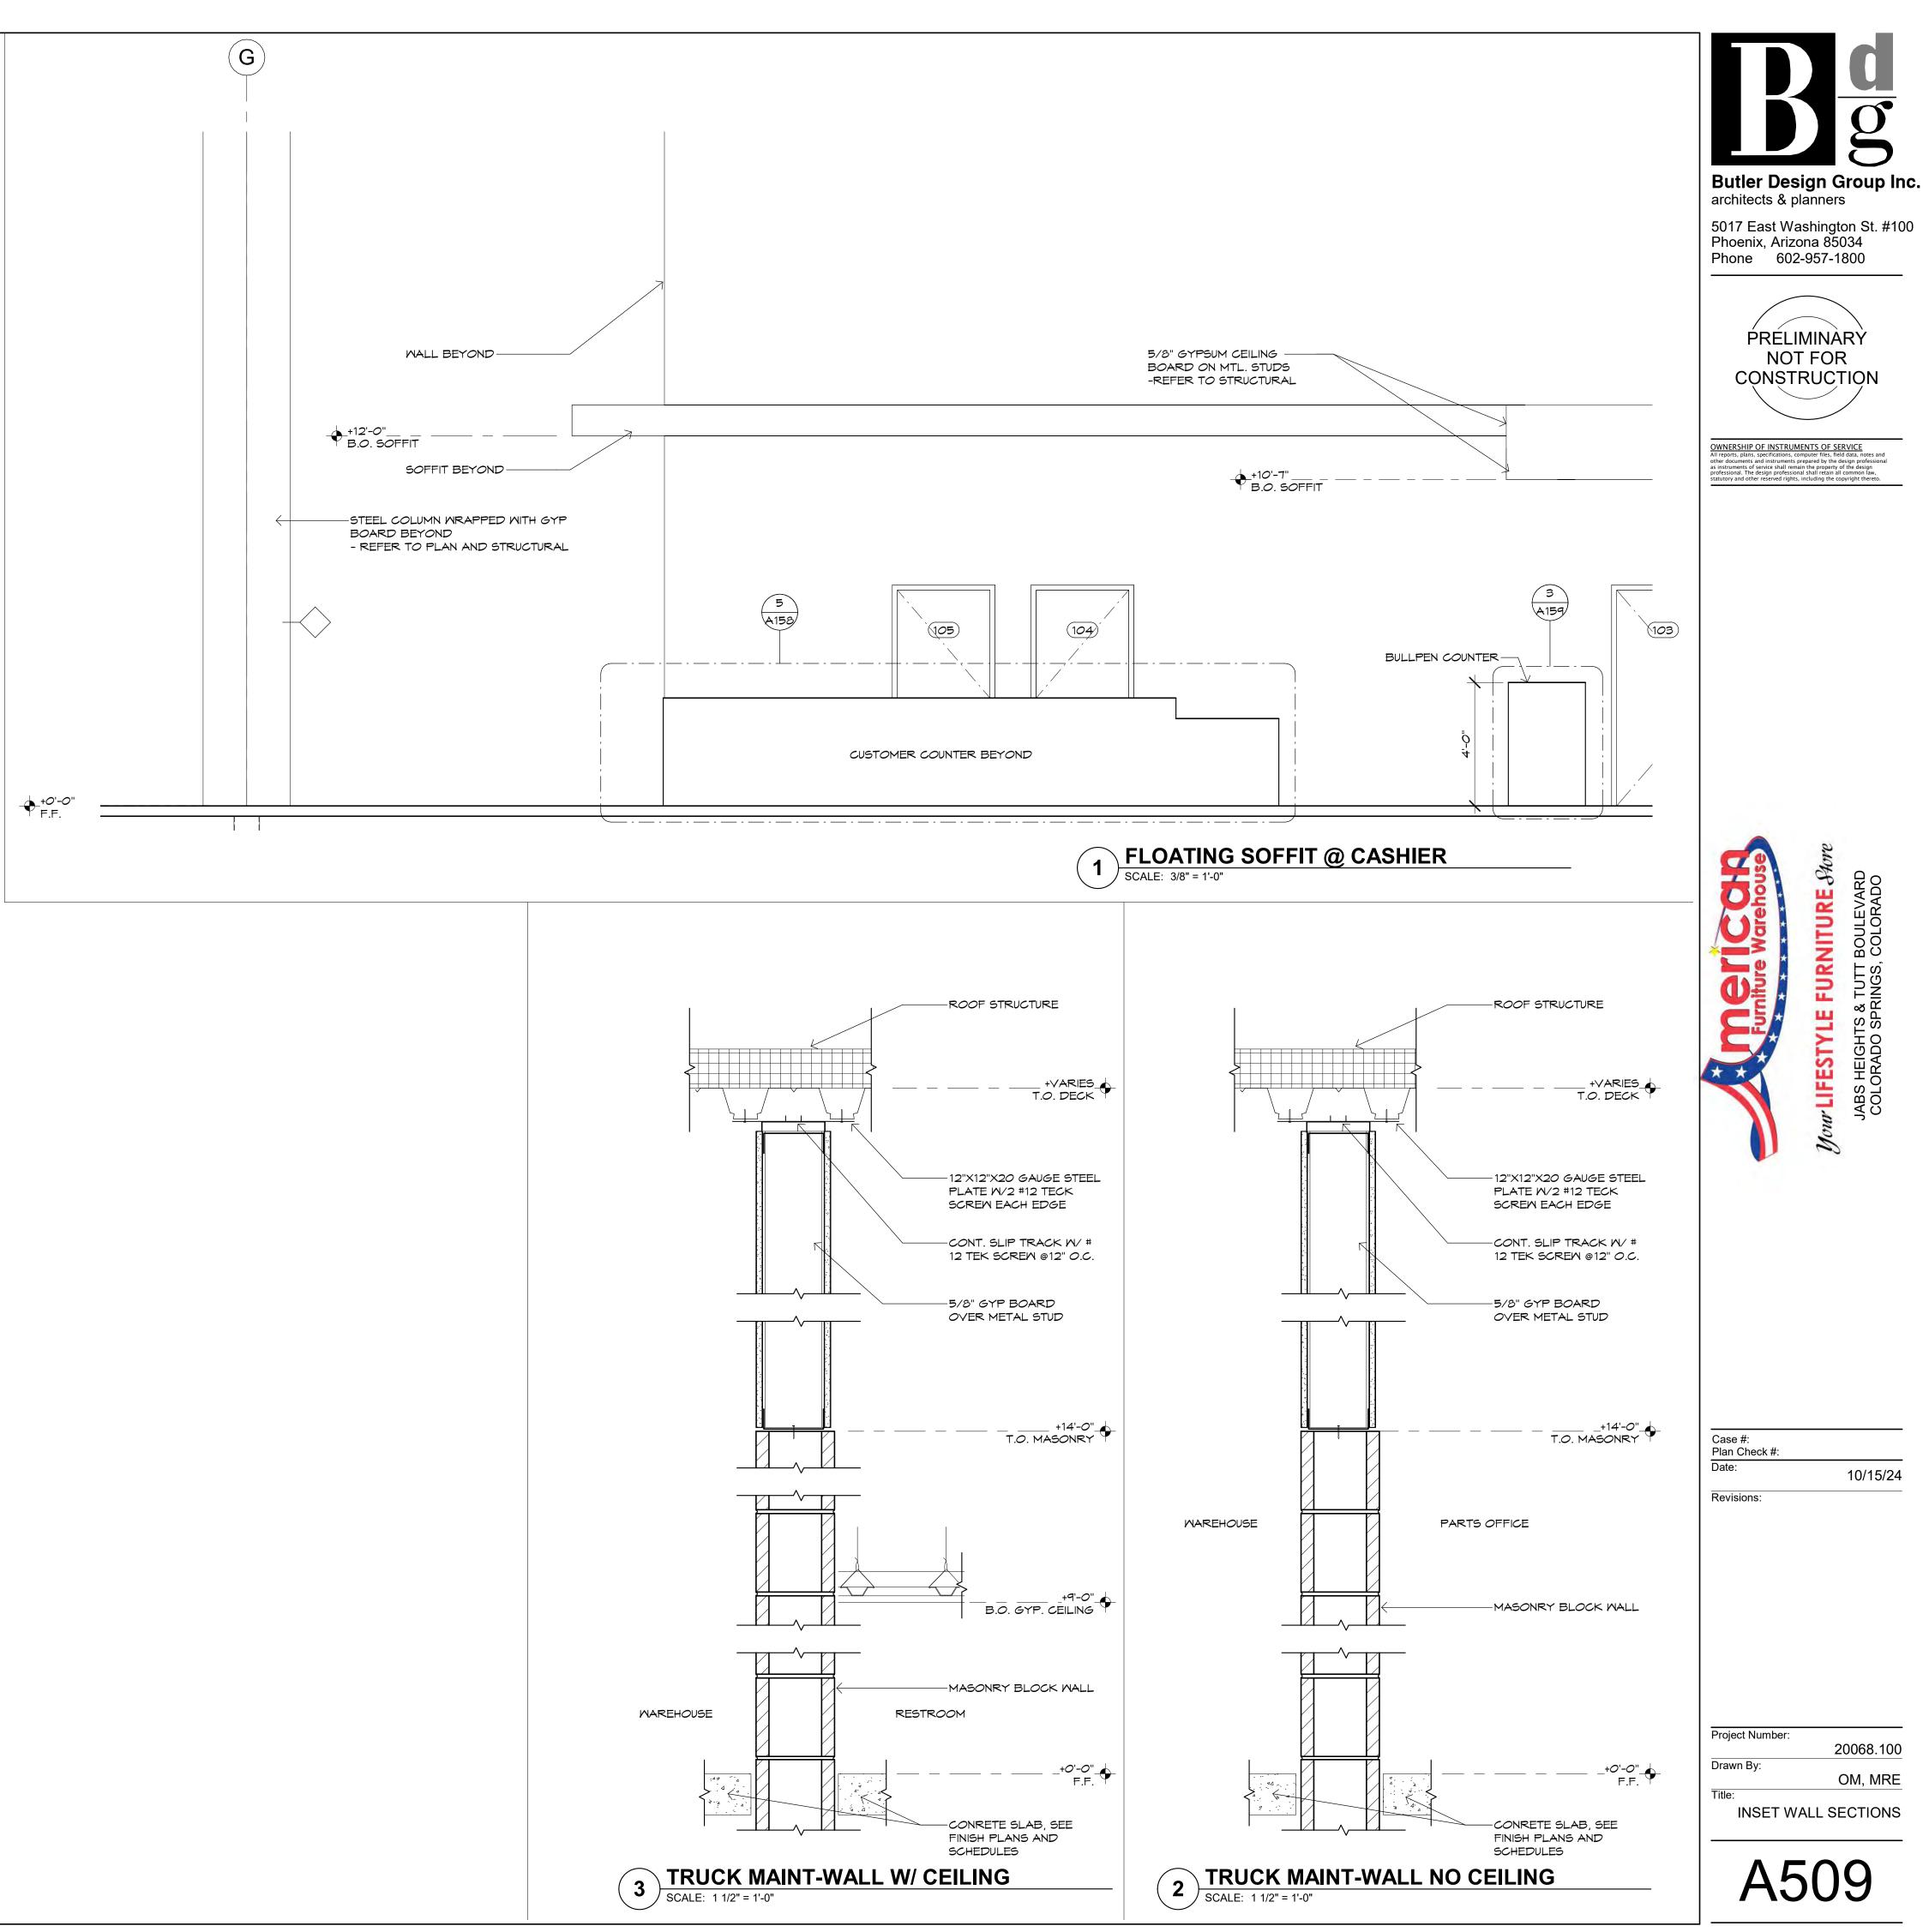


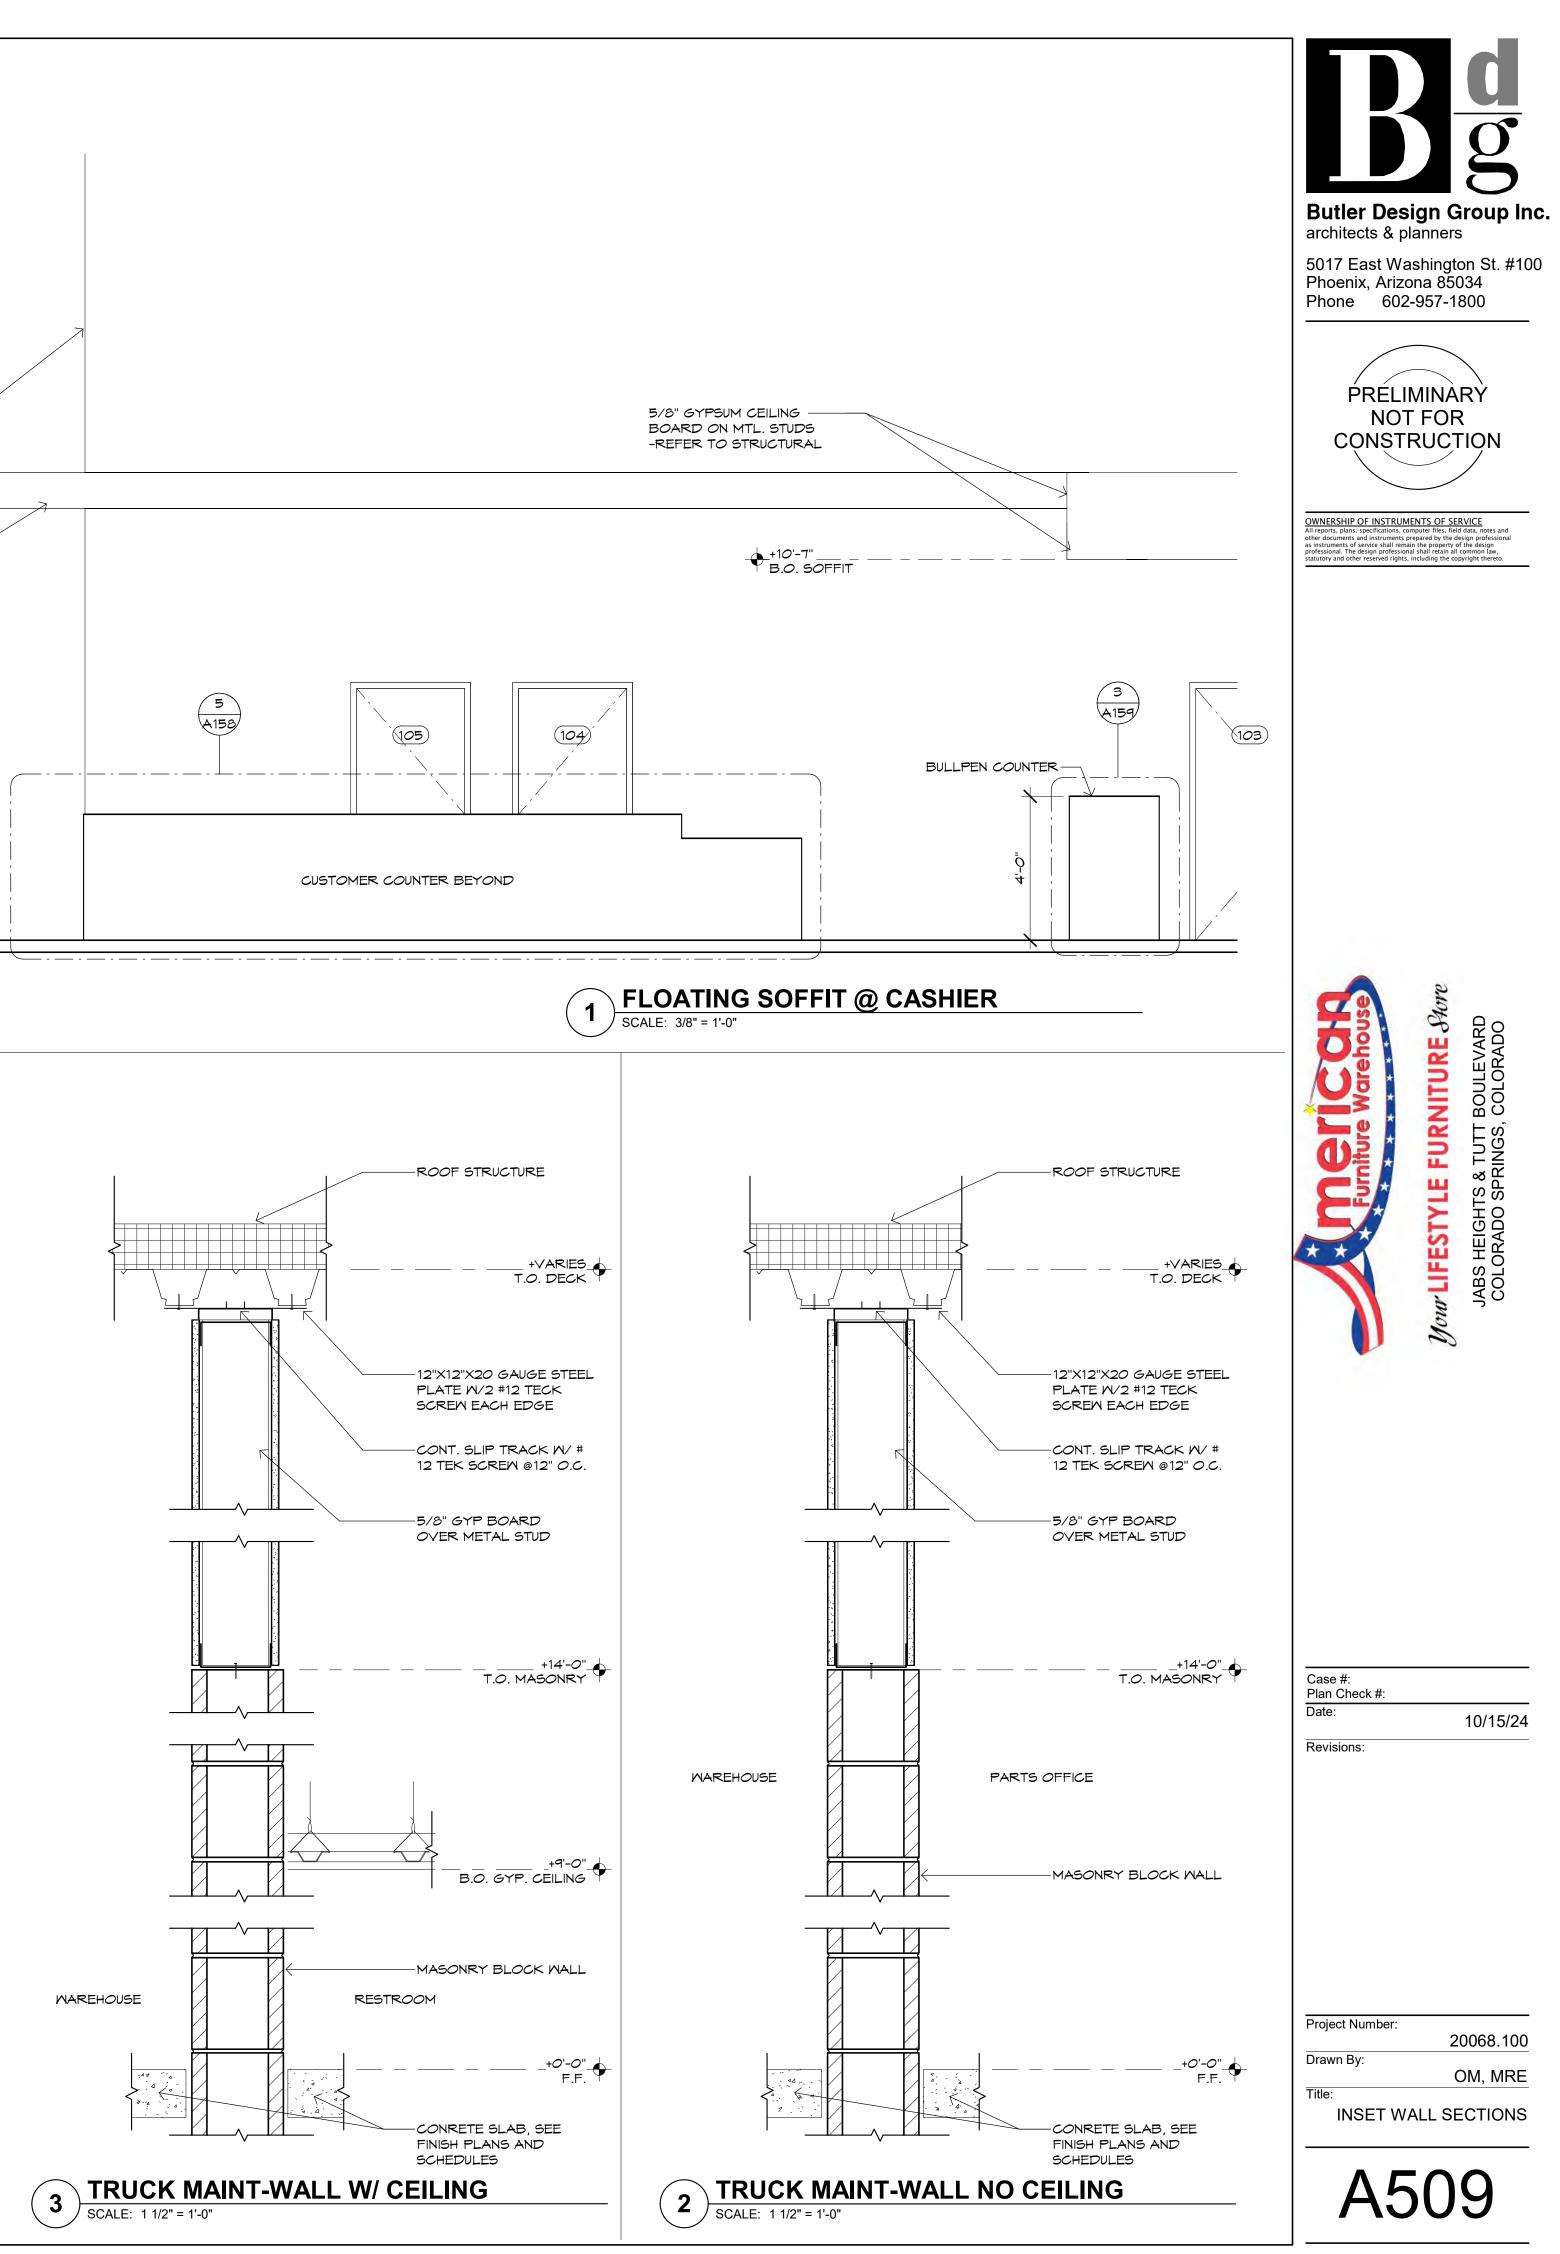


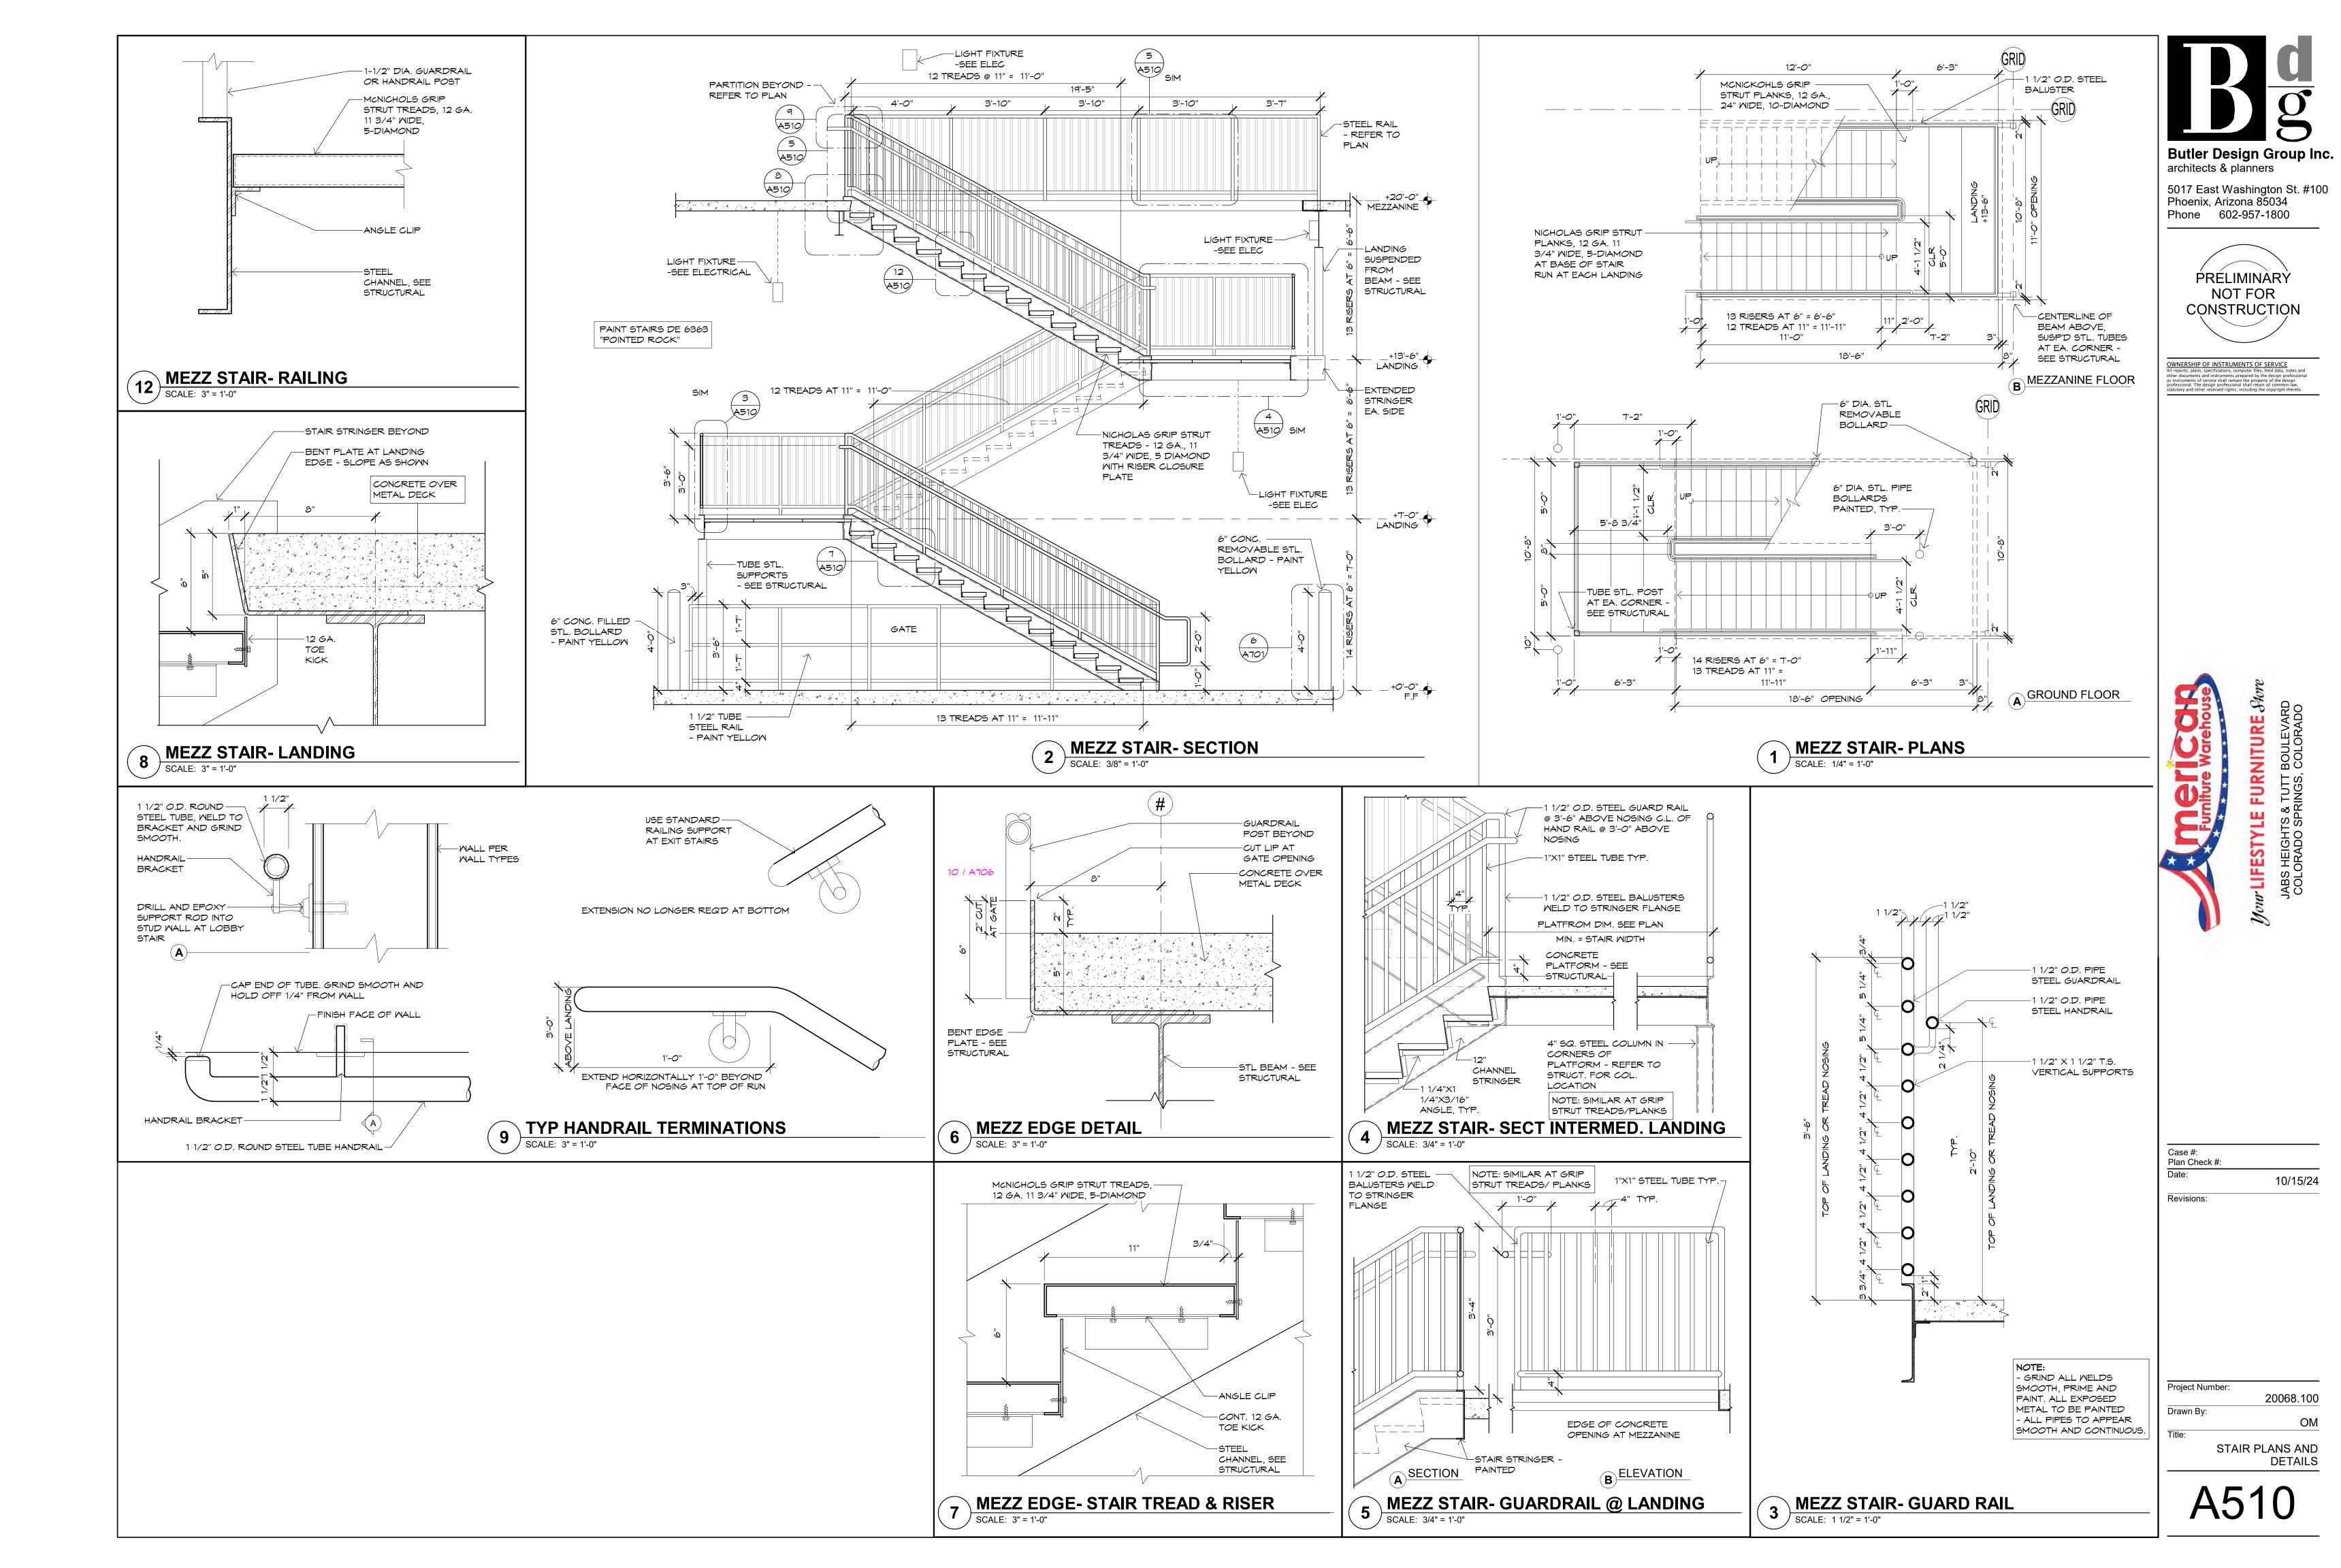


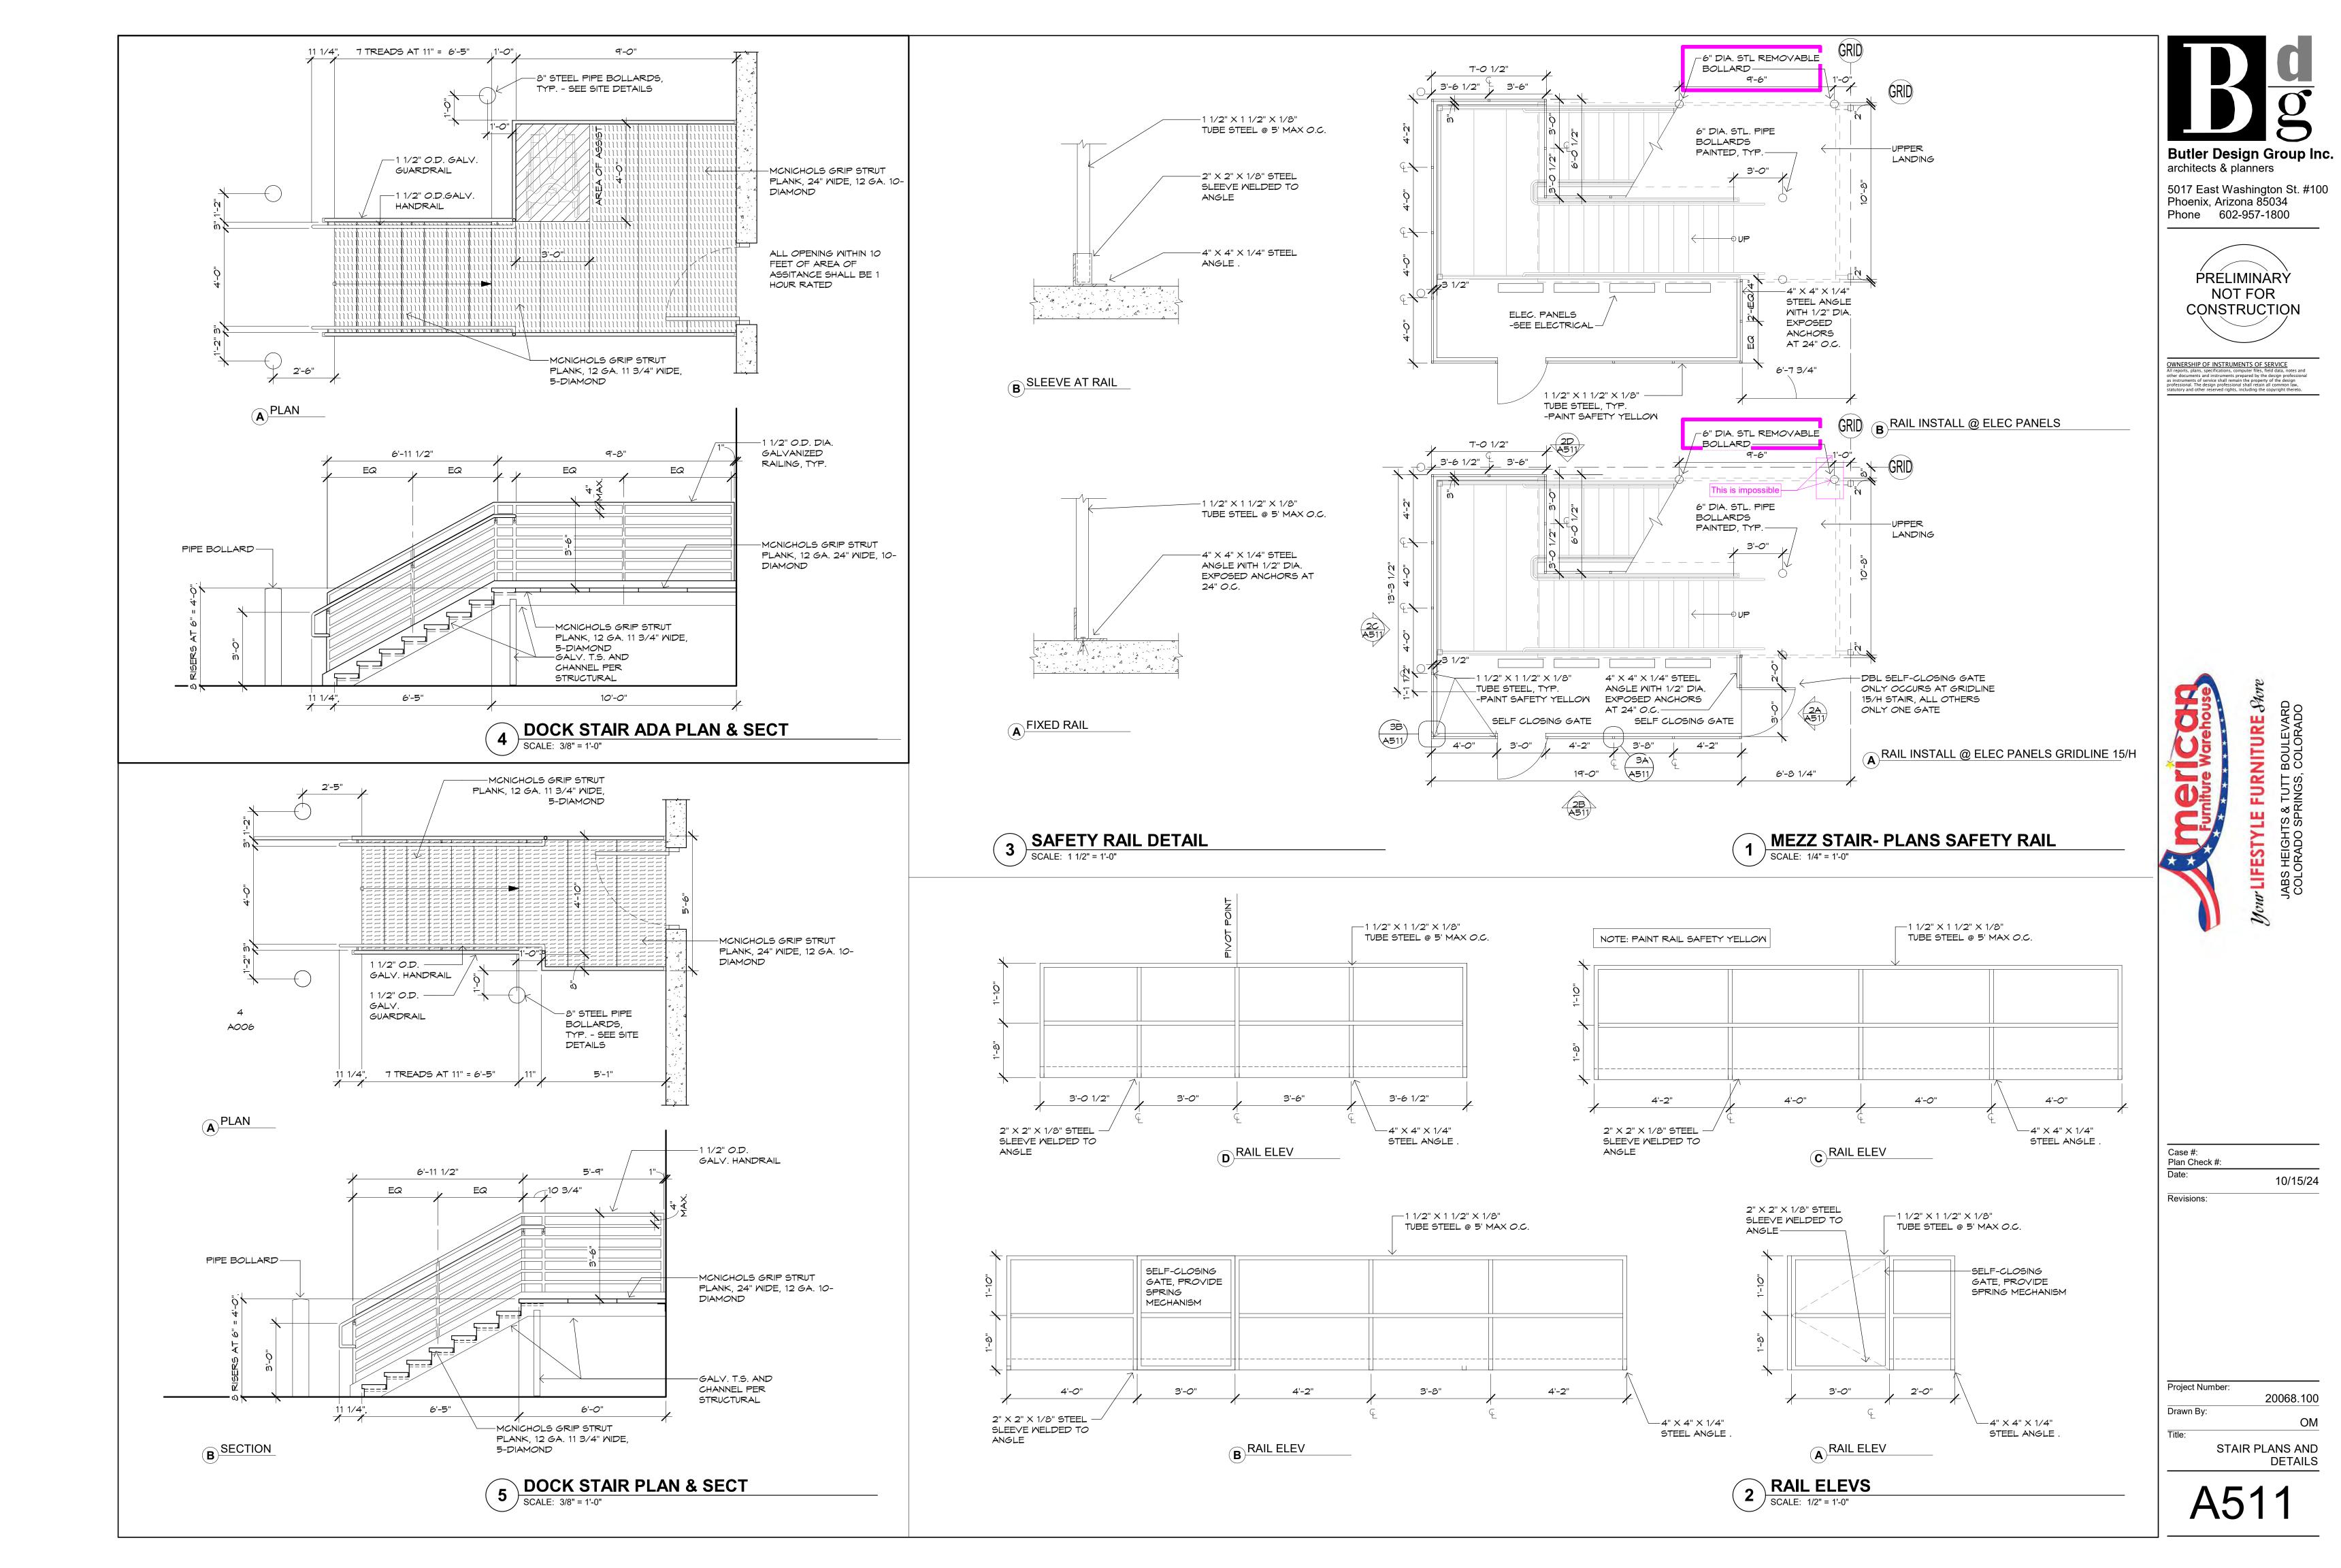


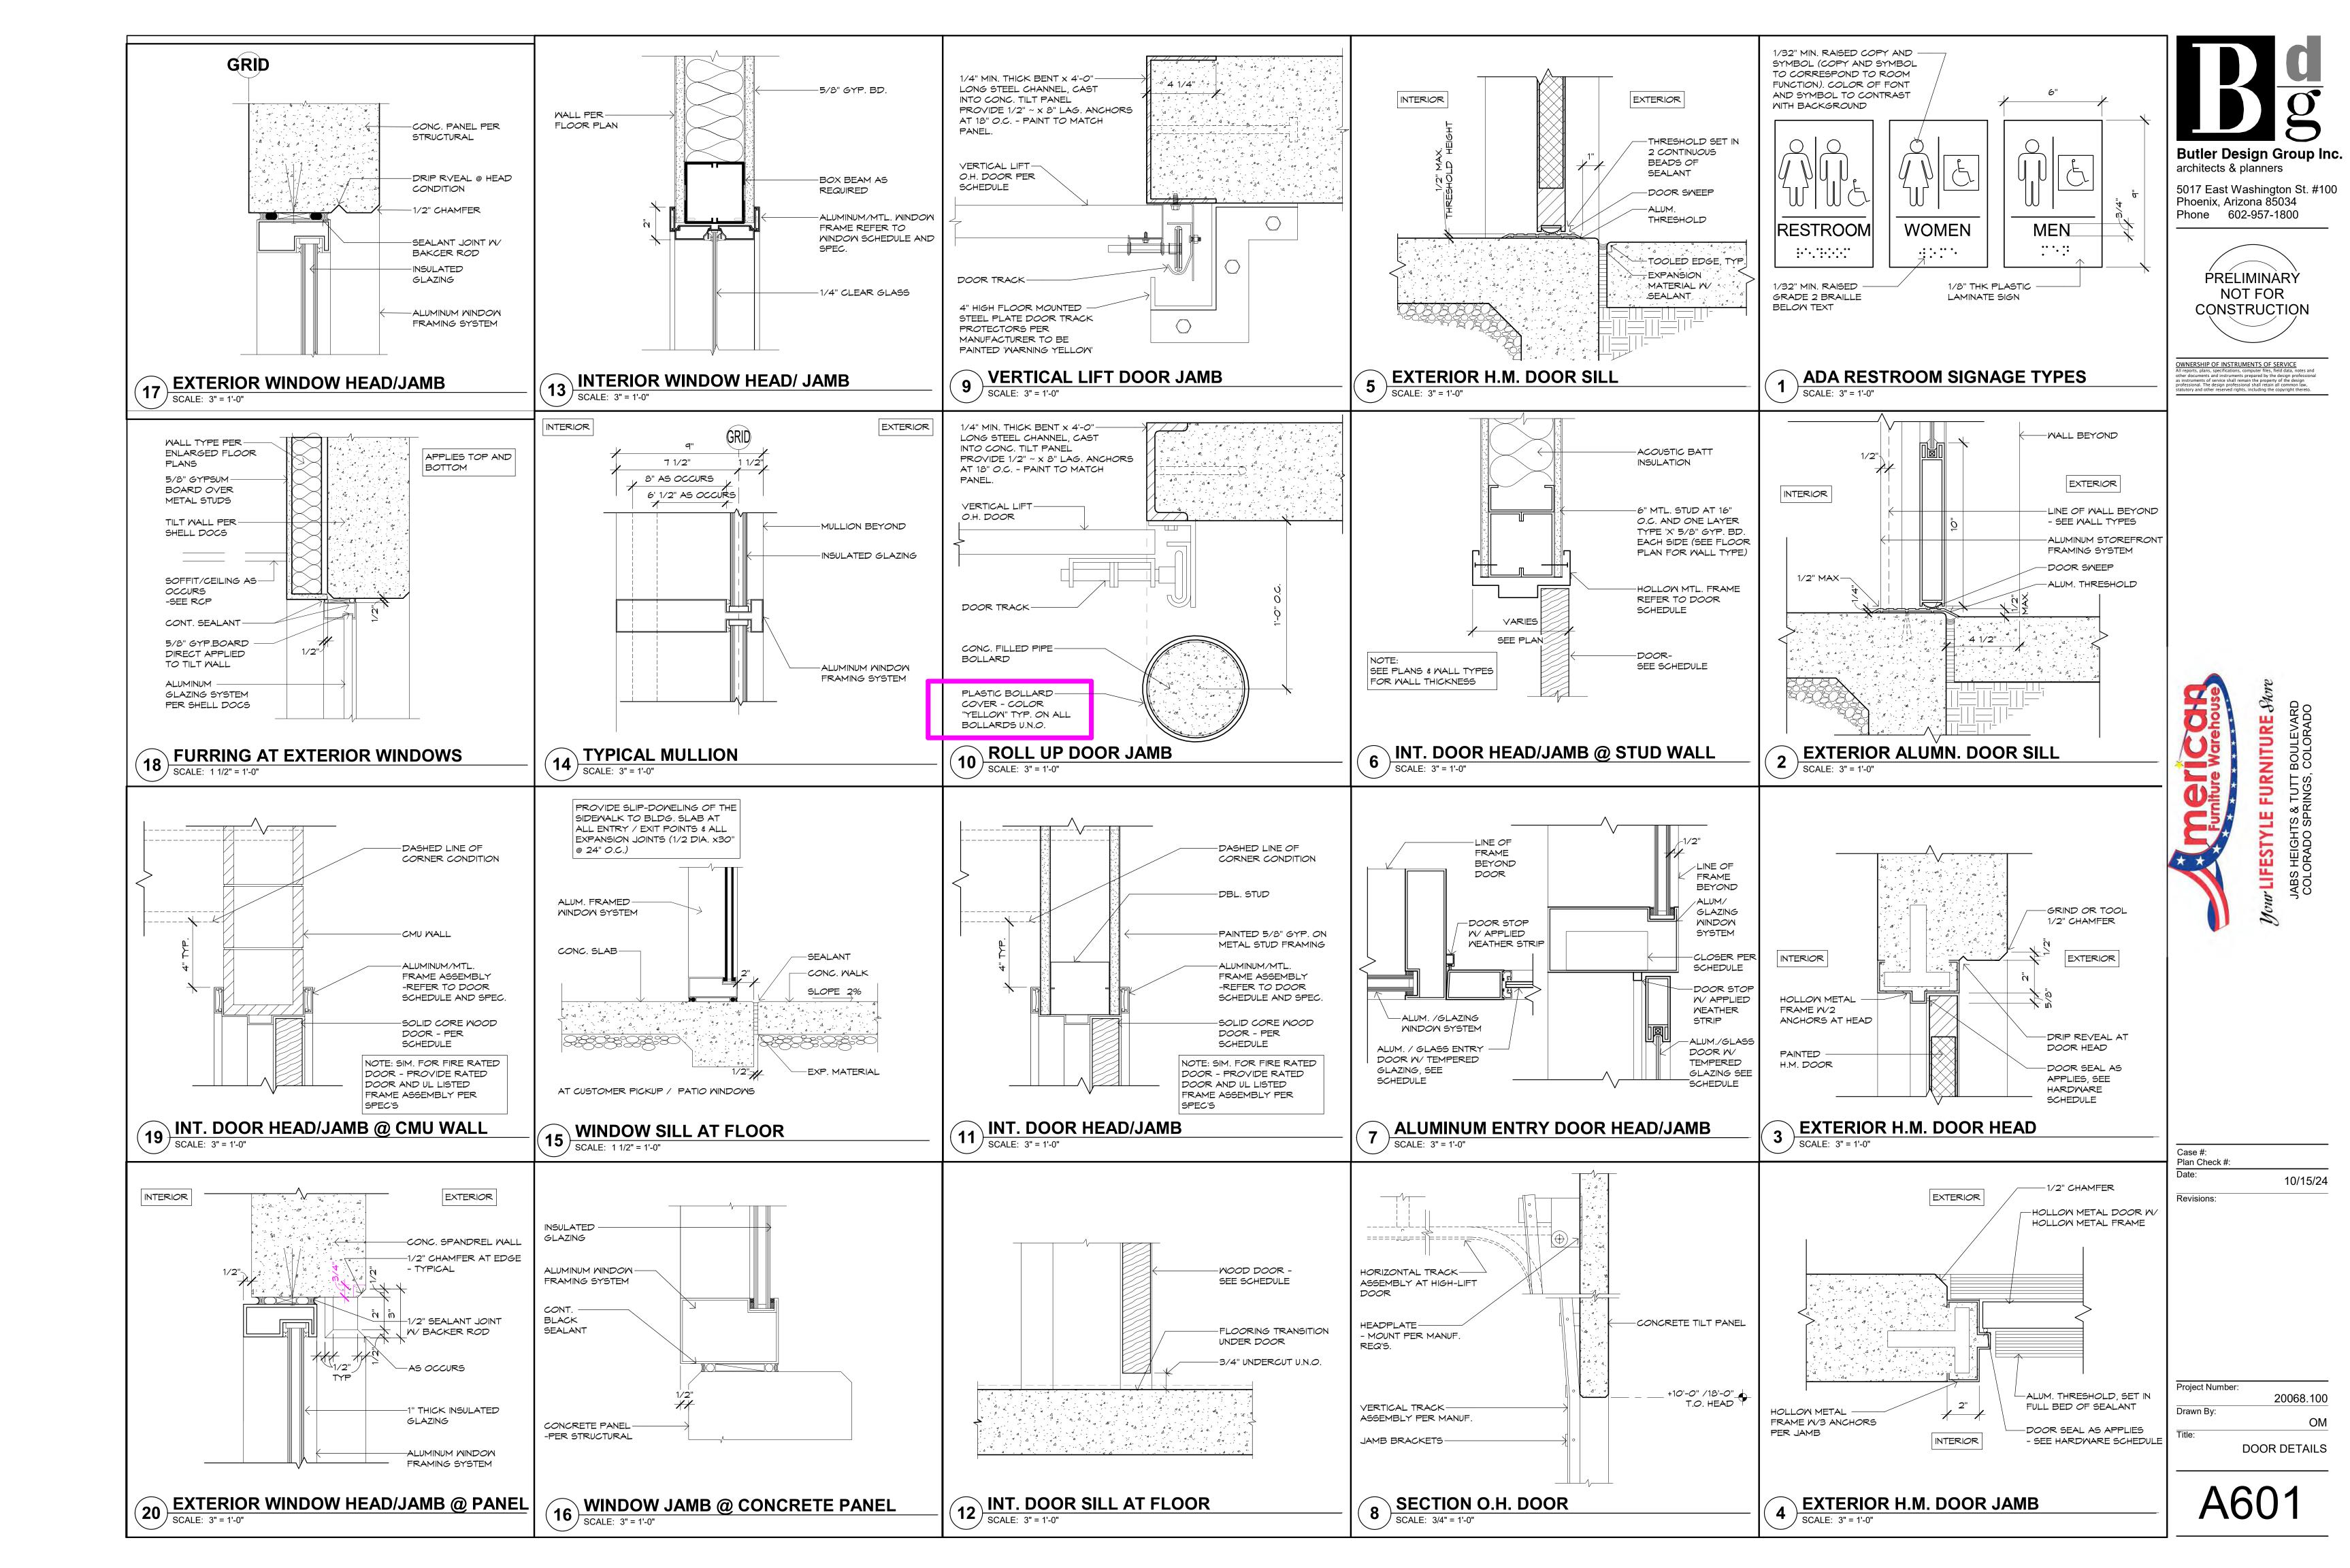


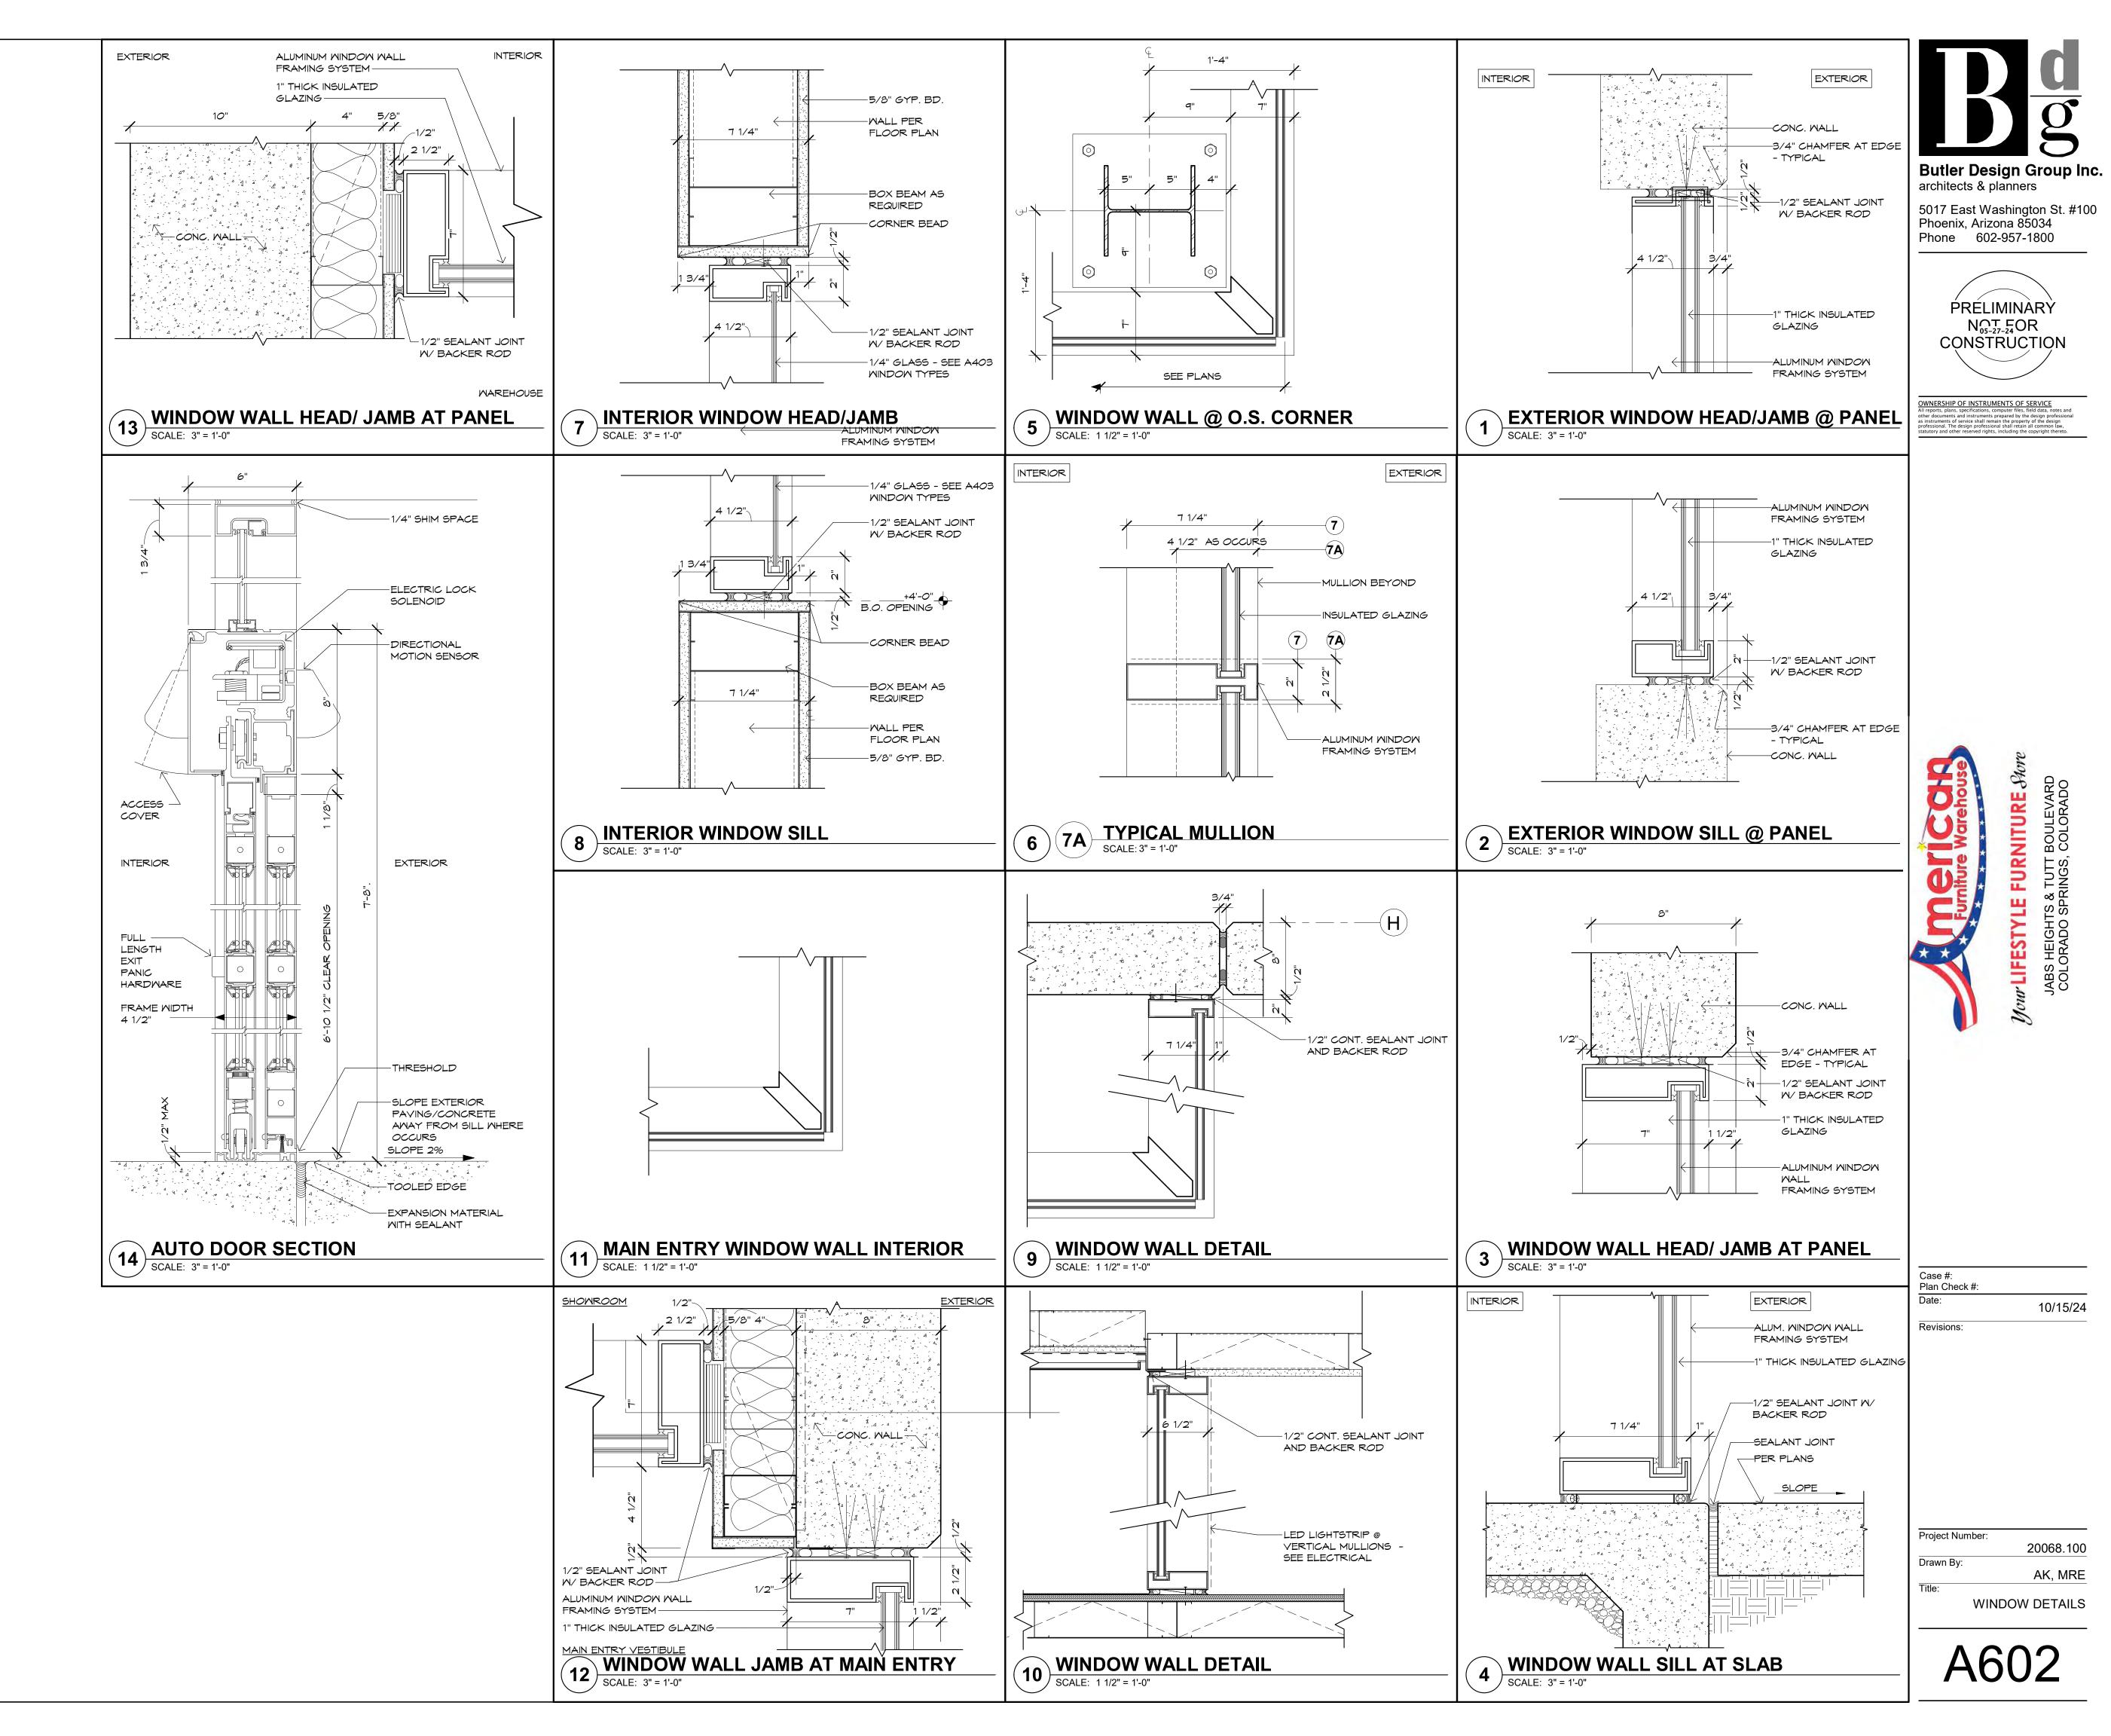


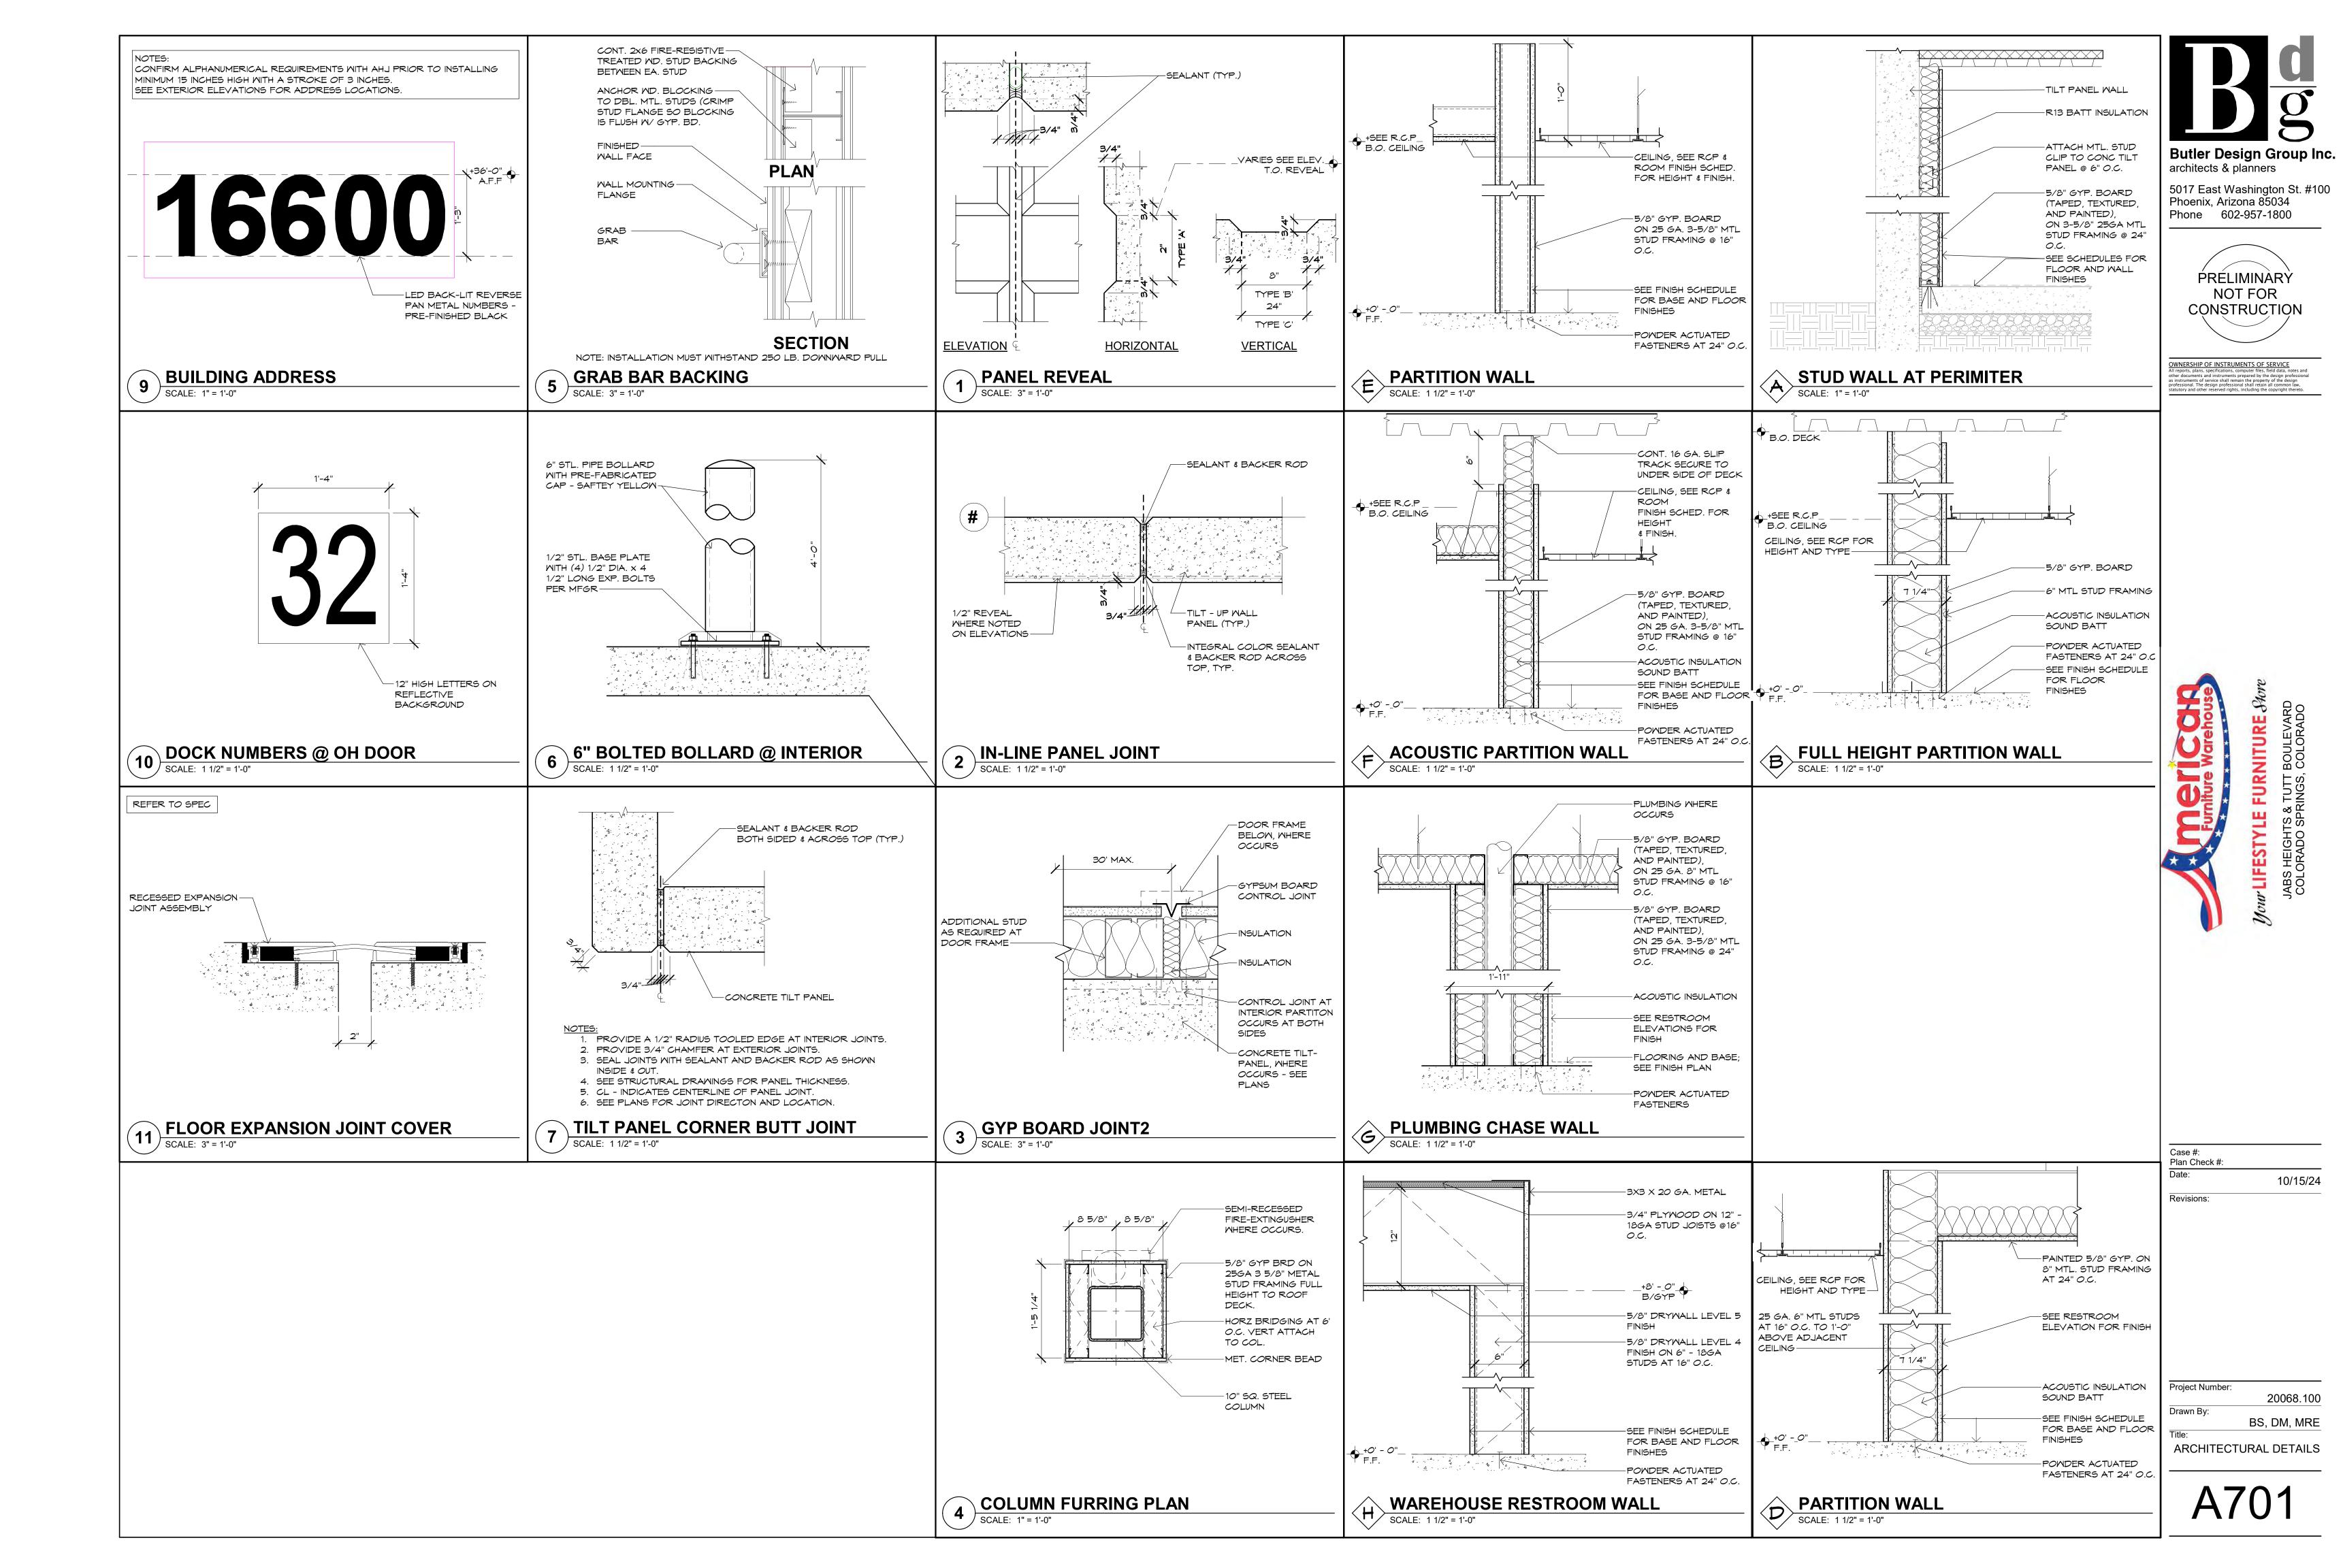


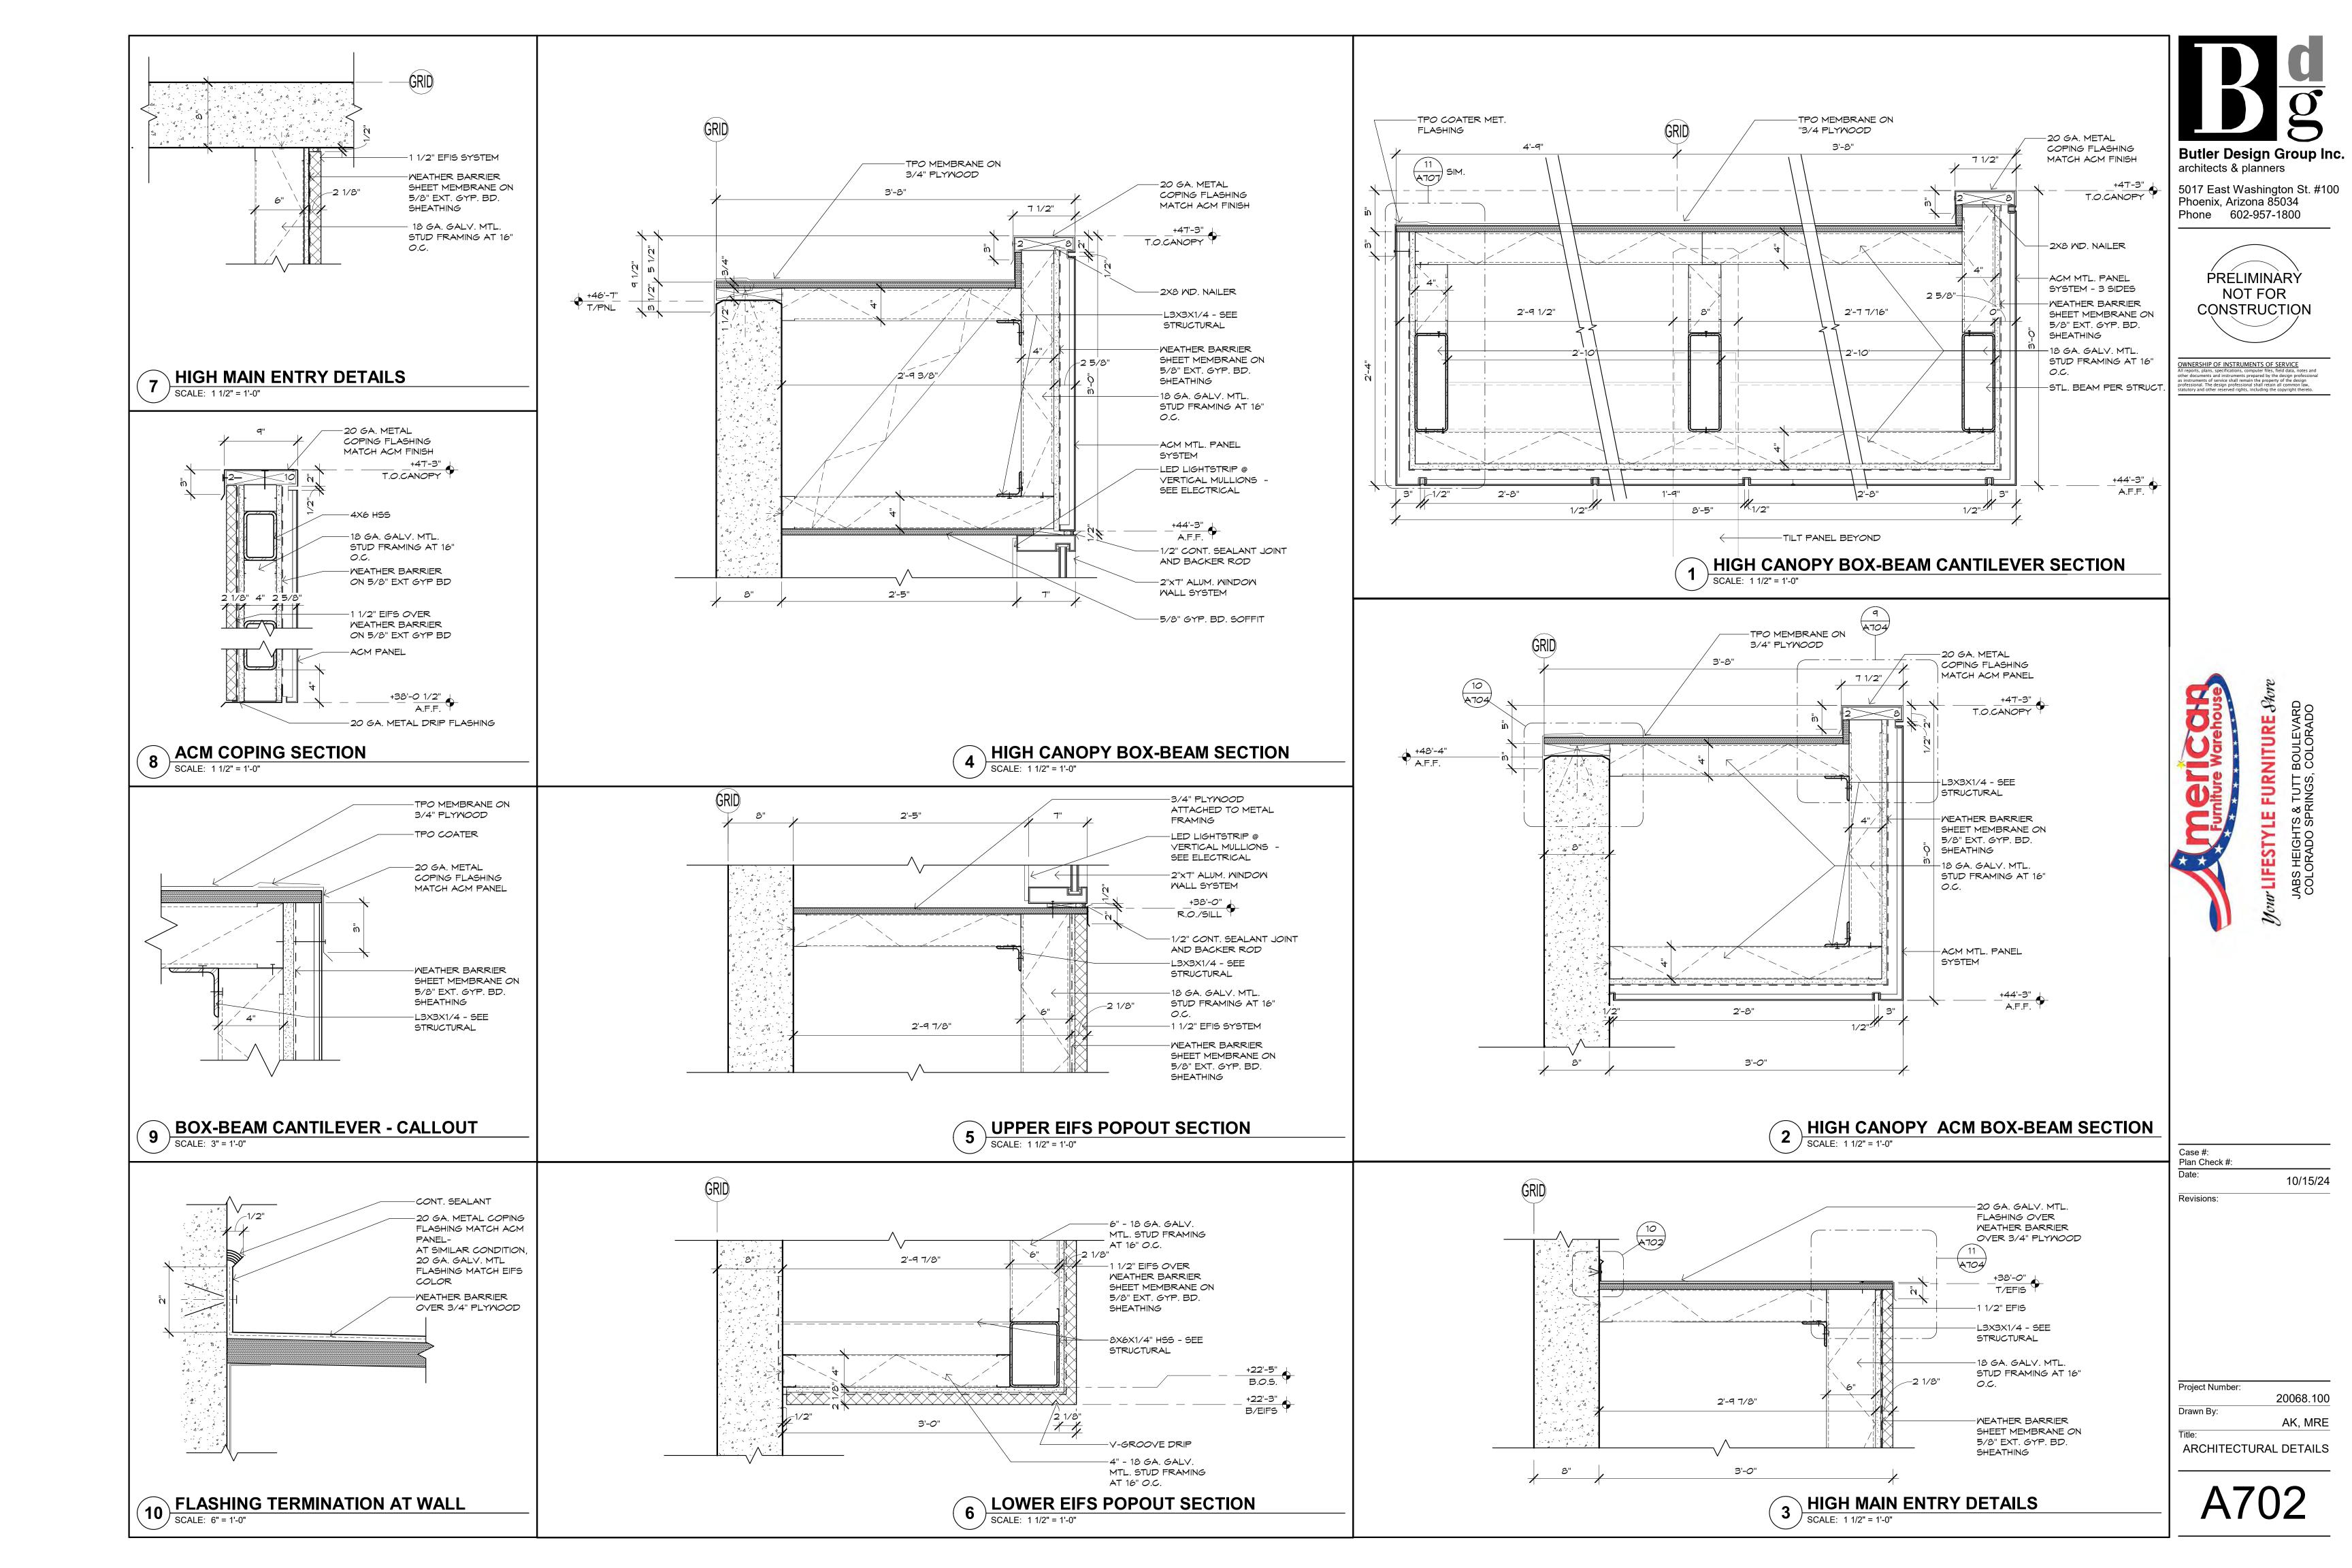


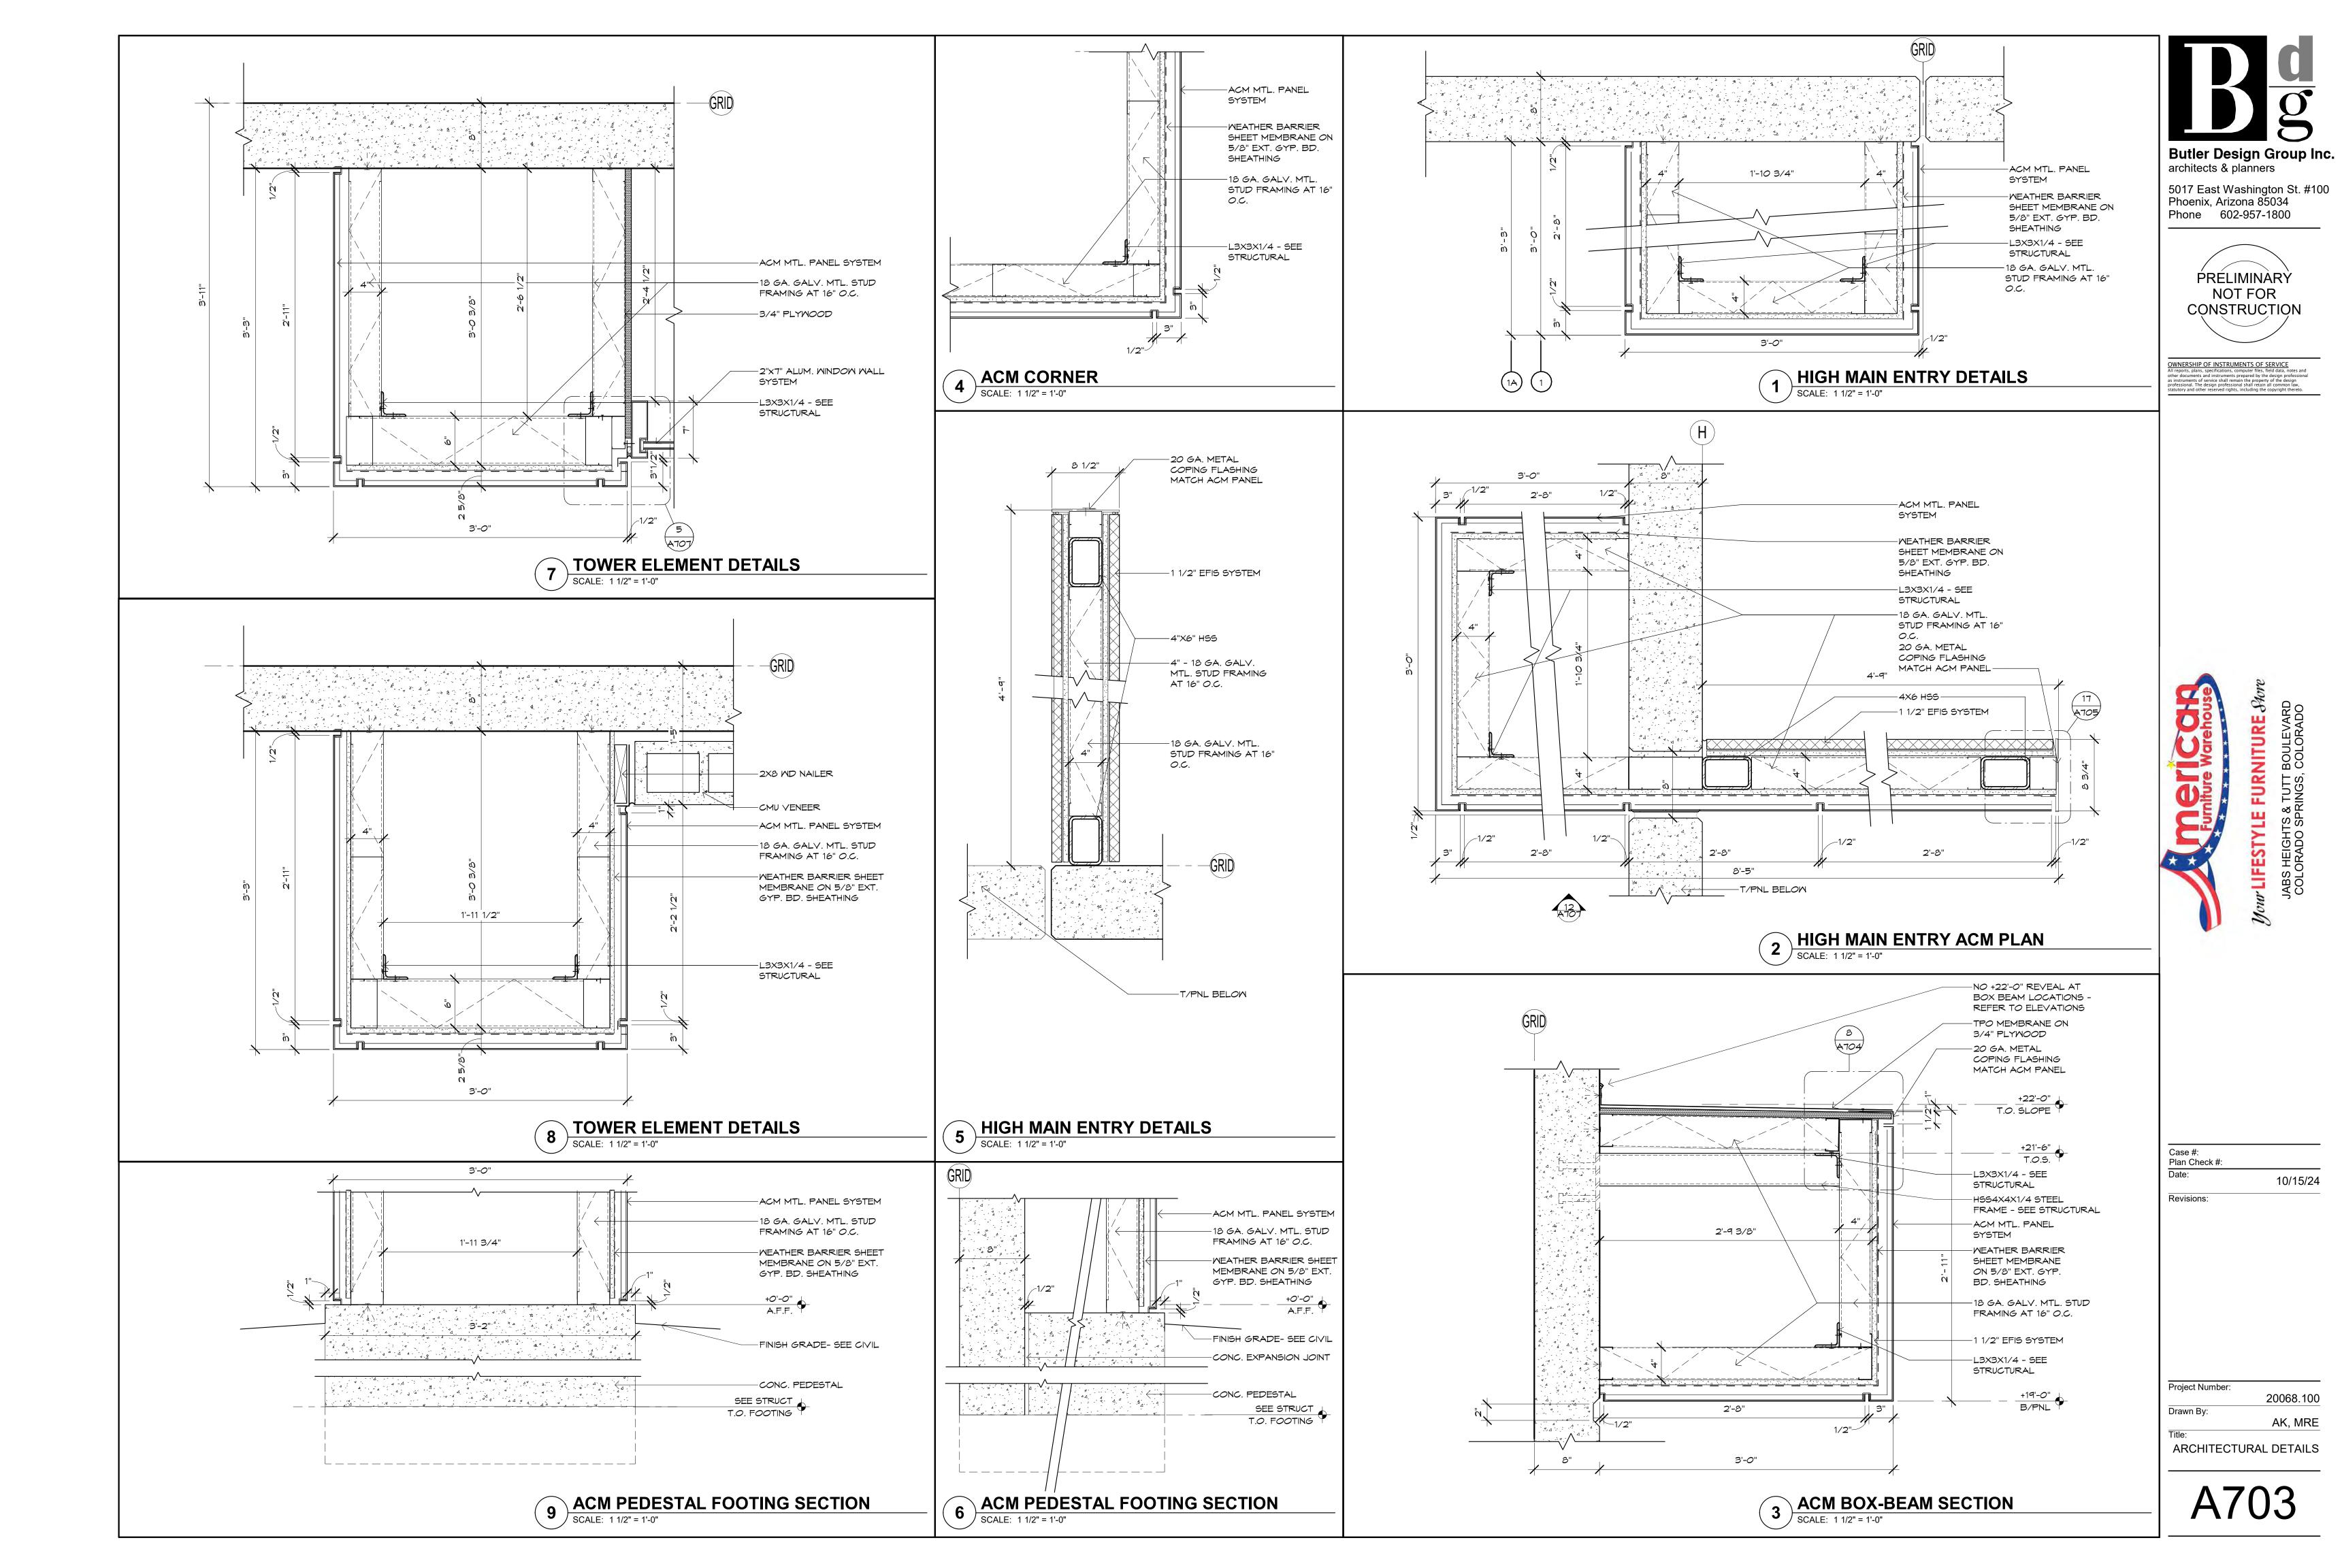


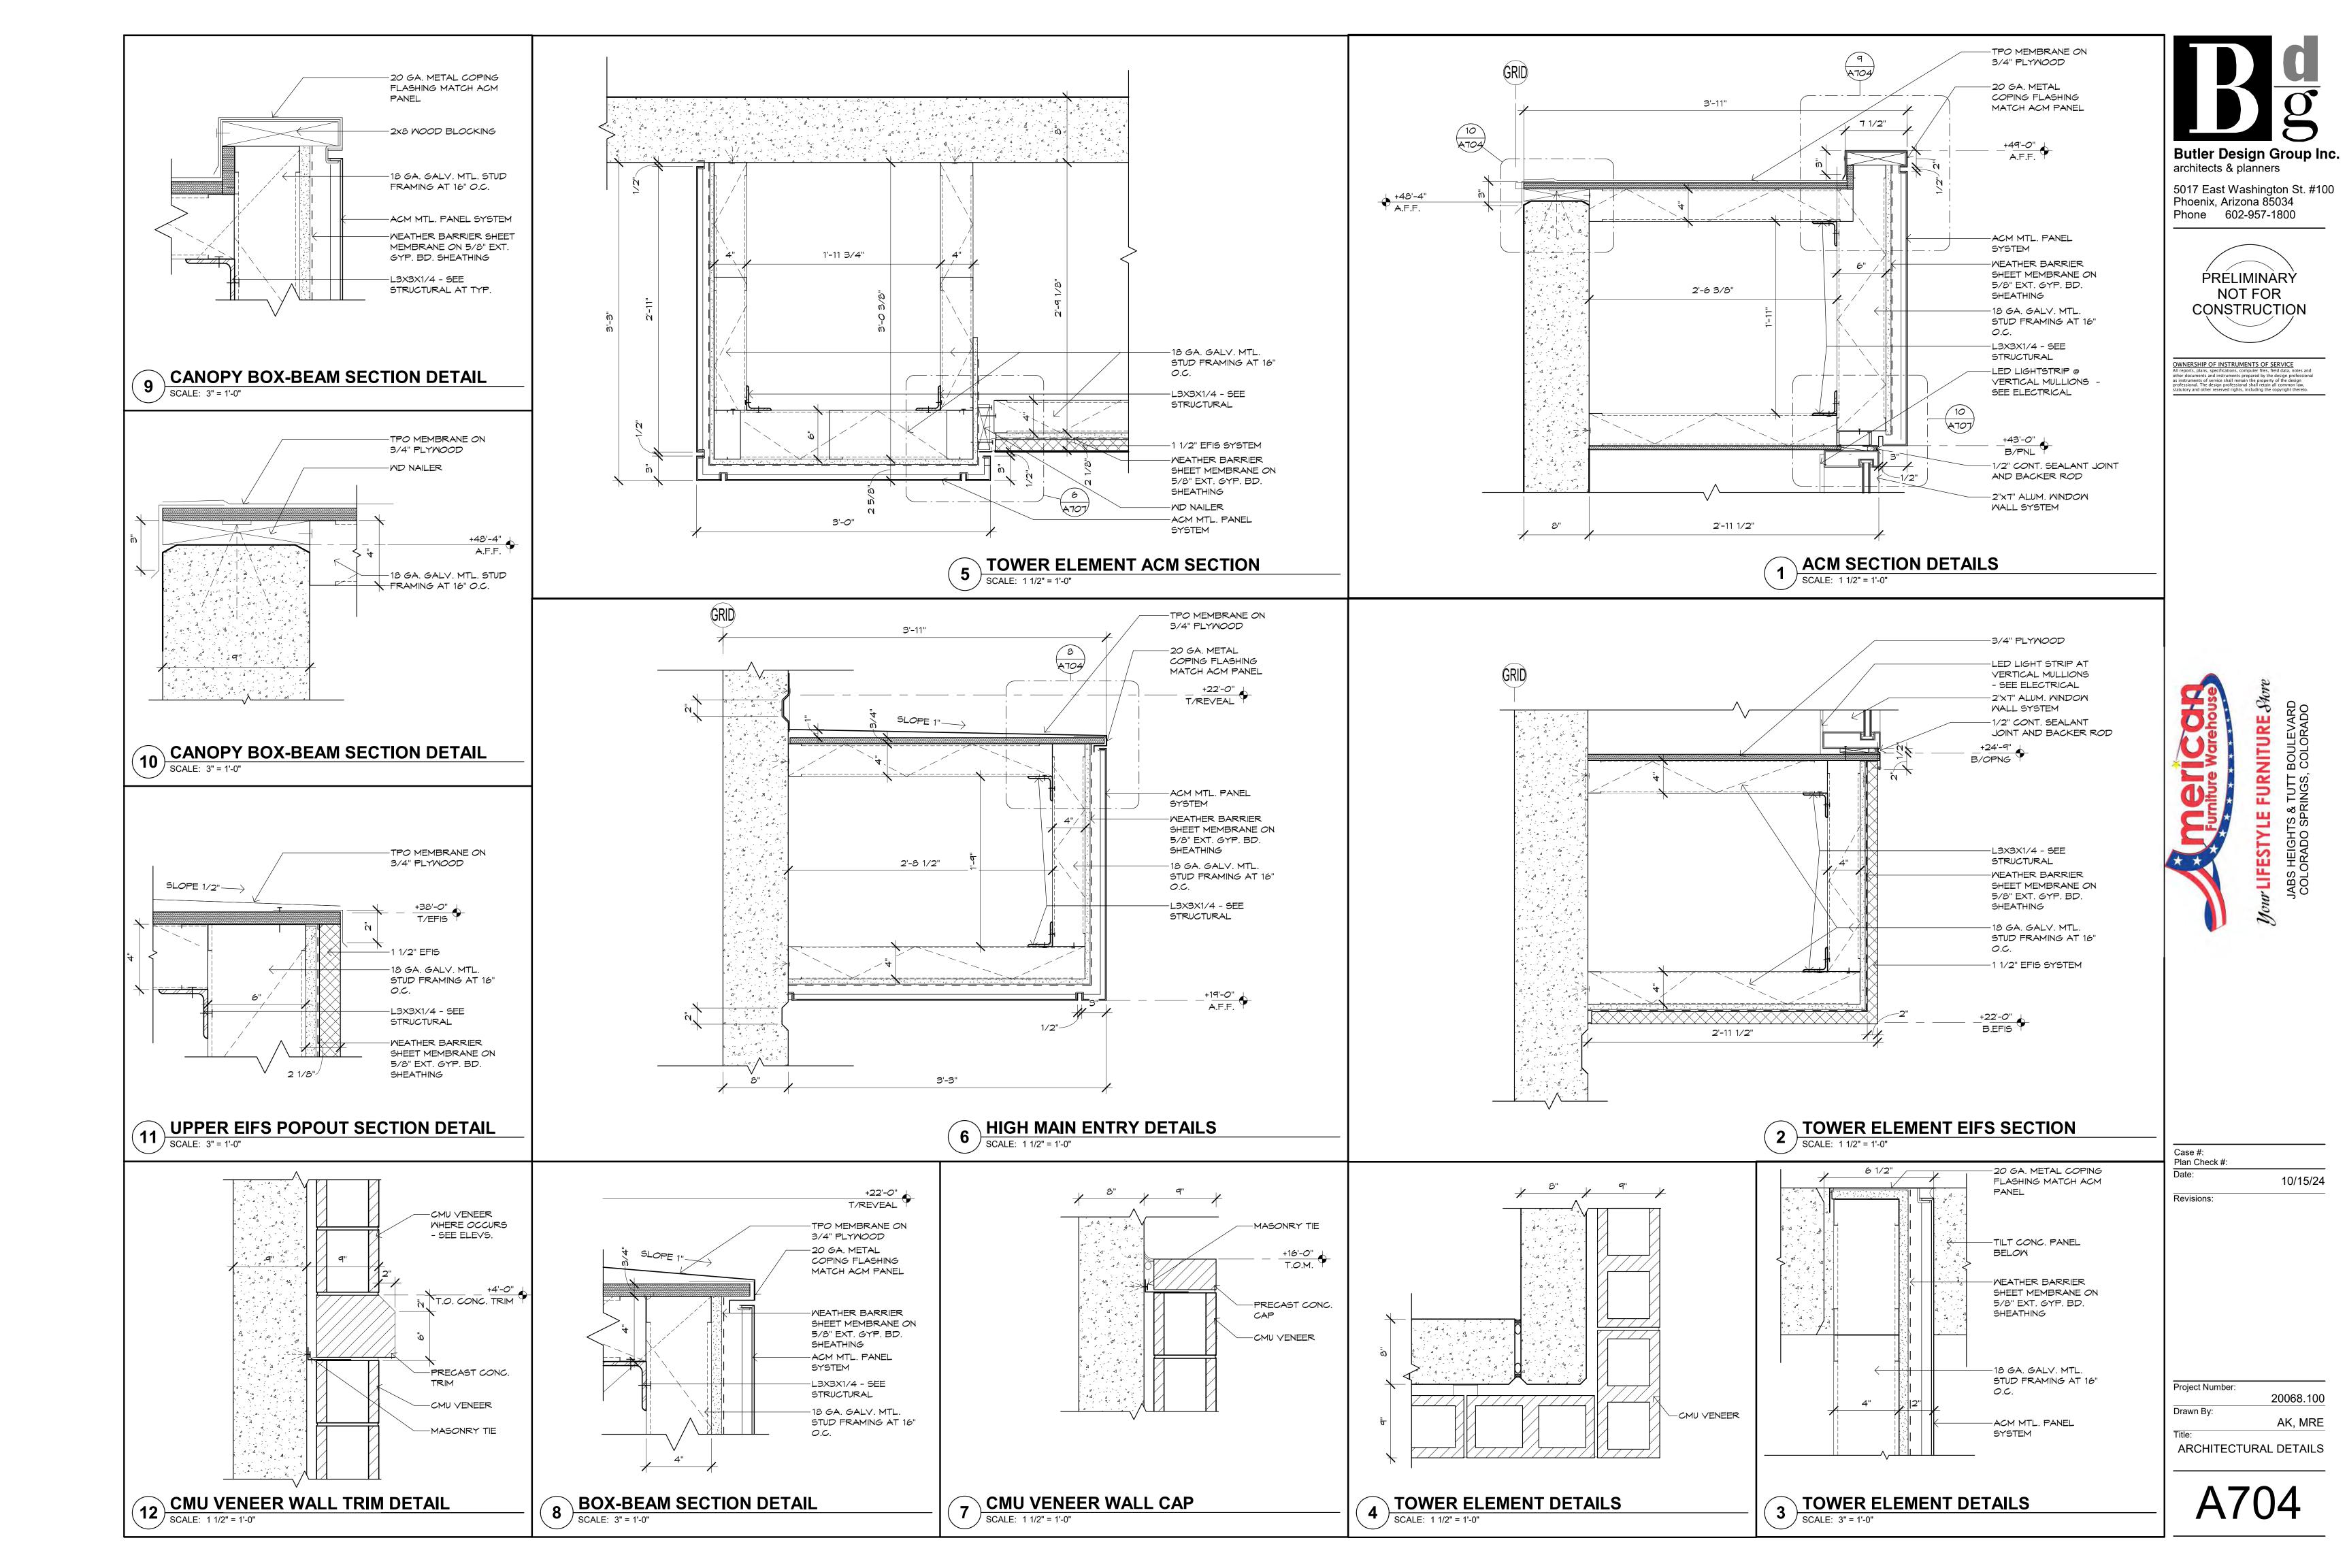


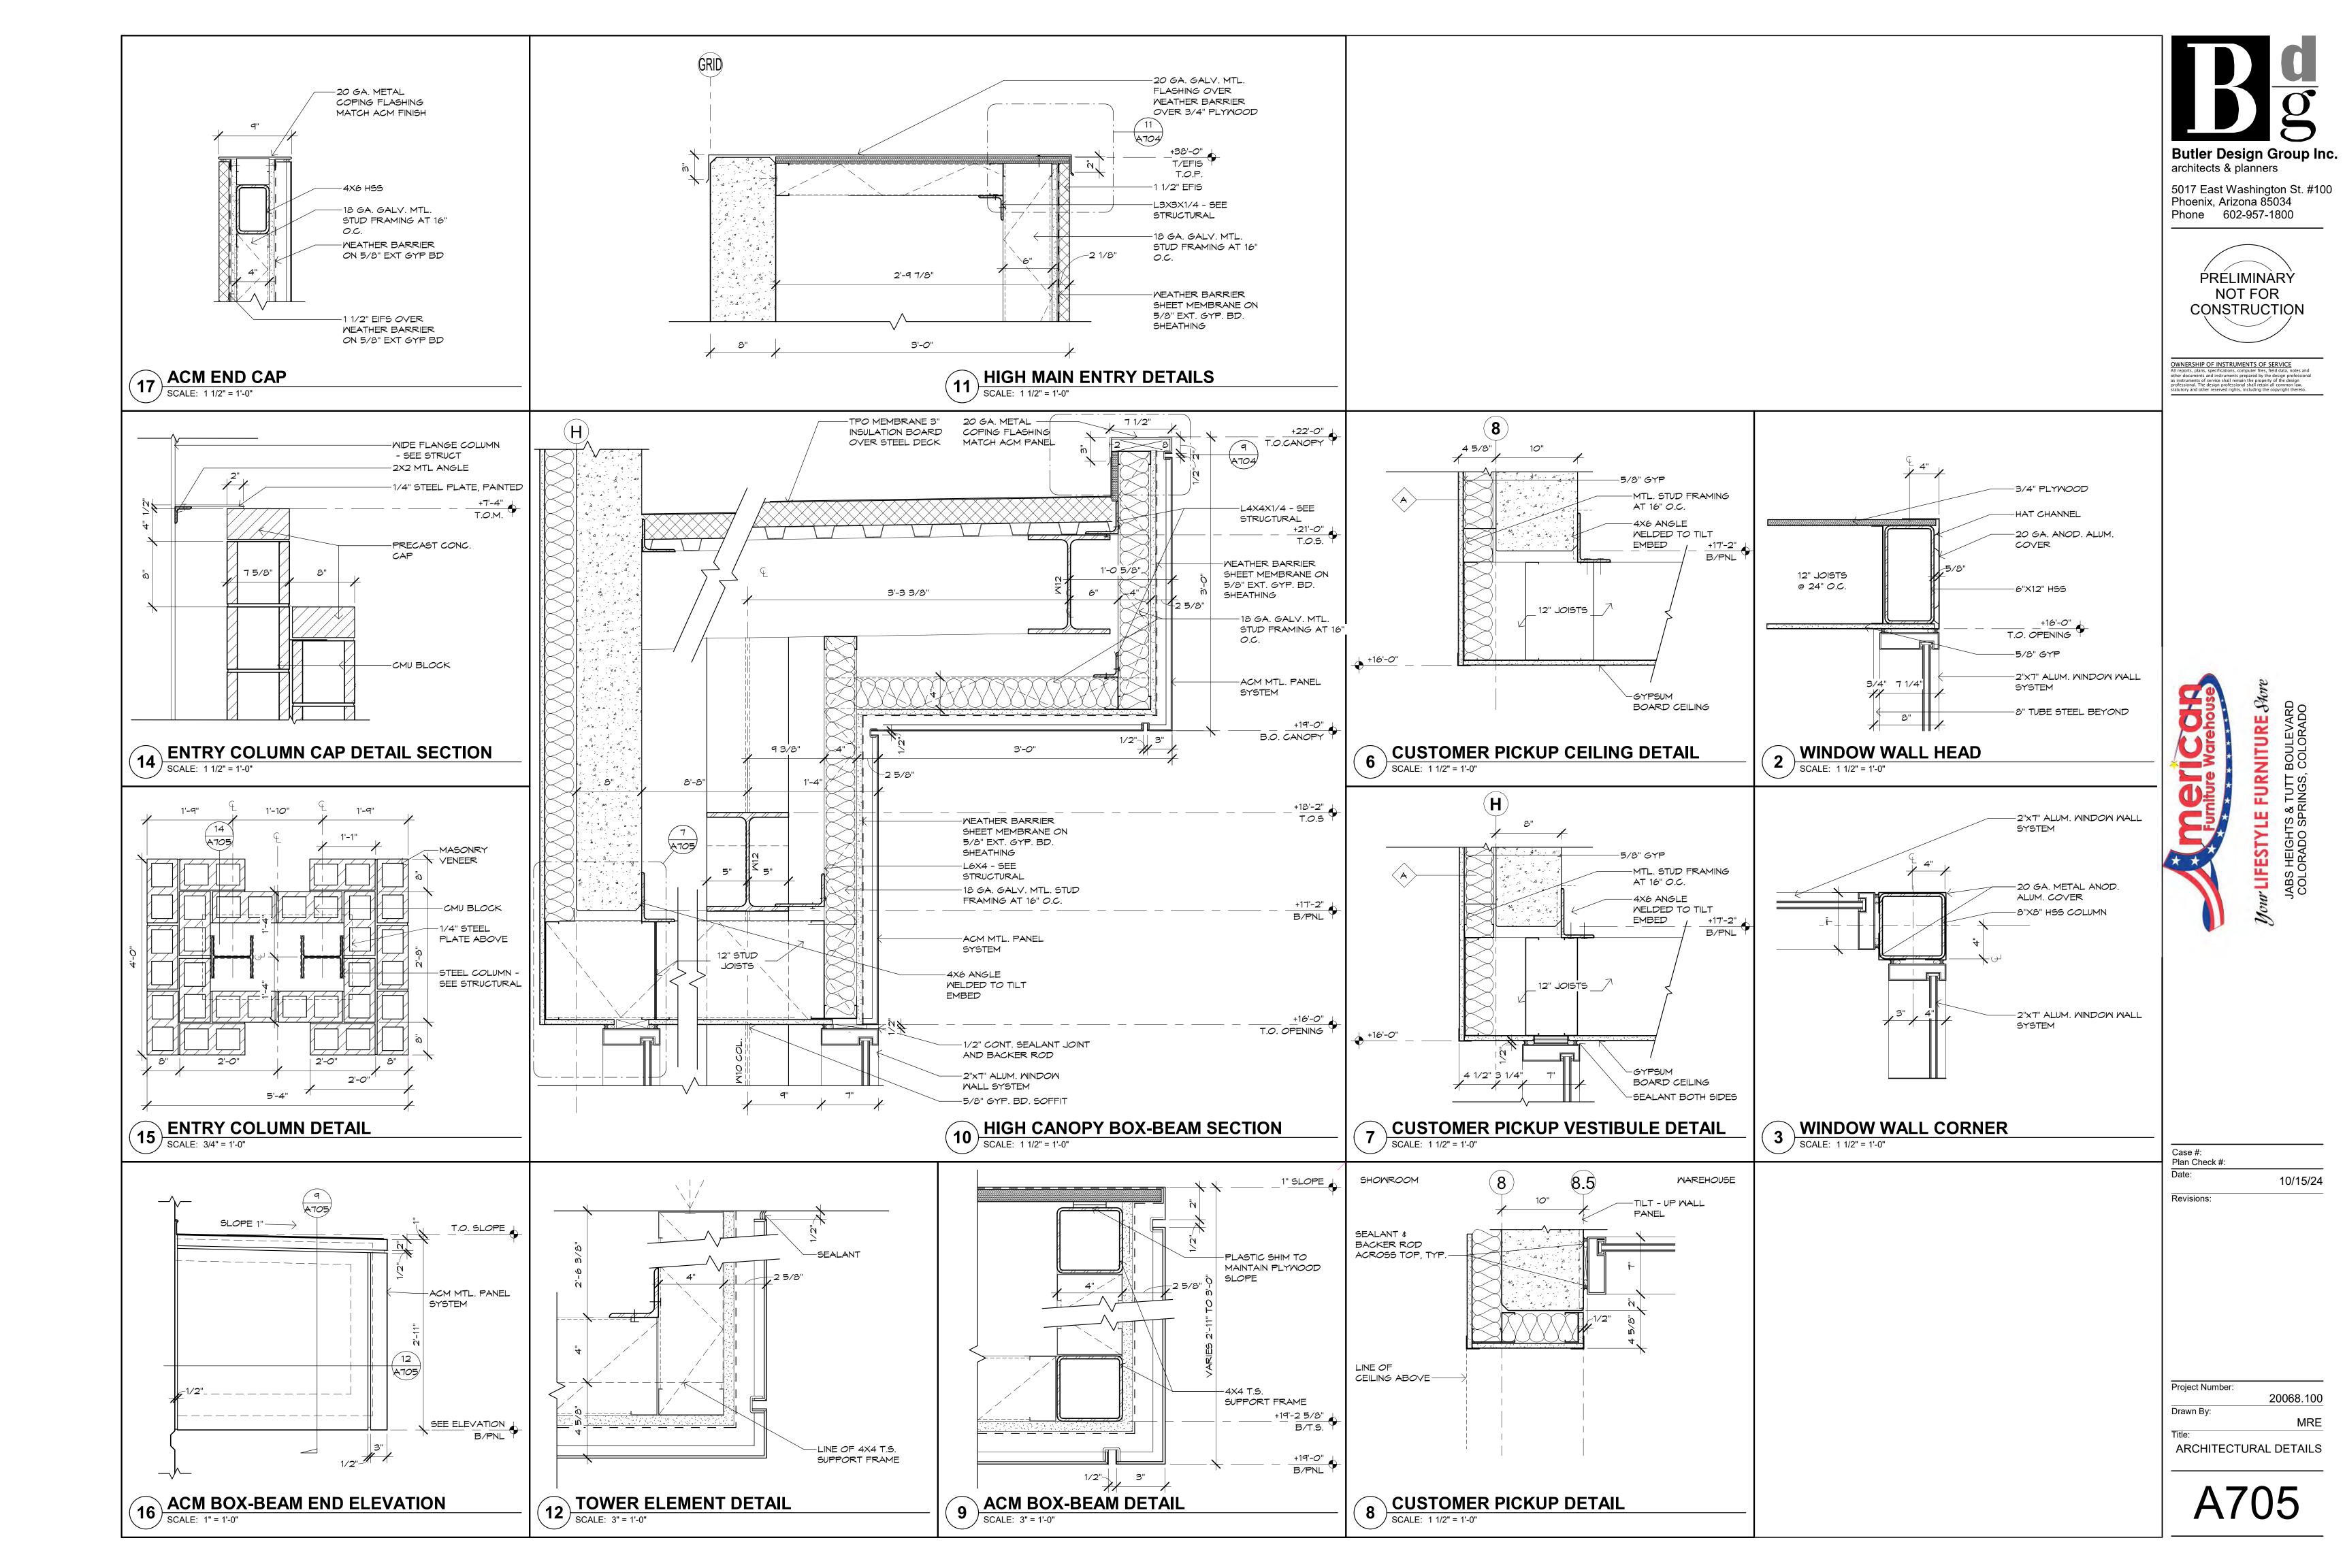


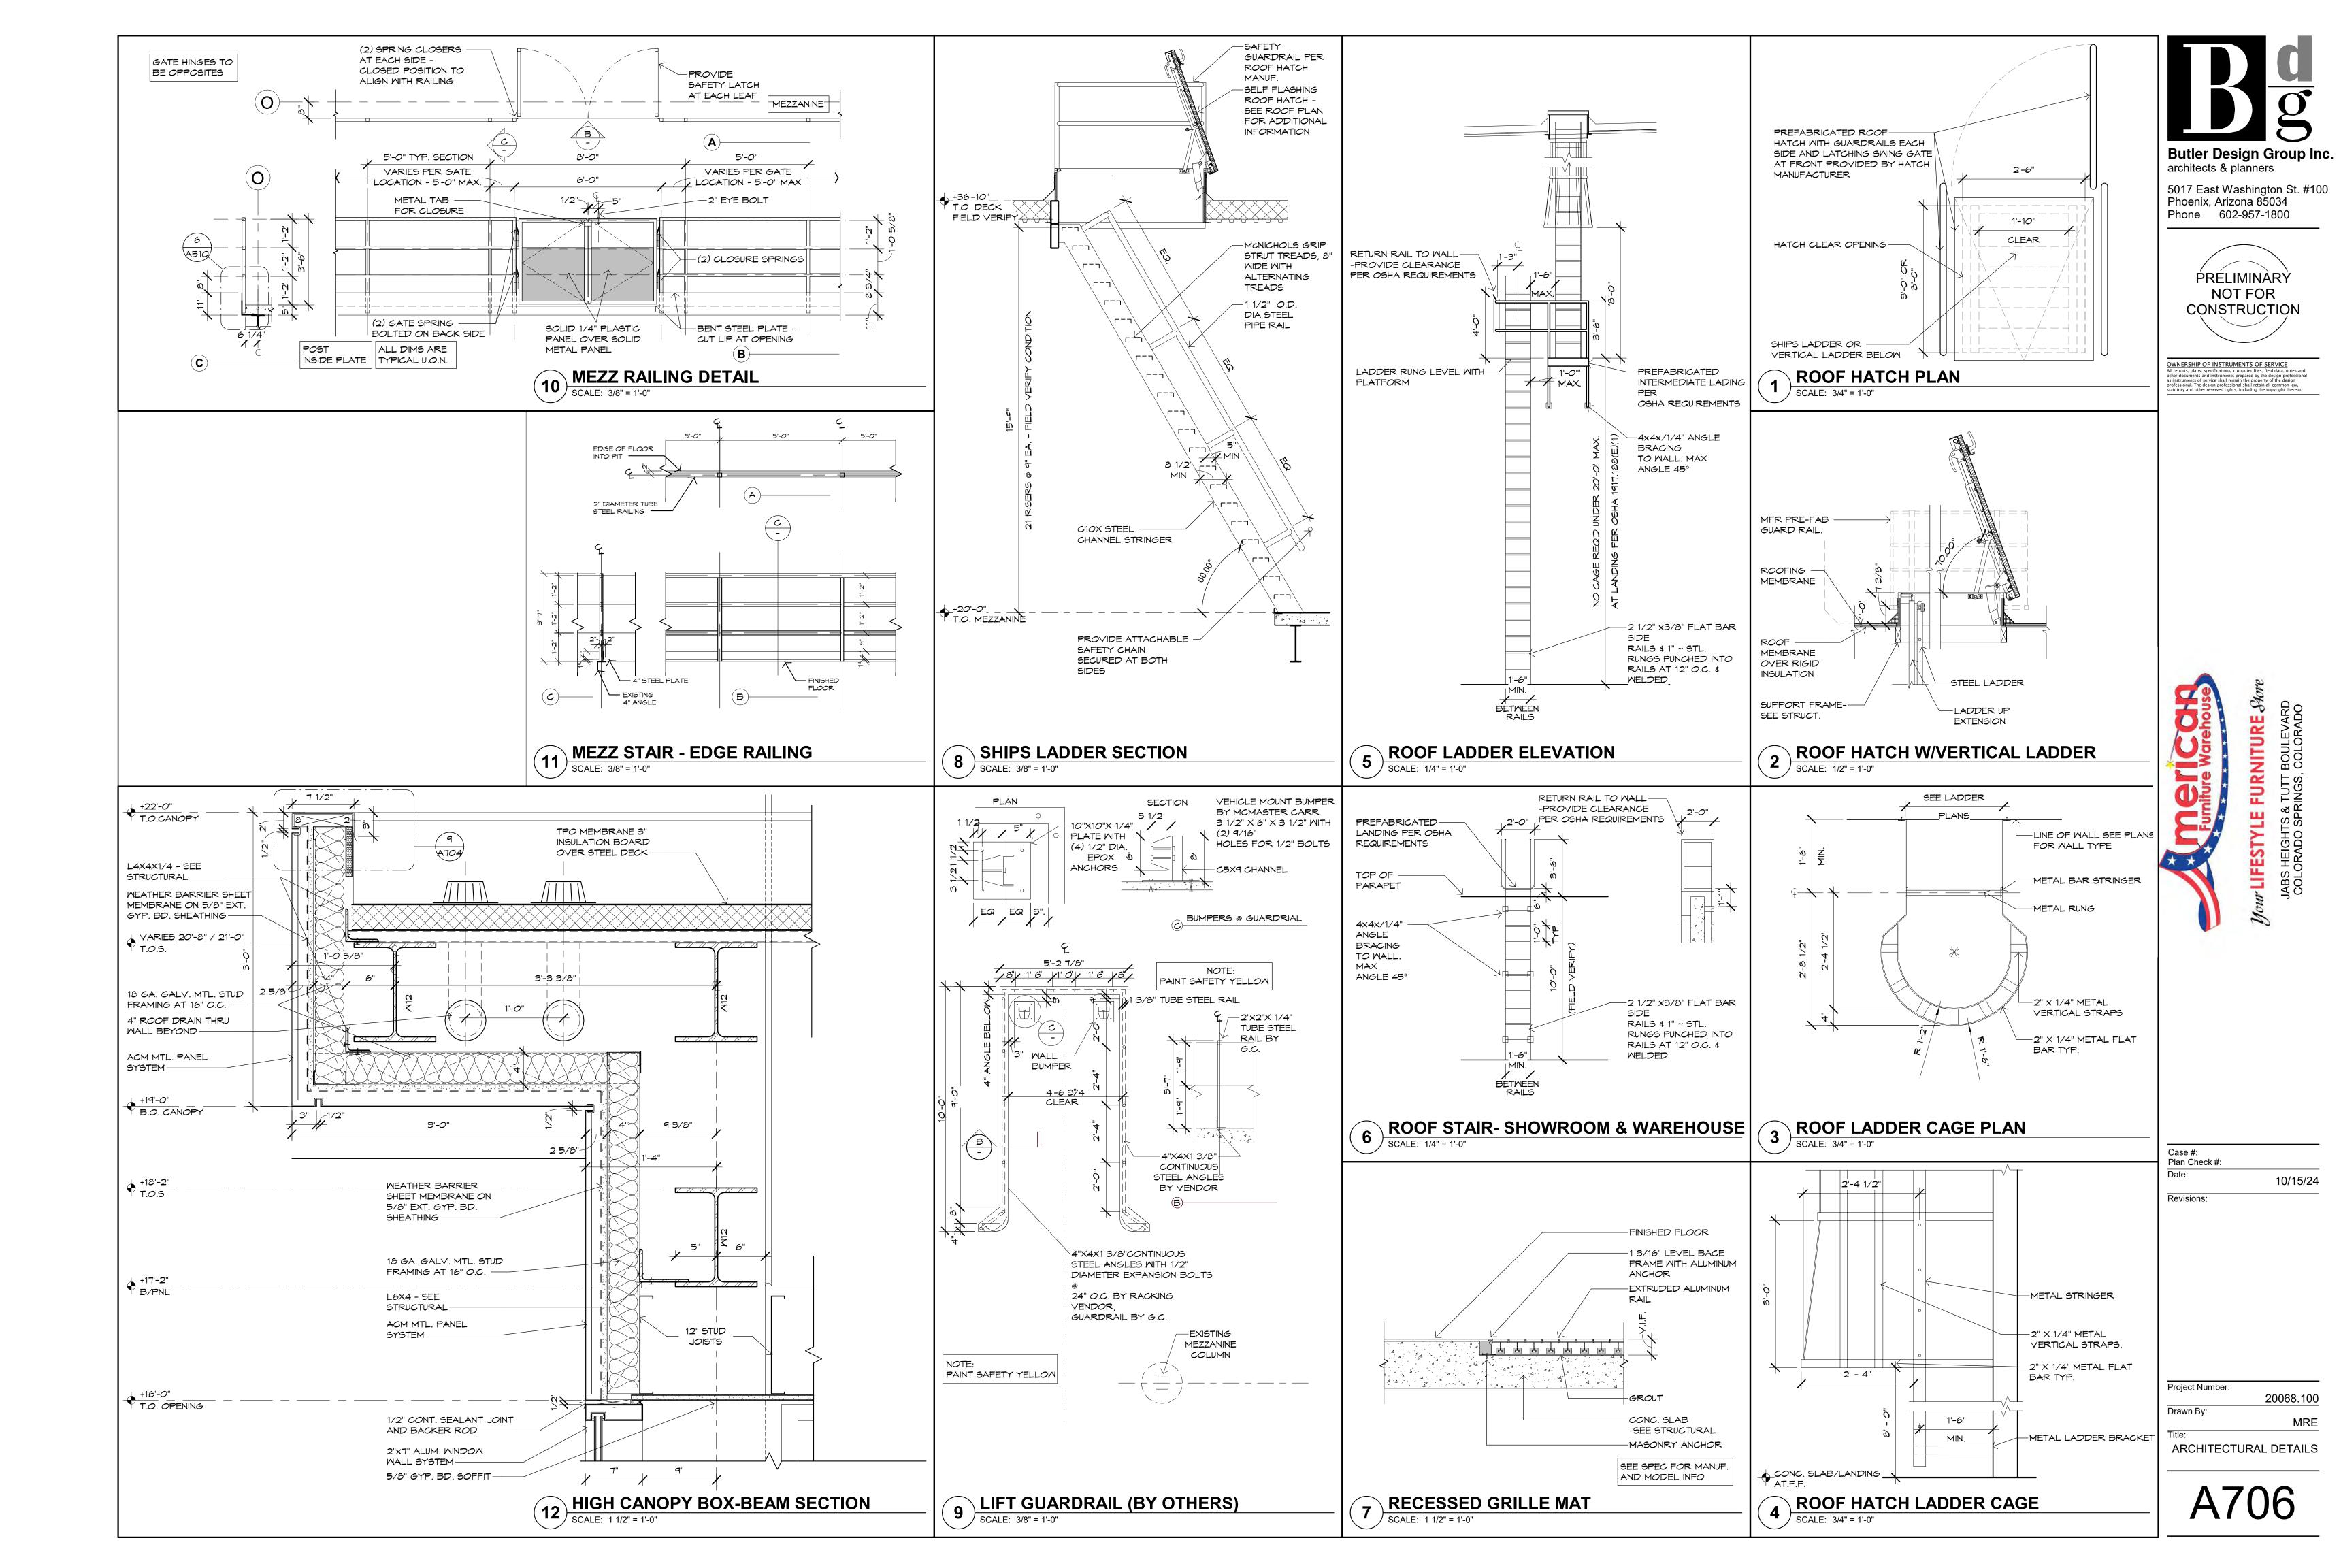


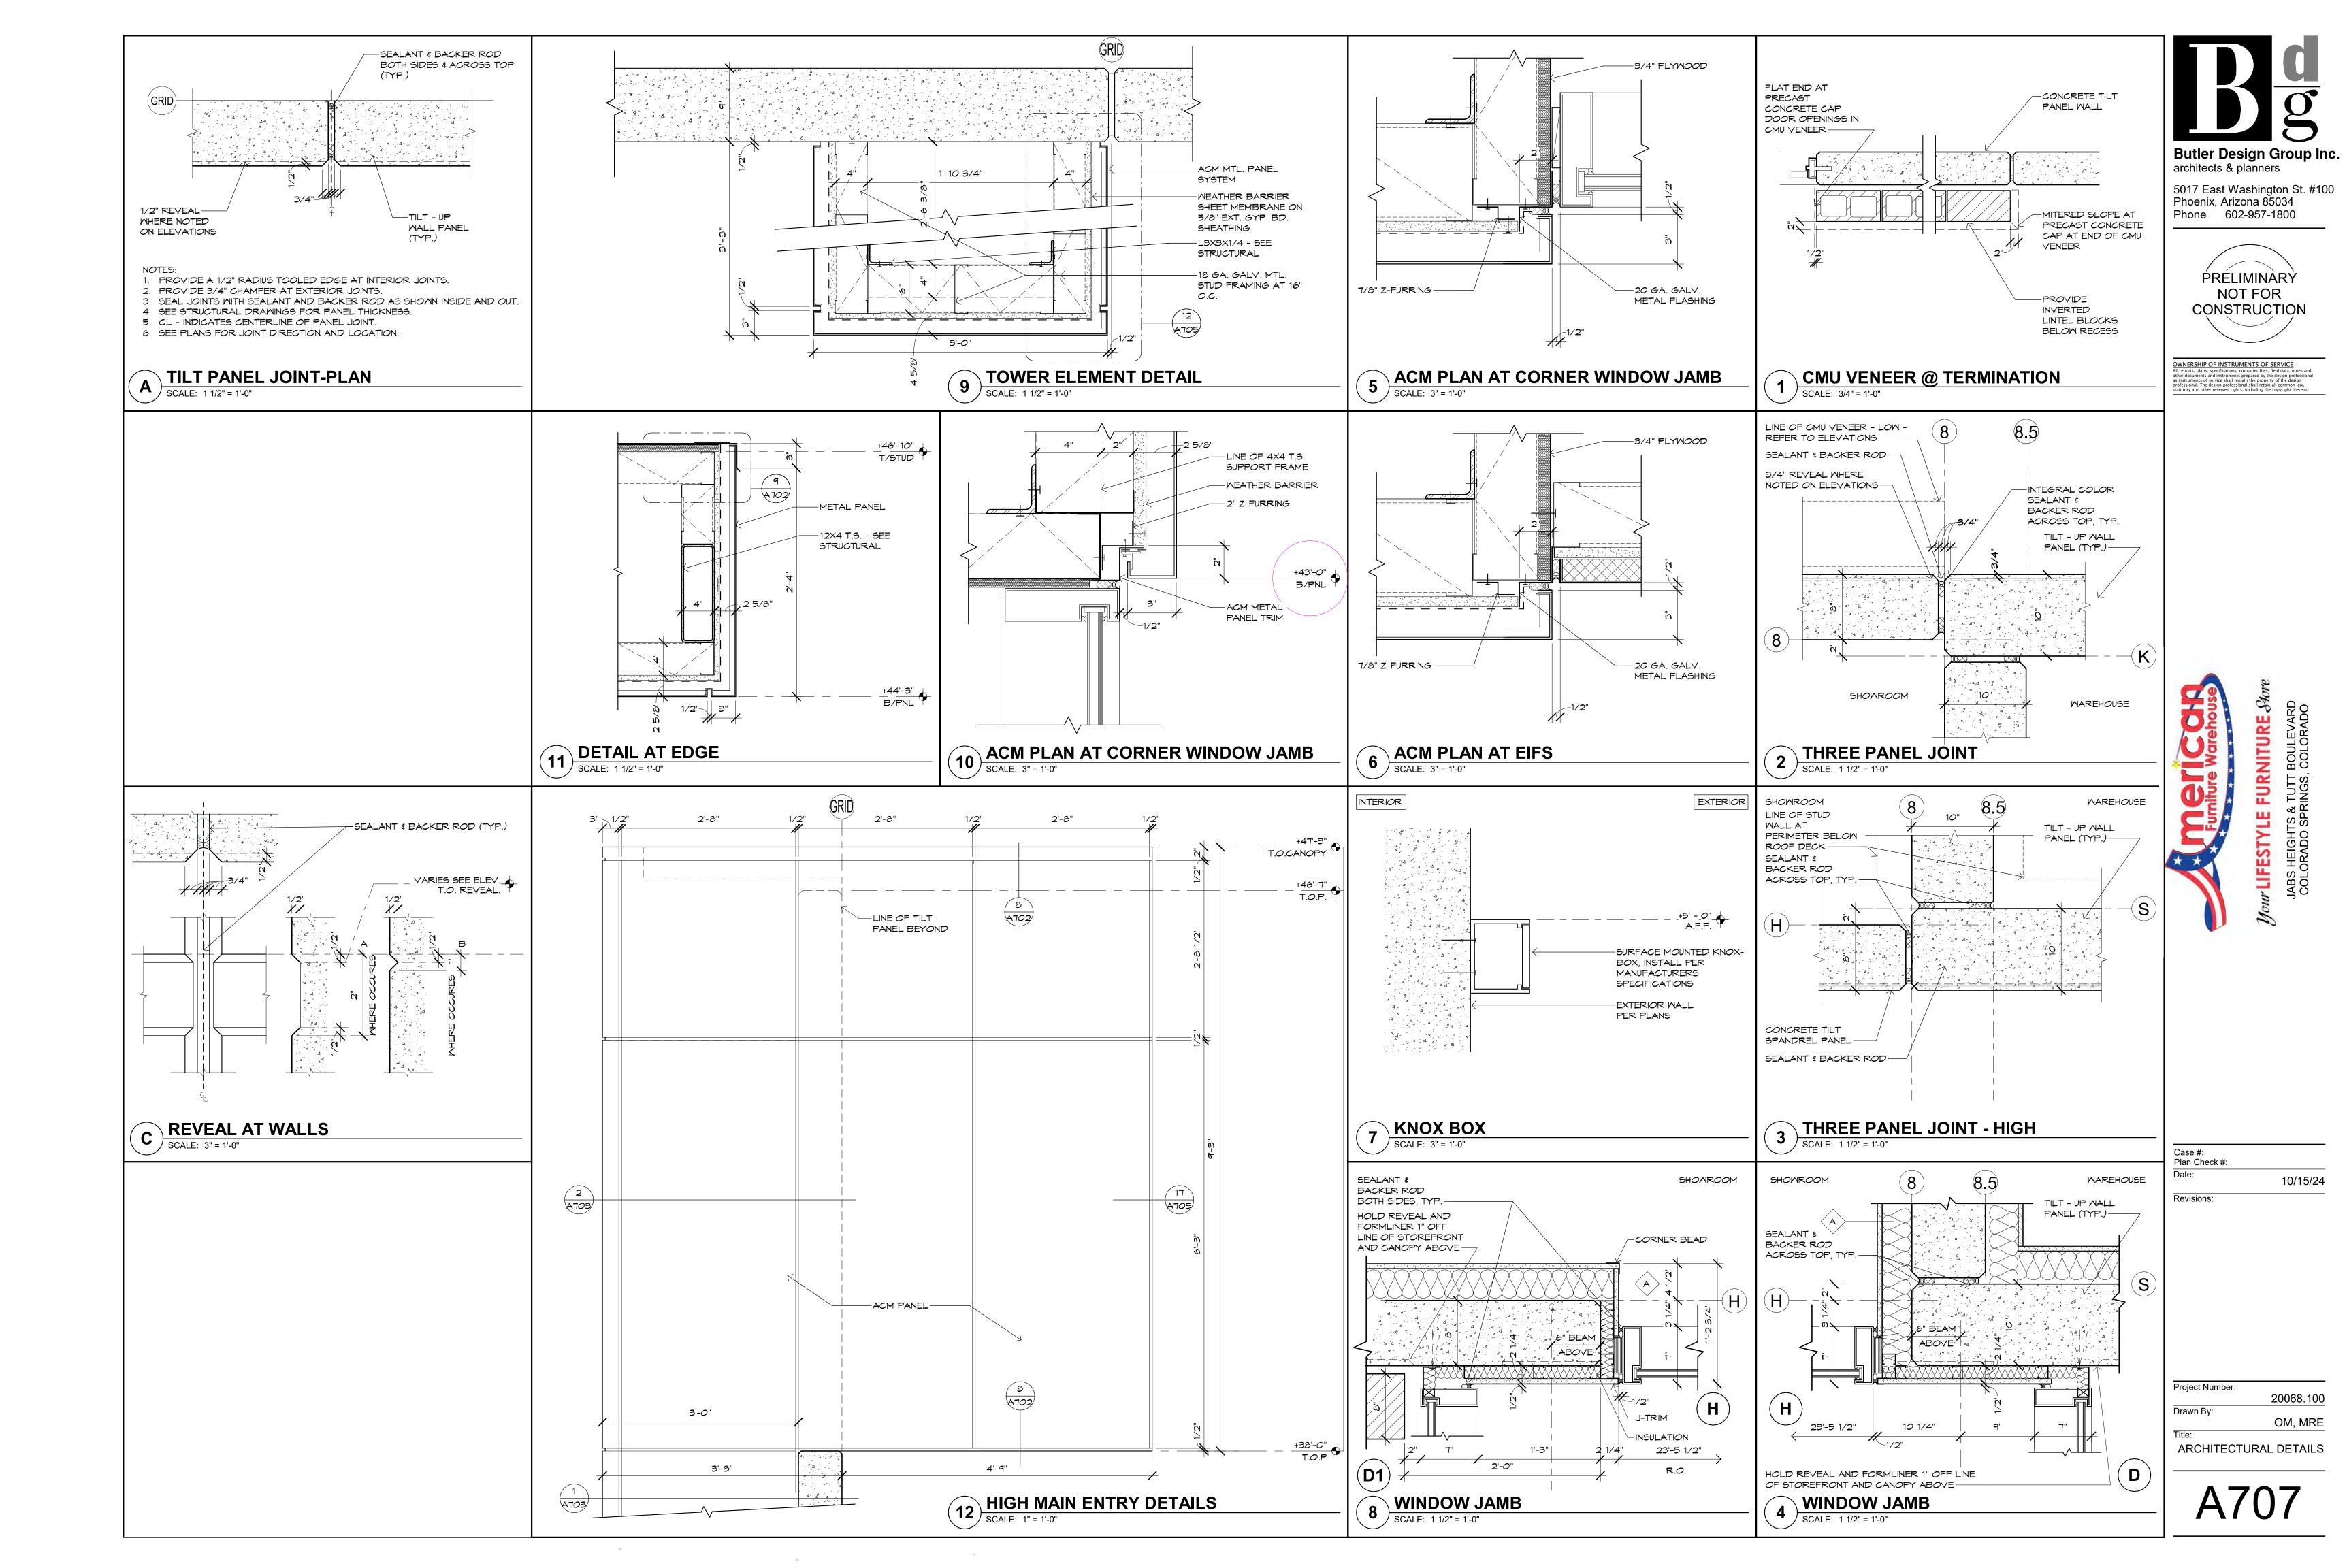

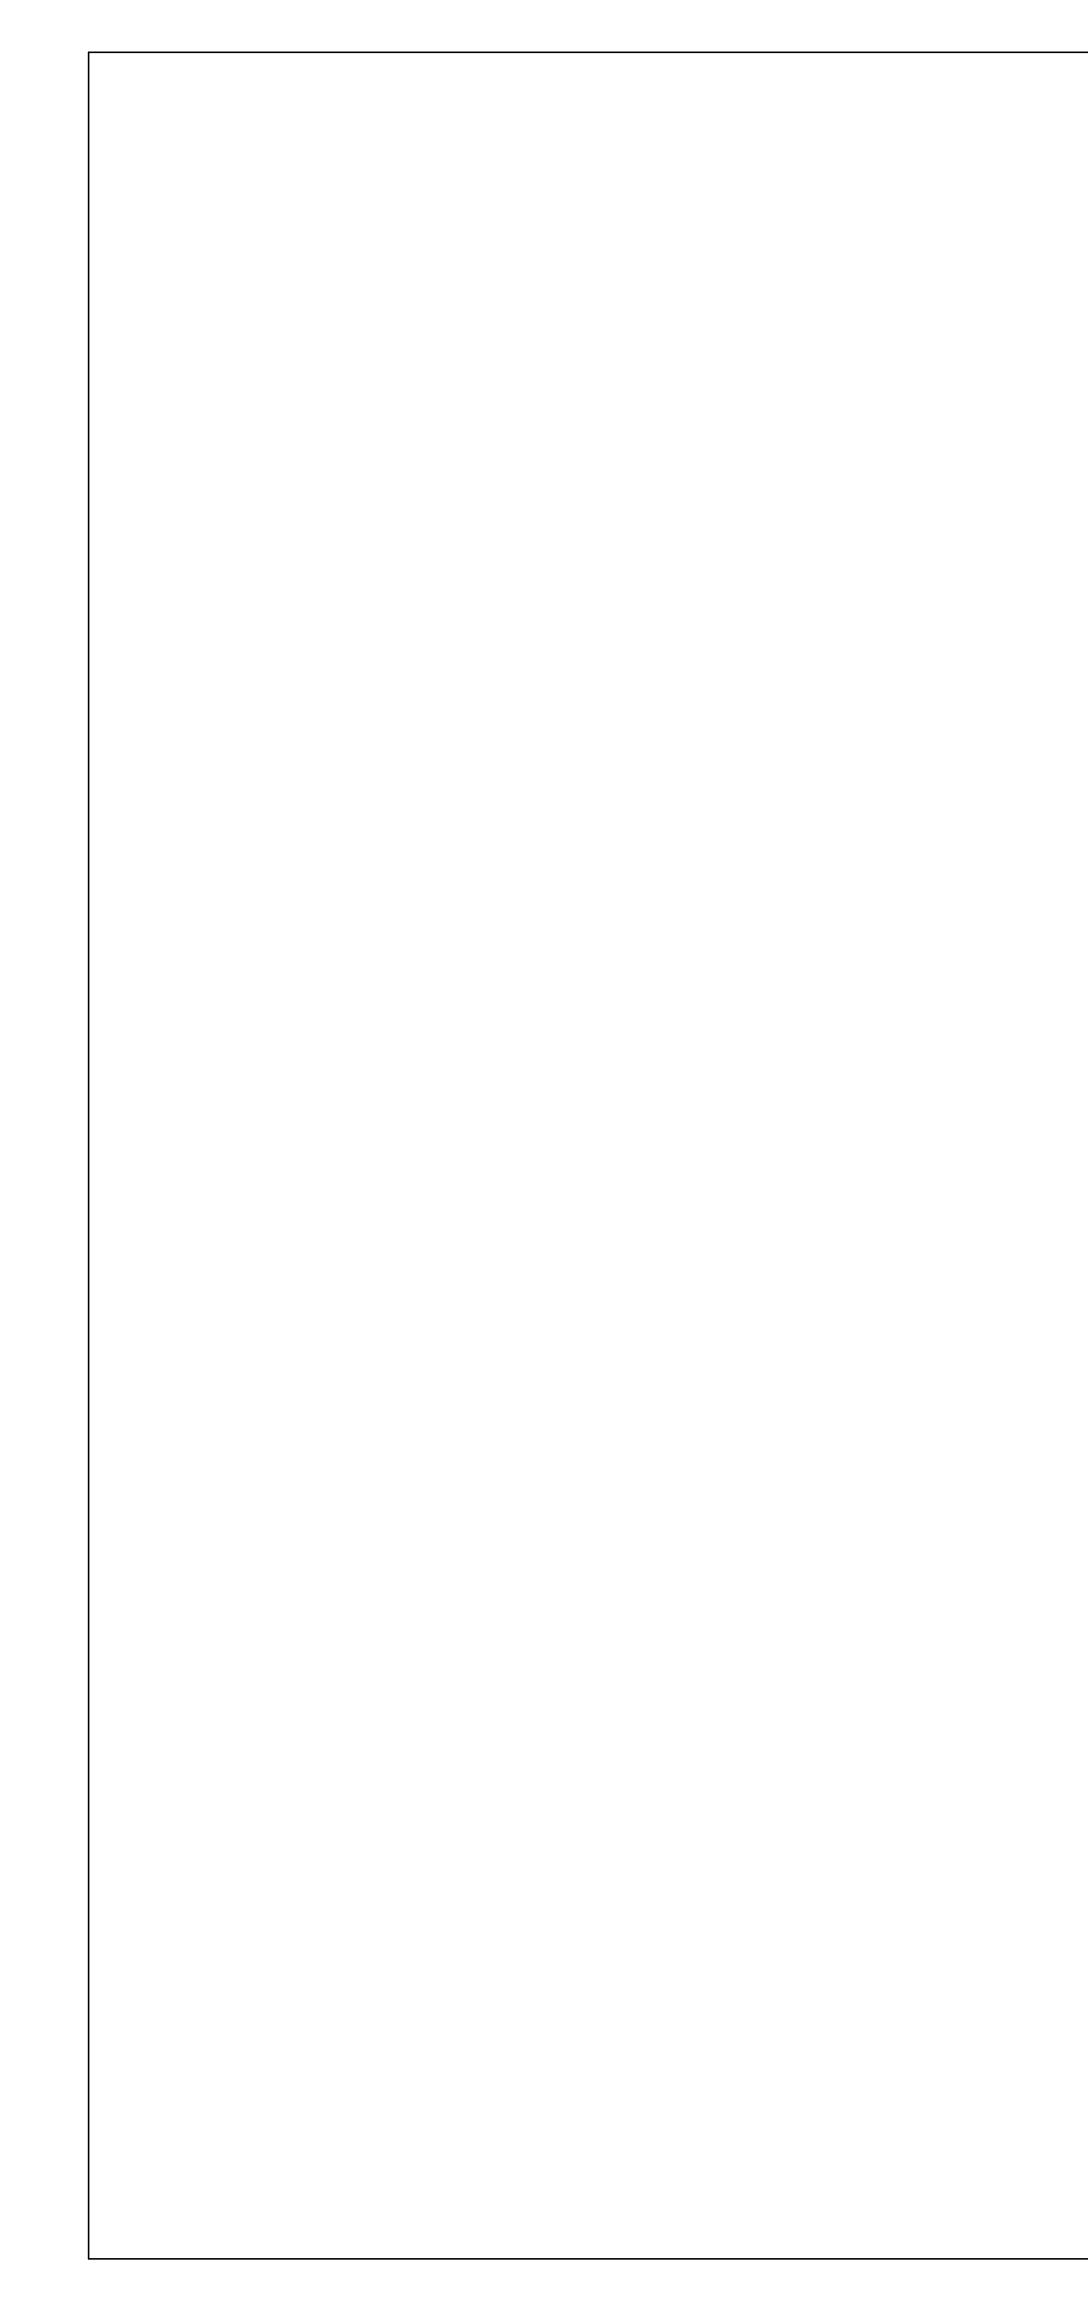

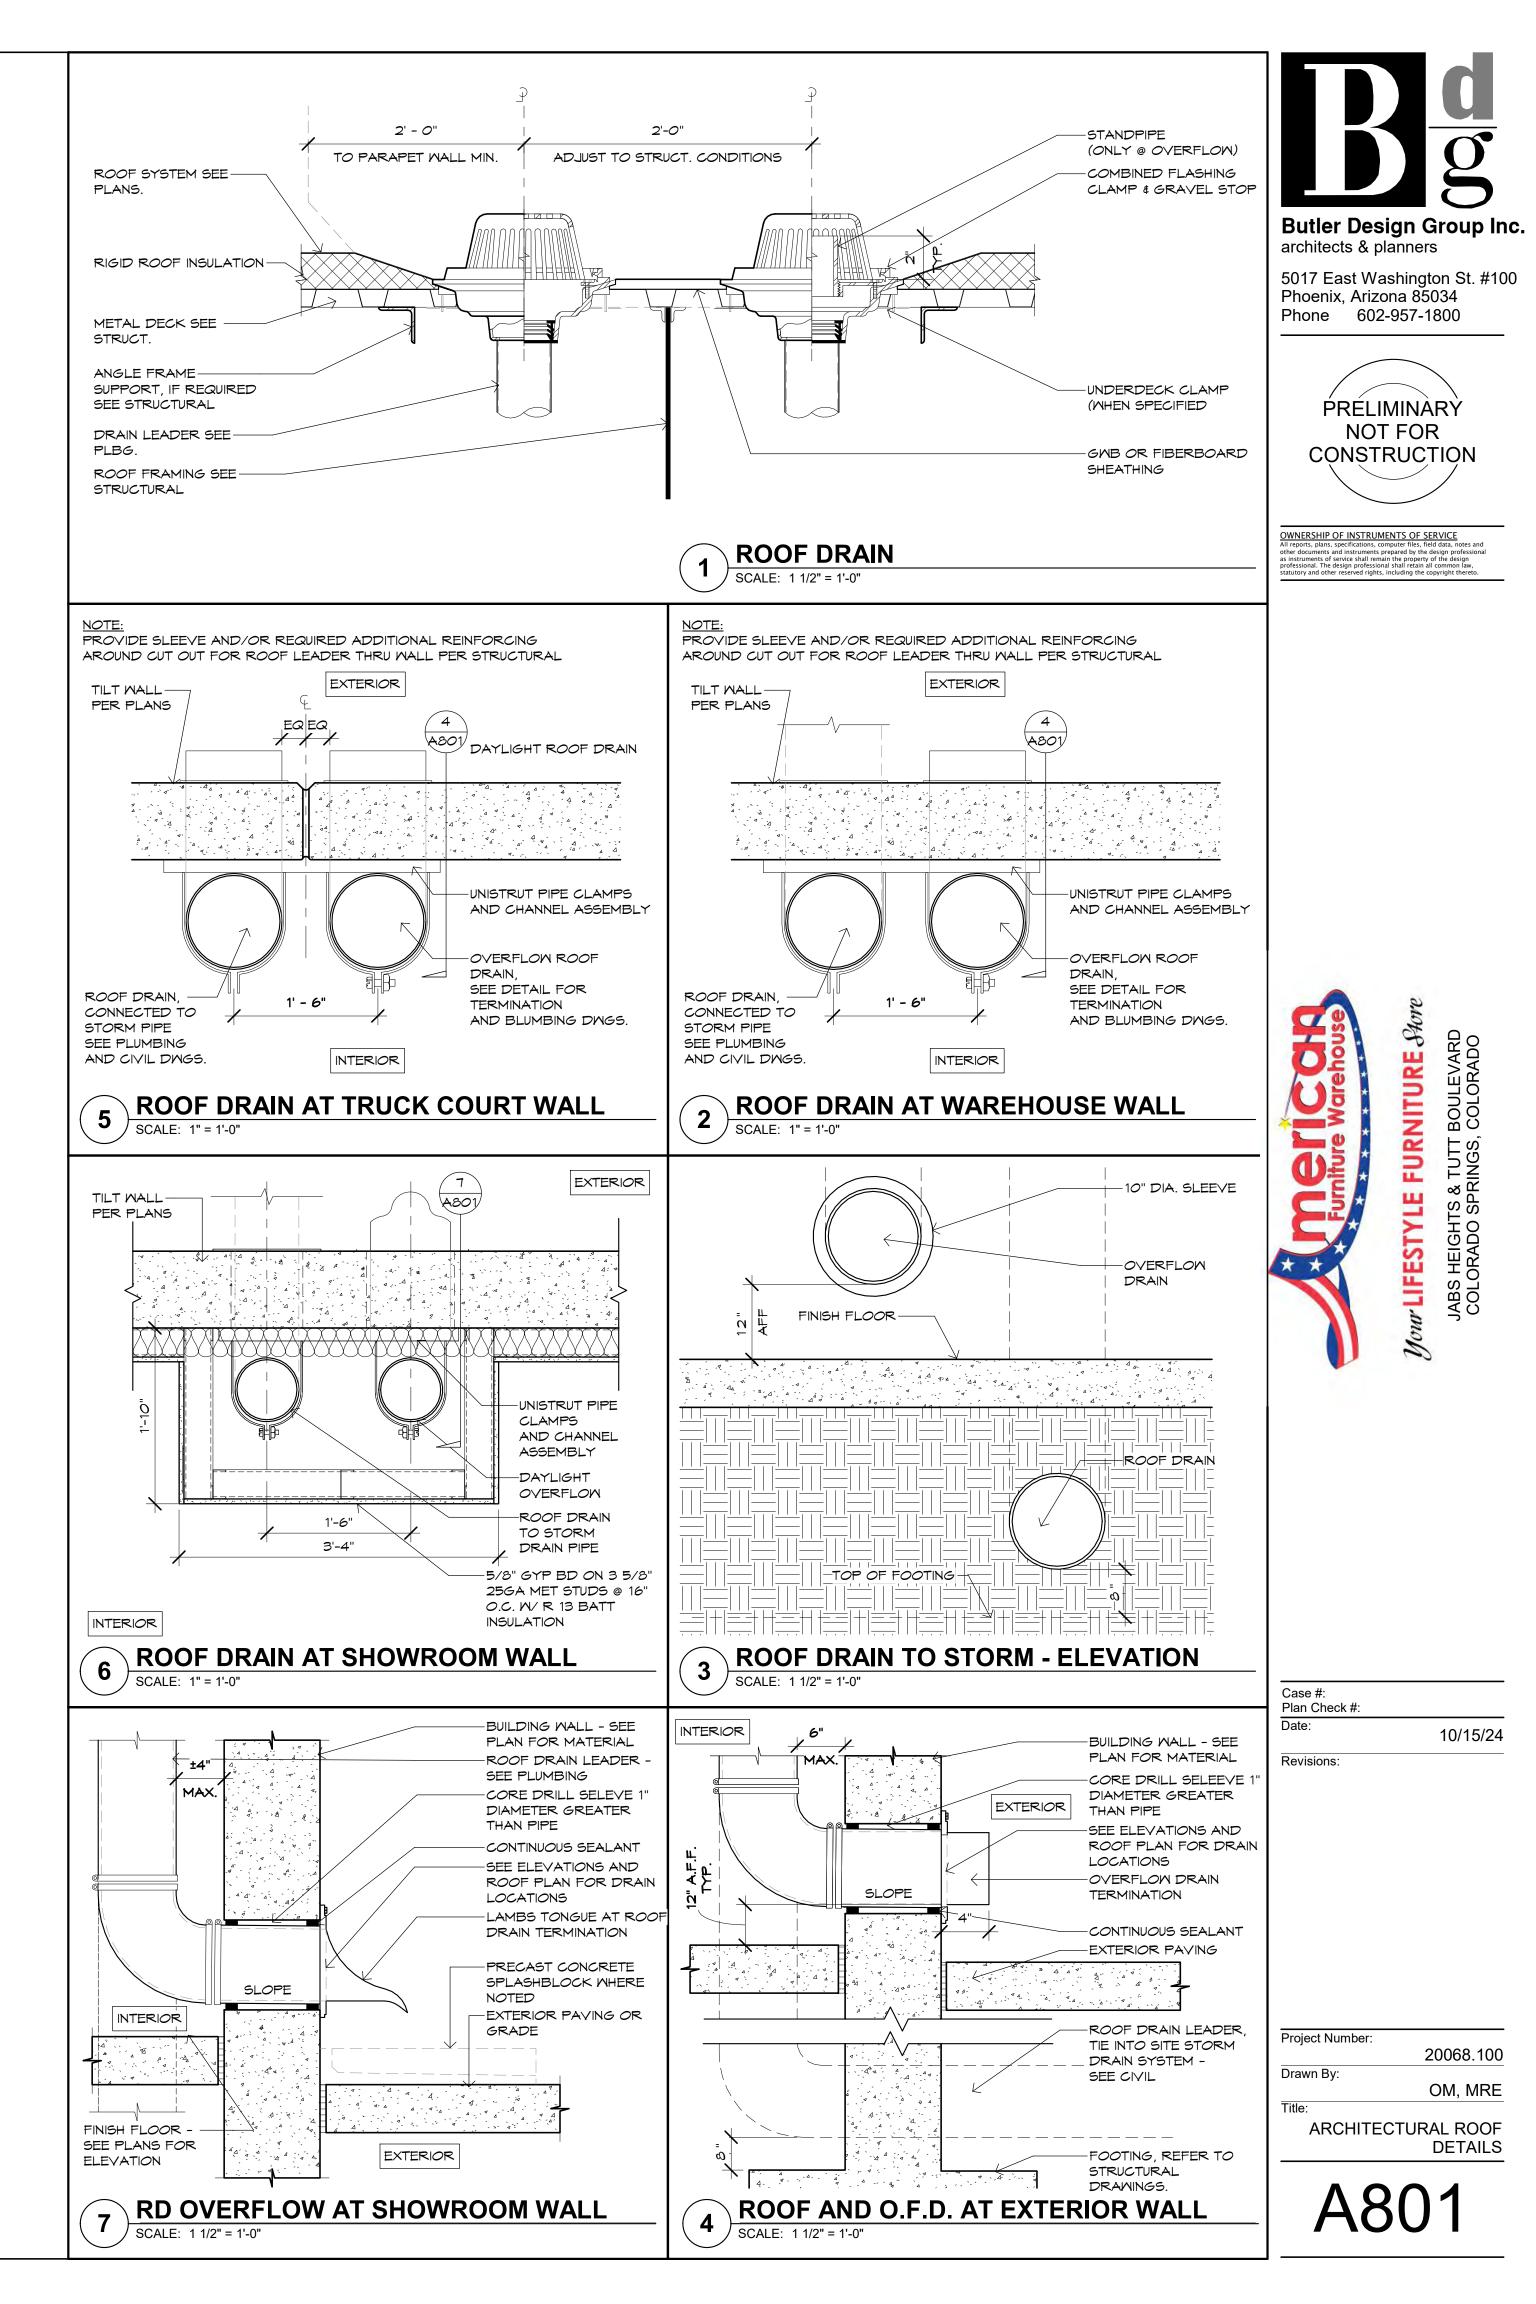

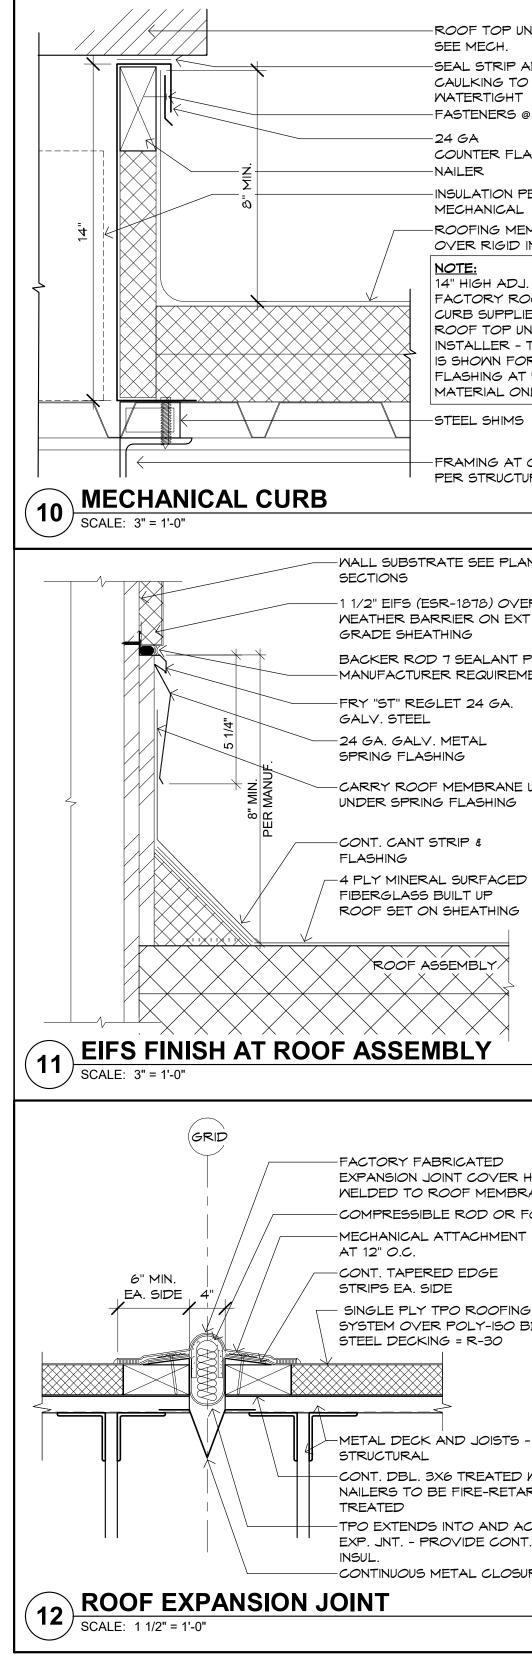

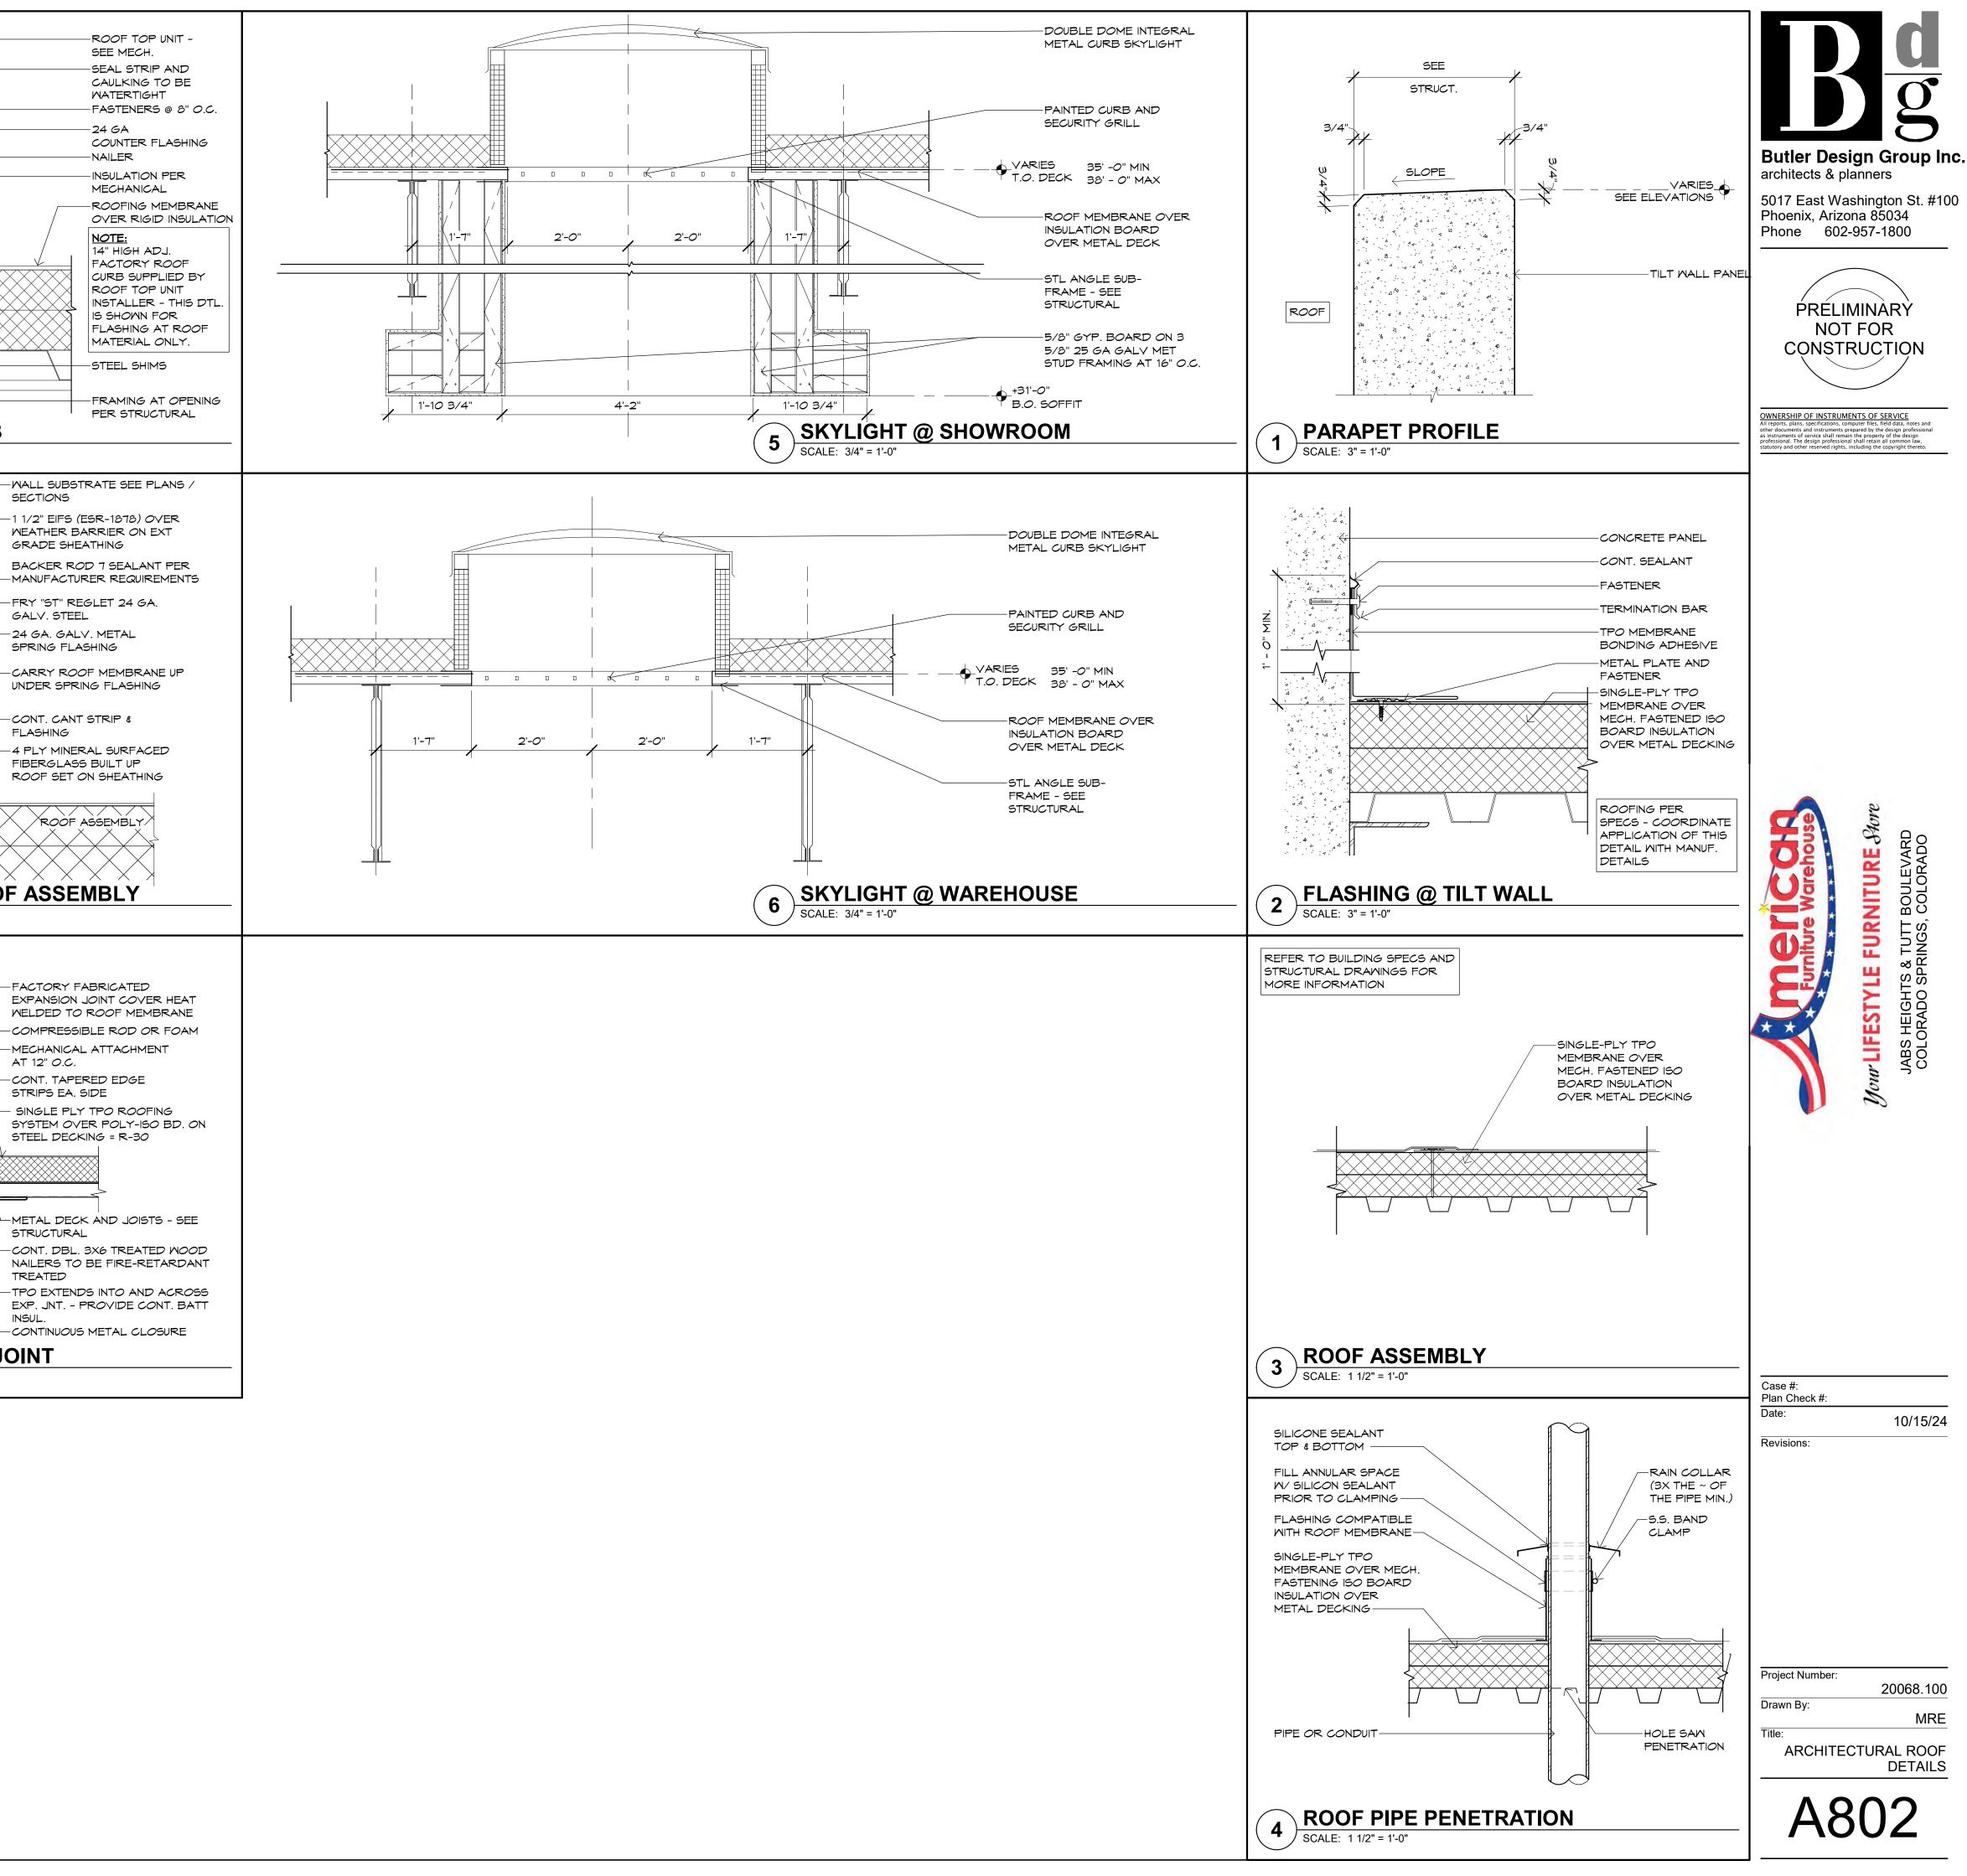

EXPANSION JOINT COVER HEAT WELDED TO ROOF MEMBRANE

-MECHANICAL ATTACHMENT

- SINGLE PLY TPO ROOFING SYSTEM OVER POLY-ISO BD. ON

-TPO EXTENDS INTO AND ACROSS

-CONTINUOUS METAL CLOSURE